



Homestead High School Expansion/Renovation Project  
Phase 2B - Gymnasium and Auditorium Additions - General Construction  
12.9.20  
Addendum No. 2

Questions and Front End Clarifications - Pre-Bid Meeting - CSO Architects Addendum No. 2

The following information by issuance as Addendum 02 shall be included and become part of the Bidding Documents and therefore part of the Construction Documents.

**BIDDERS ARE TO REVIEW ALL ADDENDUM ITEMS FOR FAMILIARITY WITH ALL BID PACKAGES AND SCOPES OF WORK.**

- Item: 2.01**  
Location: Bid date  
Description: **Bid date** is being pushed to **Friday, December 18, 2020 at 2:00pm.**
- Item: 2.02**  
Location: CSO Addendum No. 2 2B  
Description: See attached copy of CSO Addendum No. 2 documents from CSO. Also can be accessed from notice through Smartbid
- Item: 2.03**  
Location: Clarification  
Description: See attached revised Summary of Work dated Rev 12.09.20. The following Bid Packages have been revised:  
**BP-14 Gyp Assy/Acoustical Ceilings** - added item 19. Furnish material and labor to patch walls that remain where casework, white boards or other accessories are removed  
**BP-19 General Trades** - added WR2 Battle Rope Box and the following:  
14.Furnish and install clad windows in Ticket Booths.  
  
15.This bid package to include furnishing material and labor to frame the Ticket Booths including sub sheathing.  
**BP-20 Athletic Equipment** - Move scorer's table to **BP-21 Scoreboards**  
Removed stage floor from **BP-18A Flooring - Wood Athletic Floors** and added it to **BP-18C - Flooring - Stage Flooring**. Added allowances to **BP-18A, 18B and 18C**  
**BP-18A - Flooring - Wood Athletic Floors** - Coordinate inserts for athletic equipment with **BP-20 Athletic Equipment**. **BP-20** to furnish and install sleeves. Also added to **BP-20**  
**BP-18C - Flooring - Stage Flooring** added: 3.This bid package shall furnish and install the SV1 portable sheet vinyl dance floor.
- Item: 2.04**  
Location: BP- 16 Flooring - Soft Goods  
Description: Clarification - Stair #6 will not receive rubber treads.
- Item: 2.05**  
Location: BP-19 General Trades  
Description: Knox Box shall be model #3262
- Item: 2.06**  
Location: Record Boards Spec Section 10 14 23  
Description: Shall be furnished and installed by **BP-24 Signage**



**Item:** 2.07  
**Location:** BP-11 Exterior ACM Wall Panel  
**Description:** This bid package to furnsih and install ACM on ticket booths and CS Building.

**Item:** 2.08  
**Location:** BP-19 - General Trades  
**Description:** This bid package to furnish and install canopies at entrances to CS Building.

**Item:** 2.09  
**Location:** CORRECTION to Addendum No. 1 Item 1.15 Question 38.  
**Description:** BP-19 General Trades IS TO FURNISH AND INSTALL THE RETRACTABLE SEATING. NOT BP-12.  
Fixed seating in the Auditorium is to be furnished and installed by BP-22 Theatrical and Auditorium Seating

**Item:** 2.10  
**Location:** BP-19 General Trades  
**Description:** This bid package to include furnish and install gates and fences at ticket booths.

# ADDENDUM

ADDENDUM NO: 2


BID PACKAGE NO: ALL

PROJECT: Additions & Renovations to Homestead High School  
Phase 2B

PROJECT NO: 18138

DATE: 12/02/2020

BY: Emily Newton

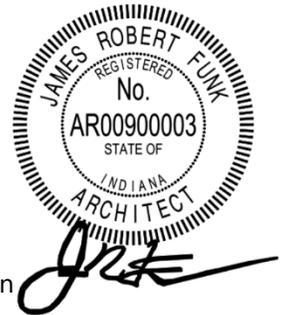

This Addendum is issued in accordance with the provisions of "The General Conditions of the Contract for Construction," Article 1, "Contract Documents" and becomes a part of the Contract Documents as provided therein. This Addendum includes:

Addendum Pages: ADD1-5 - ADD 5-5

Attachments: REVISED SHEETS: A111-2, A701-2, A756-2, TE311B, TE612, TR111B, TR411B  
ISSUED SHEETS: TE413B, TE711B, TE712B, TE713B

## **PART 1 - BIDDING AND CONTRACT REQUIREMENTS**

1.01 NOT USED

## **PART 2 - SPECIFICATIONS**

2.01 09 84 00 – ACOUSTIC ROOM COMPONENTS

A. Add section 2.02A6 as follows:

**6. ESSI Acoustic Wall Products**

B. Add section 2.03A5 as follows:

**5. ESSI Acoustic Wall Products**

C. Add section 2.04A6 as follows:

**6. ESSI Acoustic Wall Products**

2.02 10 21 13 – TOILET COMPARTMENTS

A. Add section 2.03B8 as follows:

**8. Metpar Copr.**

2.03 12 32 19 – MUSIC INSTRUMENT CASEWORK

A. Add section 2.01A4 as follows:

**4. Advanced Cabinet Systems**

2.04 10 50 00 – HIGH DENSITY ATHLETIC STORAGE

A.

**PART 3 - DRAWINGS**

3.01 A000-2B – SHEET LIST

A. ARCHITECTURAL SHEET LIST: Add sheets TE413B, TE711B, TE712B, and TE713B.

3.02 A111-2 – ROOF PLAN PHASE 2 – A, B, C, G, L, N

A. Add Roof Plan Note 14. Reissued sheet.

3.03 A201CS-2 – FIRST FLOOR PLAN – UNIT CS

A. Add one (1) FE to Mechanical Mezzanine CS201

3.04 A202B-2 – SECOND FLOOR PLAN – UNIT B

A. Add three (3) FEC1s to Corridor B207

3.05 A202C-2 – SECOND FLOOR PLAN – UNIT C

A. Add one (1) FE to Mechanical C202

3.06 A202D-2 – SECOND FLOOR PLAN – UNIT D

A. Add one (1) FE to Mechanical D201

3.07 A202E-2 – SECOND FLOOR PLAN – UNIT E

A. Add one (1) FEC1 to Media Row E208

3.08 A202F-2 – SECOND FLOOR PLAN – UNIT F

A. Add two (2) FEs to Mechanical Room F201

3.09 A211E-2 FIRST FLOOR REFLECTED CEILING PLAN – UNIT E

A. Revise ceiling height in Day Lockers E105 from ~~10'-8"~~ to **10'-0"**.

B. Add CL5 @ +10'-6" in Ice E108A.

3.010 A502-2 – DOOR SCHEDULE & ELEVATIONS

A. Revise E108A door type from ~~PAIR~~ to **OCD**.

1. Door width: **5'-6"W** Door height: **8'-0"H** Door Material: **AL** Door finish: **AN** Door elevation: **D5** Head detail: **H20** Jamb detail: **J19** Remarks: **9**

3.011 A701-2 – ENLARGED RESTROOM PLANS

- A. Add **CEILING MOUNTED TOILET PARTITION SUPPORT** detail as shown on the attached sheet.

3.012 A756-2 – ENLARGED PLAN DETAILS

- A. Delete roof vapor barrier membrane and ½” gypsum deck board 07 54 19-B at all areas with corrugated metal deck. Note: The only area to receive a roof vapor barrier is at the concrete roof deck at the auditorium.

3.013 A800-2 FINISH LEGEND & NOTES

- A. Revise Wall Finish DVW1 as follows:
  - 1. **SUBSTRATE: SILK WITH UNDERLINER TO ACCOMMODATE CMU WALL INSTALLATION.**

3.014 A801A-E FIRST FLOOR FINISH PLAN – UNIT A

- A. Remove all Finish Tags and Keyed Finish Notes from TV STUDIO A112.
- B. Add Keyed Finish Note **FN17** to TV Studio A112.

3.015 A900-2 EQUIPMENT SCHEDULE

- A. Add **FIRE EXTINGUISHER & BRACKET** to the equipment schedule.
  - 1. Type Mark: **FE** Spec section: **10 44 13** Manufacturer: **See Spec.** Model No.: **See Spec.** Remarks: **Fire extinguisher on bracket** Furnished by: **Contractor** Installed by: **Contractor**

3.016 A901CS-2 – FIRST FLOOR EQUIPMENT PLAN – UNIT CS

- A. Add one (1) FE to Cart Room CS121
- B. Add one (1) FEC1 to Locker Room CS147
- C. Add one (1) FEC1 to Corridor CS154

3.017 A901B-2 – FIRST FLOOR EQUIPMENT PLAN – UNIT B

- A. Add one (1) FEC1 to Choir Room B113
- B. Add one (1) FEC1 to Stage B116

3.018 A901C-2 – FIRST FLOOR EQUIPMENT PLAN – UNIT C

- A. Add one (1) FE to Set Shop C105
- B. Add one (1) FEC1 to Band Room C107
- C. Add one (1) FEC1 to Orchestra Room C122
- D. Add one (1) FE to Scene Shop C135

E. Add one (1) FEC1 to Music Multipurpose C138

3.019 A901D-2 – FIRST FLOOR EQUIPMENT PLAN – UNIT D

A. Add one (1) FEC1 to South Gymnasium D108

3.020 A901F-2 - FIRST FLOOR EQUIPMENT PLAN – UNIT F

A. Add one (1) FEC1 to Weight Room F122

B. Add one (1) FE to Building Storage F125

3.021 A901G-2 - FIRST FLOOR EQUIPMENT PLAN – UNIT G

A. Add one (1) FEC1 to Gymnasium G105

3.022 A901H-2 - FIRST FLOOR EQUIPMENT PLAN – UNIT H

A. Add one (1) FEC1 to Concessions H102

3.023 TE113B – STAGE LIGHTING SYSTEM PROSCENIUM ELEVATION

A. Add callouts to enlarged elevations

3.024 TE413B – STAGE LIGHTING SYSTEM PROSCENIUM COORDINATION

A. Issue new sheet

3.025 TE612 – STAGE LIGHTING SYSTEM SCHEDULES

A. Revise box mountings and control types in wiring device and entry panel schedules

3.026 TE711B – STAGE LIGHTING SYSTEM PANEL DETAILS

A. Issue new sheet

3.027 TE712B – STAGE LIGHTING SYSTEM PANEL DETAILS

A. Issue new sheet

3.028 TE713B – STAGE LIGHTING SYSTEM PANEL DETAILS

A. Issue new sheet

3.029 TR111B – STAGE RIGGING SYSTEM PROSC STAGE LEVEL PLAN

A. Revise proscenium dimension

3.030 TR411B – STAGE RIGGING SYSTEM COORDINATION AND DETAIL ENLARGEMENTS

A. Add Proscenium Reduction Panel detail

**PART 4 - OTHER ITEMS**

4.01 NOT USED


**PART 5 - QUESTION AND ANSWER**

5.01 NOT USED

END OF ADDENDUM

NOTE:  
SHADED AREA IS THE EXISTING BUILDING ROOF  
AND IS NOT INCLUDED WITH PHASE 2.

NOT IN PHASE 2 SCOPE

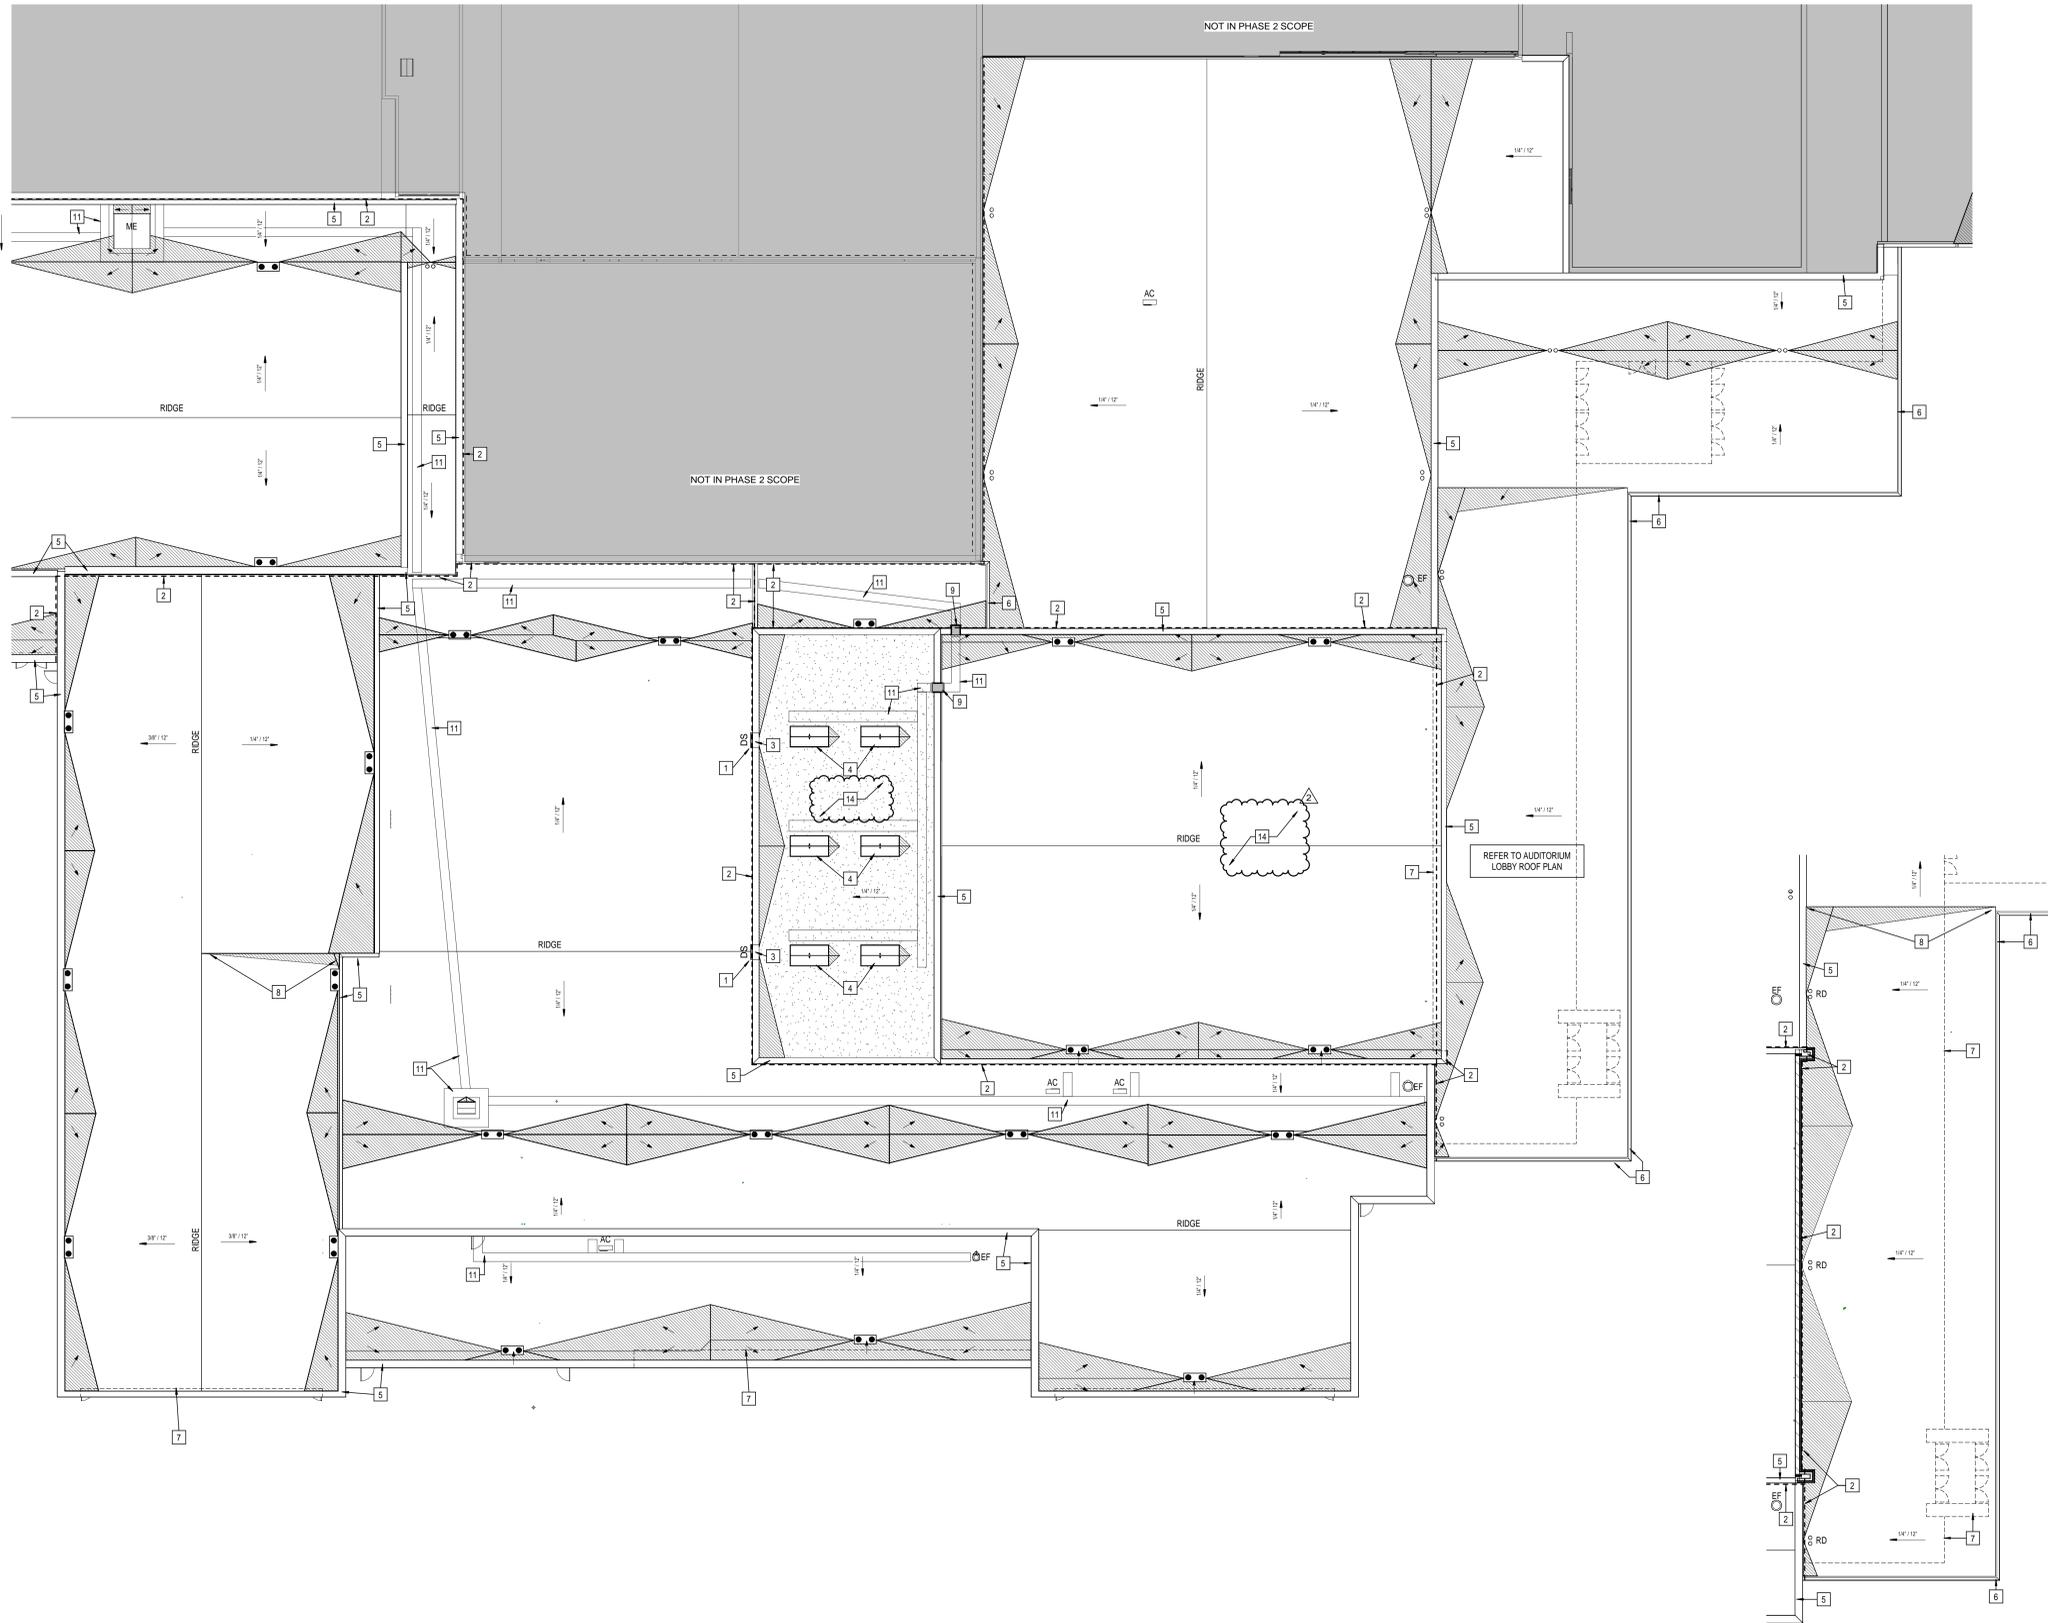

1 ROOF PLAN PHASE 2 - A,B,C,G,L,N  
A111-2 SCALE: 1/8" = 1'-0"

2 ROOF PLAN AUDITORIUM LOBBY  
A111-2 SCALE: 1/8" = 1'-0"

**ROOF ABBREVIATIONS**

- AC AIR CONDITIONER; SEE MECHANICAL
- DR DUCT THRU ROOF
- DS METAL DOWNSPOUT
- EF EXHAUST FAN; SEE MECHANICAL
- EJ EXPANSION JOINT
- FS FLUE STACK; SEE MECHANICAL
- ME MECHANICAL EQUIPMENT; SEE MECHANICAL
- GU METAL GUTTER
- PV PLUMBING VENT
- RAV RELIEF AIR VENT; SEE MECHANICAL
- RH ROOF HATCH

**GENERAL ROOF NOTES**


1. ALL WORK SHALL BE IN ACCORDANCE WITH THE BEST QUALITY STANDARDS OF THE TRADE, AND SHALL CONFORM WITH THE LATEST EDITION OF ALL FEDERAL, STATE, AND LOCAL CODES AND STANDARDS. THE SAME ARE MADE A PART OF THESE CONTRACT DOCUMENTS, AS IF REPEATED HEREIN.
2. CONTRACT DOCUMENTS CONSIST OF BOTH THE PROJECT MANUAL AND DRAWINGS, AND BOTH ARE INTENDED TO BE COMPLEMENTARY. ANYTHING APPEARING ON EITHER MUST BE EXECUTED THE SAME AS IF SHOWN ON BOTH.
3. CONSTRUCTION DOCUMENTS SHALL BE FOLLOWED AS CLOSELY AS POSSIBLE. HOWEVER, SYSTEMS HAVE BEEN SHOWN DIAGRAMMATICALLY AND IN SOME CASES ENLARGED FOR CLARITY. PROVIDE ADDITIONAL ITEMS AS REQUIRED TO PROVIDE A COMPLETE AND COORDINATED SYSTEM.
4. CONTRACTOR SHALL PROVIDE ANY AND ALL TEMPORARY UTILITY SERVICE REQUIRED TO CONSTRUCT THE WORK. CONTRACTOR MAY EXTEND SERVICES FROM EXISTING LOCATIONS TO WHERE THEY ARE REQUIRED. REMOVE TEMPORARY UTILITIES AND RELATED EXTENSIONS AS SOON AS PRACTICABLE. RESTORE ALL AFFECTED AREAS TO ORIGINAL CONDITION.
5. CONTRACTOR SHALL REMOVE CONSTRUCTION DEBRIS FROM THE BUILDING AND ROOF DAILY.
6. STORE VOLATILE OR FLAMMABLE LIQUIDS IN UL LISTED FIRE CABINETS.
7. CONTRACTOR SHALL BE SOLELY RESPONSIBLE FOR THE SECURITY OF ALL STORED MATERIALS AND EQUIPMENT INSIDE OR OUTSIDE THE BUILDING.
8. CONTRACTOR SHALL FURNISH NECESSARY TEMPORARY PROTECTION FROM WEATHER TO PROTECT INTERIOR OF BUILDING FROM ELEMENTS OF WEATHER AT ALL TIMES.
9. CONTRACTOR RESPONSIBLE FOR TRAFFIC PROTECTION DURING CONSTRUCTION. AREAS OF WORK SUBJECT TO TRAFFIC BY VARIOUS TRADES SHALL BE PROTECTED BY TEMPORARY WALK PADS.
10. PROVIDE TREATED WOOD BLOCKING EQUAL IN THICKNESS TO INSULATION SYSTEM AT ROOF PERIMETER AND AROUND ALL ROOF PENETRATIONS. ANCHOR PER SECTION 4.0 OF THE FM GLOBAL LOSS PREVENTION GUIDE.
11. EXTEND ALL PLUMBING VENTS TO PROVIDE A MIN. OF 12" OF HEIGHT FROM TOP OF INSULATION. ALL FITTINGS TO BE AIR AND WATER TIGHT. SEE PLUMBING PLANS FOR LOCATIONS.
12. ROOF INSULATION SADDLES AND CRICKETS ARE DIAGRAMMATIC. ROOF INSULATION MANUFACTURER SHALL DESIGN AND SIZE THESE PER THE ROOF MEMBRANE MANUFACTURER'S RECOMMENDATIONS. CRICKETS AND SADDLES SHOULD HAVE A MINIMUM OF TWO TIMES THE SLOPE OF THE PRIMARY TAPERED SYSTEM OR STRUCTURAL SLOPE. THE RATIO OF A CRICKET'S WIDTH TO LENGTH SHOULD BE NO LESS THAN 1 TO 3.
13. PROVIDE SADDLES/CRICKETS AROUND ALL NEW ROOF TOP EQUIPMENT. SEE MECHANICAL, ELECTRICAL AND PLUMBING DRAWINGS FOR LOCATIONS OF ALL ROOF PENETRATIONS.
14. PROVIDE TAPERED INSULATION WHERE REQUIRED TO TRANSITION FROM ONE INSULATION HEIGHT TO ANOTHER.
15. NOTCH ALL INSULATION AS REQUIRED TO ACCOMMODATE SURFACE MOUNTED CONDUIT, FASTENERS, OFFSETS AND OTHER PROJECTIONS EXTENDING ABOVE THE SURFACE OF THE DECK.
16. PERIMETER EDGE METAL TO COMPLY WITH ANSIPRI ES-1 FM GLOBAL 1-48.
17. SEE MECHANICAL, ELECTRICAL AND PLUMBING (MEP) SHEETS FOR ROOF TOP EQUIPMENT.
18. INSPECT ALL WOOD BLOCKING SCHEDULED TO REMAIN. NOTIFY ARCHITECT OF ANY DETERIORATED BLOCKING NEEDING REPLACEMENT. CONTRACTOR TO REPLACE AND DAMAGED BLOCKING ON A TIME AND MATERIAL BASIS. SEE SPECIFICATIONS.
19. ALL ROOF DETAIL DRAWINGS CONTAINED IN THIS SET ARE DIAGRAMMATIC. ADJUST ROOF DETAILS BASED ON SPECIFIC ROOFING SYSTEM SELECTED ACCORDING TO MANUFACTURER'S WRITTEN SPECIFICATIONS AND APPROVED DETAIL DRAWINGS. ALL ASSEMBLY COMBINATIONS SHOULD BE BROUGHT TO THE ATTENTION OF THE ARCHITECT.
20. THE ROOF CONTRACTOR SHALL PROTECT ALL ROOF DRAINS, GUTTERS AND DOWNSPOUTS FROM DEBRIS CREATED DURING CONSTRUCTION. THE ROOF CONTRACTOR SHALL CLEAR ALL DRAINS, GUTTERS AND DOWNSPOUTS PRIOR TO COMPLETION OF WORK AND TO ENSURE THAT THEY ARE FREE OF DEBRIS AND FUNCTIONING PROPERLY.
21. MECHANICAL, ELECTRICAL AND PLUMBING INFORMATION SHOWN ON THIS PLAN IS GENERAL IN NATURE. REFER TO P, M AND E DRAWINGS FOR FURTHER INFORMATION AND COORDINATE ALL REQUIRED ROOF OPENINGS OR ROOF MOUNTED EQUIPMENT.

**ROOF PLAN NOTES**

1. PREFINISHED METAL GUTTER AND DOWNSPOUT WITH SPLASH BLOCK.
2. BUILDING EXPANSION JOINT SYSTEM WITH FACTORY FABRICATED TRANSITIONS. TYPICAL AT LOCATIONS WHERE NEW CONSTRUCTION MEETS THE EXISTING CONSTRUCTION.
3. 40"W x 16"H THROUGH WALL SCUPPER CONNECTED TO GUTTER AND DOWNSPOUT.
4. ROOF SMOKE VENTS - SEE SPECS.
5. PREFINISHED METAL COPING.
6. PREFINISHED METAL GRAVEL STOP - COLOR BY ARCHITECT.
7. DASHED LINE REPRESENTS BUILDING PERIMETER BELOW ROOF.
8. TAPERED INSULATION (WEDGE) BETWEEN OPPOSING OR DIFFERENT ROOF SLOPES.
9. ROOF ACCESS LADDER - SEE SPECS.
10. ROOF HATCH.
11. PVC WALKING PATH BY ROOF MANUFACTURER.
12. STANDING SEAM METAL ROOF.
13. PREFABRICATED CANOPY SYSTEM. SEE DETAILS AND SPECS.
14. VAPOR BARRIER APPLIED OVER CONCRETE ROOF DECK.

**ROOFING TYPES SCHEDULE**

TYPE	LEGEND	DESCRIPTION
TYPE "A"		CLASS "A" ROOFING MEMBRANE OVER (2) STAGGERED LAYERS OF 2" POLYISO ROOFING INSULATION BOARD TO TOTAL THICKNESS (4") INSTALLED ONTO LOW SLOPED METAL ROOF DECK. W/ 1/2" COVERBOARD.
TYPE "B"		CLASS "A" ROOFING MEMBRANE OVER TAPERED (1/2" MINIMUM PER FOOT SLOPE) POLYISO ROOFING INSULATION BOARD (4" THICKNESS) INSTALLED ONTO A SLOPED METAL ROOF DECK. PROVIDE A MIN. STARTING INSULATION THICKNESS OF 1/2" AT ROOF DRAINS. W/ 1/2" COVERBOARD.
TYPE "C"		CLASS "A" ROOFING MEMBRANE OVER TAPERED (1/4" MIN. PER FOOT) POLYISO ROOFING INSULATION BOARD (4" THICKNESS) INSTALLED ONTO A LEVEL METAL ROOF DECK. PROVIDE A MIN. STARTING INSULATION THICKNESS OF 1/2". W/ 1/2" COVERBOARD.
CRICKET/SADDLE		ROOF SADDLE CREATED WITH TAPERED INSULATION. SLOPE 1/2" PER FOOT. CRICKETS AND SADDLES TO BE A MINIMUM WIDTH OF 1/2 THE SADDLE LENGTH.

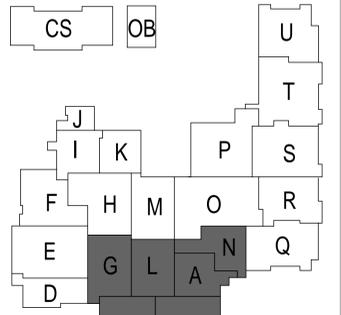



**SACS**  
SOUTHWEST ALLEN COUNTY SCHOOLS



**HOMESTEAD HIGH SCHOOL**  
1970



**CSO**  
ARCHITECTURE · INTERIOR DESIGN  
8831 Keystone Crossing, Indianapolis, IN 46240  
317.848.7800 | csocinc.net



**MKM**  
architecture · design  
119 WEST WAYNE STREET,  
FORT WAYNE, IN 46802  
P. 260.422.0783 | www.MKMdesign.com


PROJECT:  
**SOUTHWEST ALLEN COUNTY SCHOOLS  
ADDITIONS AND RENOVATIONS TO  
HOMESTEAD HIGH SCHOOL**  
4310 HOMESTEAD ROAD, FORT WAYNE, IN 46814

SCOPE DRAWINGS:  
These drawings indicate the general scope of the project in terms of architectural design concepts, the placement of structural, mechanical and electrical systems. The drawings do not constitute an offer or describe all work required for the performance and completion of the project. On the basis of the general scope indicated on drawings, the trade contractors shall furnish all items required for the proper execution and completion of the work.

REVISIONS:  
2 ADDENDUM #2 - 12/02/2020  
PHASE 2B


ISSUE DATE DRAWN BY CHECKED BY  
10/28/2020 MKM MKM

DRAWING TITLE:  
**ROOF PLAN  
PHASE 2 -  
A,B,C,G,L,N**

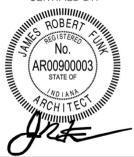CERTIFIED BY:  
  
JAMES ROBERT PLUNK  
No. ARO0000003  
STATE OF INDIANA  
ARCHITECT


DRAWING NUMBER  
**A111-2**

PROJECT NUMBER  
**18138**

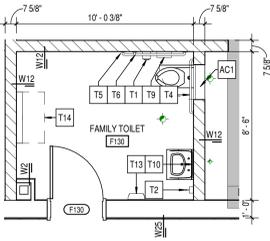


6 ENLARGED RESTROOM PLAN

A701-2 SCALE: 1/4" = 1'-0"

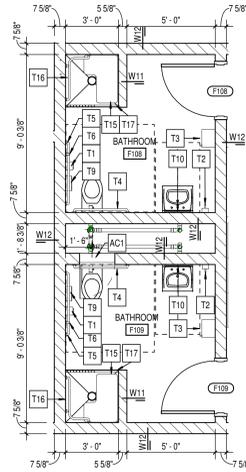


7 ENLARGED RESTROOM PLAN

A701-2 SCALE: 1/4" = 1'-0"

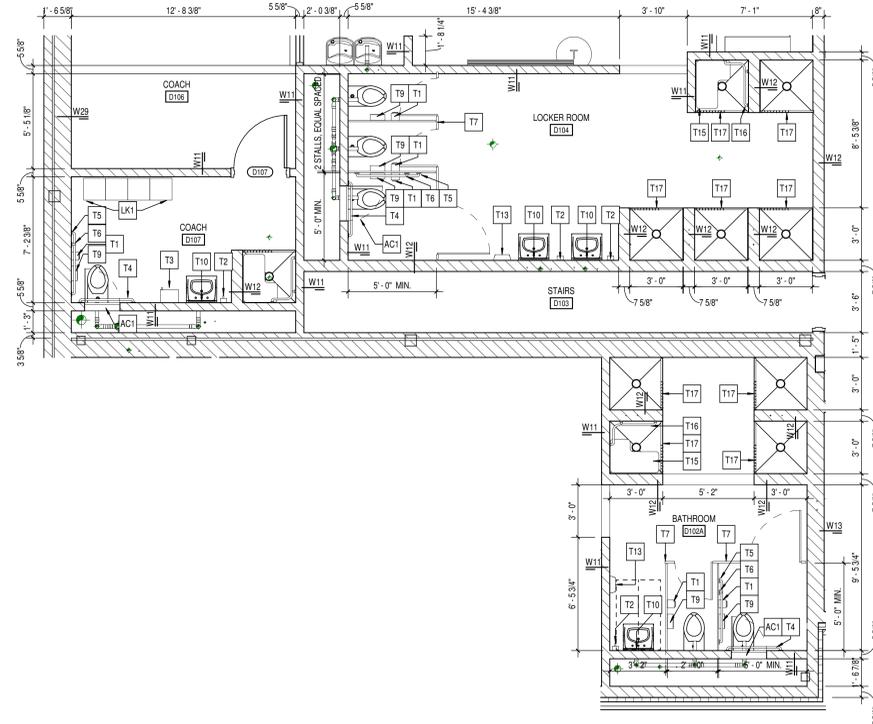


5 ENLARGED RESTROOM PLAN

A701-2 SCALE: 1/4" = 1'-0"

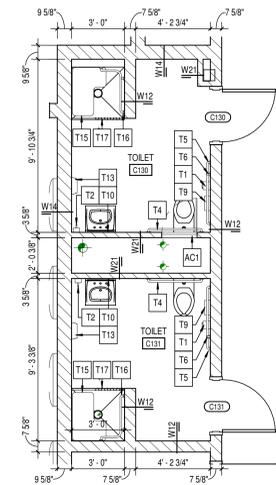


4 ENLARGED RESTROOM PLAN

A701-2 SCALE: 1/4" = 1'-0"

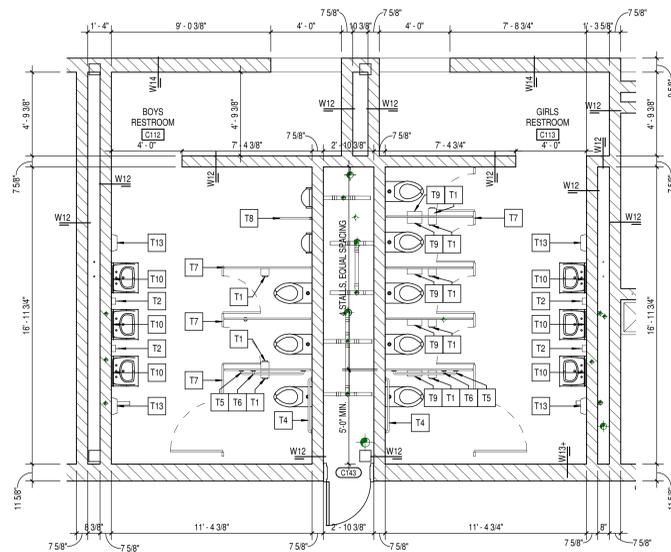


3 ENLARGED RESTROOM PLAN

A701-2 SCALE: 1/4" = 1'-0"

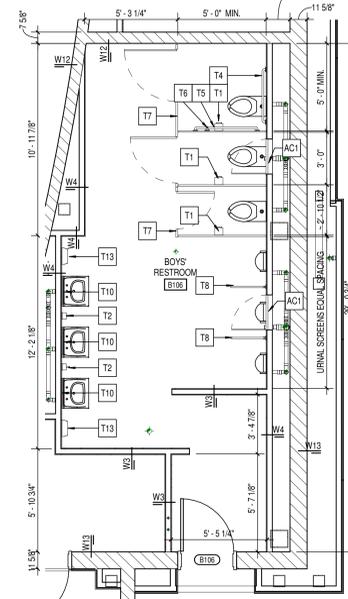

2 ENLARGED RESTROOM PLAN

A701-2 SCALE: 1/4" = 1'-0"

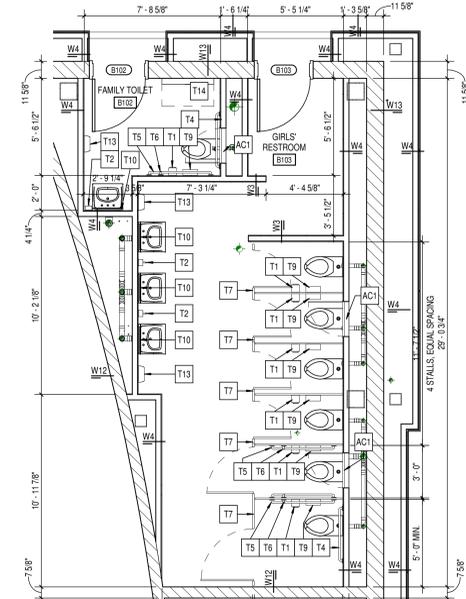


1 ENLARGED RESTROOM PLAN

A701-2 SCALE: 1/4" = 1'-0"

TOILET ACCESSORY SCHEDULE						
TYPE MARK	ITEM DESCRIPTION	MANUFACTURER	MODEL #	MOUNTING HEIGHT	FURNISHED BY	INSTALLED BY
T1	TOILET TISSUE DISPENSER - SURFACE MOUNTED	BY OWNER	-	MOUNT AS REQUIRED FOR ADA. COORDINATE LOCATION WITH GRAB BARS.	OWNER	CONTRACTOR
T2	SOAP DISPENSER - SURFACE MOUNTED	BY OWNER	-	MOUNT AS REQUIRED FOR ADA	OWNER	CONTRACTOR
T3	PAPER TOWEL DISPENSER	BY OWNER	-	MOUNT AS REQUIRED FOR ADA	OWNER	CONTRACTOR
T4	GRAB BAR - 36"	SEE SPEC #10 28 00	SEE SPEC	MOUNT AS REQUIRED FOR ADA	CONTRACTOR	CONTRACTOR
T5	GRAB BAR - 42"	SEE SPEC #10 28 00	SEE SPEC	MOUNT AS REQUIRED FOR ADA	CONTRACTOR	CONTRACTOR
T6	GRAB BAR - 18"	SEE SPEC #10 28 00	SEE SPEC	MOUNT AS REQUIRED FOR ADA	CONTRACTOR	CONTRACTOR
T7	TOILET PARTITION	SEE SPEC #10 21 13	SEE SPEC	-	CONTRACTOR	CONTRACTOR
T8	URINAL SCREEN	SEE SPEC #10 21 13	SEE SPEC	-	CONTRACTOR	CONTRACTOR
T9	SANITARY NAPKIN DISPOSAL - SURFACE MOUNTED	BY OWNER	-	MOUNT AS REQUIRED FOR ADA. COORDINATE LOCATION WITH GRAB BARS.	OWNER	CONTRACTOR
T10	MIRROR - 18"x36"	SEE SPEC #10 28 00	SEE SPEC	MOUNT AS REQUIRED FOR ADA	CONTRACTOR	CONTRACTOR
T11	MIRROR - 24"x36"	SEE SPEC #10 28 00	SEE SPEC	MOUNT AS REQUIRED FOR ADA	CONTRACTOR	CONTRACTOR
T12	MIRROR - 24"x72"	SEE SPEC #10 28 00	SEE SPEC	MOUNT AS REQUIRED FOR ADA	CONTRACTOR	CONTRACTOR
T13	ELECTRIC HAND DRYER	SEE SPEC	SEE SPEC	REFER TO MEP FOR POWER LOCATION	CONTRACTOR	CONTRACTOR
T14	BABY CHANGING STATION - SURFACE MOUNTED	SEE SPEC #10 28 00	SEE SPEC	MOUNT AS REQUIRED FOR ADA	CONTRACTOR	CONTRACTOR
T15	ADA SHOWER SEAT	SEE SPEC #10 28 00	ASI 8205	SEE DETAILS FOR MOUNTING HEIGHT	CONTRACTOR	CONTRACTOR
T16	CONTINUOUS SHOWER GRAB BAR	SEE SPEC #10 28 00	3700 - TYPE 60	-	CONTRACTOR	CONTRACTOR
T17	SHOWER ROD AND CURTAIN	SEE SPEC #10 28 00	SEE SPEC	-	CONTRACTOR	CONTRACTOR
TE1	STAGE CURTAINS AND EQUIPMENT	-	-	SEE THEATRICAL DRAWINGS	CONTRACTOR	CONTRACTOR
TS1	TROPHY SHELF	SEE SPEC	-	SIZE AS INDICATED ON INTERIOR ELEVATIONS	CONTRACTOR	CONTRACTOR


**TOILET ACCESSORIES SCHEDULE GENERAL NOTES**

- A. ACCESSORIES SCHEDULED AS BY OWNER SHALL BE INSTALLED BY CONTRACTOR IN ACCORDANCE WITH DRAWINGS AND SPECIFICATIONS.
- B. SEE SHEET A701 FOR TYPICAL TOILET ACCESSORY LAYOUT. REFER TO A600 SERIES ELEVATIONS & A600 SERIES EQUIPMENT PLANS FOR ADDITIONAL TOILET ACCESSORY ITEMS (SUCH AS PAPER TOWEL DISPENSERS, COAT HOOKS, ETC).
- C.

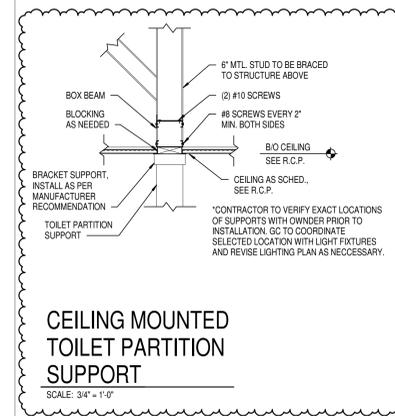

CEILING MOUNTED TOILET PARTITION SUPPORT

SCALE: 3/4" = 1'-0"

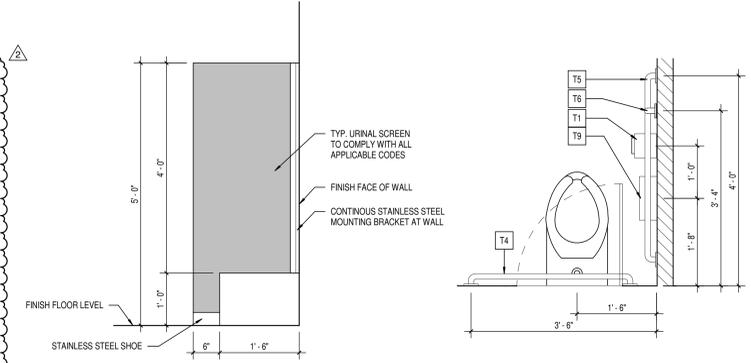

TYP. URINAL SCREEN DETAIL

SCALE: 3/4" = 1'-0"

TYPICAL TOILET ACCESSORY LAYOUT

SCALE: 3/4" = 1'-0"




PROJECT:  
SOUTHWEST ALLEN COUNTY SCHOOLS  
ADDITIONS AND RENOVATIONS TO  
HOMESTEAD HIGH SCHOOL  
4310 HOMESTEAD ROAD, FORT WAYNE, IN 46814

SCOPE DRAWINGS:  
These drawings indicate the general scope of the project in terms of architectural design concepts. The architectural, mechanical and electrical systems shown on these drawings are not necessarily indicated or described as work required for the performance and completion of the Contract.  
On the basis of the general scope indicated on these drawings, the trade contractors shall furnish all items required for the proper execution and completion of the work.

REVISIONS:  
2 ADDENDUM #2 - 12/02/2020  
PHASE 2B


ISSUE DATE DRAWN BY CHECKED BY  
10/28/2020 MKM MKM

DRAWING TITLE:  
ENLARGED RESTROOM PLANS

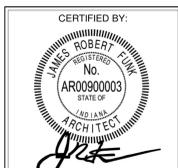


DRAWING NUMBER  
A701-2


PROJECT NUMBER  
18138

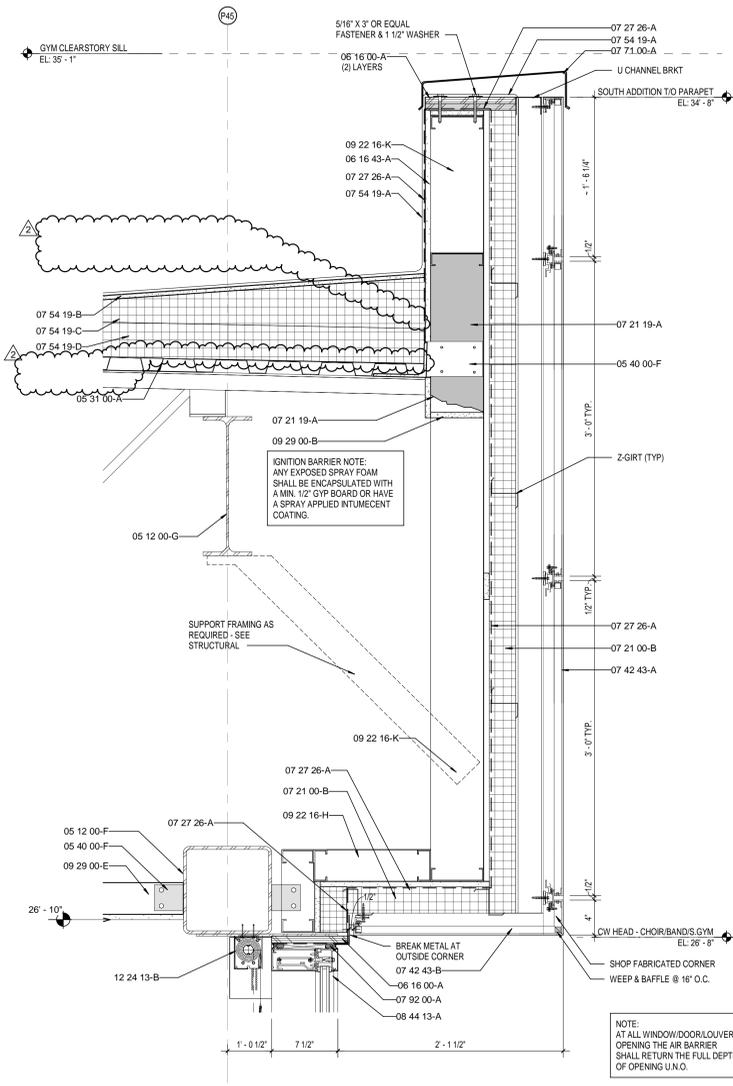


**7 ENLARGED DETAIL UNIT-B CHOIR RM - CURTAIN WALL/ SOFFIT**  
 A756-2 SCALE: 1 1/2" = 1'-0"

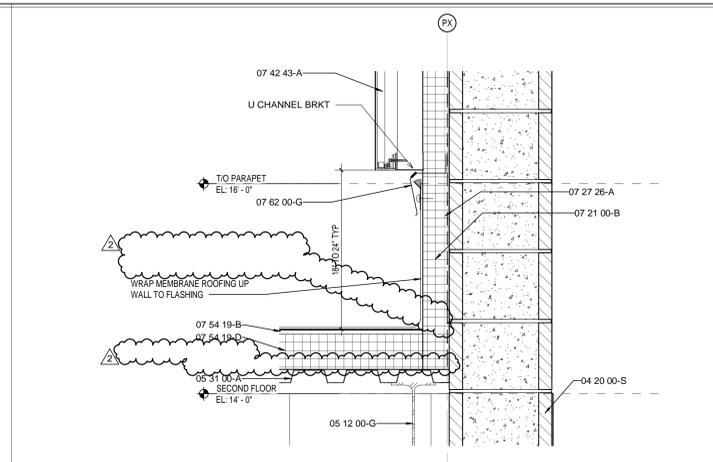


**8 ENLARGED DETAIL UNIT-B CHOIR/PRACTICE RM**  
 A756-2 SCALE: 1 1/2" = 1'-0"

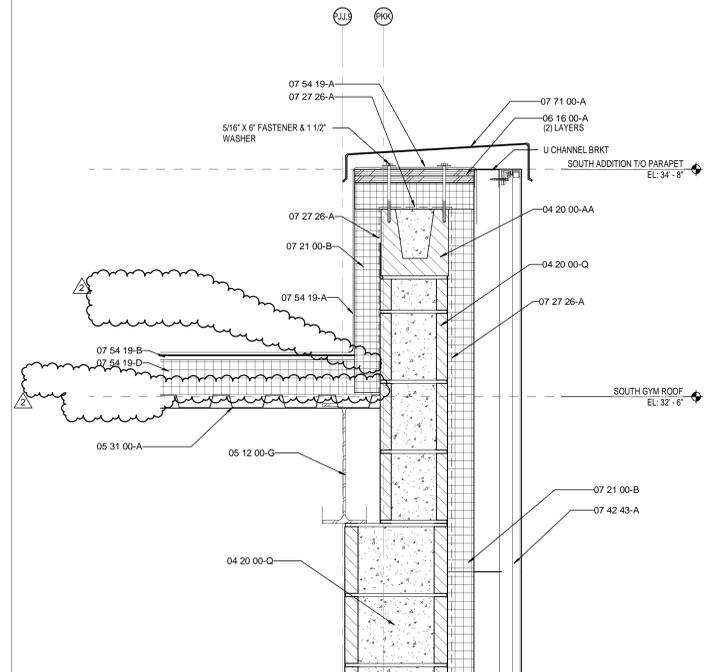


**5 ENLARGED DETAIL UNIT-B CHOIR RM**  
 A756-2 SCALE: 1 1/2" = 1'-0"

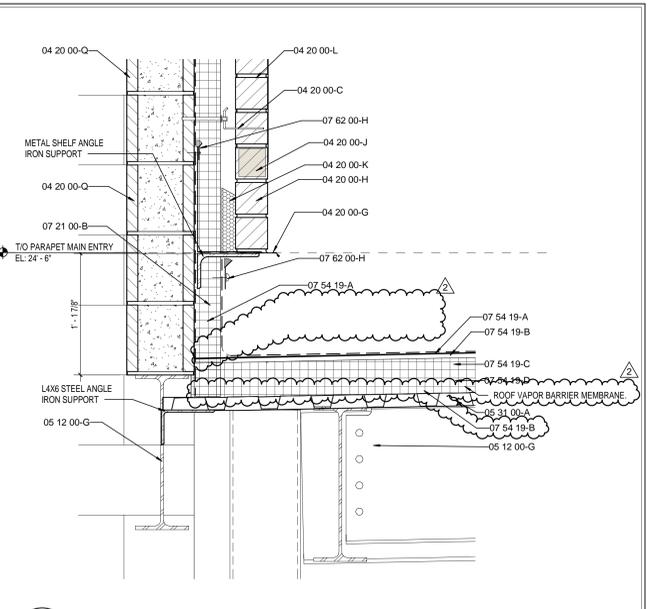


**6 ENLARGED DETAIL UNIT-B HIGH BRICK & CMU WALL**  
 A756-2 SCALE: 1 1/2" = 1'-0"

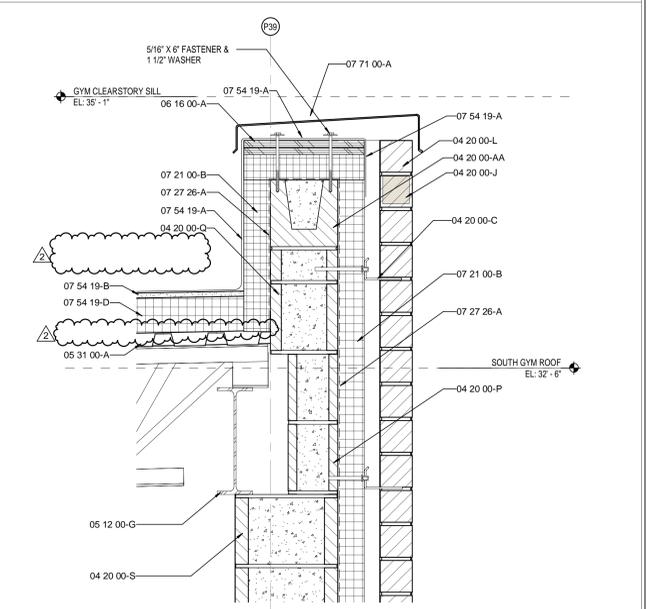


**4 ENLARGED DETAIL UNIT-B STAIR EXT. WALL**  
 A756-2 SCALE: 1 1/2" = 1'-0"

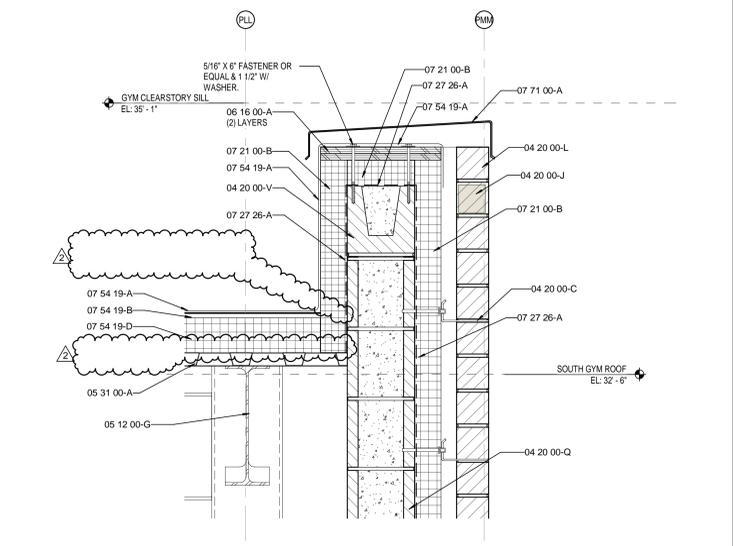

**3 ENLARGED DETAIL UNIT-B @ HIGH BRICK & CMU WALL**  
 A756-2 SCALE: 1 1/2" = 1'-0"

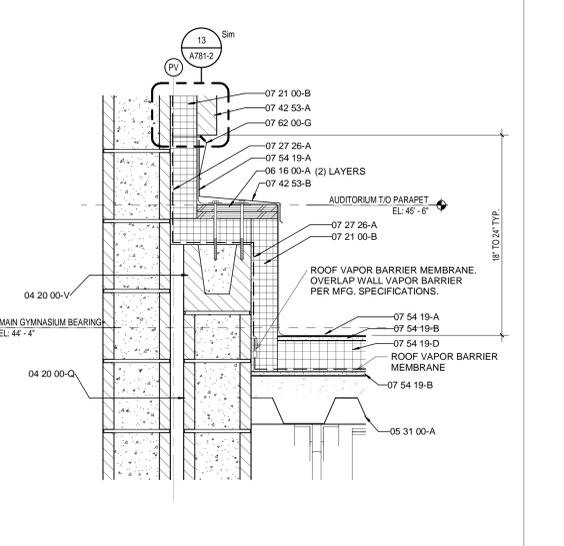

**2 UNIT B - FLY SPACE ROOF DTL**  
 A756-2 SCALE: 1 1/2" = 1'-0"

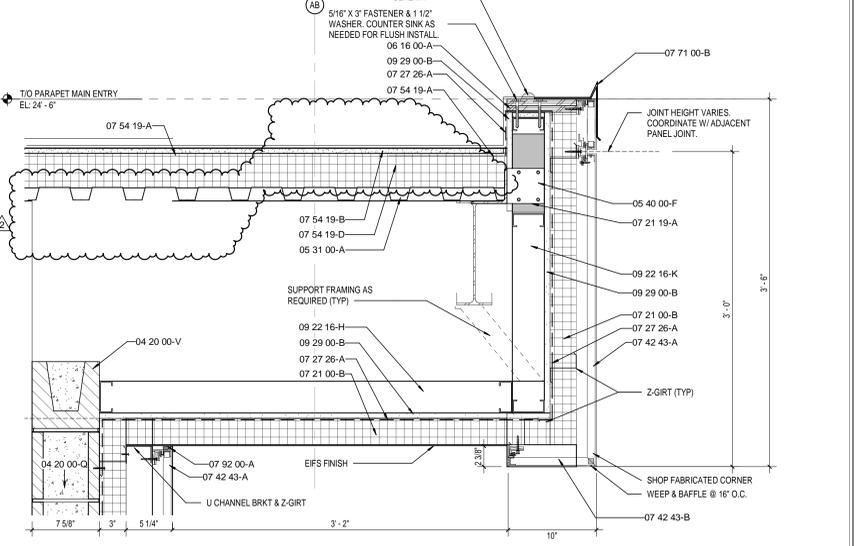

**1 ENLARGED DETAIL UNIT-A @ OVERHANG**  
 A756-2 SCALE: 1 1/2" = 1'-0"

**KEYNOTE LEGEND**

- 03 30 00-B CONCRETE SLAB OVER VAPOR BARRIER ON DRAINAGE FILL. SEE STRUCTURAL
- 03 30 00-C CONCRETE SLAB ON METAL DECK. SEE STRUCTURAL
- 03 30 00-D CONCRETE FOUNDATION. SEE STRUCTURAL
- 03 30 00-E CONCRETE FOOTING. SEE STRUCTURAL
- 03 30 00-F CONSTRUCTION JOINT
- 03 30 00-G 1/2" EXPANSION MATERIAL
- 04 20 00-A GROUT CORE SOLID
- 04 20 00-AA BOND BEAM MASONRY LINTEL
- 04 20 00-AC MASONRY TIE
- 04 20 00-AD METAL FLASHING
- 04 20 00-AE THROUGH WALL FLASHING W/ STAINLESS STEEL DRIP EDGE
- 04 20 00-AF WEEP HOLES AT 16" O.C.
- 04 20 00-AG VENTS AT 4'-0" O.C.
- 04 20 00-AH CAVITY DRAINAGE MATERIAL
- 04 20 00-AI BRICK TYPE 1
- 04 20 00-AJ BRICK TYPE 2 (ACCENT)
- 04 20 00-AM BRICK TYPE 2 (INSET ACCENT)
- 04 20 00-AN 4" CONCRETE MASONRY UNIT
- 04 20 00-AP 6" CONCRETE MASONRY UNIT
- 04 20 00-AQ 8" CONCRETE MASONRY UNIT
- 04 20 00-AR 10" CONCRETE MASONRY UNIT
- 04 20 00-AS 12" CONCRETE MASONRY UNIT
- 04 20 00-AT BULLDOZE UNIT
- 04 20 00-AV BOND BEAM MASONRY UNIT
- 04 20 00-AY SOLID UNIT
- 05 12 00-A STRUCTURAL STEEL FRAMING MEMBER. SEE STRUCTURAL
- 05 12 00-B STEEL ANGLE. SEE STRUCTURAL
- 05 12 00-C STEEL CHANNEL. SEE STRUCTURAL
- 05 12 00-D STEEL PLATE. SEE STRUCTURAL
- 05 12 00-E STEEL TUBE. SEE STRUCTURAL
- 05 12 00-F STEEL BEAM. SEE STRUCTURAL
- 05 12 00-G STEEL COLUMN. SEE STRUCTURAL
- 05 12 00-H ARCHITECTURAL EXPOSED STRUCTURAL STEEL FRAMING. SEE STRUCTURAL
- 05 21 00-A STEEL JOIST. SEE STRUCTURAL
- 05 31 00-A METAL ROOF DECKING. SEE STRUCTURAL
- 05 40 00-A 8" (MIN. 16GA) STEEL STUDS AT 16" O.C., CROSS BRACING AS REQUIRED
- 05 40 00-F CLIP ANGLE
- 05 40 00-J 3 5/8" (MIN. 16GA) GALVANIZED STEEL STUDS
- 05 40 00-K 2 1/2" (MIN. 16GA) GALVANIZED STEEL STUDS
- 05 50 00-B STEEL LINTEL. SEE STRUCTURAL
- 05 50 00-D STEEL SHELF ANGLE. SEE STRUCTURAL
- 05 50 00-F SHIPS LADDER. STEEL GRATING TREADS
- 06 10 53-B 1X WOOD BLOCKING
- 06 10 53-C 2X WOOD BLOCKING
- 06 16 00-A 3/4" PRESERVATIVE-TREATED PLYWOOD
- 06 16 43-A 5/8" EXTERIOR GYPSUM SHEATHING
- 06 42 19-A PLASTIC LAMINATE PANEL SYSTEM
- 07 21 00-A SLAB PERIMETER RIGID INSULATION
- 07 21 00-B 3" THERMALLY ISOLATED Z-GIRT COMPOSITE INSULATION SYSTEM
- 07 21 00-C PACK FILL WITH MINERAL WOOL BLANKET INSULATION
- 07 21 00-D 3" CAVITY WALL EXTRUDED POLYSTYRENE INSULATION
- 07 21 00-E SPRAY POLYURETHANE FOAM INSULATION
- 07 21 00-F FLUID APPLIED MEMBRANE AIR BARRIER, VAPOR PERMEABLE
- 07 42 15-A VERTICAL WALL PANELS
- 07 42 43-A ACM WALL PANEL SYSTEM
- 07 42 43-B ACM SOFFIT PANEL SYSTEM
- 07 42 43-C ACM EXTERIOR COLUMN COVERS
- 07 42 43-D PHENOLIC WALL PANEL SYSTEM
- 07 42 53-A PROFILE METAL WALL PANEL
- 07 42 53-B FLASHING
- 07 42 53-D METAL SOFFIT PANELS
- 07 42 53-E MEMBRANE ROOFING - EXTEND OVER AND ATTACH TO FRONT FACE OF PARAPET
- 07 54 19-B 1/2" COVER BOARD
- 07 54 19-C TAPERED POLYISO INSULATION BOARD
- 07 54 19-D 2 LAYERS OF 2" POLYISO INSULATION BOARD
- 07 62 00-G 2 PIECE COUNTERFLASHING
- 07 62 00-H TERMINATION BAR
- 07 62 00-I DRIP EDGE
- 07 62 00-L ROOF EXPANSION JOINT METAL COVER
- 07 62 00-N 4x4 PRE-FINISHED METAL GUTTER
- 07 62 00-O PREFINISHED METAL DOWNSPOUT
- 07 71 00-A CORNER
- 07 71 00-B GRAVEL STOP
- 07 71 00-C FASCIA CLADDING
- 07 71 00-D MANUFACTURED COUNTERFLASHING SYSTEM
- 07 71 00-E MANUFACTURED GUTTER
- 07 71 00-F MANUFACTURED DOWNSPOUT
- 07 71 00-G MANUFACTURED SCUPPER
- 07 92 00-A BACKER ROD AND SEALANT
- 07 92 00-B SEALANT EACH SIDE, TYPICAL
- 07 95 00-A EXPANSION JOINT ASSEMBLY
- 07 95 00-B WALL EXPANSION JOINT COVER
- 07 95 00-C CEILING EXPANSION JOINT COVER
- 07 95 00-D EXTERIOR WALL EXPANSION JOINT SYSTEM
- 08 11 13-A HOLLOW METAL DOOR/BORROWED LIGHT FRAME
- 08 11 13-B HOLLOW METAL DOOR
- 08 11 16-A ALUMINUM FLUSH DOOR
- 08 33 13-A OVERHEAD COILING DOOR DOOR
- 08 33 23-A OVERHEAD COILING DOOR
- 08 33 23-B OVERHEAD COILING DOOR - INSULATED
- 08 33 26-A OVERHEAD COILING GRILLE
- 08 41 13-A 4 1/2" ALUMINUM-FRAMED STOREFRONT
- 08 41 13-B WIDE STYLE ALUMINUM ENTRANCE DOOR
- 08 44 13-A 2 5/8" x 7 5/8" CURTAIN WALL SYSTEM
- 08 45 13-A FIBERGLASS SANDWICH PANEL WALL ASSEMBLIES
- 08 45 23-A FIBERGLASS SANDWICH PANEL WALL ASSEMBLIES - VERTICAL WALL PANEL
- 08 80 00-A GLAZING - SEE SCHEDULE/ELEVATIONS
- 08 80 00-B 1" INSULATED GLASS
- 08 80 00-D 1" INSULATED SPANDREL GLASS
- 08 80 00-E SPANDREL GLASS
- 08 87 00-A GLAZING FILM (SECURITY)
- 09 22 16-D 7/8" FURRING CHANNEL
- 09 22 16-E 1 1/2" FURRING CHANNEL
- 09 22 16-G 2 1/2" STEEL STUD
- 09 22 16-H 3 5/8" STEEL STUD
- 09 22 16-K 6" STEEL STUD
- 09 22 16-M METAL STUD KICKERS AS REQUIRED
- 09 29 00-B 5/8" GYPSUM WALL BOARD (SEE SPECS FOR TYPE)
- 09 29 00-D SOUND ATTENUATION INSULATION
- 09 29 00-E SUSPENDED GYPSUM BOARD CEILING ASSEMBLY
- 09 30 00-F SEALANT - COLOR TO MATCH
- 09 51 13-A ACOUSTICAL CEILING SUSPENSION ASSEMBLY
- 09 84 33-A SOUND DIFFUSERS
- 09 84 33-B SOUND DIFFUSING PANEL. SEE EQUIPMENT SCHEDULE
- 10 12 00-A DISPLAY CASE. SEE EQUIPMENT SCHEDULE
- 10 14 19-A SIGNS - DIMENSIONAL CHARACTERS AND LOGO FOR EXTERIOR USE
- 11 61 33-D MUSIC ROOM CURTAIN TRACK SYSTEM
- 11 61 43-A STAGE CURTAIN - MAIN
- 12 24 13-B ROLLER SHADES - MOTORIZED ROLLER WINDOW SHADES - SEE EQUIPMENT SCHEDULE
- 12 36 63-A SOLID SURFACE COUNTERTOPS
- 12 66 00-A TELESCOPING STAND SEATING. SEE EQUIPMENT SCHEDULE
- 31 20 00-B COMPACTED EARTH
- 31 20 00-C DRAINING GRANULAR FILL



**SACS**  
SOUTHWEST ALLEN COUNTY SCHOOLS



**HOMESTEAD HIGH SCHOOL**



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FORT WAYNE, IN 46802  
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**SOUTHWEST ALLEN COUNTY SCHOOLS**  
ADDITIONS AND RENOVATIONS TO  
**HOMESTEAD HIGH SCHOOL**  
4310 HOMESTEAD ROAD, FORT WAYNE, IN 46814

**SCOPE DRAWINGS:**

These drawings indicate the general scope of the project in terms of architectural design content. The delineation of structural, mechanical and electrical systems is for informational purposes only and does not constitute a contract. The contractor shall verify the accuracy of all dimensions and quantities shown on these drawings and shall be responsible for the proper execution and completion of the work.

**REVISIONS:**


2 ADDENDUM #2 - 12/02/2020  
PHASE 2B

ISSUE DATE	DRAWN BY	CHECKED BY
10/28/2020	MMK	MMK

**DRAWING TITLE:**

**ENLARGED PLAN DETAILS**

**CERTIFIED BY:**

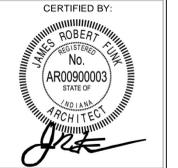

**DRAWING NUMBER**  
**A756-2**

**PROJECT NUMBER**  
**18138**



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THEATRE PLANNERS / LIGHTING DESIGNERS  
**Schuler Shook**

750 NORTH CHICAGO  
CHICAGO, IL 60614  
T: 312.944.8230 F: 312.944.8237  
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PROJECT:  
**SOUTHWEST ALLEN COUNTY SCHOOLS  
ADDITIONS AND RENOVATIONS TO  
HOMESTEAD HIGH SCHOOL**  
4310 HOMESTEAD ROAD, FORT WAYNE, IN 46814

**SCOPE DRAWINGS:**

These drawings indicate the general scope of the project in terms of architectural design content, the structural, mechanical, electrical and plumbing systems. The drawings do not necessarily indicate or describe all work required for full performance and completion of the project. On the basis of the general scope indicated or described, the trade contractors shall furnish all items required for the proper execution and completion of the work.

**REVISIONS:**

2 ADDENDUM 2 12/2/2020


**ISSUE DATE** **DRAWN BY** **CHECKED BY**

10/27/20 KJG JG

**DRAWING TITLE:**

**STAGE  
LIGHTING  
SYSTEM  
PROSCENIUM  
ELEVATION**

**CERTIFIED BY:**

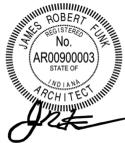


**DRAWING NUMBER**

**TE311B**


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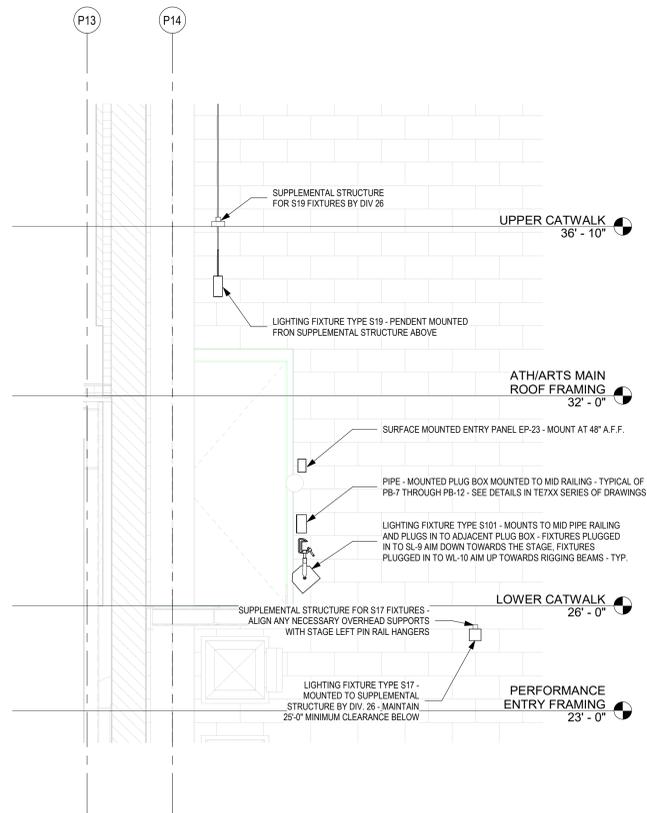
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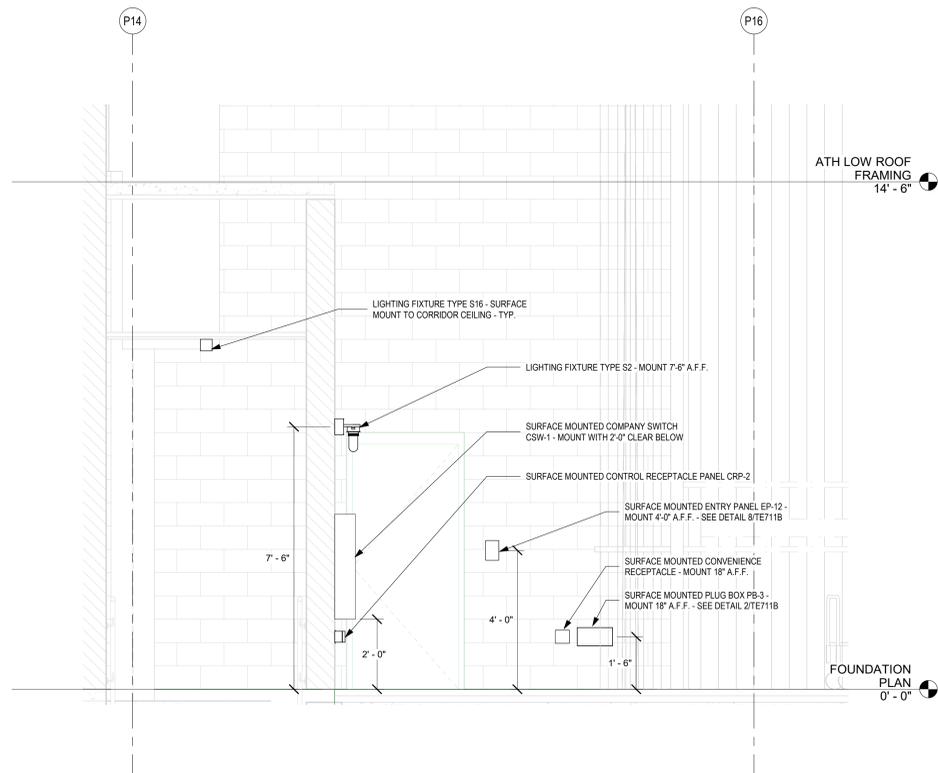
SECOND FLOOR  
PLAN  
14' - 0"

**1** ELEVATION - PROSCENIUM STAGE LIGHTING COORDINATION AND MOUNTING  
SCALE: 1/4" = 1'-0"

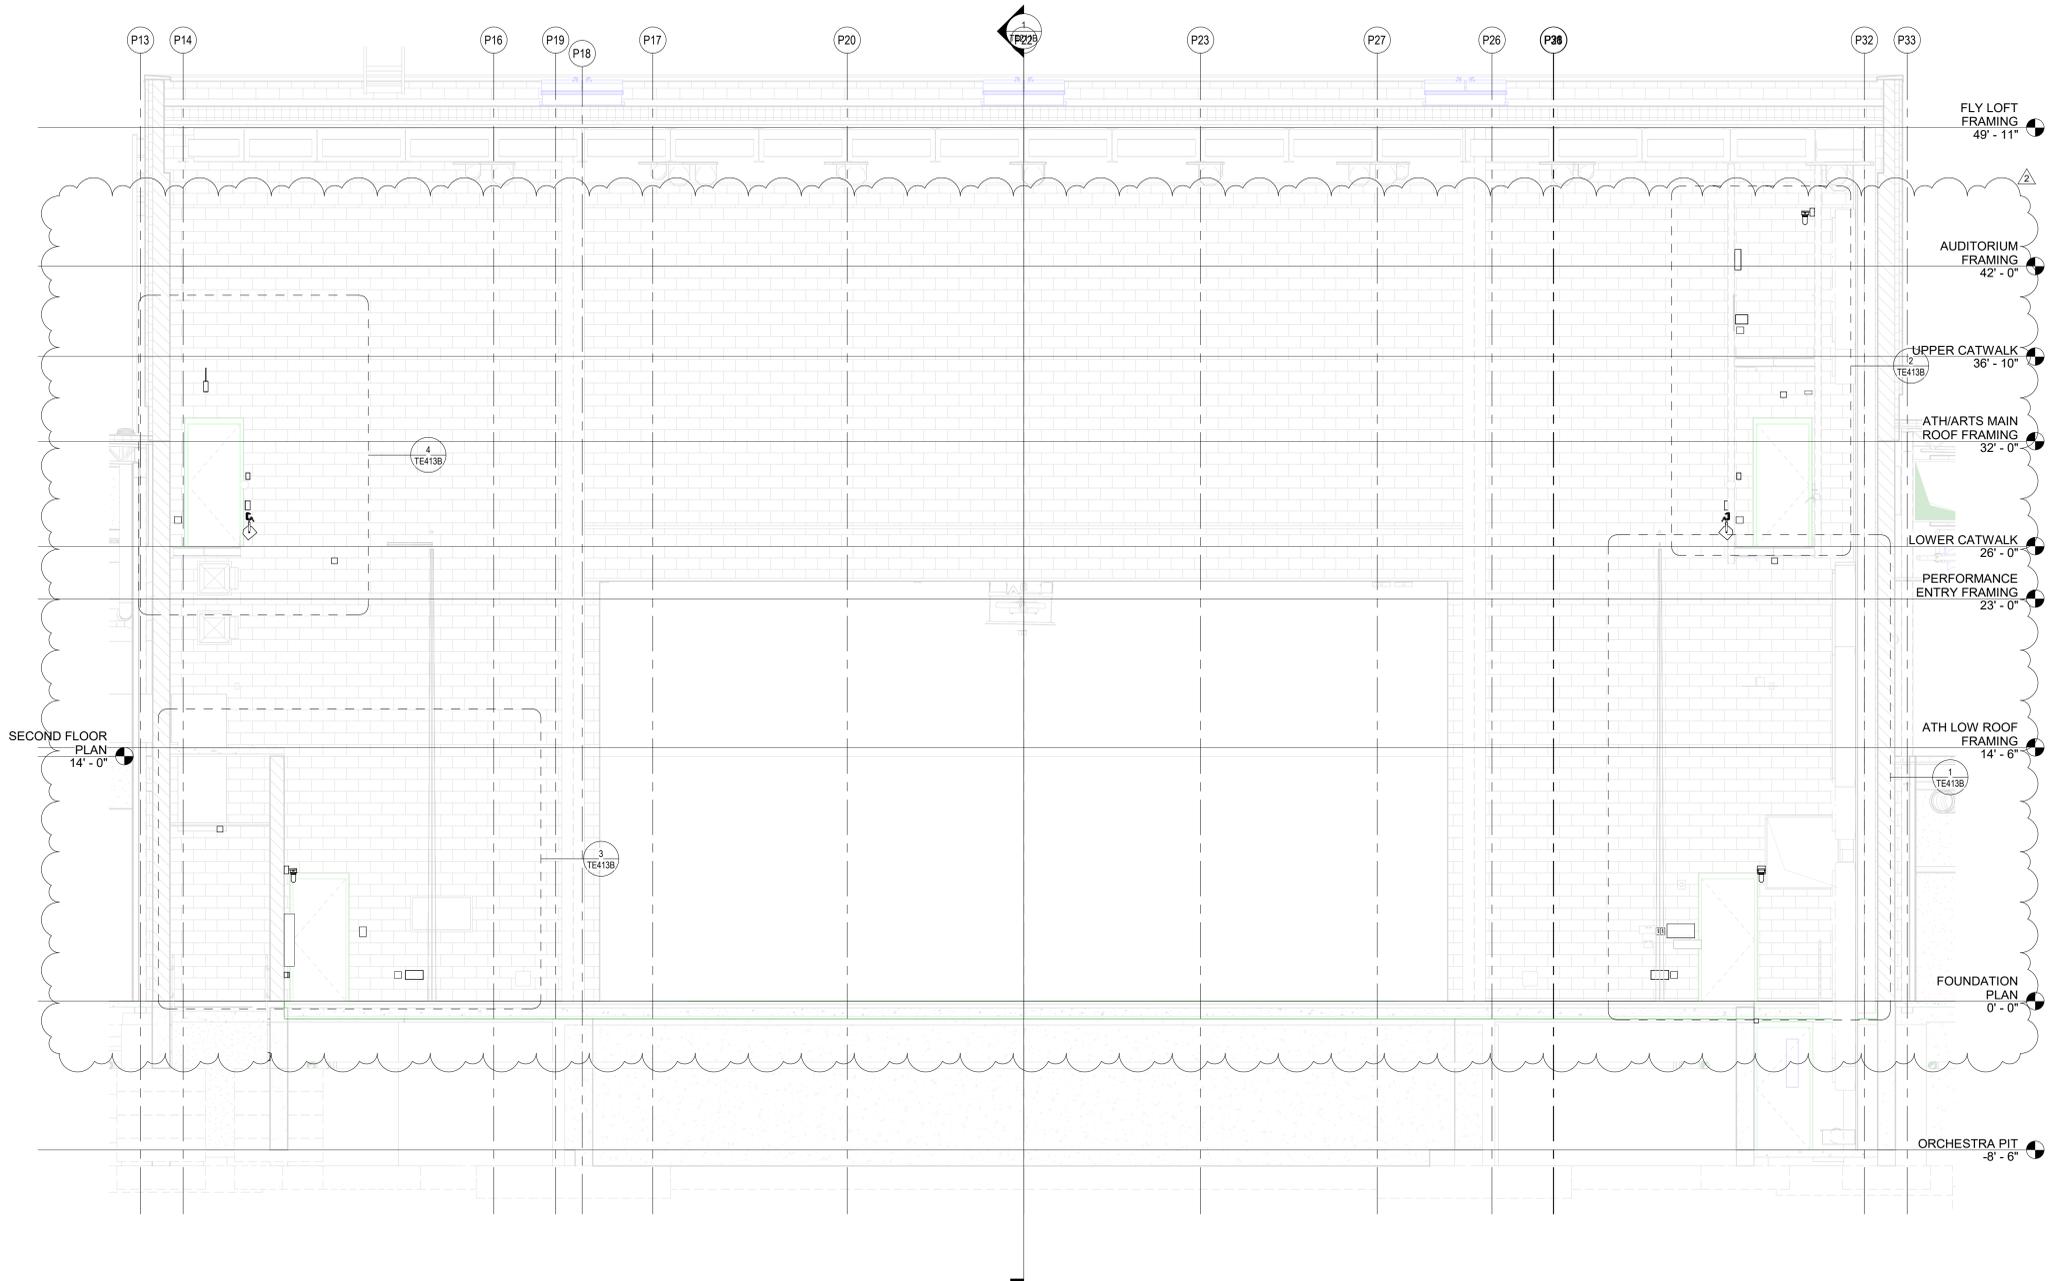





**4** ELEVATION DETAIL - STAGE LEFT PINRAIL GALLERY  
SCALE: 1/2" = 1'-0"

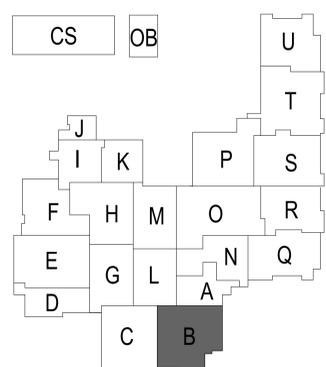


**3** ELEVATION DETAIL - STAGE LEFT PROSCENIUM COORDINATION  
SCALE: 1/2" = 1'-0"

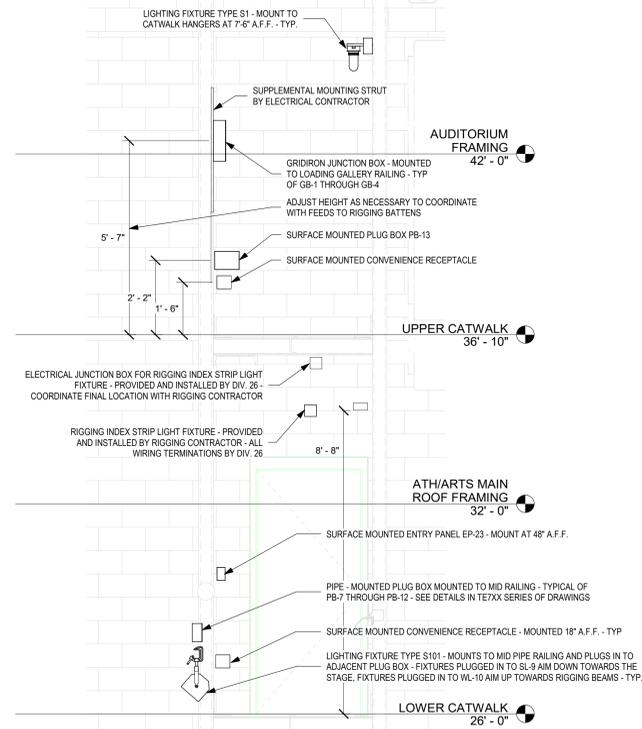

**2** ELEVATION DETAIL - STAGE RIGHT PINRAIL GALLERY  
SCALE: 1/2" = 1'-0"

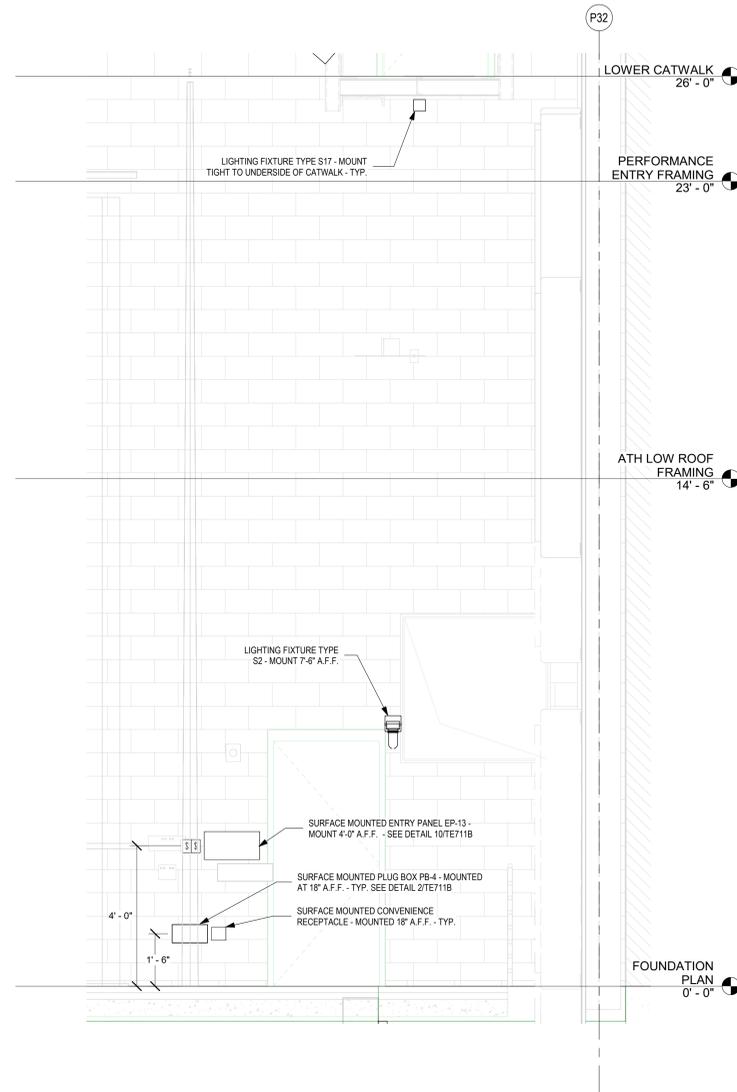

**1** ELEVATION DETAIL - STAGE RIGHT PROSCENIUM COORDINATION  
SCALE: 1/2" = 1'-0"

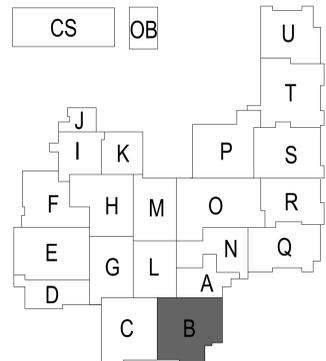

PROJECT:  
SOUTHWEST ALLEN COUNTY SCHOOLS  
ADDITIONS AND RENOVATIONS TO  
HOMESTEAD HIGH SCHOOL  
4310 HOMESTEAD ROAD, FORT WAYNE, IN 46814

SCOPE DRAWINGS:  
These drawings indicate the general scope of the project. The contractor shall coordinate the structural, mechanical, electrical and plumbing systems with the design team. The contractor shall be responsible for all work required for the performance and completion of the project. On the basis of the general scope indicated on drawings, the contractor shall furnish all items required for the proper execution and completion of the work.

REVISIONS:  
2 ADDENDUM 2 12/2/2020

ISSUE DATE	DRAWN BY	CHECKED BY
11/05/20	Author	Checker


DRAWING TITLE:  
**STAGE LIGHTING SYSTEM PROSCENIUM COORDINATION**



DRAWING NUMBER  
**TE413B**


PROJECT NUMBER  
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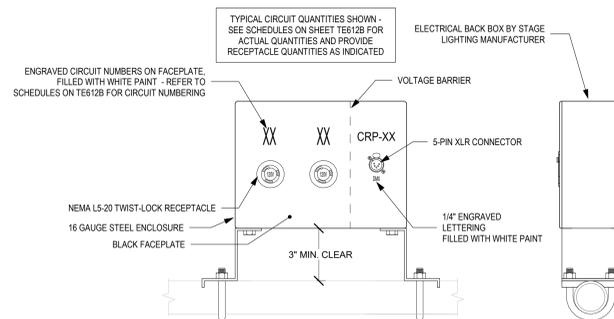
14 DETAIL - TYPICAL FLUSH MOUNTED ENTRY PANEL  
SCALE: 3" = 1'-0"

TYPICAL OF EP-101 AND EP-102

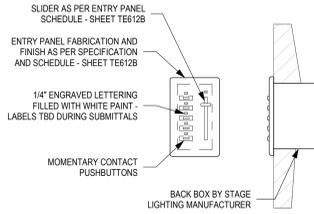


9 DETAIL - TYPICAL FLUSH MOUNTED ENTRY PANEL  
SCALE: 3" = 1'-0"

TYPICAL OF EP-14

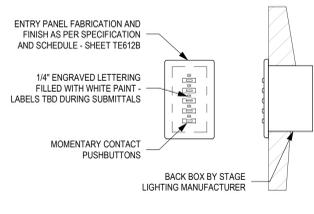


4 DETAIL - TYPICAL PIPE MOUNTED PLUG BOX  
SCALE: 3" = 1'-0"

TYPICAL OF PB-15 THROUGH PB-17

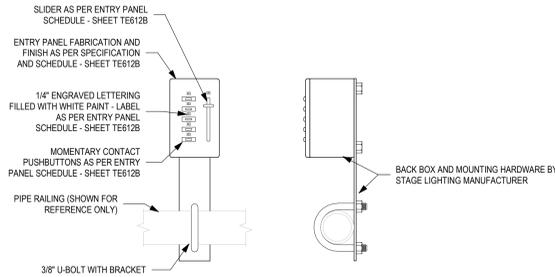


13 DETAIL - TYPICAL PIPE MOUNTED ENTRY PANEL  
SCALE: 3" = 1'-0"

TYPICAL OF EP-19

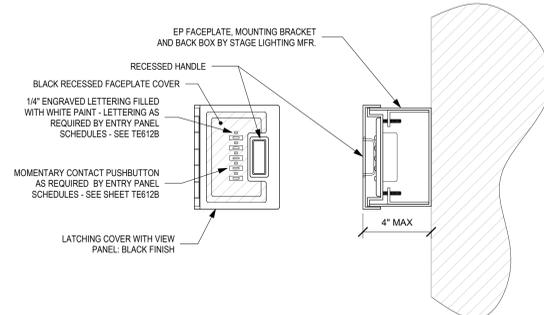


8 DETAIL - SURFACE MOUNTED ENTRY PANEL WITH COVER  
SCALE: 3" = 1'-0"

TYPICAL OF EP-3 AND EP-10 THROUGH EP-12

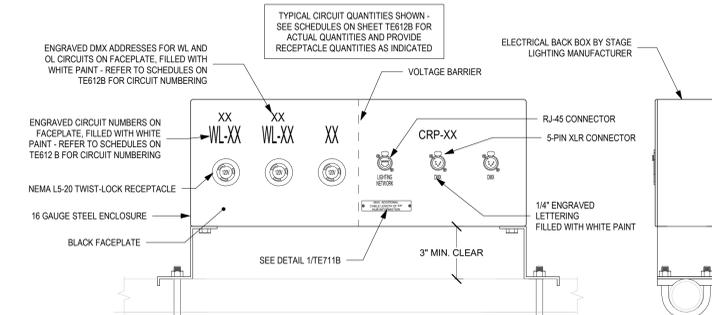


3 DETAIL - TYPICAL PIPE MOUNTED PLUG BOX  
SCALE: 3" = 1'-0"

TYPICAL OF PB-7 THROUGH PB-12

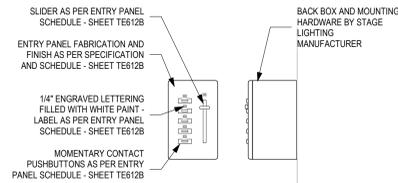


12 DETAIL - TYPICAL SURFACE MOUNTED ENTRY PANEL  
SCALE: 3" = 1'-0"

TYPICAL OF EP-22 AND EP-23

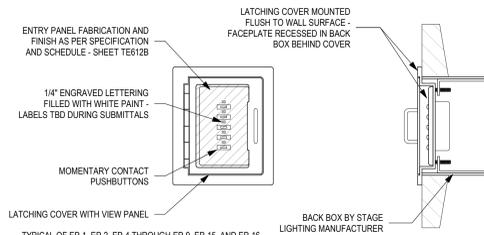


7 DETAIL - RECESSED MOUNTED ENTRY PANEL WITH COVER  
SCALE: 3" = 1'-0"

TYPICAL OF EP-1, EP-2, EP-4 THROUGH EP-9, EP-15, AND EP-16

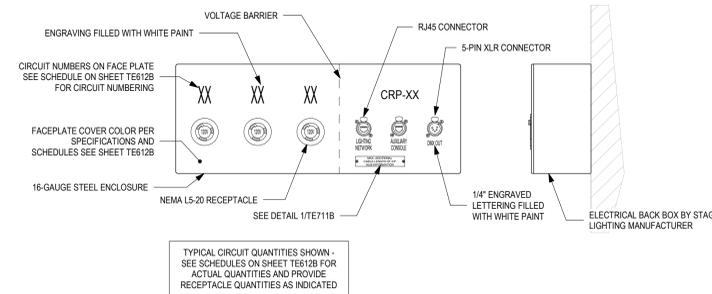


2 DETAIL - TYPICAL SURFACE MOUNTED PLUG BOX  
SCALE: 3" = 1'-0"

TYPICAL OF PB-1 THROUGH PB-6, PB-13, AND PB-18 THROUGH PB-21

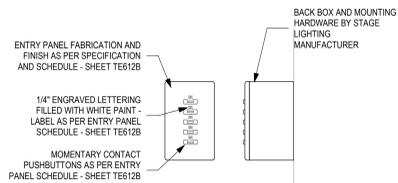


11 DETAIL - TYPICAL SURFACE MOUNTED ENTRY PANEL  
SCALE: 3" = 1'-0"

TYPICAL OF EP-20, EP-21, AND EP-24

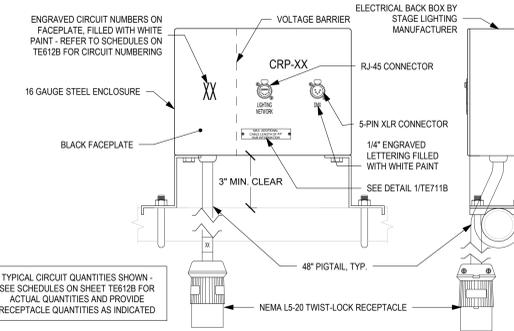


6 DETAIL - TYPICAL PIPE MOUNTED PLUG BOX  
SCALE: 3" = 1'-0"

TYPICAL OF PB-14

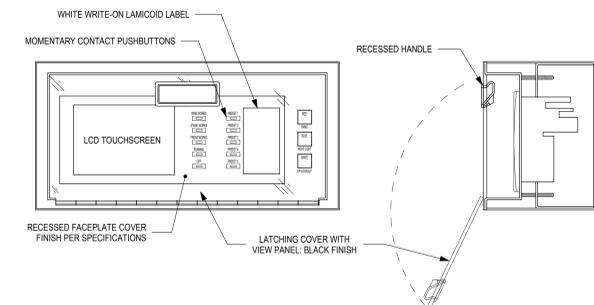


10 DETAIL - SURFACE MOUNTED ENTRY PANEL  
SCALE: 3" = 1'-0"

TYPICAL OF EP-13

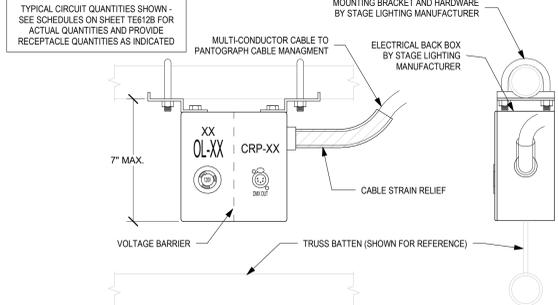

5 DETAIL - TYPICAL TRUSS BATTEN MOUNTED PLUGBOX  
SCALE: 3" = 1'-0"

TYPICAL OF DB-1 THROUGH DB-3

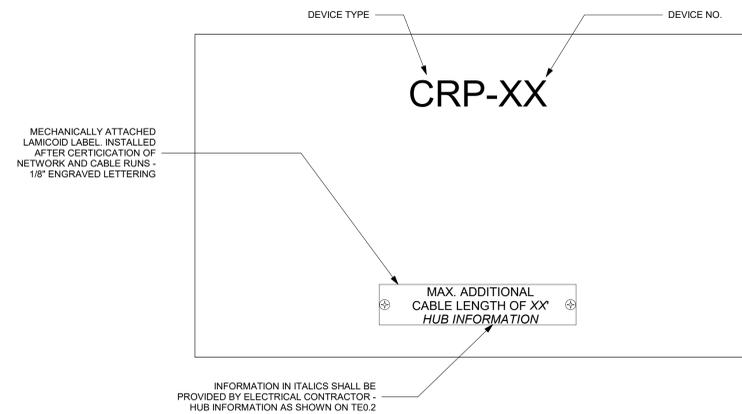

1 LEGEND - CONTROL RECEPTACLE PANEL LABELING  
SCALE: 12" = 1'-0"




PROJECT:  
SOUTHWEST ALLEN COUNTY SCHOOLS  
ADDITIONS AND RENOVATIONS TO  
HOMESTEAD HIGH SCHOOL  
4310 HOMESTEAD ROAD, FORT WAYNE, IN 46814

SCOPE DRAWINGS:  
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REVISIONS:  
2 ADDENDUM 2 12/2/2020


ISSUE DATE DRAWN BY CHECKED BY  
11/06/20 KJG JG

DRAWING TITLE:  
STAGE LIGHTING SYSTEM PANEL DETAILS

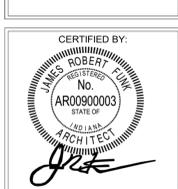


DRAWING NUMBER  
TE711B


PROJECT NUMBER  
18138

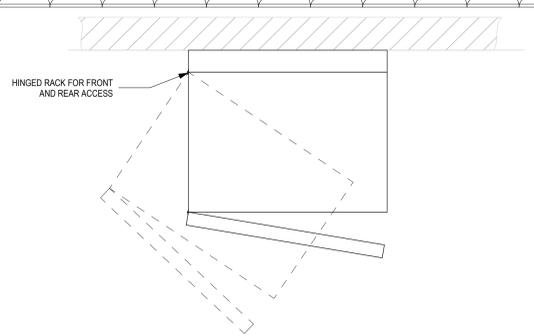


**8 PLAN DETAIL - SIGNAL PROCESSING RACK**  
SCALE: 1 1/2" = 1'-0"

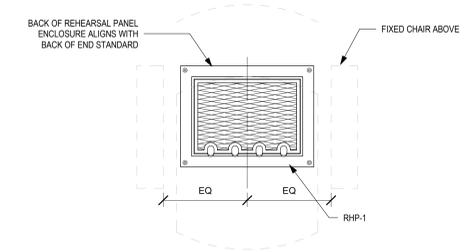


**5 COORDINATION DETAIL - REHEARSAL PANEL**  
SCALE: 1 1/2" = 1'-0" TYPICAL OF RHP-1

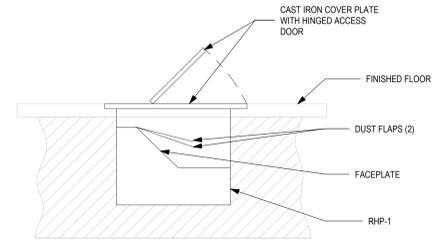


**4 SECTION DETAIL - REHEARSAL PANEL**  
SCALE: 3" = 1'-0" TYPICAL OF RHP-1

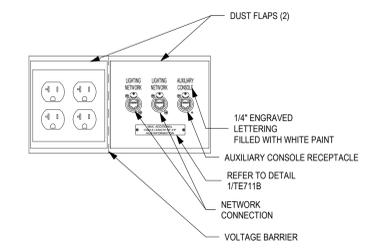


**3 DETAIL - REHEARSAL PANEL FACEPLATE**  
SCALE: 3" = 1'-0" TYPICAL OF RHP-1

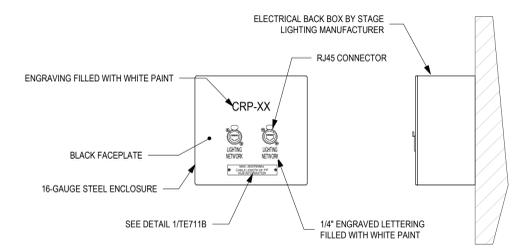


**2 DETAIL - SURFACE MOUNTED CONTROL RECEPTACLE PANEL**  
SCALE: 3" = 1'-0" TYPICAL OF CRP-2

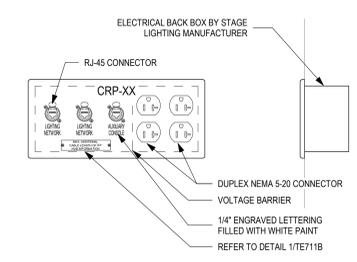


**1 DETAIL - FLUSH MOUNTED CONTROL RECEPTACLE PANEL**  
SCALE: 3" = 1'-0" TYPICAL OF CRP-1

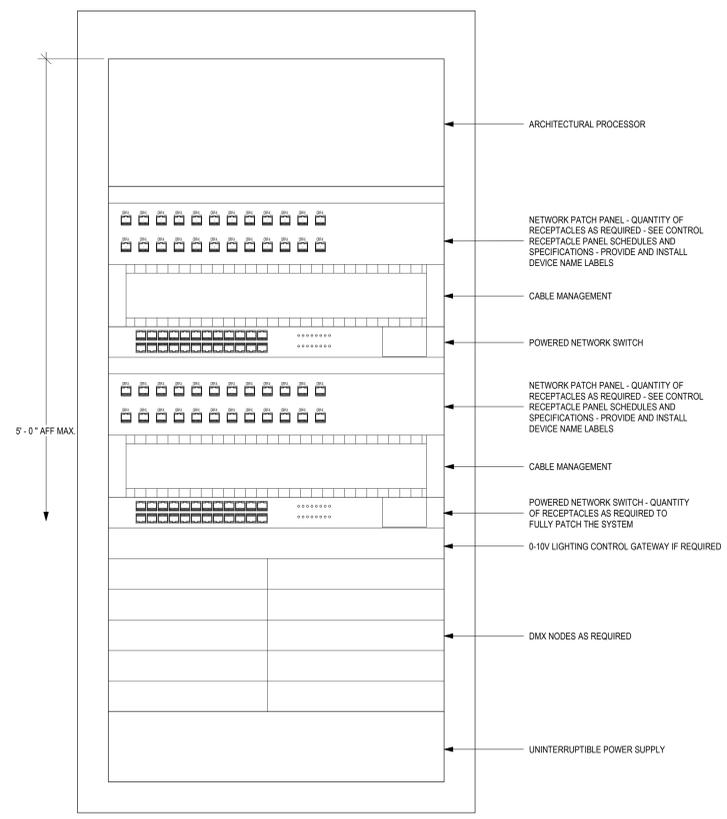


**7 DETAIL - SIGNAL PROCESSING RACK**  
SCALE: 3" = 1'-0"

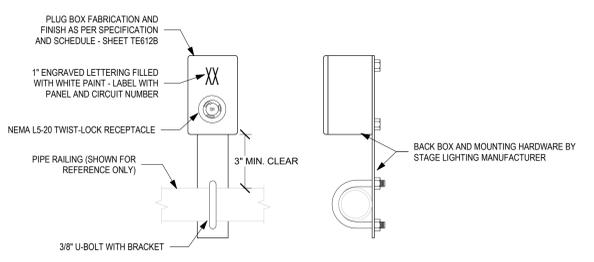


**6 DETAIL - PIPE MOUNTED PLUG BOX FOR GRAY BOX PIPE GRID**  
SCALE: 3" = 1'-0"

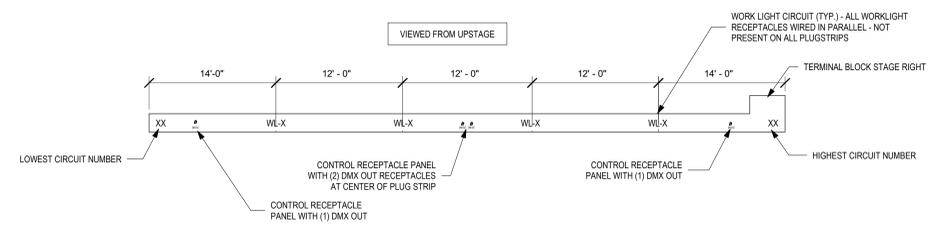

**11 DETAIL - TYPICAL ELECTRIC LINESET PLUGSTRIP**  
SCALE: 1/2" = 1'-0"

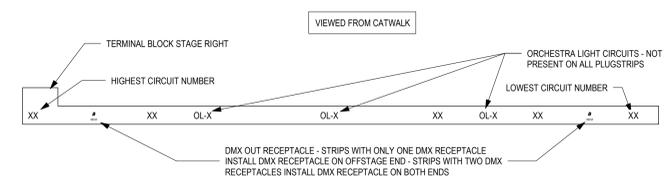

**10 DETAIL - TYPICAL FOH PLUGSTRIP**  
SCALE: 1/2" = 1'-0"

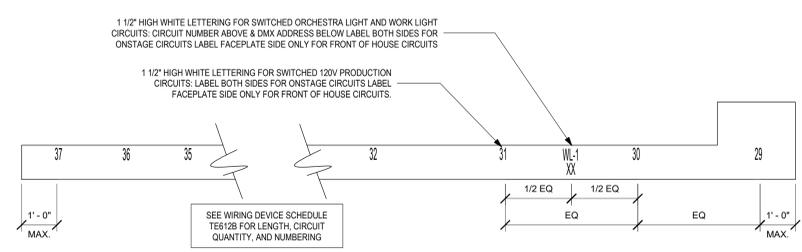

**9 LEGEND - TYPICAL PLUGSTRIP LAYOUTS AND LABELING**  
SCALE: 1/2" = 1'-0"



**SACS**  
SOUTHWEST ALLEN COUNTY SCHOOLS



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PROJECT:  
**SOUTHWEST ALLEN COUNTY SCHOOLS  
ADDITIONS AND RENOVATIONS TO  
HOMESTEAD HIGH SCHOOL**  
4310 HOMESTEAD ROAD, FORT WAYNE, IN 46814

**SCOPE DRAWINGS:**  
These drawings indicate the general scope of the project in terms of architectural design concept, the structure of the building, the mechanical and electrical systems. The design is not necessarily indicative of location or work required for full performance and completion of the requirements of the Contract.  
On the basis of the general scope indicated on drawings, the trade contractors shall furnish all items required for the proper execution and completion of the work.

**REVISIONS:**  
2 ADDENDUM 2 12/2/2020


ISSUE DATE	DRAWN BY	CHECKED BY
12/02/20	KJG	JG

**DRAWING TITLE:**  
**STAGE LIGHTING SYSTEM PANEL DETAILS**


**CERTIFIED BY:**  
JAMES ROBERT FLUK  
REGISTERED ARCHITECT  
No. ARO9090003  
STATE OF INDIANA  
*[Signature]*

**DRAWING NUMBER**  
**TE713B**


**PROJECT NUMBER**  
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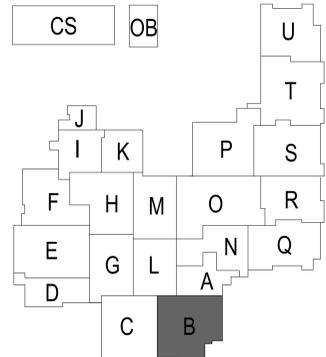
**2** TE DETAIL - STGE EDGE MARKER LIGHT SWITCH  
SCALE: 3" = 1'-0"

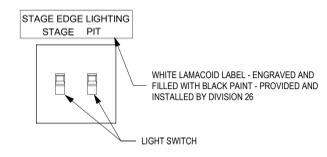

**1** TE DETAIL - AUX Console  
SCALE: 6" = 1'-0"

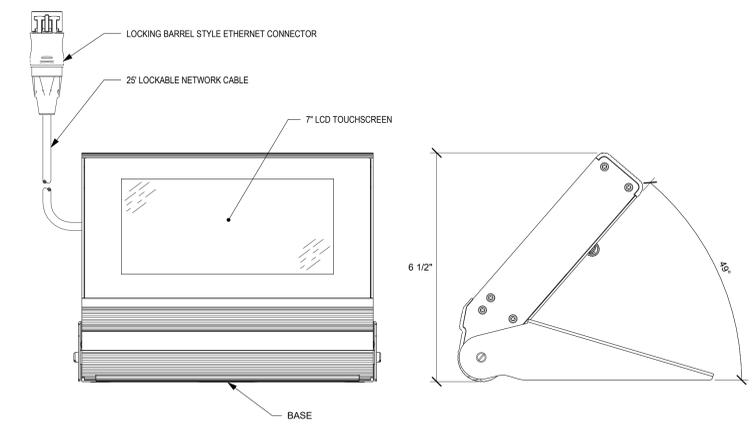

1 PLAN - STAGE RIGGING LAYOUT - STAGE LEVEL  
SCALE: 1/4" = 1'-0"

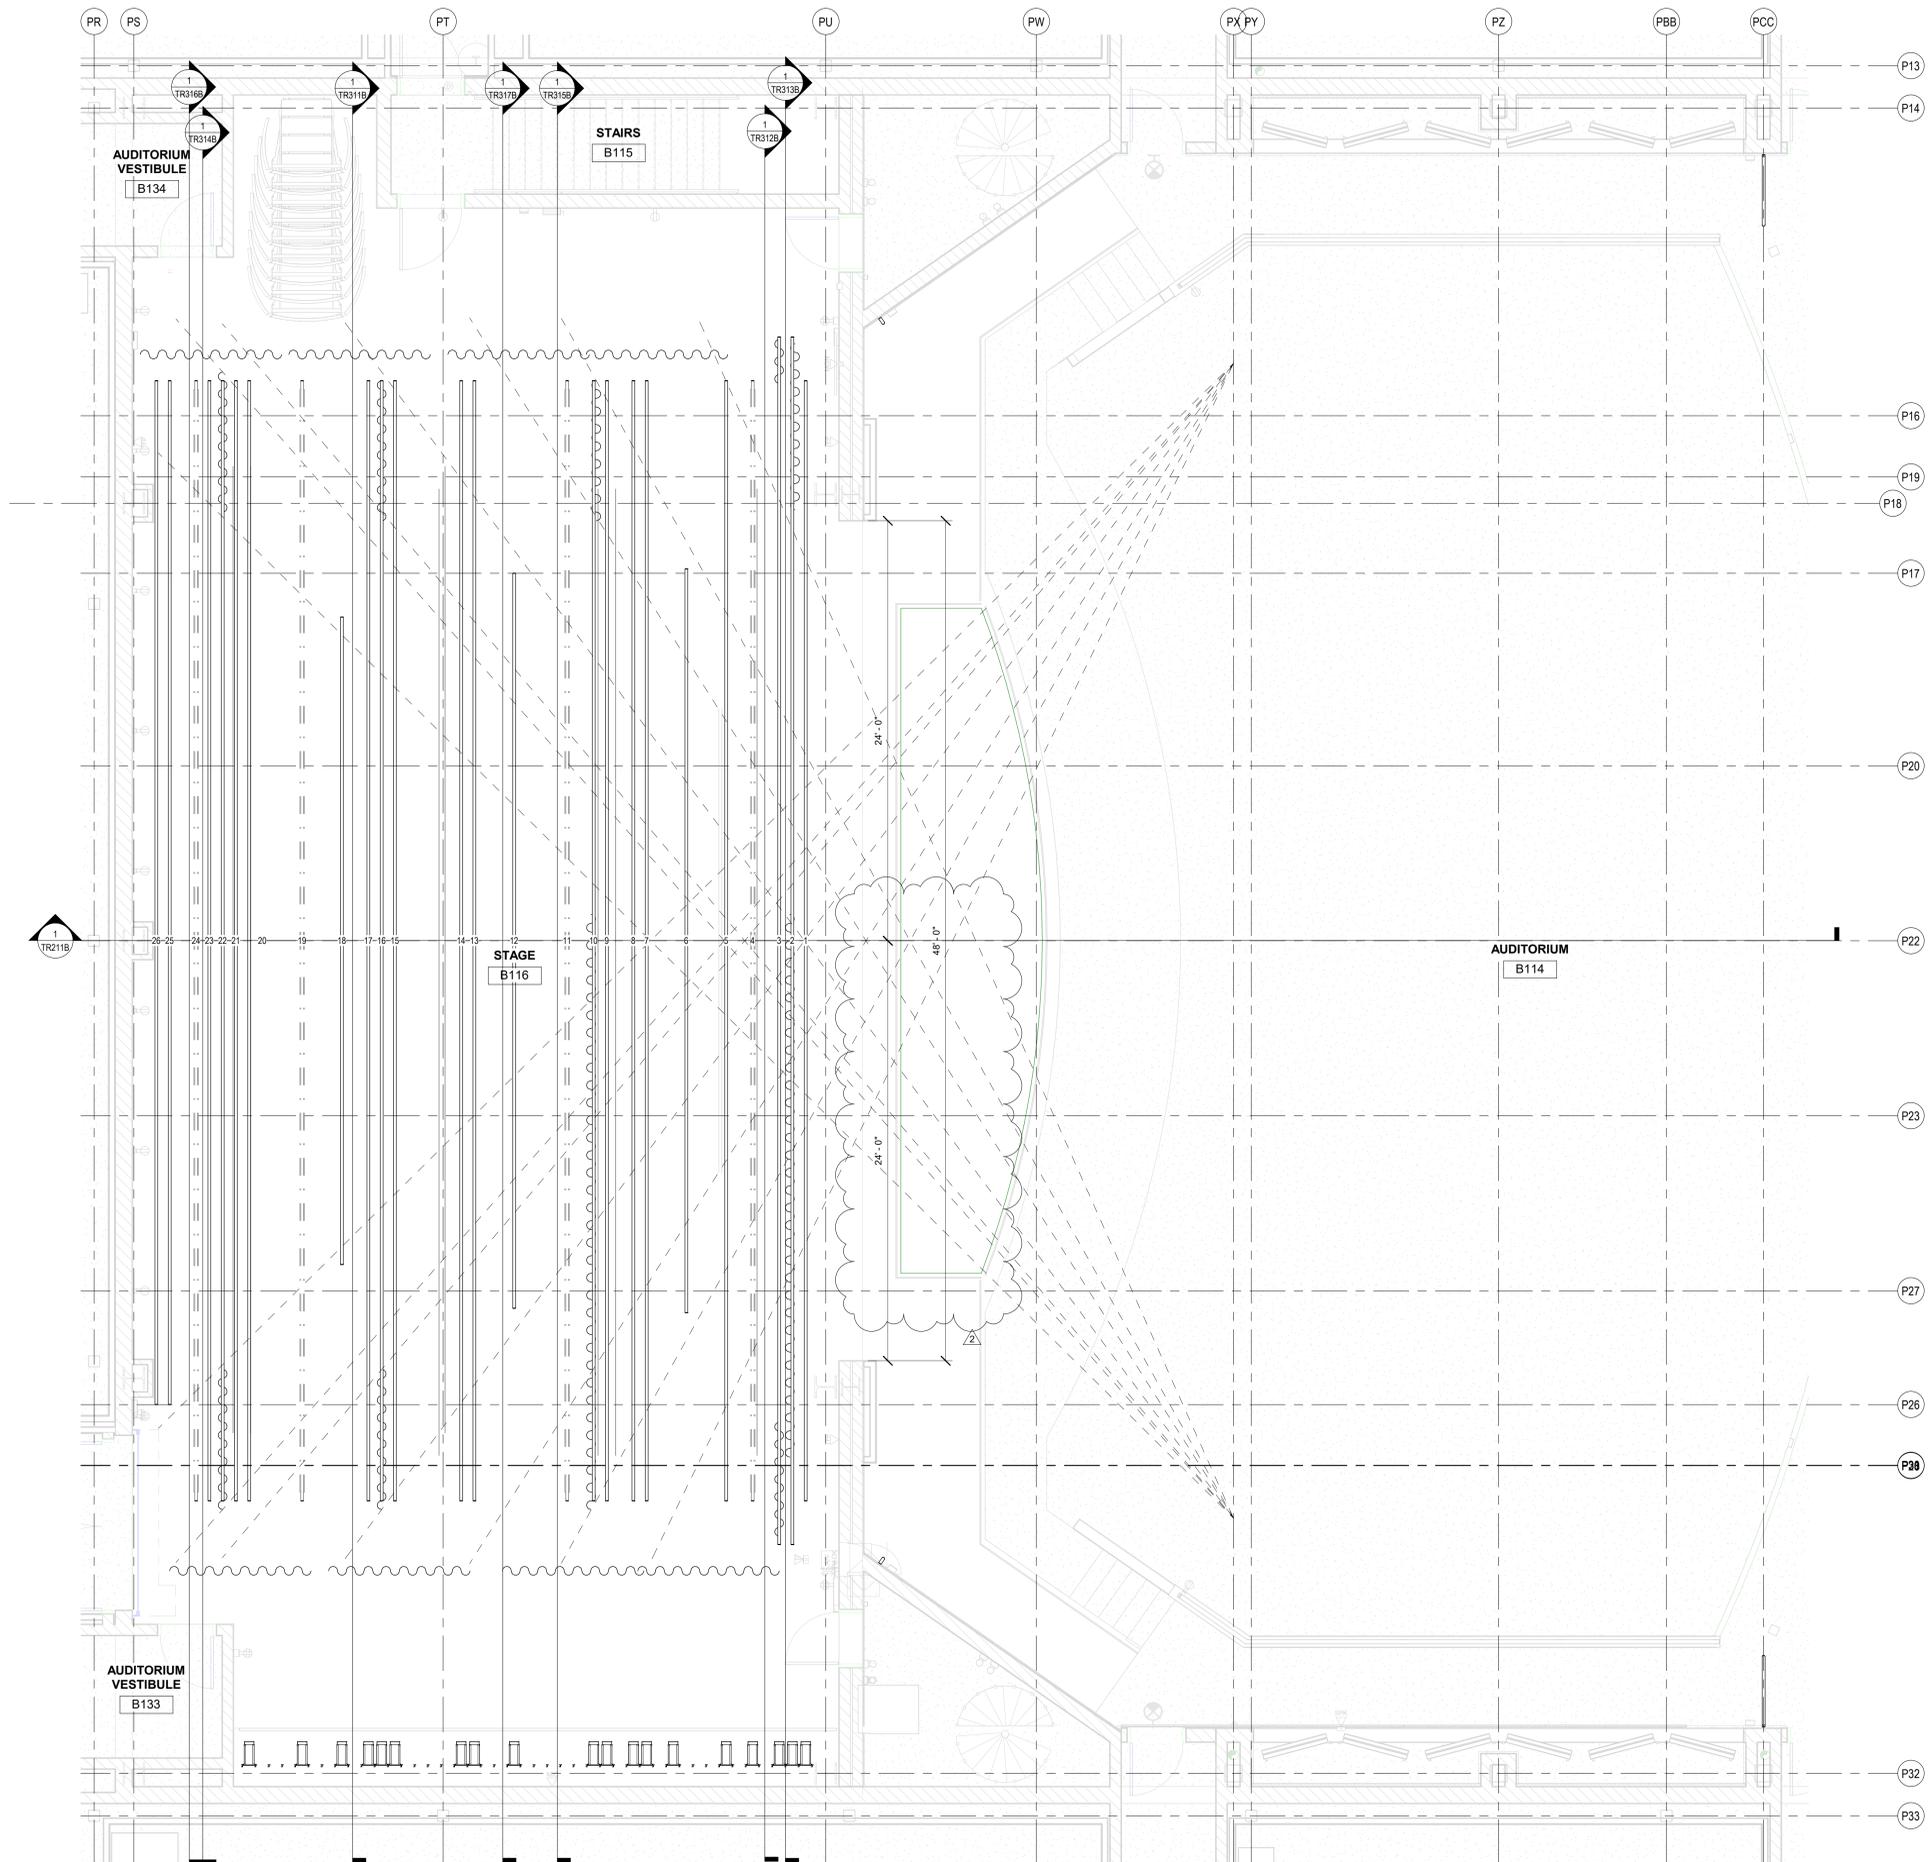


PROJECT:  
SOUTHWEST ALLEN COUNTY SCHOOLS  
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HOMESTEAD HIGH SCHOOL  
4310 HOMESTEAD ROAD, FORT WAYNE, IN 46814

SCOPE DRAWINGS:  
These drawings indicate the general scope of the project. The drawings are not intended to be used for the construction of any structure. The drawings are not intended to be used for the construction of any structure. The drawings are not intended to be used for the construction of any structure.

REVISIONS:  
2 ADDENDUM 2 12/2/2020

ISSUE DATE	DRAWN BY	CHECKED BY
10/27/20	KJG	JG

DRAWING TITLE:  
STAGE RIGGING  
SYSTEM PROSC  
STAGE LEVEL  
PLAN

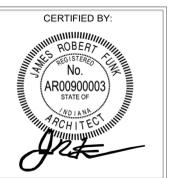

DRAWING NUMBER  
TR111B

PROJECT NUMBER  
18138



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4310 HOMESTEAD ROAD, FORT WAYNE, IN 46814

SCOPE DRAWINGS:  
These drawings indicate the general scope of the project. The contractor shall be responsible for the procurement of all materials, mechanical and electrical systems. The drawings do not necessarily indicate or describe all work required for the performance, installation and completion of the project. On the basis of the general scope indicated or described, the contractor shall furnish all items required for the proper execution and completion of the work.

REVISIONS:  
2 ADDENDUM 2 12/2/2020


ISSUE DATE DRAWN BY CHECKED BY  
10/27/20 KJG JG

DRAWING TITLE:  
**STAGE RIGGING  
SYSTEM  
COORDINATION  
AND DETAIL  
ENLARGEMENTS**


CERTIFIED BY:  
Professional Engineer  
No. AR00900003  
STATE OF INDIANA  
401111531  
*[Signature]*

DRAWING NUMBER  
**TR411B**

PROJECT NUMBER  
**18138**

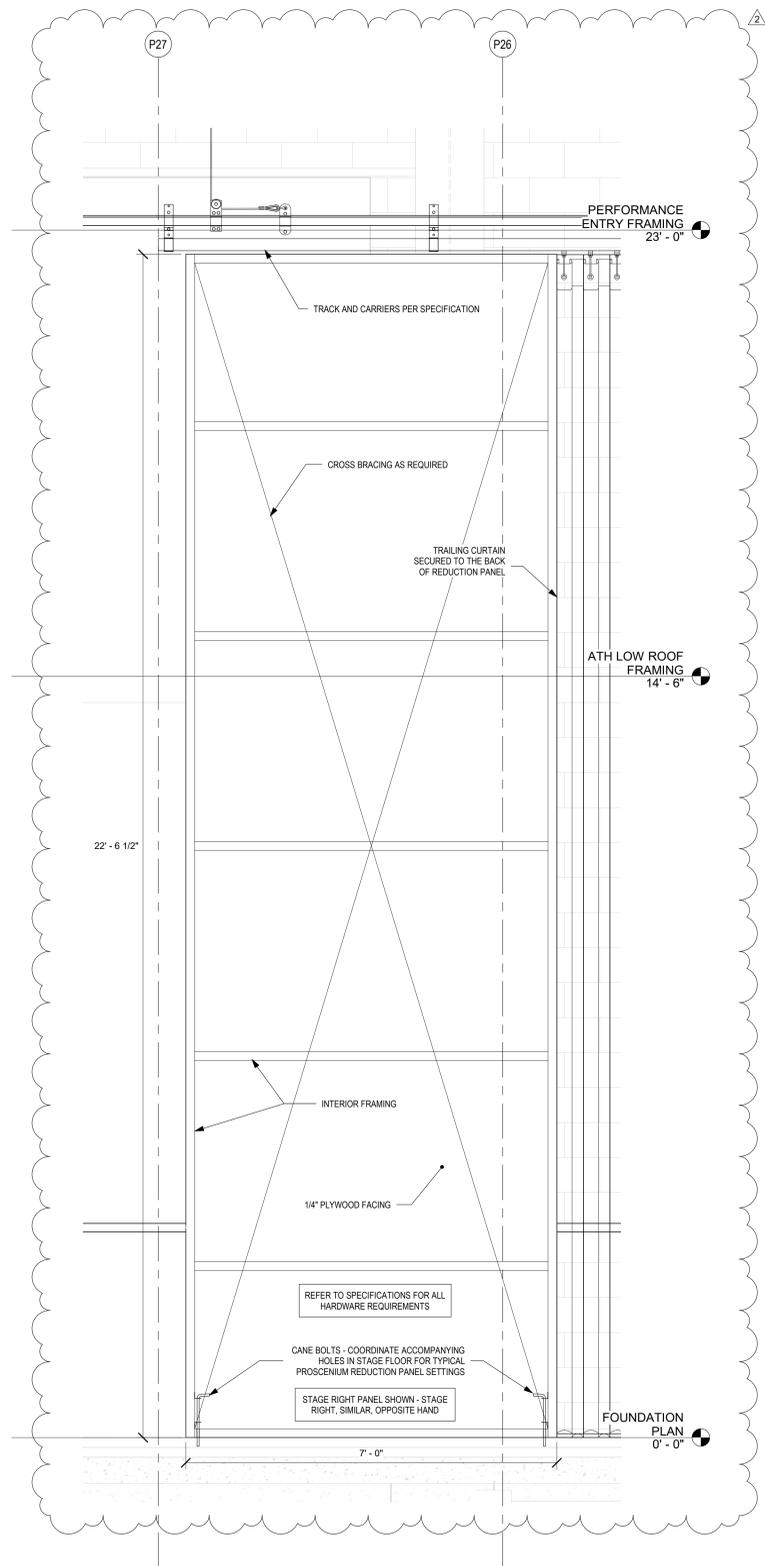

**2** DETAIL - PROSCENIUM REDUCTION PANEL  
SCALE: 3/4" = 1'-0"

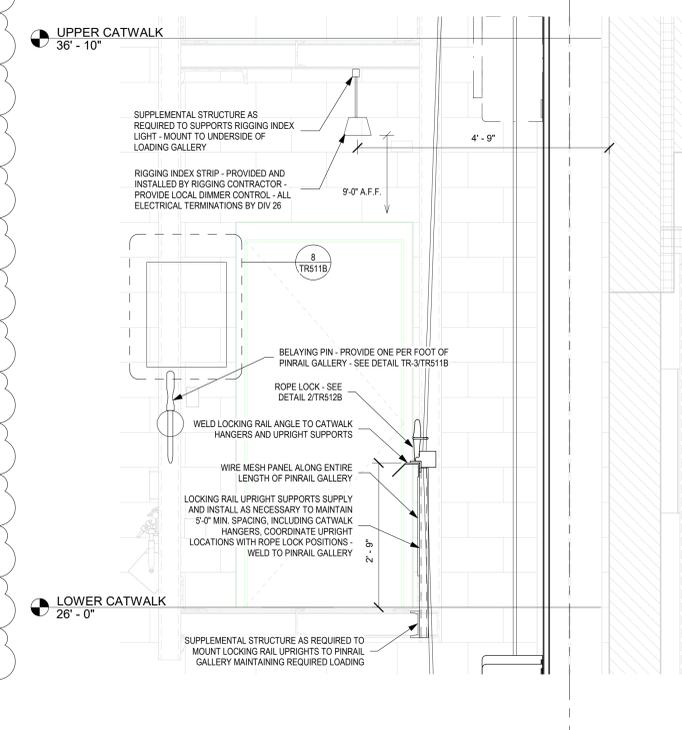

**1** DETAIL - STAGE RIGHT PINRAIL GALLERY WITH LOCKING RAIL  
SCALE: 3/4" = 1'-0"