ADDENDUM NO. 1

Penn High School Fieldhouse

Penn-Harris-Madison School Corporation Mishawaka, Indiana

Project No. 222130.00

Index of Contents


Addendum No. 1, 9 items, 4 pages

Revised Drawing Sheets: C1.1, C2.1, C2.1A, C2.2, C3.1, C3.1A, C3.2, C3.3, C4.1, C4.2, C5.1, C7.2, C7.3, S-005, S-11A, S-11B, S-11C, S-12A, S-12B, S-21C, S-502, S-503, S-510, S-520, S-522, A-11A, A-11B, A-11C, A-12A, A-12B, AC11A, AC11B, AC11C, AC12A, AC12B, AR101, A-201, A-203, A-204, A-205, A-310, A-311, A-312, A-313, A-314, A-315, A-320, A-401, A-402, A-403, A-404, A-410, A-440, A-501, A-601, A-602, AF11A, AF11B, AF11C, AF12A, AF12B AF201, AF202, AF203, AF601, AQ71A, AQ71B, AQ71C, AQ72B, AQ751, AQ753, PF11A, PF11B, PL11A, PL11B, PL12A, PL12B, PR101, P-402, P-501, P-601, P-702, P-703, MV102, MV202, MV203, MP101, MP201, MP202, MP203, MR101, M-401, M-601, ES101, EL11A, EL11B, EL11C, EL12A, EL12B, EP11A, EP11B, EP11C, EP12B, EP12C ET11A, ET11B, ET11C, ET12A, ET12B, ET12D, ET501, E-601, E-602, T-001, T-11A, T-11B, T-11C, T-12A, T-12B, T-12D, and T-503 Prebid Conference Power Point Presentation Prebid Conference Sign-in Sheet

January 26,2024

I hereby certify that this Addendum was prepared by me or under my direct supervision and that I am a duly registered Architect/Engineer under the Laws of the State of Indiana.

FANNING/HOWEY ASSOCIATES, INC. ARCHITECTS/ENGINEERS/CONSULTANTS

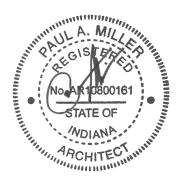

Paul A. Miller, License No. AR10800161 Expiration Date: 12/31/2025

TO: ALL BIDDERS OF RECORD

ADDENDUM NO. 1 to Drawings and Project Manual, dated January 10, 2024, for the Penn High School Fieldhouse for Penn-Harris-Madison School Corporation, 55900 Bittersweet Road, Mishawaka, Indiana 46545; as prepared by Fanning/Howey Associates, Inc., Indianapolis, Indiana.

This Addendum shall hereby be and become a part of the Contract Documents the same as if originally bound thereto.

The following clarifications, amendments, additions, revisions, changes, and modifications change the original Contract Documents only in the amount and to the extent hereinafter specified in this Addendum.

Each bidder shall acknowledge receipt of this Addendum in his proposal or bid.

NOTE: Bidders are responsible for becoming familiar with every item of this Addendum. (This includes miscellaneous items at the very end of this Addendum.)

RE: ALL BIDDERS

ITEM NO. 1. PROJECT MANUAL, SECTION - 01 50 00 - TEMPORARY FACILITIES AND CONTROLD

- A. Replace 3.4, B., 1., as follows:
 - "1. Common-Use Field Office: The Owner will provide and maintain a meeting space for Owner, Architect, and Construction Personnel Progress Meetings, pre-installation meetings and general coordination meetings involving the same parties.
 - a. This field office is not to be used for Contractor field personnel daily office."

ITEM NO. 2. <u>PROJECT MANUAL, SECTION – 07 27 26.02 – VAPOR-PERMEABLE FLUID-APPLIED</u> MEMBRANE AIR BARRIER

- A. Delete 2.3, A., 1., in its entirety.
- B. Replace 2.3, A., 3., as follows:
 - "3. Material: Perm-A-Barrier VPL 50RS, 20 mils thick (wet/dry) by GCP Applied Technologies, www.GCPAT.com."

Note: Remainder of subparagraphs remain unchanged and are applicable.

C. Article 2.3, A., 4: Change "90 mils (wet)" to "20 mils (wet/dry)".

ITEM NO. 3. PROJECT MANUAL, SECTION 07 71 00 - ROOF SPECIALTIES

- A. Add 2.7, A., 8., as follows:
 - "8. Special Fabrications: Two-way sloped coping cap."

ITEM NO. 4. PROJECT MANUAL, SECTION 08 71 00 – DOOR HARDWARE

A. Article 3.05: Replace Hardware Sets 20 and 24 as follows:

Hardware Group No. 20

For use on Door #(s):

B120F

Provide each OPENING with the following:

QTY		DESCRIPTION	CATALOG NUMBER	FINISH	MFR
(1)	EA	CONT. HINGE	112XY EPT	628	IVE
1	EA	POWER TRANSFER	EPT10	689	VON
1	EA	ELEC PANIC HARDWARE	LX-RX-QEL-99-NL 24 VDC	626	VON
1	EA	RIM CYL HOUSING (SFIC)	80-116 (W/ DISP CONST CORE)	626	SCH
1	EA	PERMANENT CORE	MARSHALL BEST SECURITY, 7-PIN, SMALL FORMAT INTERCHANGEABLE CORE	626	MAR
<u>1</u>	<u>EA</u>	OH STOP	100S ADJ	<u>630</u>	<u>GLY</u>
4	EA	SURFACE CLOSER (W/	4040XP SCUSH	689	LCN
		SPRING STOP)			
<u>1</u>	<u>EA</u>	SURF. AUTO OPERATOR	4642 WMS 120 VAC	<u>689</u>	<u>LCN</u>
4	EA	CUSH SHOE SUPPORT	4040XP-30	689	LCN
4	EA	BLADE STOP SPACER	4040XP-61	689	LCN
<u>2</u>	<u>EA</u>	<u>ACTUATOR</u>	<u>8310-818T</u>	<u>630</u>	<u>LCN</u>
1	EA	CREDENTIAL READER	BY ACCESS CONTROL INTEGRATOR		B/O
1	EA	PUSH BUTTON RELEASE	BY INTERCOM SYSTEM (DIV 28) (660-	(628)	B/O
		(DESK MOUNT BUTTON)	PB)		(SCE)
1	EA	DOOR CONTACT	679 SERIES	BLK	SCE
1	EA	POWER SUPPLY	PS902 900-4RL 120/240 VAC	LGR	SCE
			(4RL FOR PUSH BUTTON DELAY)		

DOOR(S) NORMALLY CLOSED AND LOCKED AND EXTERIOR ACTUATOR DISABLED. PRESENTING VALID CREDENTIAL TO READER, OR REMOTE PUSH BUTTON, RETRACTS EXIT DEVICE LATCH AND ENABLES EXTERIOR ACTUATOR. PUSHING ENABLED EXTERIOR ACTUATOR SIGNALS AUTOMATIC OPERATOR TO OPEN DOOR. INTERIOR ACTUATOR ENABLED AT ALL TIMES. PUSHING INTERIOR ACTUATOR RETRACTS LATCH AND SIGNALS AUTOMATIC OPERATOR TO OPEN DOOR. EXIT DEVICE LATCH ALSO CAPABLE OF BEING ELECTRONICALLY DOGGED DOWN (I.E. PUSH/PULL MODE) AS DESIGNATED BY ACCESS CONTROL SYSTEM SCHEDULE. EXIT DEVICE LATCHES AND LOCKS WITH LOSS OF POWER. FREE EGRESS AT ALL TIMES. (DOOR(S) NORMALLY CLOSED AND LOCKED. PRESENTING VALID CREDENTIAL TO READER, OR REMOTE PUSH BUTTON, RETRACTS EXIT DEVICE LATCH, ALLOWING ACCESS. EXIT DEVICE LATCH ALSO CAPABLE OF BEING ELECTRONICALLY DOGGED DOWN (I.E. PUSH/PULL MODE) AS DESIGNATED BY ACCESS CONTROL SYSTEM SCHEDULE. EXIT DEVICE LATCHES AND LOCKS WITH LOSS OF POWER. FREE EGRESS AT ALL TIMES.)

Hardware Group No. 24

For use on Door #(s):

B120

PART 1 - Provide each OPENING with the following:

QTY		DESCRIPTION	CATALOG NUMBER	FINISH	MFR
4	EA	CONT. HINGE	112XY EPT	628	IVE
1	EA	POWER TRANSFER	EPT10	689	VON
1	EA	ELEC PANIC HARDWARE	LX-RX-QEL-99-NL 24 VDC	626	VON

Addendum No. 1 Penn High School Fieldhouse Penn-Harris-Madison School Corporation

QTY		DESCRIPTION	CATALOG NUMBER	FINISH	MFR
1	EA	RIM CYL HOUSING (SFIC)	80-159 (W/ KEYED CONST CORE)	626	SCH
1	EA	PERMANENT CORE	MARSHALL BEST SECURITY, 7-PIN, SMALL FORMAT INTERCHANGEABLE CORE	626	MAR
<u>1</u>	<u>EA</u>	OH STOP	100S ADJ	<u>630</u>	<u>GLY</u>
4	EA	SURFACE CLOSER (W/SPRING STOP)	4040XP SCUSH	689	LCN
<u>1</u>	<u>EA</u>	SURF. AUTO OPERATOR	4642 WMS 120 VAC	<u>689</u>	<u>LCN</u>
4	EA	CUSH SHOE SUPPORT	4040XP-30	689	LCN
4	ΕΑ	BLADE STOP SPACER	4040XP-61	689	LCN
<u>2</u>	<u>EA</u>	<u>ACTUATOR</u>	<u>8310-818T</u>	<u>630</u>	<u>LCN</u>
			(JAMB MOUNTED)		
1	EA	RAIN DRIP	142AA	AA	ZER
1	EA	WEATHERSTRIPPING	BY DOOR/FRAME MANUFACTURER		B/O
1	EA	DOOR SWEEP, BRUSH W/ DRIP	8198AA	AA	ZER
1	EA	THRESHOLD, 1/2"	655A	Α	ZER
1	EA	CREDENTIAL READER	BY ACCESS CONTROL INTEGRATOR		B/O
1	EA	PUSH BUTTON RELEASE	BY INTERCOM SYSTEM (DIV 28) (660-	(628)	B/O
		(DESK MOUNT BUTTON)	PB)		(SCE)
1	EA	DOOR CONTACT	679 SERIES	BLK	SCE
1	EA	POWER SUPPLY	PS902 900-4RL 120/240 VAC	LGR	SCE
			MRI FOR DUSH BUTTON DELAY)		

DOOR(S) NORMALLY CLOSED AND LOCKED AND EXTERIOR ACTUATOR DISABLED. PRESENTING VALID CREDENTIAL TO READER, OR REMOTE PUSH BUTTON, RETRACTS EXIT DEVICE LATCH AND ENABLES EXTERIOR ACTUATOR. PUSHING ENABLED EXTERIOR ACTUATOR SIGNALS AUTOMATIC OPERATOR TO OPEN DOOR. INTERIOR ACTUATOR ENABLED AT ALL TIMES. PUSHING INTERIOR ACTUATOR RETRACTS LATCH AND SIGNALS AUTOMATIC OPERATOR TO OPEN DOOR. EXIT DEVICE LATCH ALSO CAPABLE OF BEING ELECTRONICALLY DOGGED DOWN (I.E. PUSH/PULL MODE) AS DESIGNATED BY ACCESS CONTROL SYSTEM SCHEDULE. EXIT DEVICE LATCHES AND LOCKS WITH LOSS OF POWER. FREE EGRESS AT ALL TIMES. (DOOR(S) NORMALLY CLOSED AND LOCKED. PRESENTING VALID CREDENTIAL TO READER, OR REMOTE PUSH BUTTON, RETRACTS EXIT DEVICE LATCH, ALLOWING ACCESS. EXIT DEVICE LATCH ALSO CAPABLE OF BEING ELECTRONICALLY DOGGED DOWN (I.E. PUSH/PULL MODE) AS DESIGNATED BY ACCESS CONTROL SYSTEM SCHEDULE. EXIT DEVICE LATCHES AND LOCKS WITH LOSS OF POWER. FREE EGRESS AT ALL TIMES.)

ITEM NO. 5. PROJECT MANUAL, SECTION - 09 21 16 - GYPSUM BOARD ASSEMBLIES

- A. Replace 3.10, D., as follows:
 - "D. Aluminum Trim: Install in locations indicated on drawings or as follows:
 - 1. Provide reveal molding where gypsum board walls or bulkheads intersect a dissimilar material in the same plane (parallel)."

ITEM NO. 6. PROJECT MANUAL, SECTION 22 66 13 - FACILITY NATURAL-GAS PIPING

- A. Add 2.1, D., as follows:
 - "D. Fittings, at the Contractor's option, in pipe sizes upto 4", may be carbon or stainless steel mechanical press-fit, equal to Viega MegaPress, MegaPress FKM. Fittings and Valves shall have natural gas compatible components, third party listed and Fuel Gas Code Compliant. Installing Contractor shall carry manufacturer's training certification. Natural Gas Valves in sizes upto 4" may be equal to MegaPressG and carry ANSI LC4 approval."
- B. Add 2.4, A., 1., as follows:
 - "1. See Article 2.1, D., for Contractor Option mechanical press-fit ball vales for sizes 4 inches and less."

ITEM NO. 7. PROJECT MANUAL, SECTION 27 53 15 - SYNCHRONOUS, WIRELESS CLOCK SYSTEMS

A. Delete this Section in its entirety.

ITEM NO. 8. ACCEPTABLE MANUFACTURERS

The following manufacturers are to be considered acceptable manufacturers (suppliers and fabricators) for the Sections of the Specifications listed. Listed manufacturers are required to bid on products equal in type and design, size, function, and quality to that originally specified. Final decision as to equality of products specified versus those proposed shall be made by the Architect.

Section 07 71 00 - Roof Specialties

- Jackson Architectural Metal Fabrication


Section 13 34 19 – Metal Building Systems

- Kirby Building Systems, Portland, Tennessee
- Silvercote, Greenville, South Carolina (Metal Building Insulation & Roof Liner)

ITEM NO. 9. REVISED DRAWING SHEETS

A. Drawing Sheets: C1.1, C2.1, C2.1A, C2.2, C3.1, C3.1A, C3.2, C3.3, C4.1, C4.2, C5.1, C7.2, C7.3, S-005, S-11A, S-11B, S-11C, S-12A, S-12B, S-21C, S-502, S-503, S-510, S-520, S-522, A-11A, A-11B, A-11C, A-12A, A-12B, AC11A, AC11B, AC11C, AC12A, AC12B, AR101, A-201, A-203, A-204, A-205, A-310, A-311, A-312, A-313, A-314, A-315, A-320, A-401, A-402, A-403, A-404, A-410, A-400, A-501, A-601, A-602, AF11A, AF11B, AF11C, AF12A, AF12B AF201, AF202, AF203, AF601, AQ71A, AQ71B, AQ71C, AQ72B, AQ751, AQ753, PF11A, PF11B, PL11A, PL11B, PL12A, PL12B, PR101, P-402, P-501, P-601, P-702, P-703, MV102, MV202, MV203, MP101, MP201, MP202, MP203, MR101, M-401, M-601, ES101, EL11A, EL11B, EL11C, EL12A, EL12B, EP11A, EP11B, EP11C, EP12B, EP12C, ET11A, ET11B, ET11C, ET12A, ET12B, ET12D, ET501, E-601, E-602, T-001, T-11A, T-11B, T-11C, T-12A, T-12B, T-12D, and T-503 have been revised, dated 1/26/24, and is included with and hereby made a part of this Addendum. These Drawings supersede the original documents.

END OF ADDENDUM

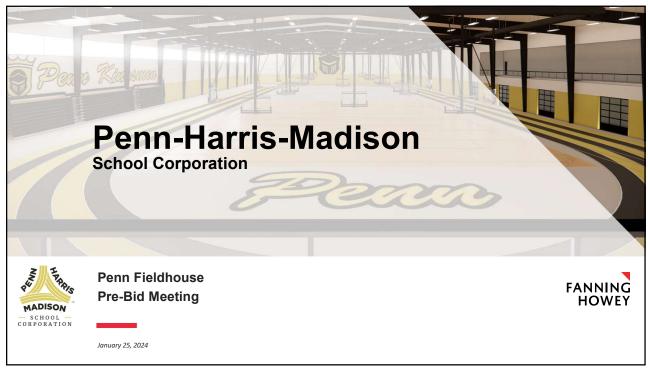



Penn Fieldhouse: Leadership

FANNING HOWEY

PHM:

- Dr. Jerry Thacker, Superintendent
- Dr. Aaron Leniski, Chief Operating Officer
- Joe Winters, Director of Facilities
- Jason Messner,
 - Assistant Director of Facilities Energy
- Joseph Zappia, Facilities Manager

DESIGN TEAM:

- Fanning Howey,
 Mike Schipp, AIA, Project Manager
 (317) 407-7229; mschipp@fhai.com
- Magnus Engineering: Structural Troy Madlem, PE Jake Althouse, PE Jake Yoder, PE
- Danch Harner: Site & Civil Michael Danch, PE Scott Meredith, SET Ryan Clussman, PE

3



Penn Fieldhouse Project Schedule & Details

Penn Fieldhouse: Project Information

FANNING HOWEY

PROJECT SCHEDULE:

January 26 Addendum No. 1
 February 1 Addendum No. 2
 February 8 Addendum No. 3

■ February 15 Receipt of Bids at 2 p.m.

- at the ESC

■ February 26 Award of Contracts

■ February 27 Issue "Notice to Proceed"

March - tbd
 Pre-Construction Meeting

March - tbd
 Commence New Construction
 Pending agency approvals

July 31, 2025 Substantial Completion

BUILDING AREA:

New Construction: 100,378 SF
 Field House: 54,239 SF
 1st Floor SF: 80,692 SF
 2nd Floor SF: 19,686 SF
 Note: Includes Alternate SF

PROJECT BUDGET:

• \$16.8 Million

Alternate Considerations

5

Penn Fieldhouse: Project Requirements



INSTRUCTIONS TO BIDDERS:

- Project is Tax Exempt
- Obtaining Bid Documents/Revit Files
- Bid Bond

10% of Bid

Performance & Payment Bond

100% of Bid

Background Checks

Section 00 73 60

Insurance

Refer to Exhibit A to the Contract

Substitution Requests

Section 00 26 00.01

BID INFROMATION:

- Single Lump Sum
- Alternates 1 thru 9
- Allowances:

No. 1 – General: \$100,000 No. 2 – Anchor Bolts: \$15,000 No. 3 – Soils: \$200,000

Permits

Local Permits are GC's Responsibility

Temporary Facilities and Controls

GC's Responsibility


Bid Form

Review Section 00 41 16 "Bidder Reminder List"





Penn Fieldhouse Site Location Plan


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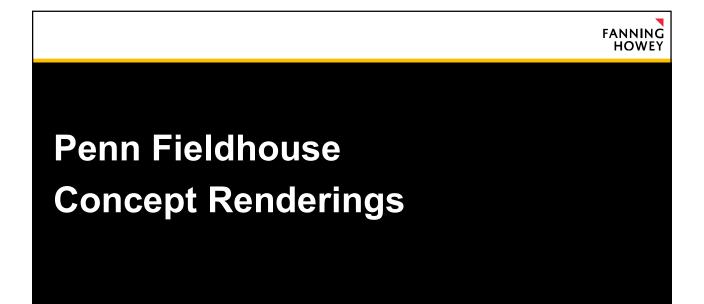


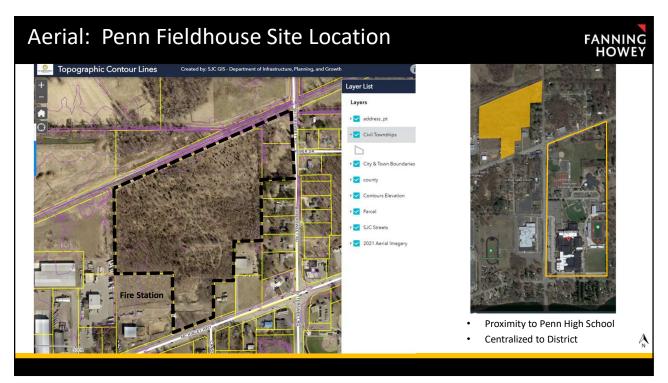




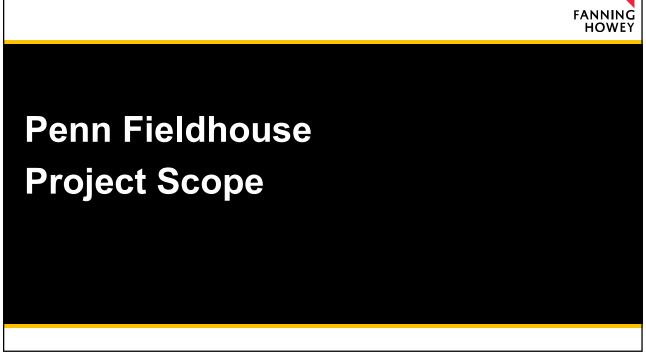


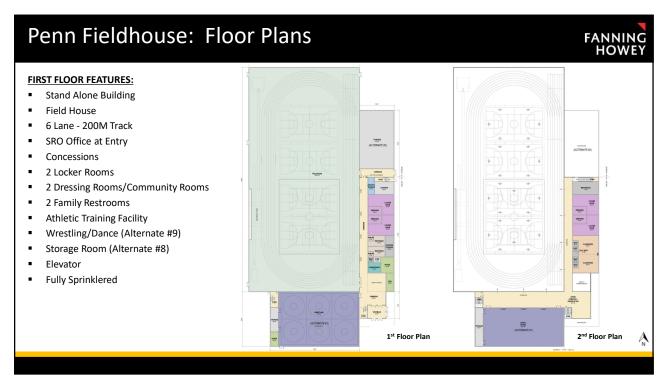


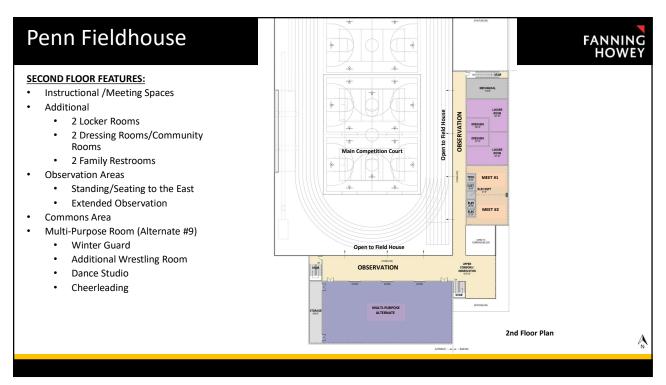

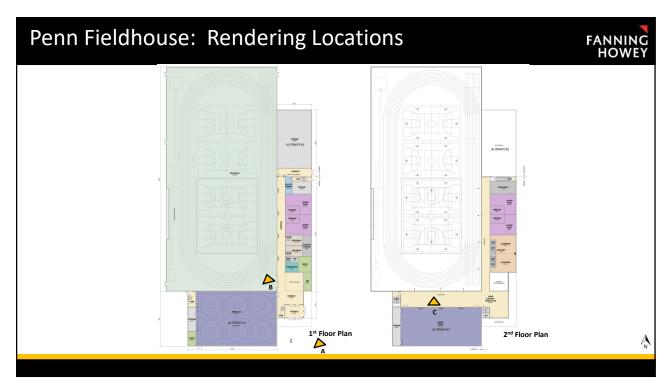





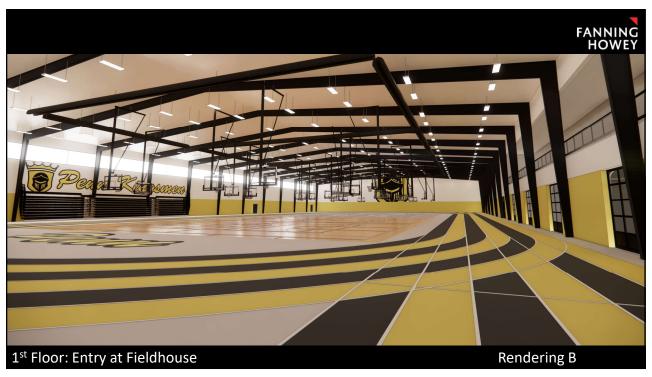


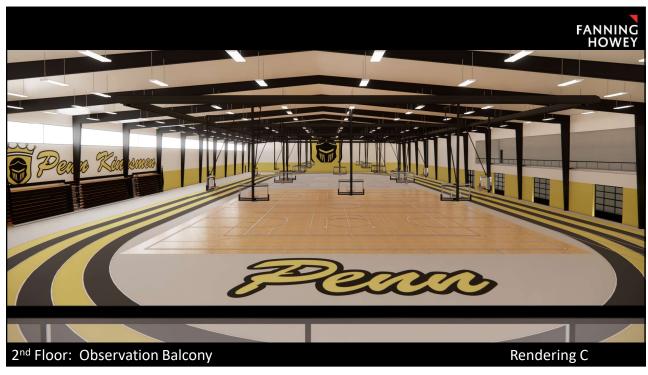




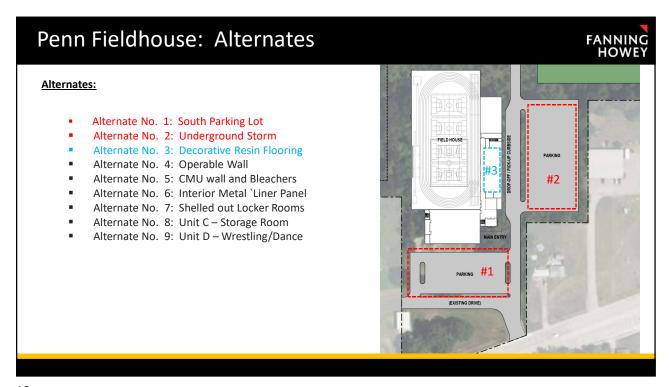

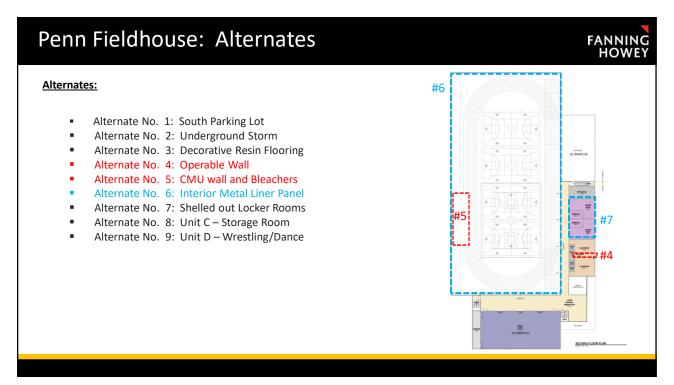

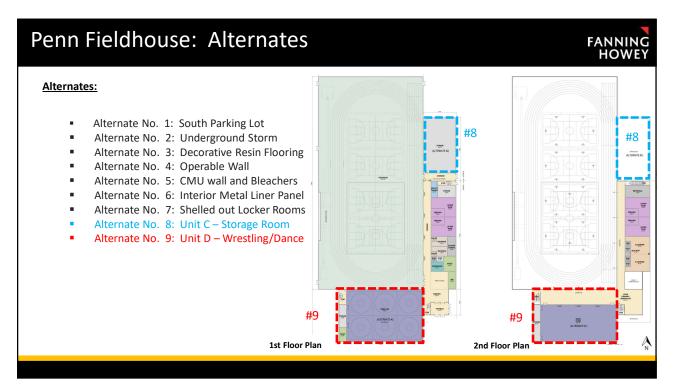

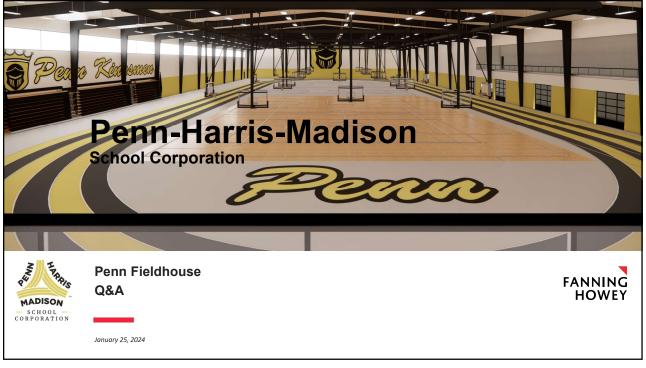

PLEASE PRINT CLEARLY.

Your name and title will be included in the meeting report.

Thank you.

PREBID MEETING SIGN IN SHEET (PLEASE PRINT)

		7		
NAME (Please Print)	TITLE	COMPANY (Including Address Info)	TELEPHONE NO. FAX NO. CELL NO.(optional)	E-MAIL
Mike Tath	Estimator	RembartanDavis Services 916 E. McKinky, Mish 46545	5-4-204-266-64	Mtoff Cpembartendaris. com
Rowhelley	Estimator	Pemberbon Dalvis Services 574-277-7001 916 E. Mekinley Mish 46545	574-277-7001	PHOllevie Pembutou Muis, rom
Cimmy Leibengerd	project empirer	Gayler Electric Study, IN 16514	5743660405	steibengood Baylor com
Frank Garro	Project Engine	ľ	2360-665-MS	tgarro e gaylar com
PR. ARRON LENISKI ME	007	рнм		
JOE WINTERS MS	RRECTOR OF FAC	НН		
JASON MESSHER NY	ASSIST. DIRECTOR	Рнн		
JOSEPH ZAPPIN MS	FACILITIES MAN.	рнм		
MILE SCHIPP (HCS)	ARCHITECT	FAMMING HOWRY	(317) 407. 1229	MSCHIPPE FHAI. COM

PLEASE PRINT CLEARLY.

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Thank you.

PRE-BID SIGN IN SHEET (PLEASE PRINT)	(PLEASE PRINT)			
NAME (Please Print)	TITLE	COMPANY (Including Address Info)	TELEPHONE NO. FAX NO. CELL NO.(optional)	E-MAIL
Joshuc Peine	Superintented 33	Caquerr-inc 33/5 Hangoluthe St. Ru)	563-216-8217	Dence Crownsone in 1
Key whileth	12. PM	YODER CORFUNCTION	200-242-2983	9
Hon Doenges	Project Engineer	Larson Danielson	80/1-158-612	219-851-1408 robengespldconstructon, con

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Your name and title will be included in the meeting report.

Thank you.

PRE-BID SIGN IN SHEET (PLEASE PRINT)	PLEASE PRINT)			
NAME (Please Print)	TITLE	COMPANY (Including Address Info)	TELEPHONE NO. FAX NO. CELL NO.(optional)	E-MAIL
lin Marey	PM -	Frank of Frank	269-330-4639	Time bobac. US
Verdel Simmons	Sub	Sletcle Rosang	574-233-7485	574-233-7485 Lebydell. Summons & Slattle colly
Mark Haskins	Sus	Haskins Undergrand	574-930-6858	Mark @ haskins underground.com
a Elley in	Ju. B	Toxed Vine Entropiess	Jelo 748-9731	Vince of teathing, com

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Your name and title will be included in the meeting report. Thank you.

PREBID MEETING SIGN IN SHEET (PLEASE PRINT)

	%, Co	. A.c.	bester			
E-MAIL	butch & mid electric, com	514304-3857 SBAYS @ Gitfleth.cm	574-849-2575 Com he alma soto how			
TELEPHONE NO. FAX NO. CELL NO.(optional)						
COMPANY (Including Address Info)	Middle bury Electeic IN LESTESTUS 33 EAST	Griffe PH 28075 No RD ELLM	Alva. so teba			
TITLE	VP	End.	BM			
NAME TITLE (Please Print)	BUTCH BREW	Shore Buy S	Cent to stehn			

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Your name and title will be included in the meeting report.

Thank you.

PRE-BID SIGN IN SHEET (PLEASE PRINT)

NAME (Please Print)	TITLE	COMPANY (Including Address Info)	TELEPHONE NO. FAX NO. CELL NO.(optional)	E-MAIL
Terry Minis		Crang Industrial Zour		into@Ciscocrawe.com
Dale Laplace	PM	Precision Control Systms	219-7461245	Precision Control Systems 219-7461245 dlaplace@pcsg.com
Mat hazmierzak	pm	Dynamic Mechanical	574-257-0123	Dynamic Mechanical 574-257-0123 matthodynamic machanical mat
Greg Hicks	Estimator	Tibs. Lewis	1858 652 713	574 259 8581 alichs @ 1, nceusa, com
				4

PLEASE PRINT CLEARLY.

Your name and title will be included in the meeting report. Thank you.

PRE-BID SIGN IN SHEET (PLEASE PRINT)

NAME (Please Print)	TITLE	COMPANY (Including Address Info)	TELEPHONE NO. FAX NO. CELL NO.(optional)	E-MAIL
JAF Williams	Projuct MAMAGES	Kuhn Specally ADDING	269-832-4101	JWILLIAMS @ Kehn Spanly Hary 10m.
Matt Boiley	Preject Manegar	H36 Service	57N-274-6556	Mbailey@hgserviez.eom
Adam Clork	Estinator	CRE Excasa Ly	9/15/1-696-468	aclorke and perceveting, com
Colin Campbell Estimator	Estimator	Ziolkowsk;	\$574-287-1911	completion 260it. Lon
MARCELO SUVELZA FORMATOR	Fey MATER	Zauranski Lonst.	574.386.3335	MSW/ECZG@ZEWicz.com
Ubste Hershorsa	Project Homser	HAG	P285-712-41S	nherstberger@hyservices.an

PHMSC FIELDHOUSE - FINAL SITE PLAN (PHASE 1)

PART OF THE SOUTHWEST, AND NORTHWEST QUARTERS OF SECTION 6, TOWNSHIP 37 NORTH, RANGE 4 ÉAST, PENN TOWNSHIP, ST. JOSEPH COUNTY, INDIANA.

_____ E.-W. 1/4 LINE, SEC. 6, T.37N., R.4E

A PART OF THE SOUTHWEST AND NORTHWEST QUARTER OF SECTION 6, TOWNSHIP 37 NORTH, RANGE 4 EAST, PENN TOWNSHIP, ST. JOSEPH COUNTY, INDIANA AND BEING MORE PARTICULARLY DESCRIBED AS: COMMENCING AT THE CENTER MARKER OF SAID SECTION, TOWNSHIP AND RANGE; THENCE SOUTH 89°34'38" WEST ALONG THE EAST-WEST QUARTER SECTION LINE OF SAID SECTION, A DISTANCE OF 247.05 FEET TO THE POINT OF BEGINNING; THENCE SOUTH 00°35'37" EAST AND ALONG THE WEST LINE OF LANGE'S MINOR SUBDIVISION AS SHOWN IN BOOK 28, PAGE L-3, SYNDER'S MINOR SUBDIVISION AS SHOWN IN BOOK 25, PAGE S-6, AND FOULK'S MINOR SUBDIVISION AS SHOWN IN BOOK 27, PAGE F-3, ALL RECORDED IN THE OFFICE OF THE ST. JOSEPH COUNTY, INDIANA RECORDER, A DISTANCE OF 821.53 FEET; THENCE SOUTH 89°41'12" WEST (REC. SOUTH 90°00'00" WEST), A DISTANCE OF 200.68 FEET (REC. 200.00 FEET); THENCE SOUTH 00°21'34" EAST (REC. SOUTH 00°00'00" EAST), A DISTANCE OF 292.98 FEET; THENCE SOUTH 89°49'39" WEST (REC. SOUTH 90°00'00" WEST), A DISTANCE OF 150.06 FEET (REC. 150.00 FEET); THENCE SOUTH 00°21'34" EAST (REC. SOUTH 00°00'00" EAST), A DISTANCE OF 318.02 FEET (REC. 317.76 FEET) TO THE CENTERLINE OF MCKINLEY HIGHWAY; THENCE SOUTH 69°47'08" WEST ALONG SAID CENTERLINE, A DISTANCE OF 322.07 FEET; THENCE NORTH 00°30'11" WEST (REC. NORTH 00°08'50" WEST), A DISTANCE OF 53.11 FEET (REC. 53.16 FEET) TO THE NORTH RIGHT-OF-WAY LINE OF MCKINLEY HIGHWAY; THENCE SOUTH 69°47'08" WEST (REC. SOUTH 70°00'19" WEST) ALONG SAID NORTH RIGHT-OF-WAY LINE, A DISTANCE OF 447.35 FEET (REC. 447.85); THENCE NORTH 00°28'35" WEST AND ALONG THE EAST LOT LINE OF LOT 2 AND LOT 6 EVERGREEN PLAZA SUBDIVISION AS RECORDED IN DOCUMENT NUMBER 08200867 IN THE OFFICE OF THE ST. JOSEPH, INDIANA RECORDER, A DISTANCE OF 1228.80 FEET TO THE SOUTH LINE OF THE CONRAIL RAILROAD; THENCE NORTH 66°34'12" EAST ALONG SAID SOUTH RAILROAD LINE, A DISTANCE OF 1166.84 FEET, THENCE SOUTH 00°35'37" EAST, A DISTANCE OF 45.95 FEET TO THE POINT OF BEGINNING.

8.25' -

FD. CAPPED

(ON-LINE)

FD. CAPPED -

(ON-LINE)

CONTAINING 28.60 ACRES MORE OR LESS AND CONSISTING OF TWO (2) LOTS. SUBJECT TO ALL LEGAL RIGHT-OF-WAYS, AND EASEMENTS, AND RESTRICTIONS OF

BUILDING ENCROACHMENT:

LEGAL DESCRIPTION:

THERE ARE NO ENCROACHMENTS UPON EXISTING BUILDING SETBACK LINES AND/OR EASEMENTS.

BUILDING SETBACK NOTE:

THE BUILDING SETBACKS SHALL CONFORM TO THE APPLICABLE PROVISIONS OF THE ZONING ORDINANCE AND/OR AS INDICATED ON THIS

EASEMENT NOTE:

TO THE BEST OF OUR RESEARCH, AND FROM THE INFORMATION SUPPLIED TO US BY THE OWNERS, ALL EASEMENTS OF RECORD ARE SHOWN ON THIS PLAT.

FLOOD PLAIN NOTE:

THE PARCEL OF GROUND DOES NOT FALL WITHIN THE FLOOD HAZARD AREA AS DEFINED ON AND SCALED FROM THE COMMUNITY PANEL MAPS ESTABLISHED BY F.E.M.A. FOR FLOOD INSURANCE. THIS PARCEL FALLS WITHIN A "X" ZONE AREA AS SHOWN ON COMMUNITY PANEL NO. 18141C020228D & 18141C0236E, DATED JANUARY 6, 2011.

STREET CLASSIFICATION NOTE:

WATER AND SEWER NOTE:

CLASSIFICATION

1. MCKINLEY HWY. HIGHWAY

AS SHOWN

THE LOTS SHOWN ON THIS SUBDIVISION WILL BE SERVICED BY PUBLIC WATER AND SANITARY SEWER.

WAIVER NOTE:

THE PLAT COMMITTEE OF THE ARE PLAN COMMISSION AT ITS JUNE 4, 2020 MEETING GRANTED THE FOLLOWING WAIVERS:

1) FROM SECTION 153.025 (M) TO ALLOW FOR ONE (1) 76.55 FT. WIDE OPENING FOR LOT 1 AND ONE (1) 100 FT. WIDE OPENING FOR LOT 2 ACROSS THE 5 FT. NON-ACCESS EASEMENT FOR ACCESS ONTO MCKINLEY

DRAINAGE NOTE:


A SEPARATE DRAINAGE PLAN FOR LOT 1 WILL BE REQUIRED PRIOR TO DEVELOPMENT.

EASEMENT NOTES:

- 1. THE 100-FT WIDE OPENING ALONG THE 5-FT NON ACCESS EASEMENT SHOWN ON LOT 2 WILL BE FOR EGRESS ONLY.
- 2. THE INGRESS/EGRESS EASEMENT SHOWN ON LOT 1 OF THIS PLAT IS RESERVED FOR THE EXCLUSIVE USE OF THE OWNERS, SUCCESSORS AND/OR THEIR ASSIGNS OF LOT 1 AND 2 OF THIS PLAT.

EASEMENT LEGEND:

- (A) 5-FT NON-ACCESS EASEMENT
- 20-FT CITY OF MISHAWAKA MUNICIPAL UTILITY
- INGRESS/EGRESS EASEMENT

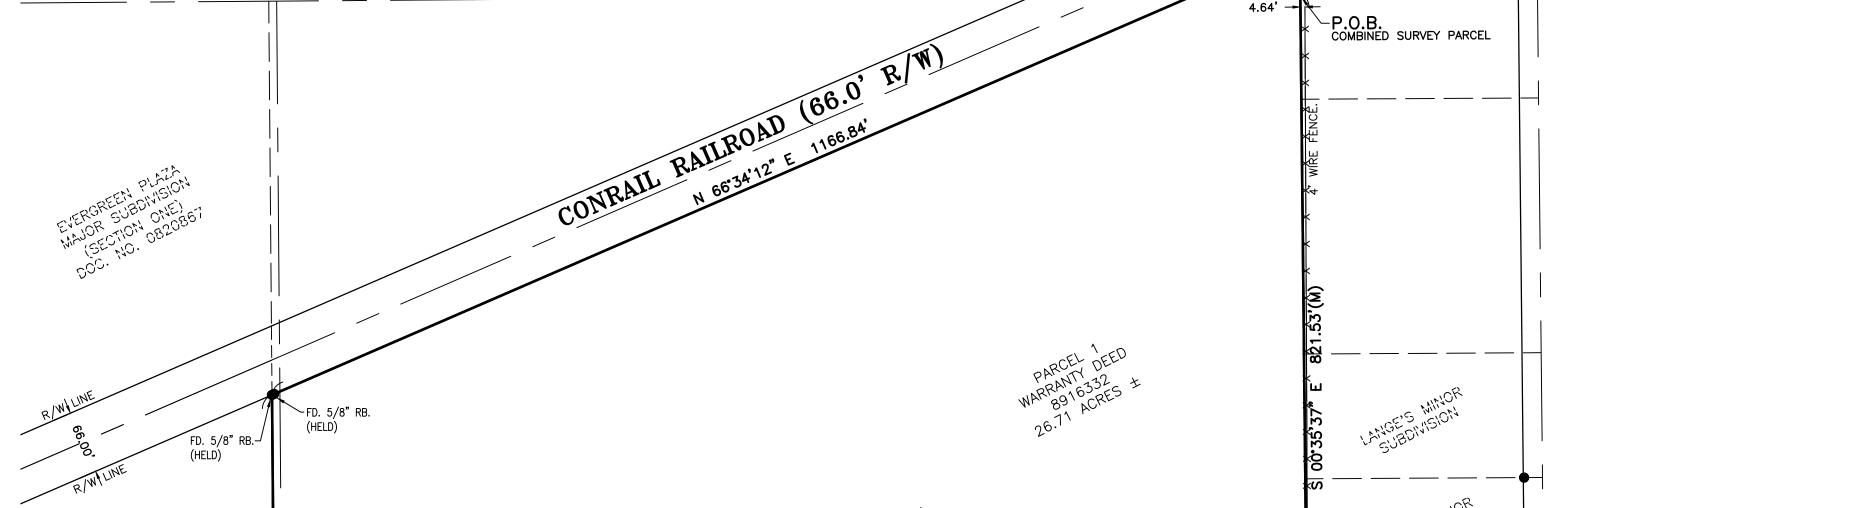

LIMIT OF CONSTRUCTION - PHASE


DEMOLITION KEYNOTES:

CENTER OF SEC. 6, T.37N., R.4E

(FD. HARRISON MON.)

S 89'34'38" W 247.05'(M)


(D) REMOVE EXISTING TREES, BRUSH AND DEBRIS.

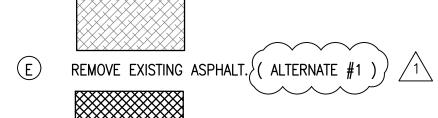


REMOVE EXISTING FENCE

GENERAL DEMOLITION NOTES:

- MAINTAIN AND PROTECT ALL SANITARY SEWER, STORM SEWER, DOMESTIC WATER, FIRE PROTECTION WATER, ELECTRICAL, AND NATURAL GAS UTILITY CONNECTIONS TO THE SITE DURING THE DEMOLITION/CONSTRUCTION PROCESS.
- ANY DEMOLITION MATERIALS REMOVED FROM THE SITE ARE TO BE DISPOSED OF PER LOCAL, STATE, AND FEDERAL LAWS OR
- ANY DAMAGE OR DISTURBANCE FROM CONSTRUCTION ACTIVITIES, OUTSIDE THE AREA OF DEMOLITION, IS TO BE REPAIRED TO ITS ORIGINAL CONDITION.
- FIELD LOCATE EXISTING SANITARY SEWER AND WATER LATERALS AND PROTECT DURING CONSTRUCTION.

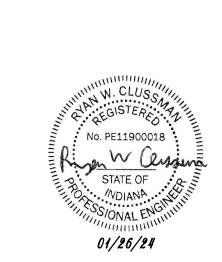

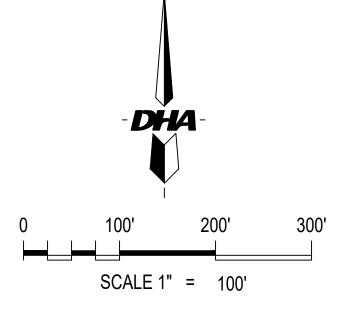

SHEET

EXISTING CONDITIONS & DEMOLITION PLAN

DRAWN BY: REVISIONS 01/10/24 CHECKED BY: | DATE | BY SCALE 1/26/24 ASM ADDENDUM #1 1" = 100'FILE # PROJ. MANGR:

PETITIONER: PENN HARRIS MADISON

SCHOOL CORPORATION

55900 BITTERSWEET ROAD

MISHAWAKA, IN 46545

(574) 259-7941 ATTN: JOE WINTERS


restaurant


UNDER CONSTRUCTION


ELEVATION = 745.79


SURVEYORS & ENGINEERS: DANCH, HARNER & ASSOCIATES, INC. 1643 COMMERCE DRIVE SOUTH BEND, IN. 46628 (574) 234-4003

ATTN: MICHAEL DANCH

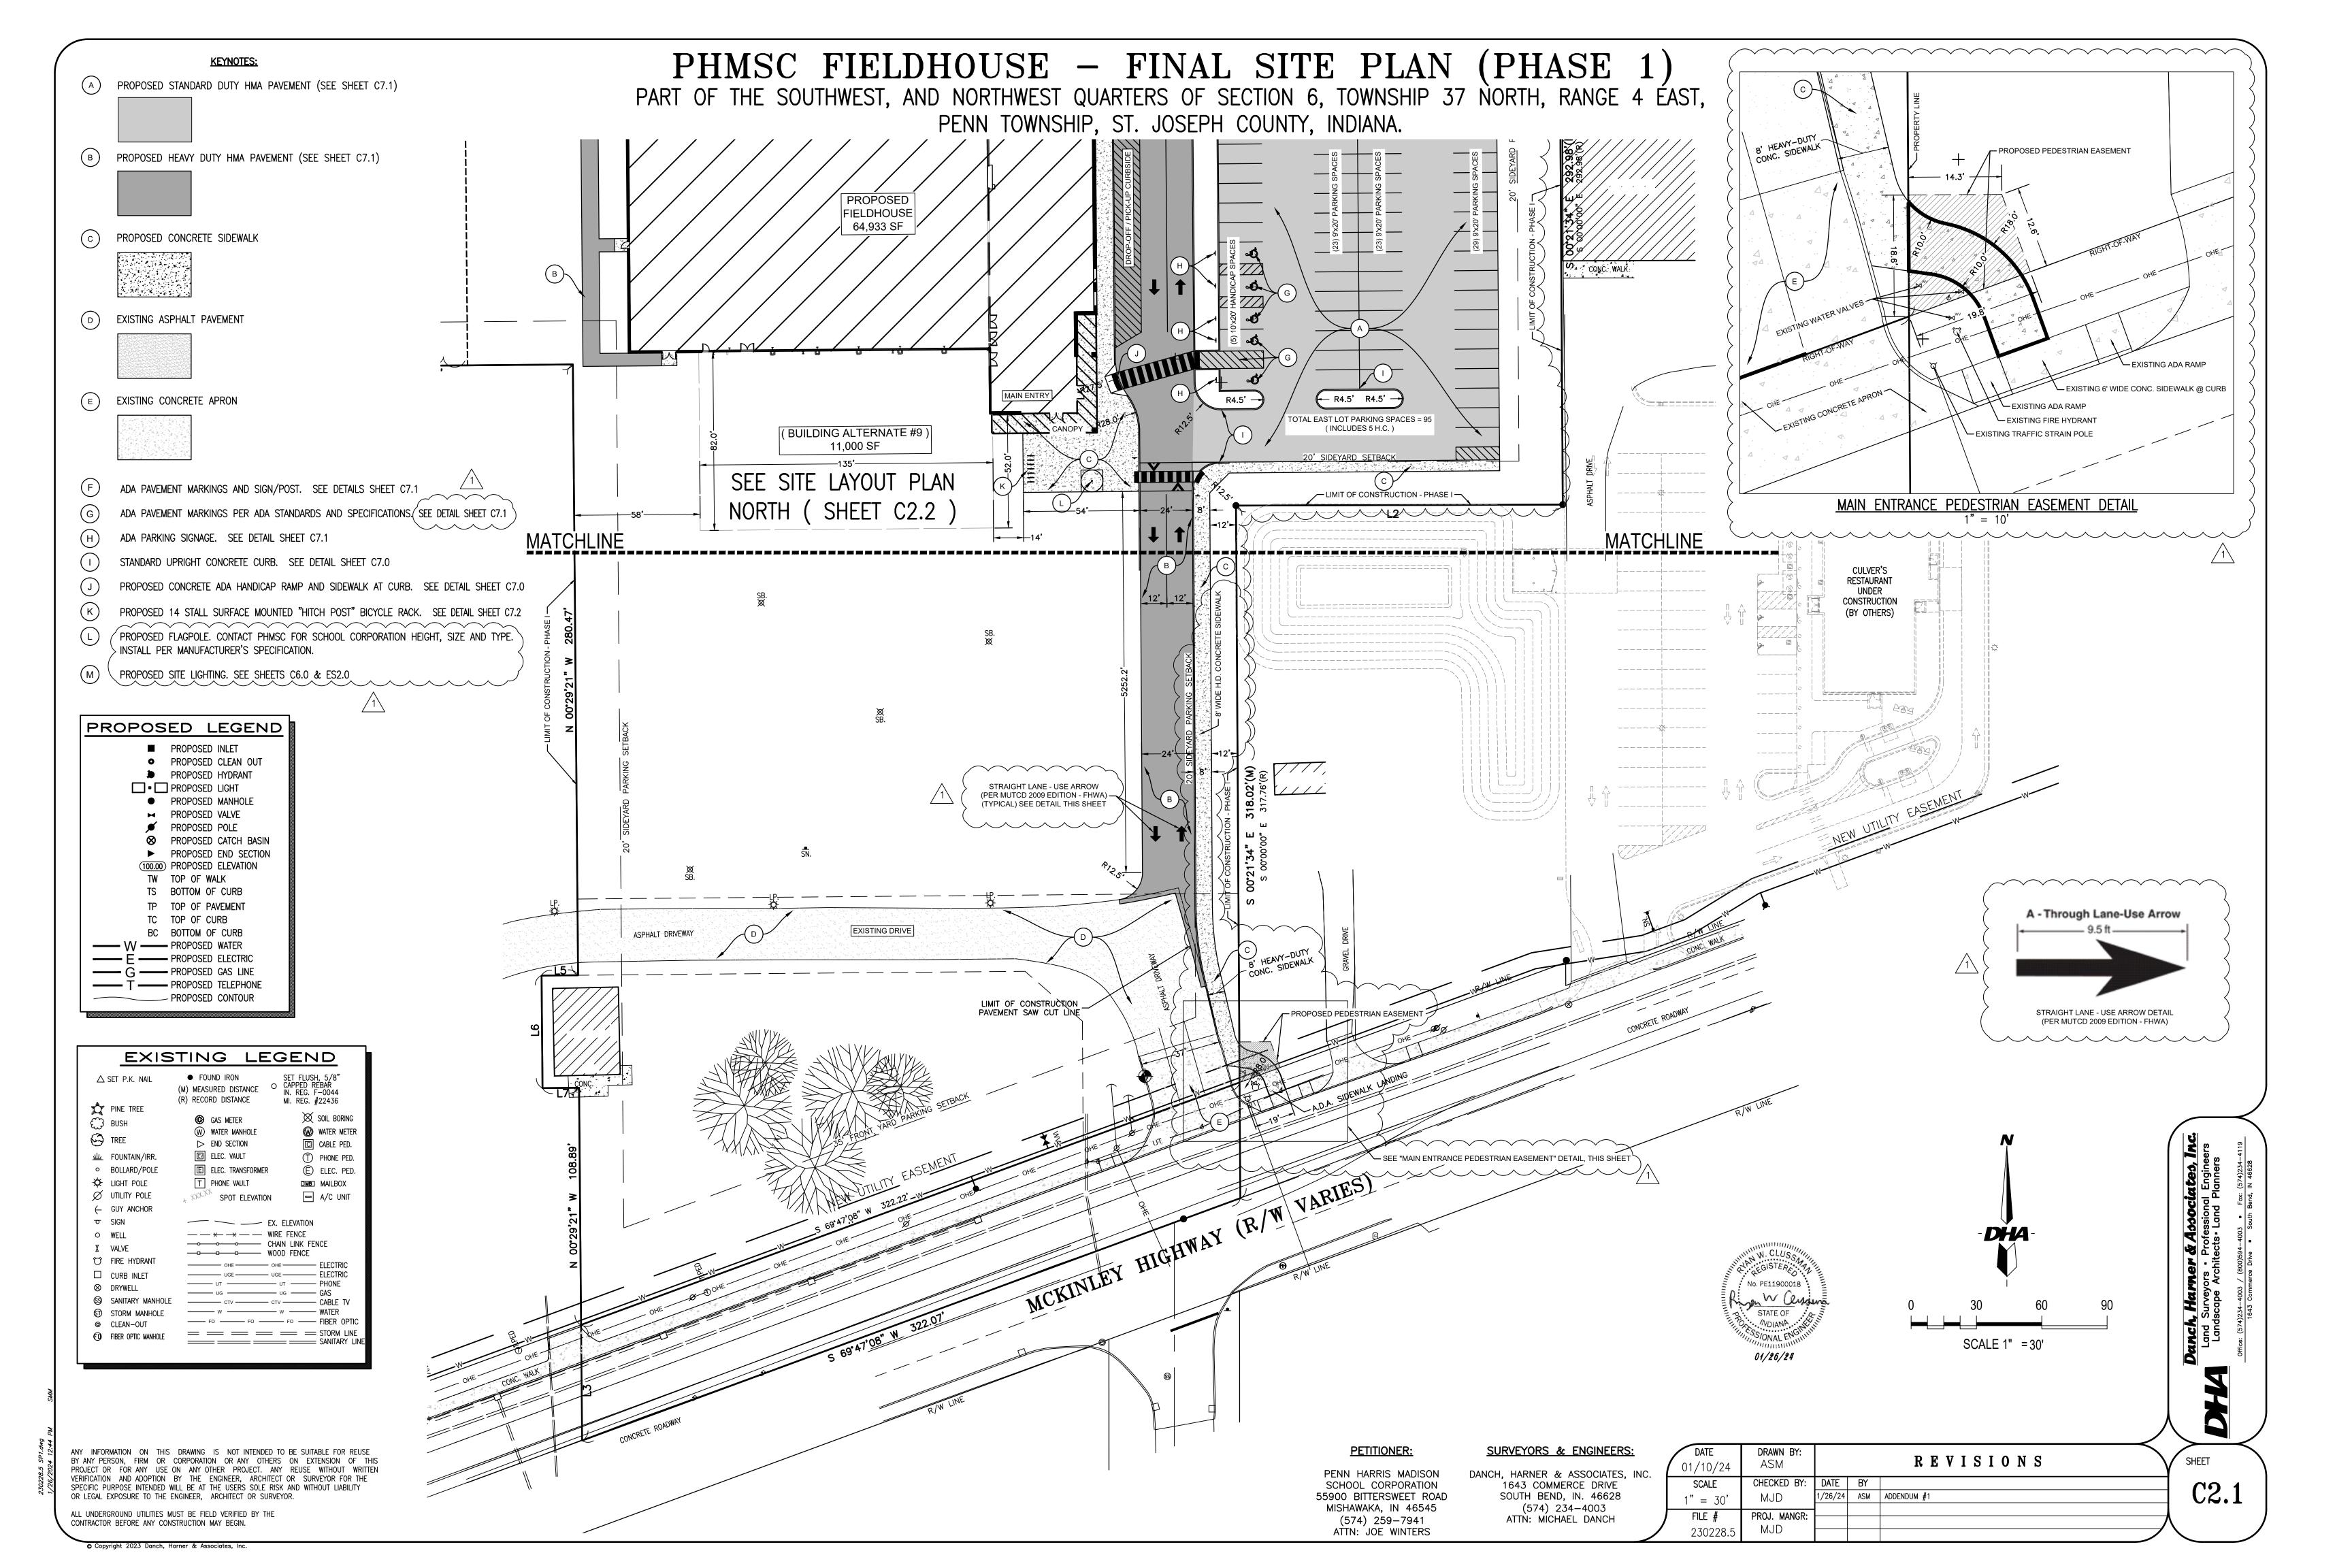

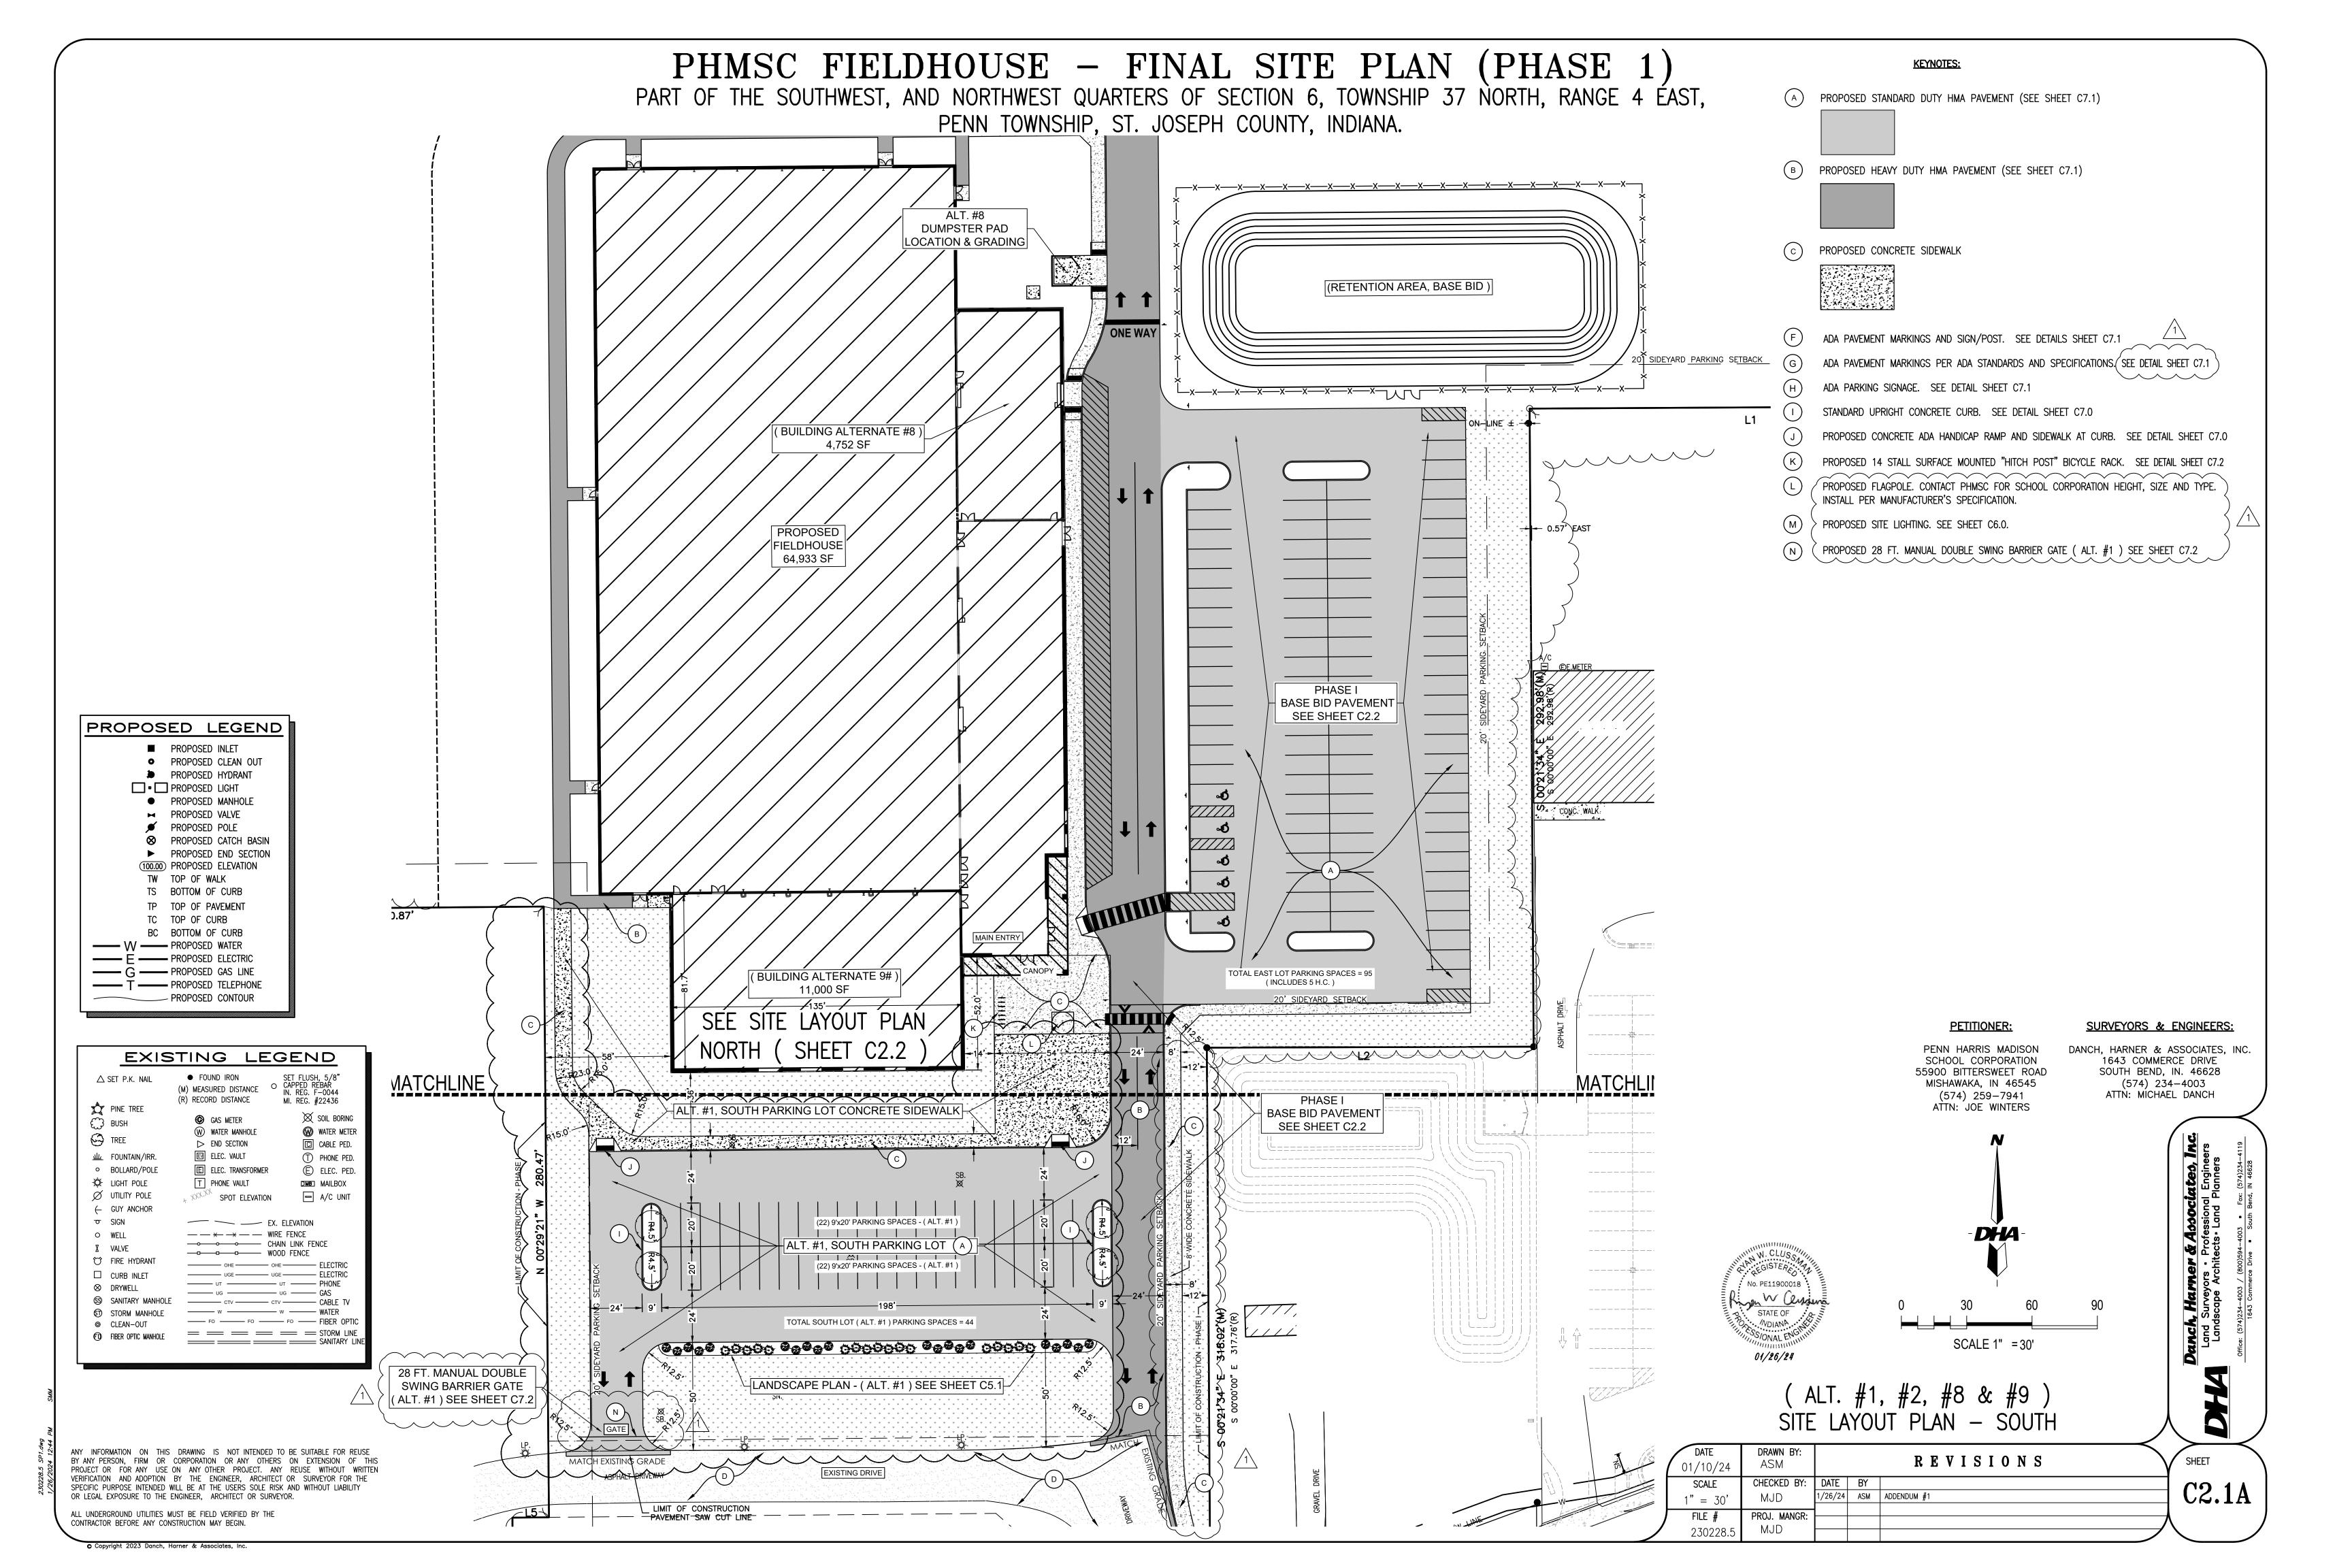

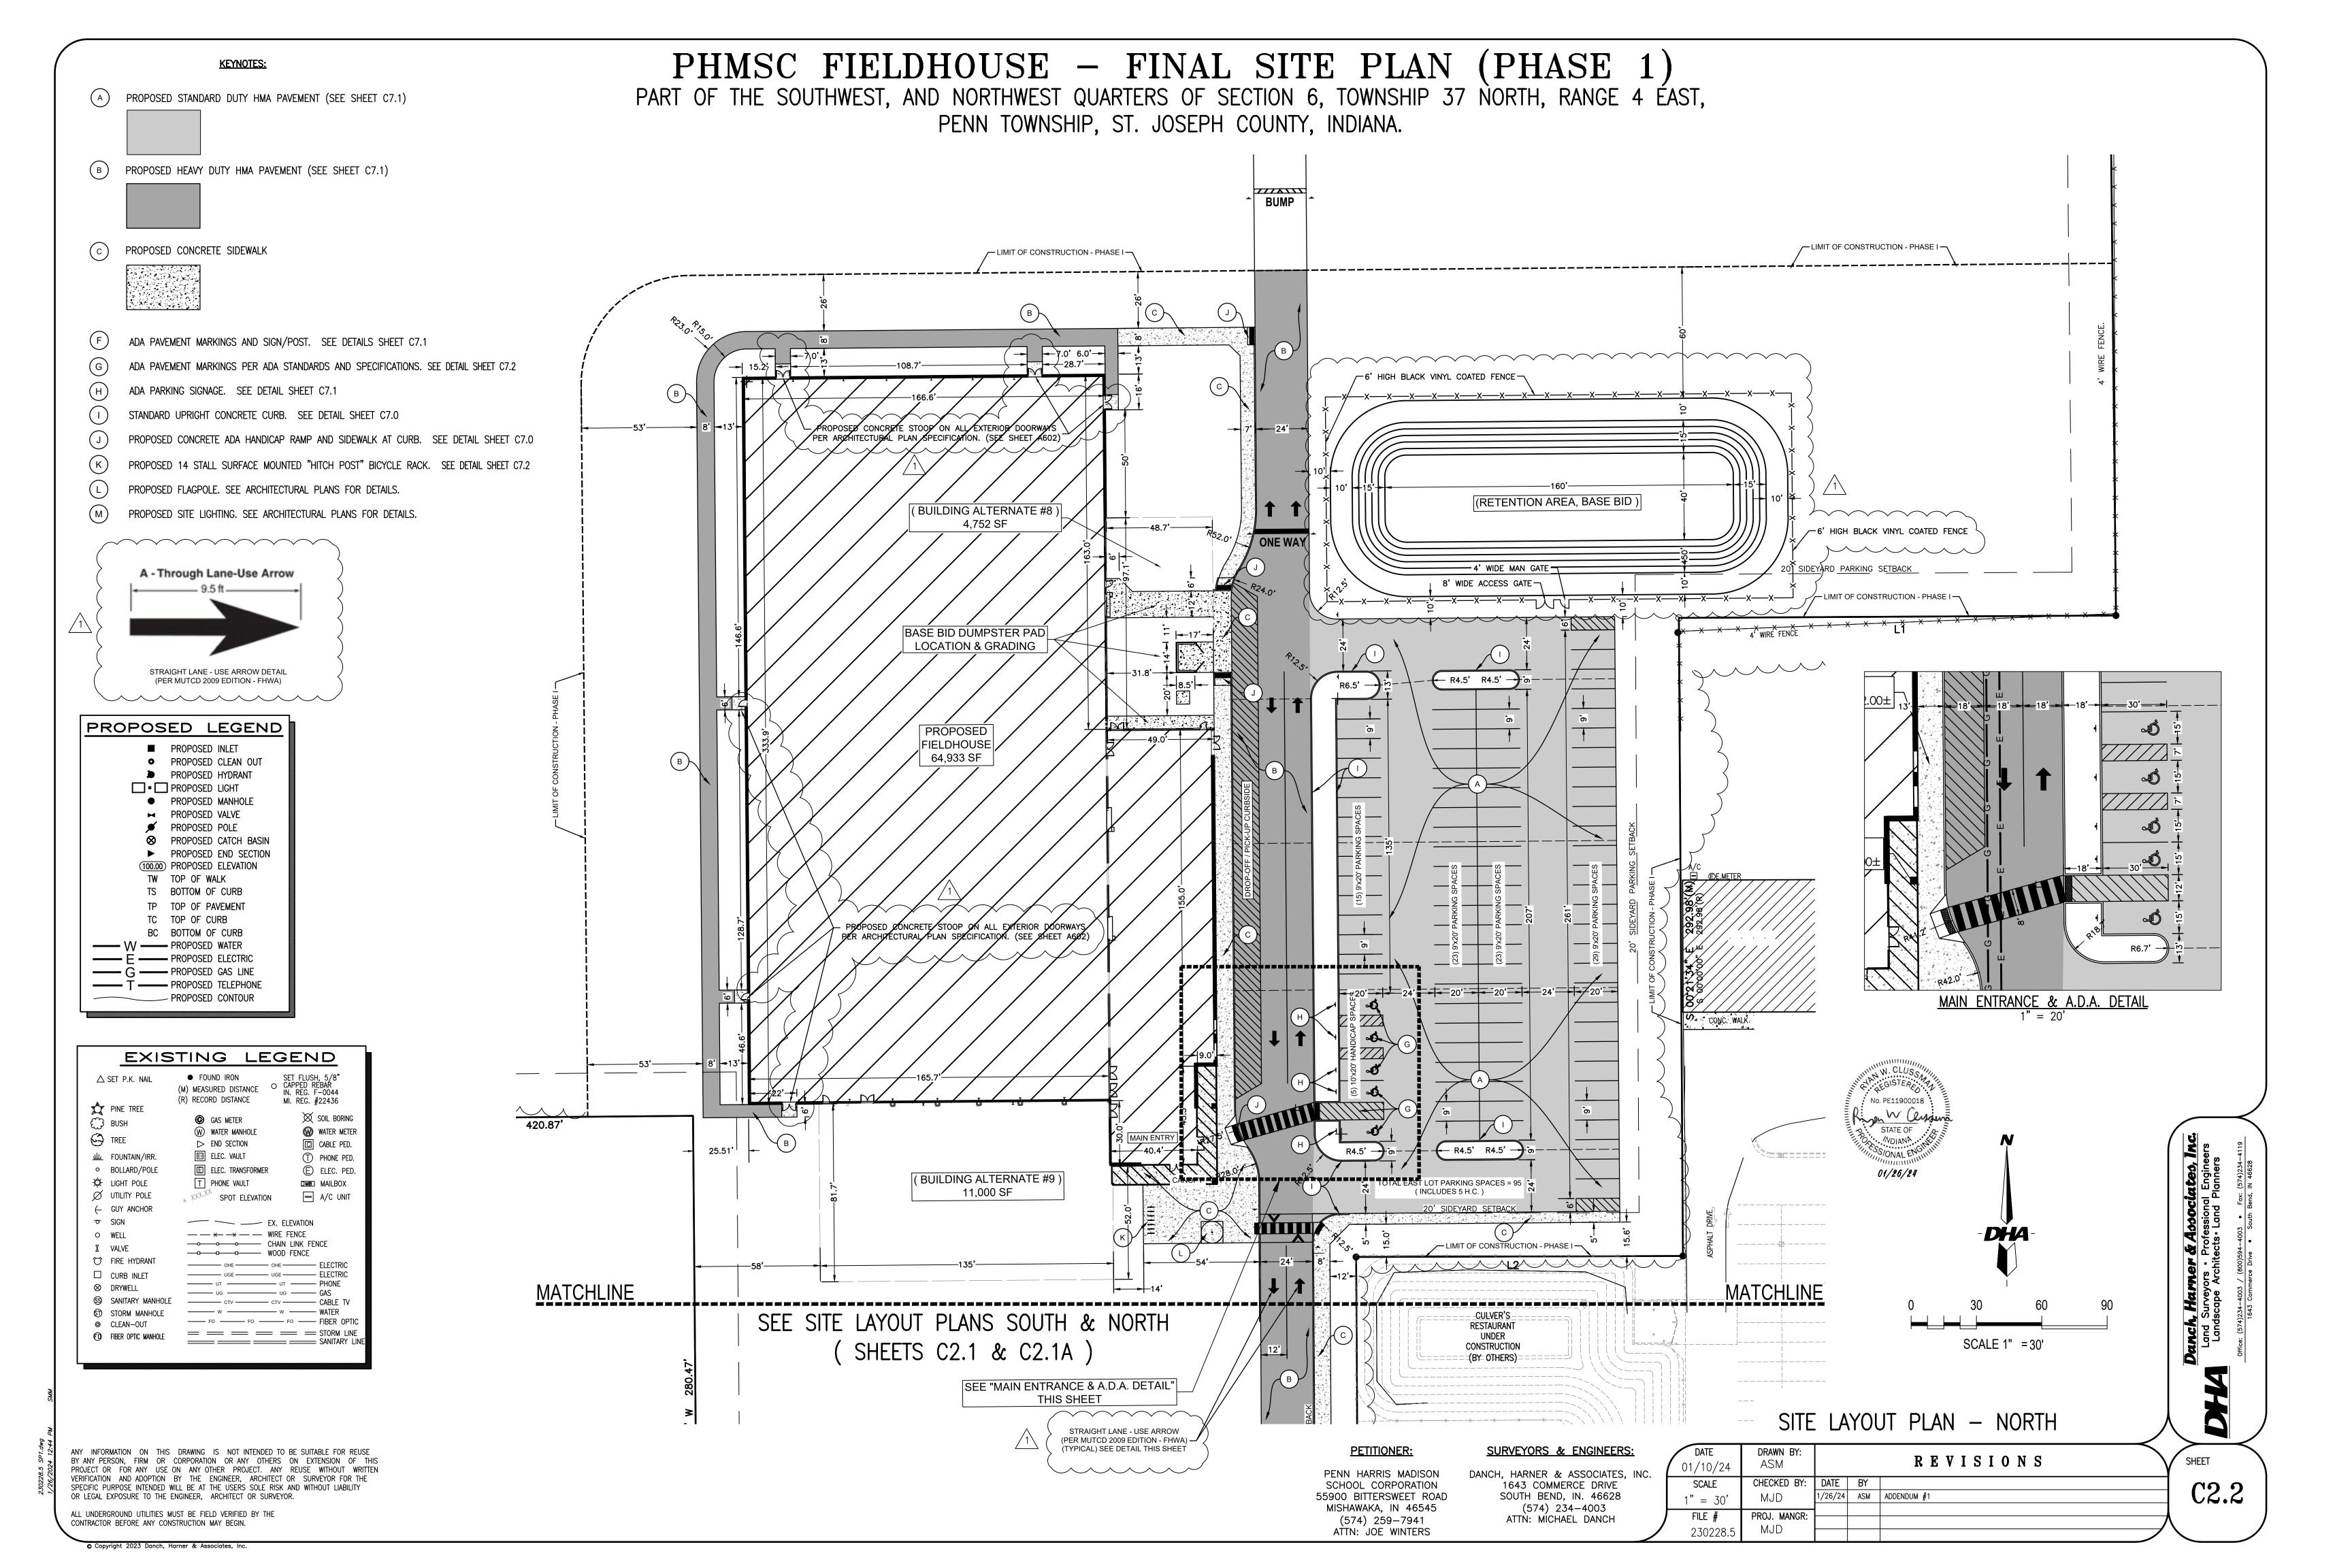

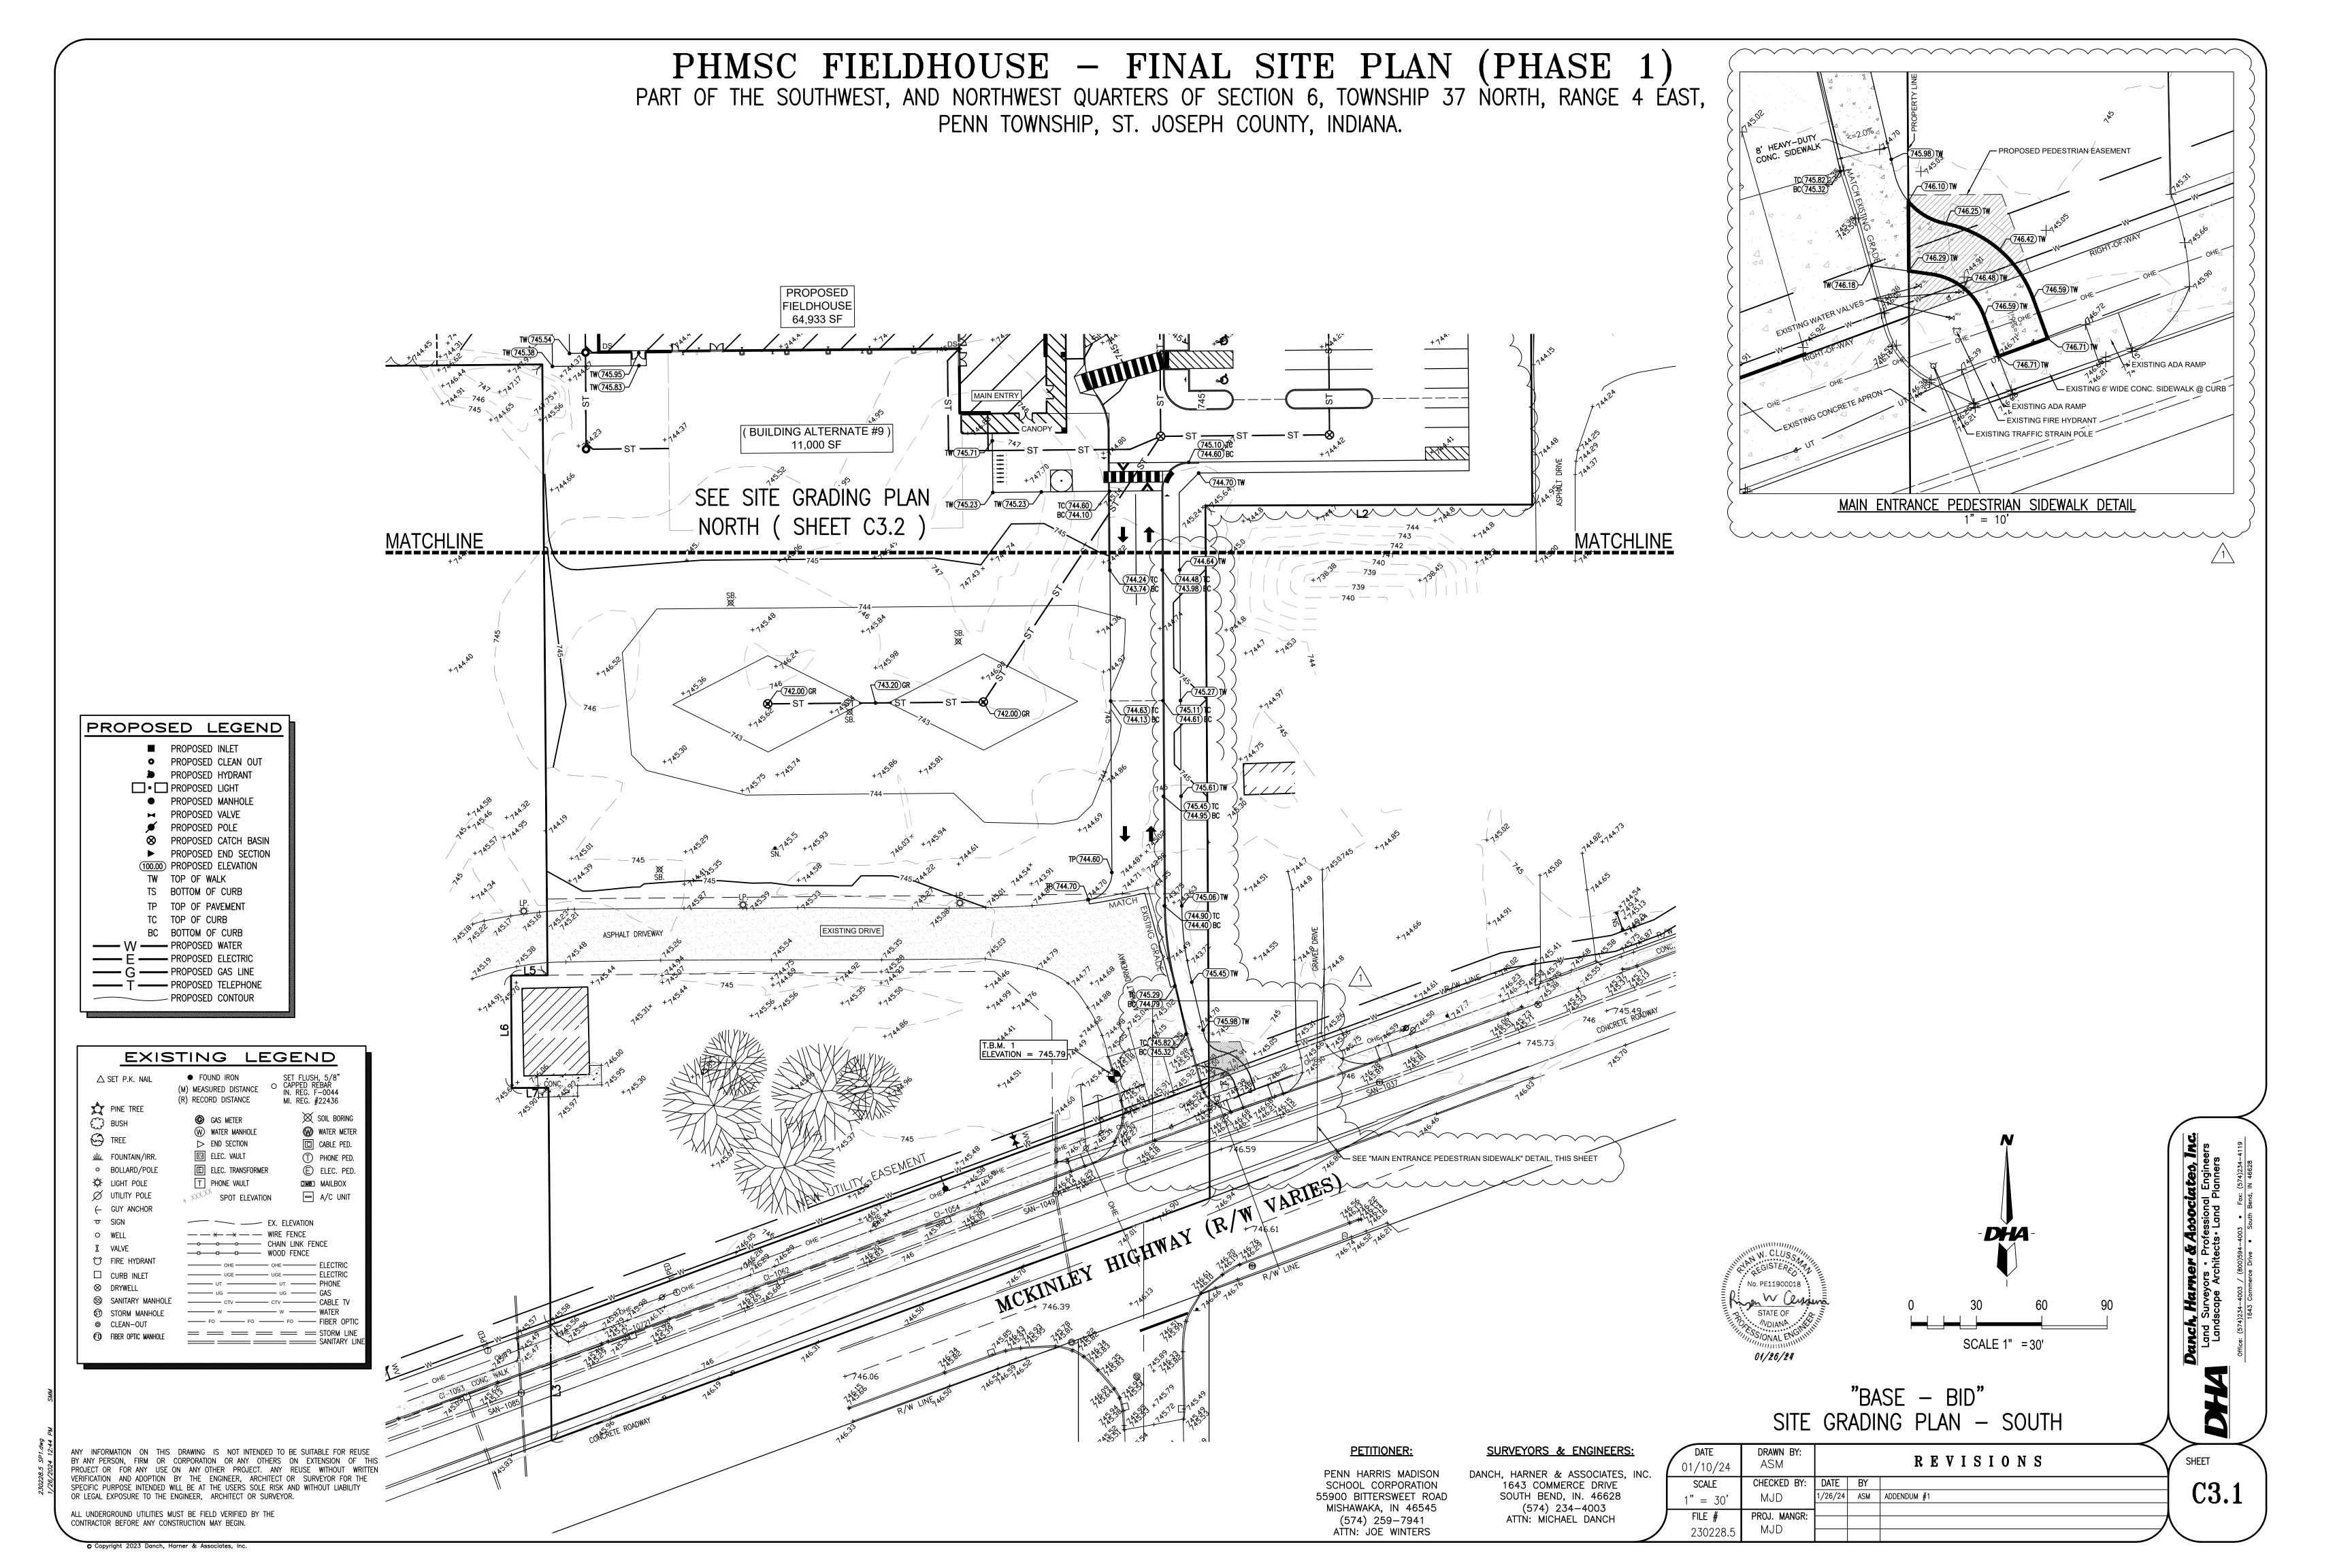


PHMSC FIELDHOUSE - FINAL SITE PLAN (PHASE 1)

PART OF THE SOUTHWEST, AND NORTHWEST QUARTERS OF SECTION 6, TOWNSHIP 37 NORTH, RANGE 4 ÉAST, PENN TOWNSHIP, ST. JOSEPH COUNTY, INDIANA.


PROPOSED LEGEND PROPOSED INLET PROPOSED CLEAN OUT ▶ PROPOSED HYDRANT ☐ • ☐ PROPOSED LIGHT PROPOSED MANHOLE → PROPOSED VALVE PROPOSED END SECTION 100.00 PROPOSED ELEVATION TW TOP OF WALK TS BOTTOM OF CURB TP TOP OF PAVEMENT TC TOP OF CURB BC BOTTOM OF CURB ----- G ------ PROPOSED GAS LINE ----- T ------ PROPOSED TELEPHONE



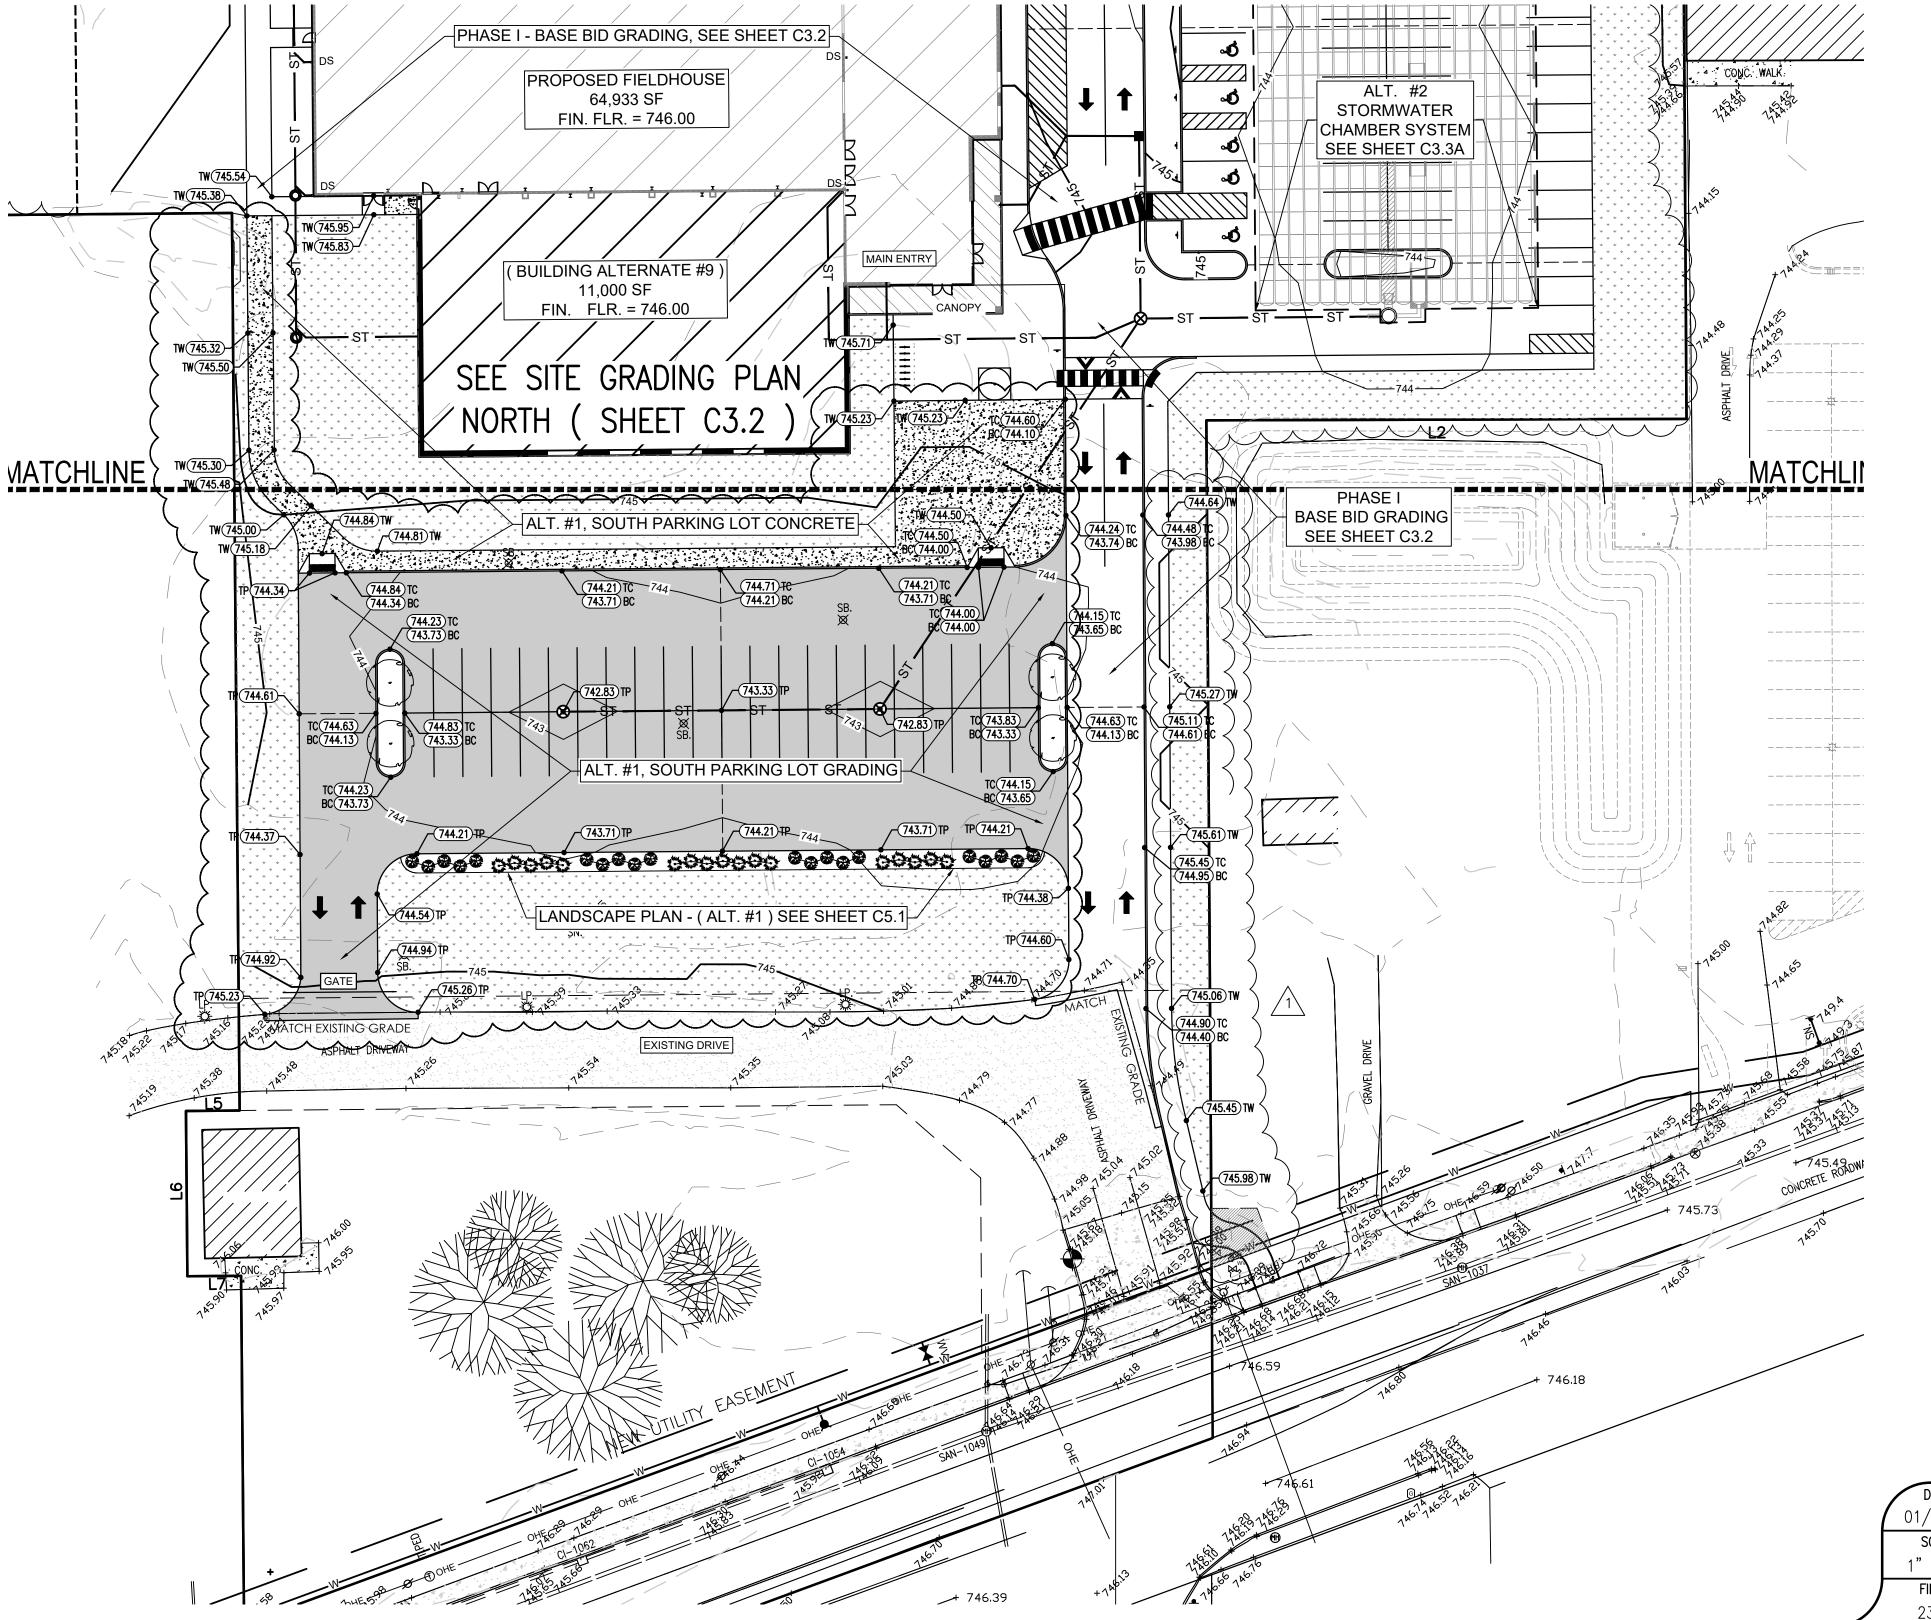

DRAINAGE CALCULATION: (ALT. #2 - CHAMBER SYSTEM)

PHMSC	FIELDHOUSE - FIN	NAL SITE PLAI	N (PHASE 1)
Post-Development	Area (ft ²)	Area (ac)	Coefficient	Total
Impervious Surface	92,781	2.130	0.99	91,853
Building	80,685	1.852	1.00	80,685
Open Space	134,781	3.094	0.23	31,000
Total	308,247	7.076		203,538
	Weighted Runoff (Coefficient (c) =	0.66	
Required Storage	Calculation			
	25 year, 24 Hour Rainfa	all Intensity (i) =	0.205	
	Q (0.93 x 0.205	n/hr x 1.13 ac) =	0.891	ft ³ /s
	Storage Required (C).215 ft ³ /s x 24 h	46,260	ft ³
Proposed Storag	e Calculation			
	Total Basin	Inf. Surf. Area =	27,500	ft ²
		Basin Depth =	5.0	ft
	Proposed Basin		47,129	ft ³
	Storag	ge Required:	46,260	ft ³
	Stora	ge Provided:	47,009	ft ³
	Surp	lus Storage:	749	ft ³

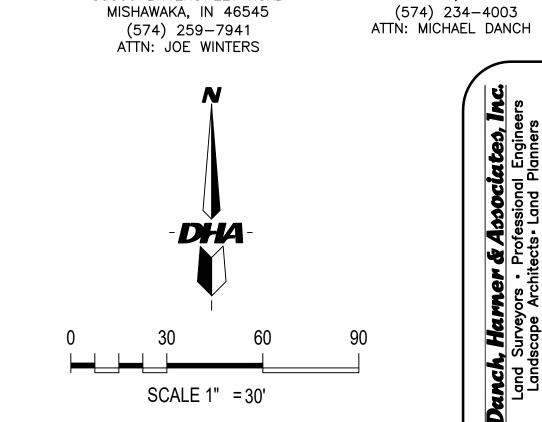

PETITIONER:

PENN HARRIS MADISON

SCHOOL CORPORATION

55900 BITTERSWEET ROAD

(ALT. #1, #2, #8 & #9) SITE GRADING PLAN - SOUTH

DRAWN BY: REVISIONS SCALE 1/26/24 ASM ADDENDUM #1 1" = 30'FILE # PROJ. MANGR:

No. PE11900018

01/26/24

SURVEYORS & ENGINEERS:

DANCH, HARNER & ASSOCIATES, INC.

1643 COMMERCE DRIVE SOUTH BEND, IN. 46628

SHEET C3.1A

ANY INFORMATION ON THIS DRAWING IS NOT INTENDED TO BE SUITABLE FOR REUSE

SPECIFIC PURPOSE INTENDED WILL BE AT THE USERS SOLE RISK AND WITHOUT LIABILITY


OR LEGAL EXPOSURE TO THE ENGINEER, ARCHITECT OR SURVEYOR.

ALL UNDERGROUND UTILITIES MUST BE FIELD VERIFIED BY THE


CONTRACTOR BEFORE ANY CONSTRUCTION MAY BEGIN.


BY ANY PERSON, FIRM OR CORPORATION OR ANY OTHERS ON EXTENSION OF THIS


PROJECT OR FOR ANY USE ON ANY OTHER PROJECT. ANY REUSE WITHOUT WRITTEN VERIFICATION AND ADOPTION BY THE ENGINEER, ARCHITECT OR SURVEYOR FOR THE

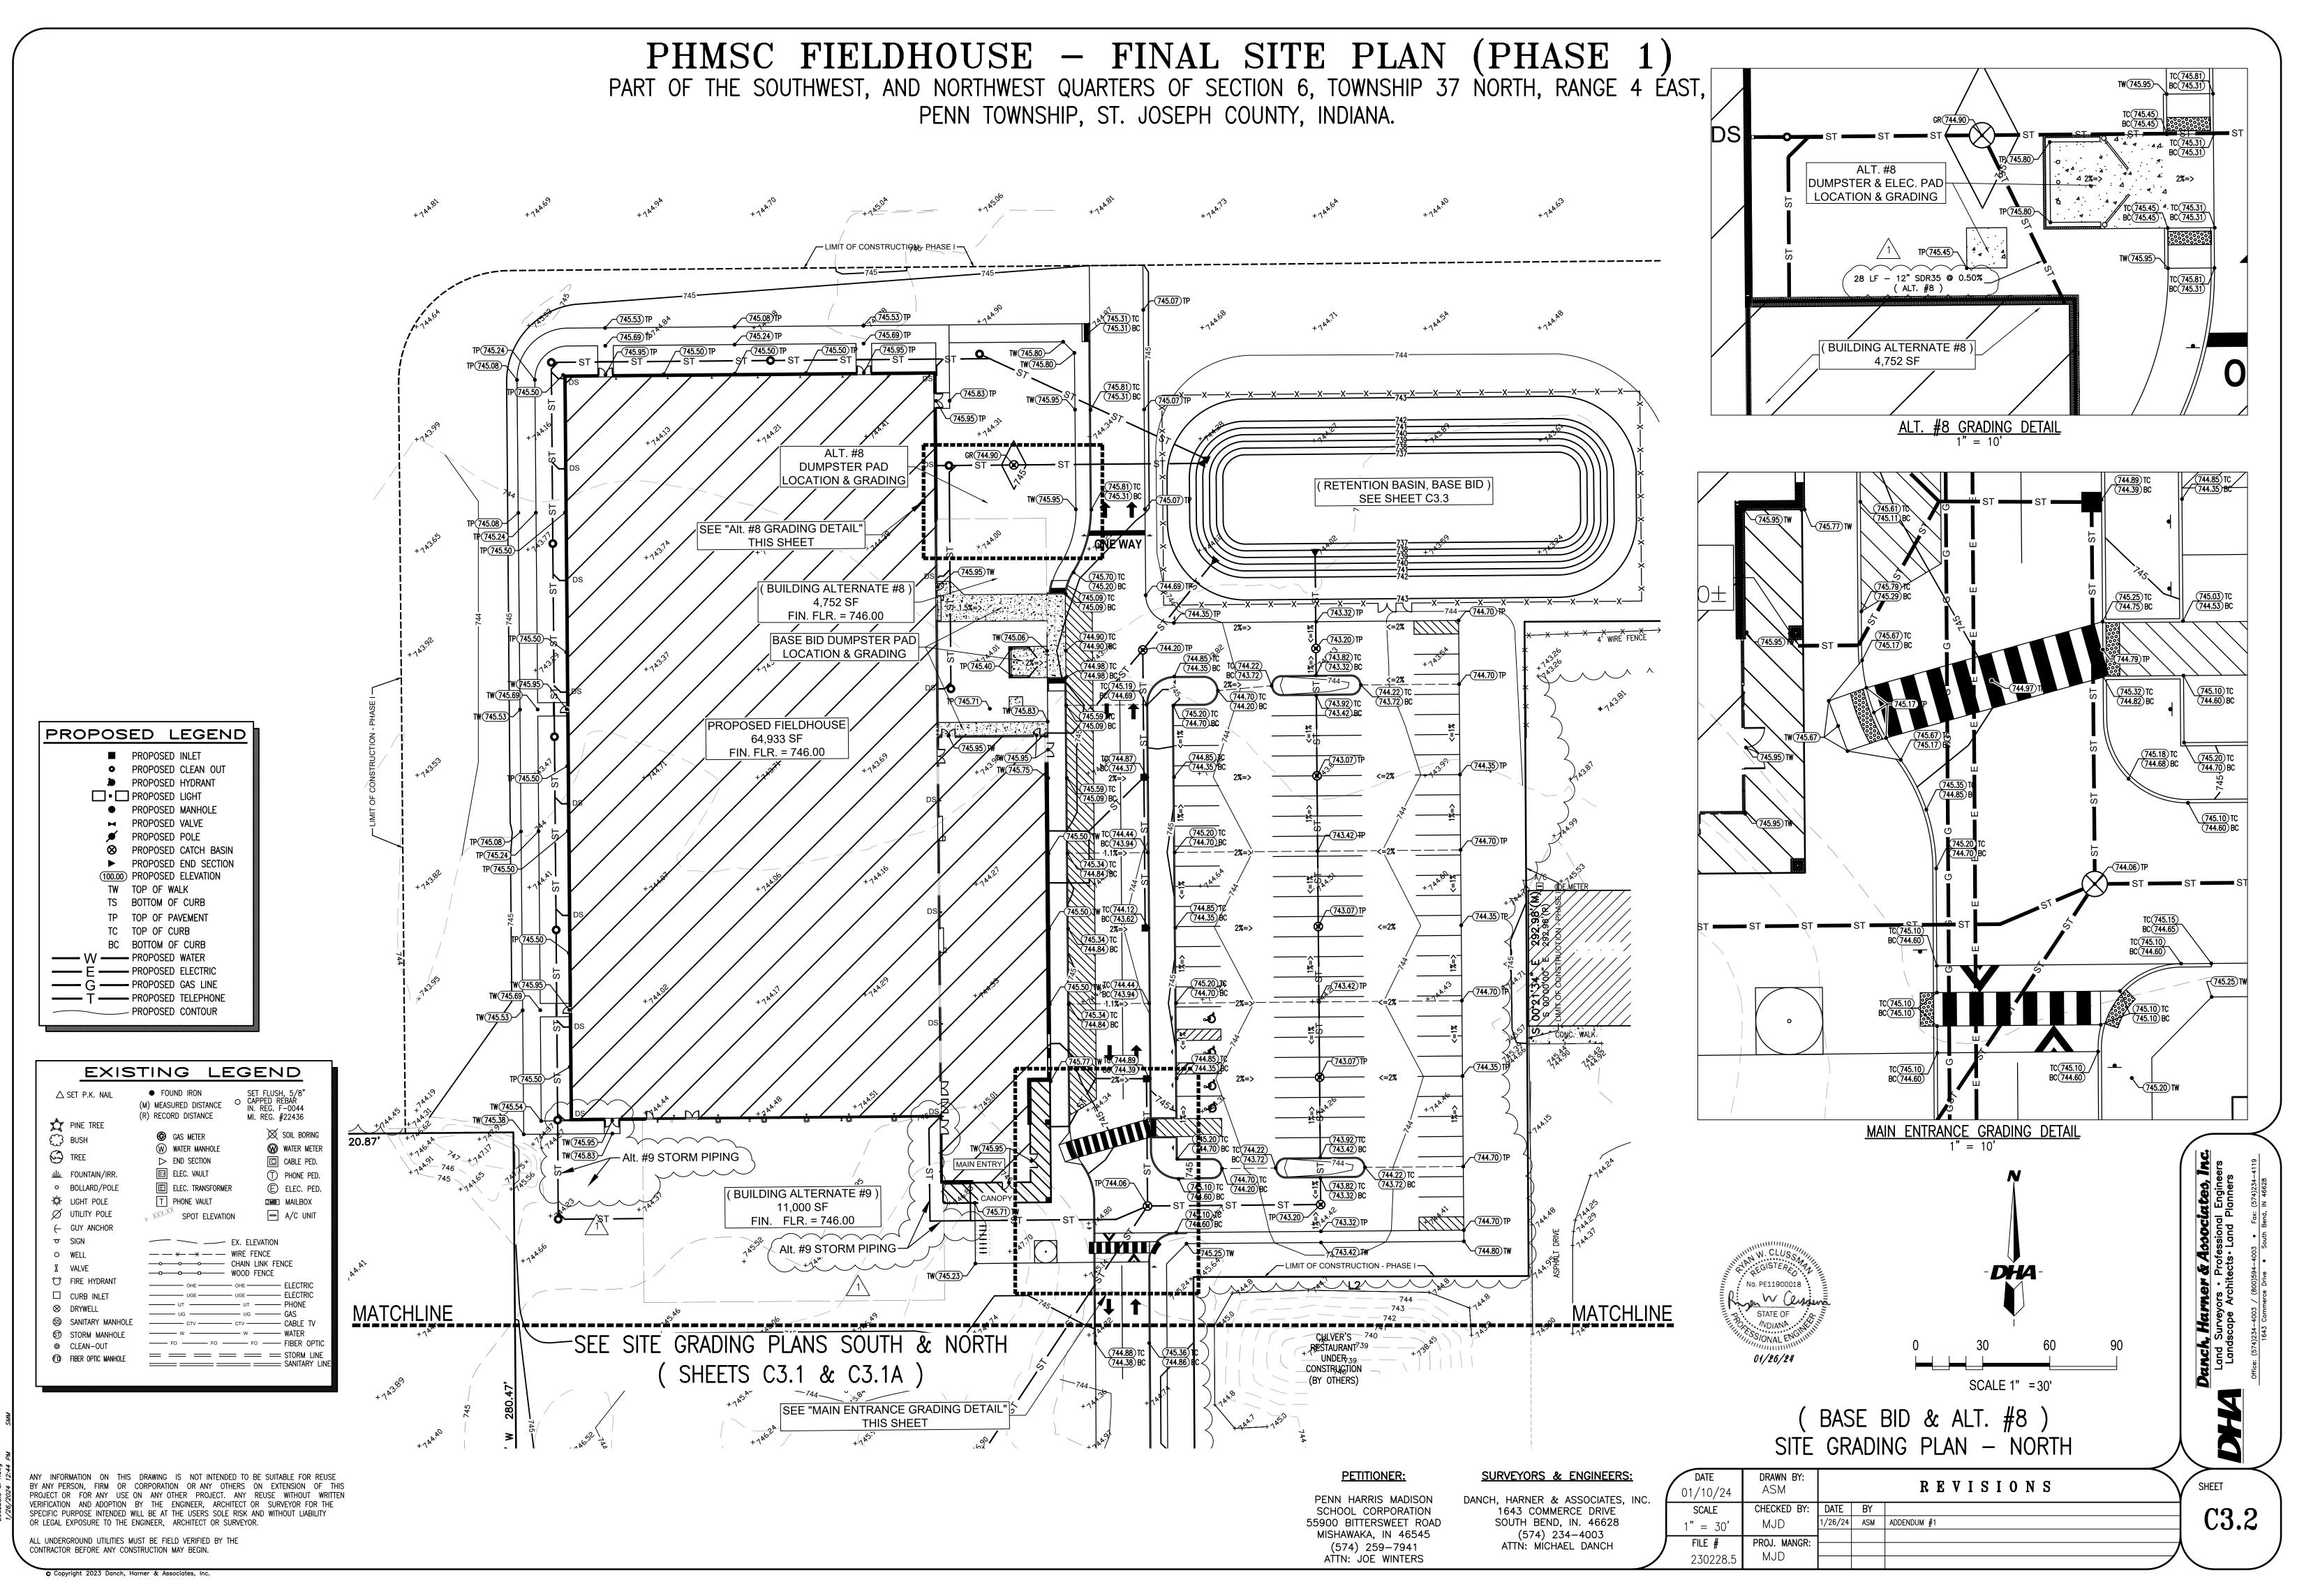

230228 5 SP1 dwa

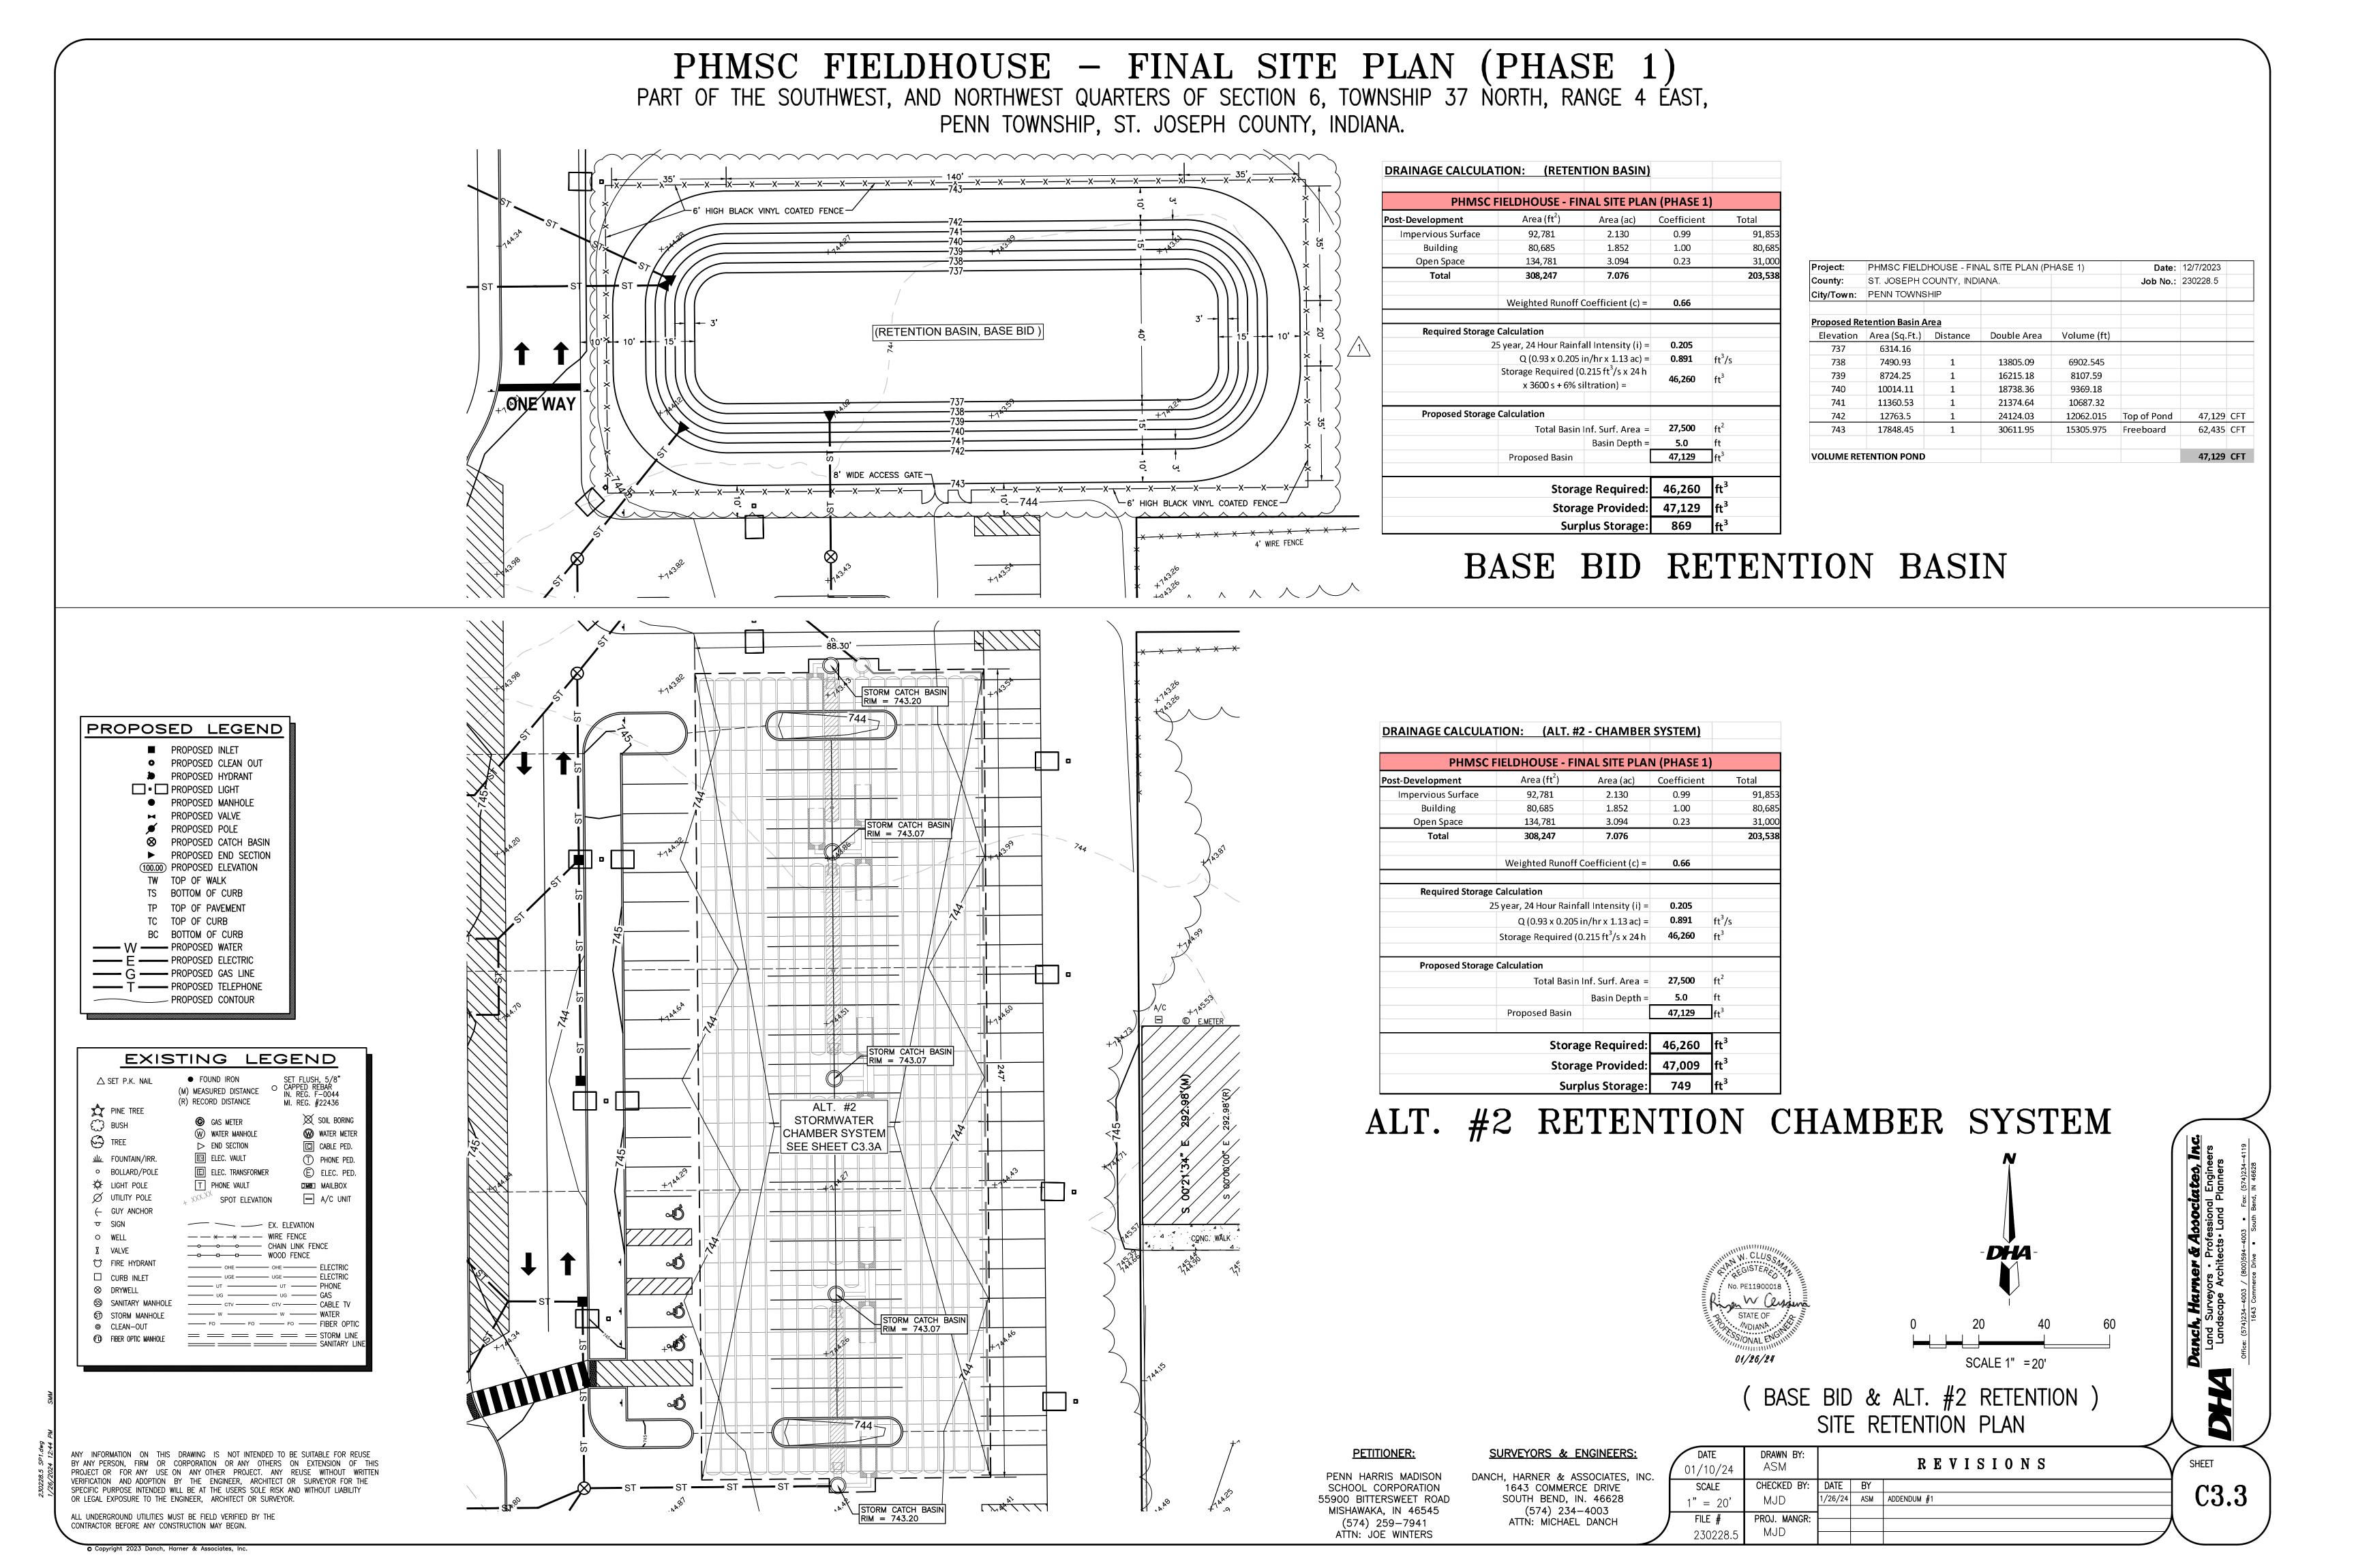


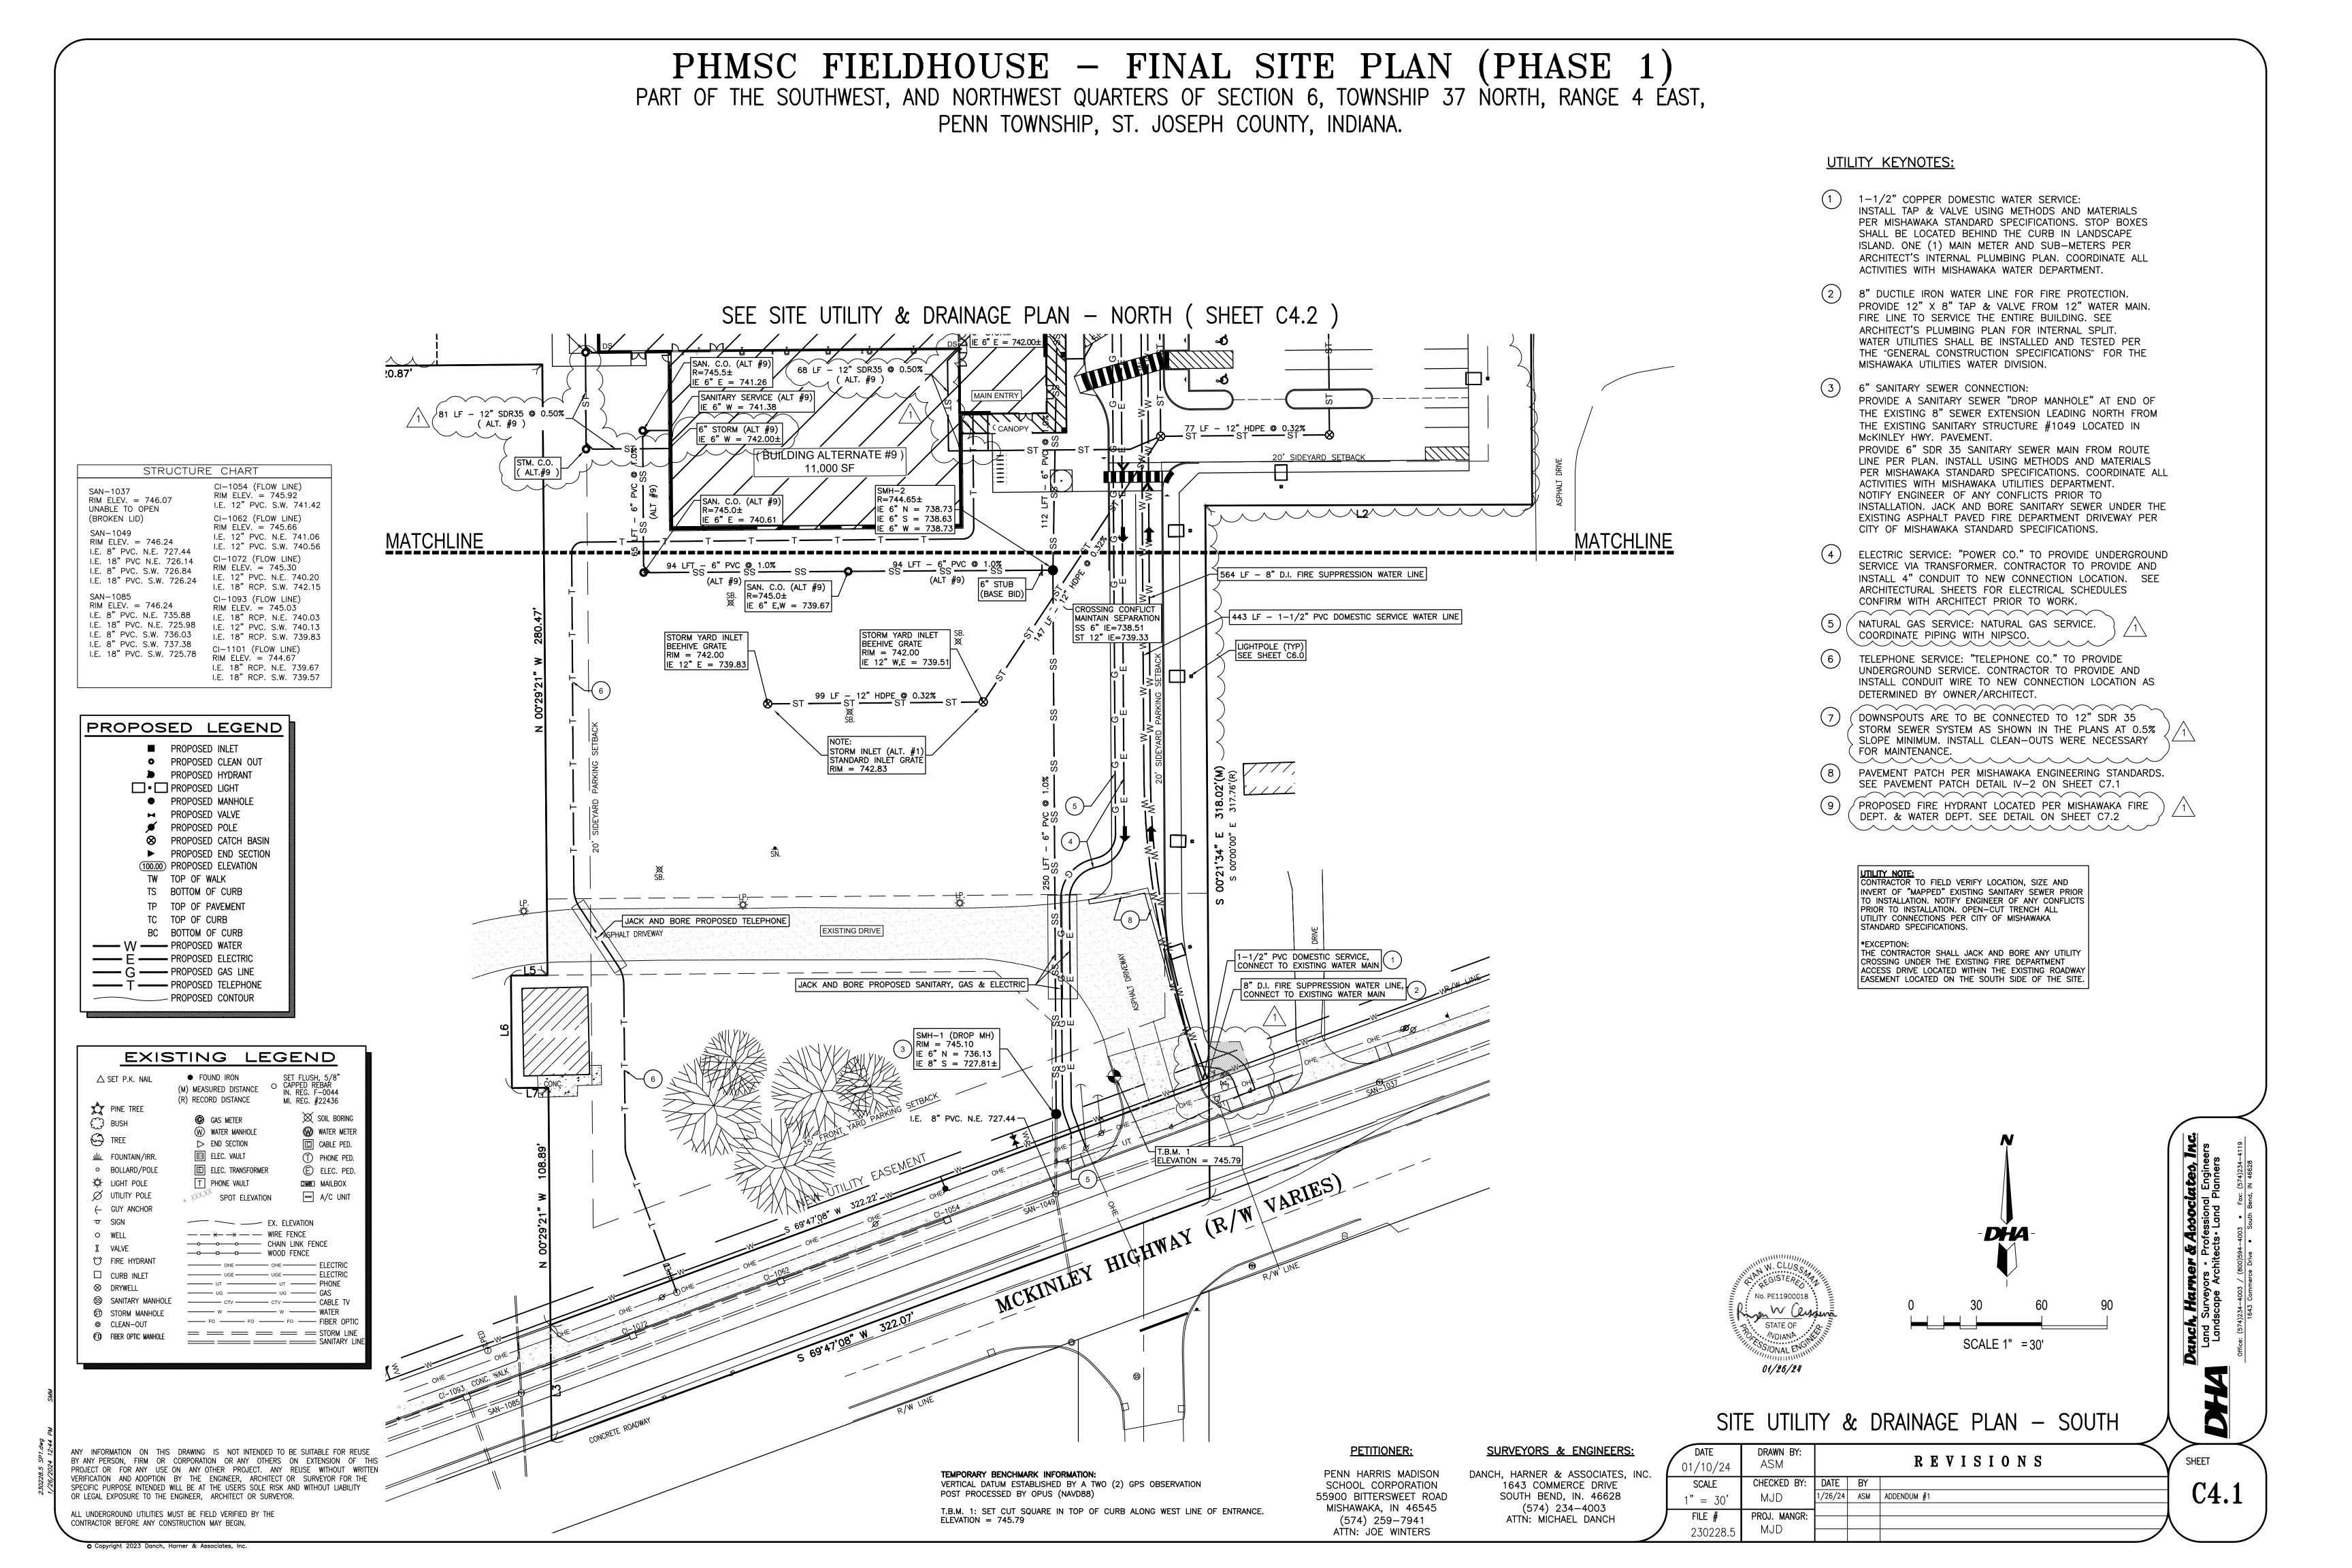


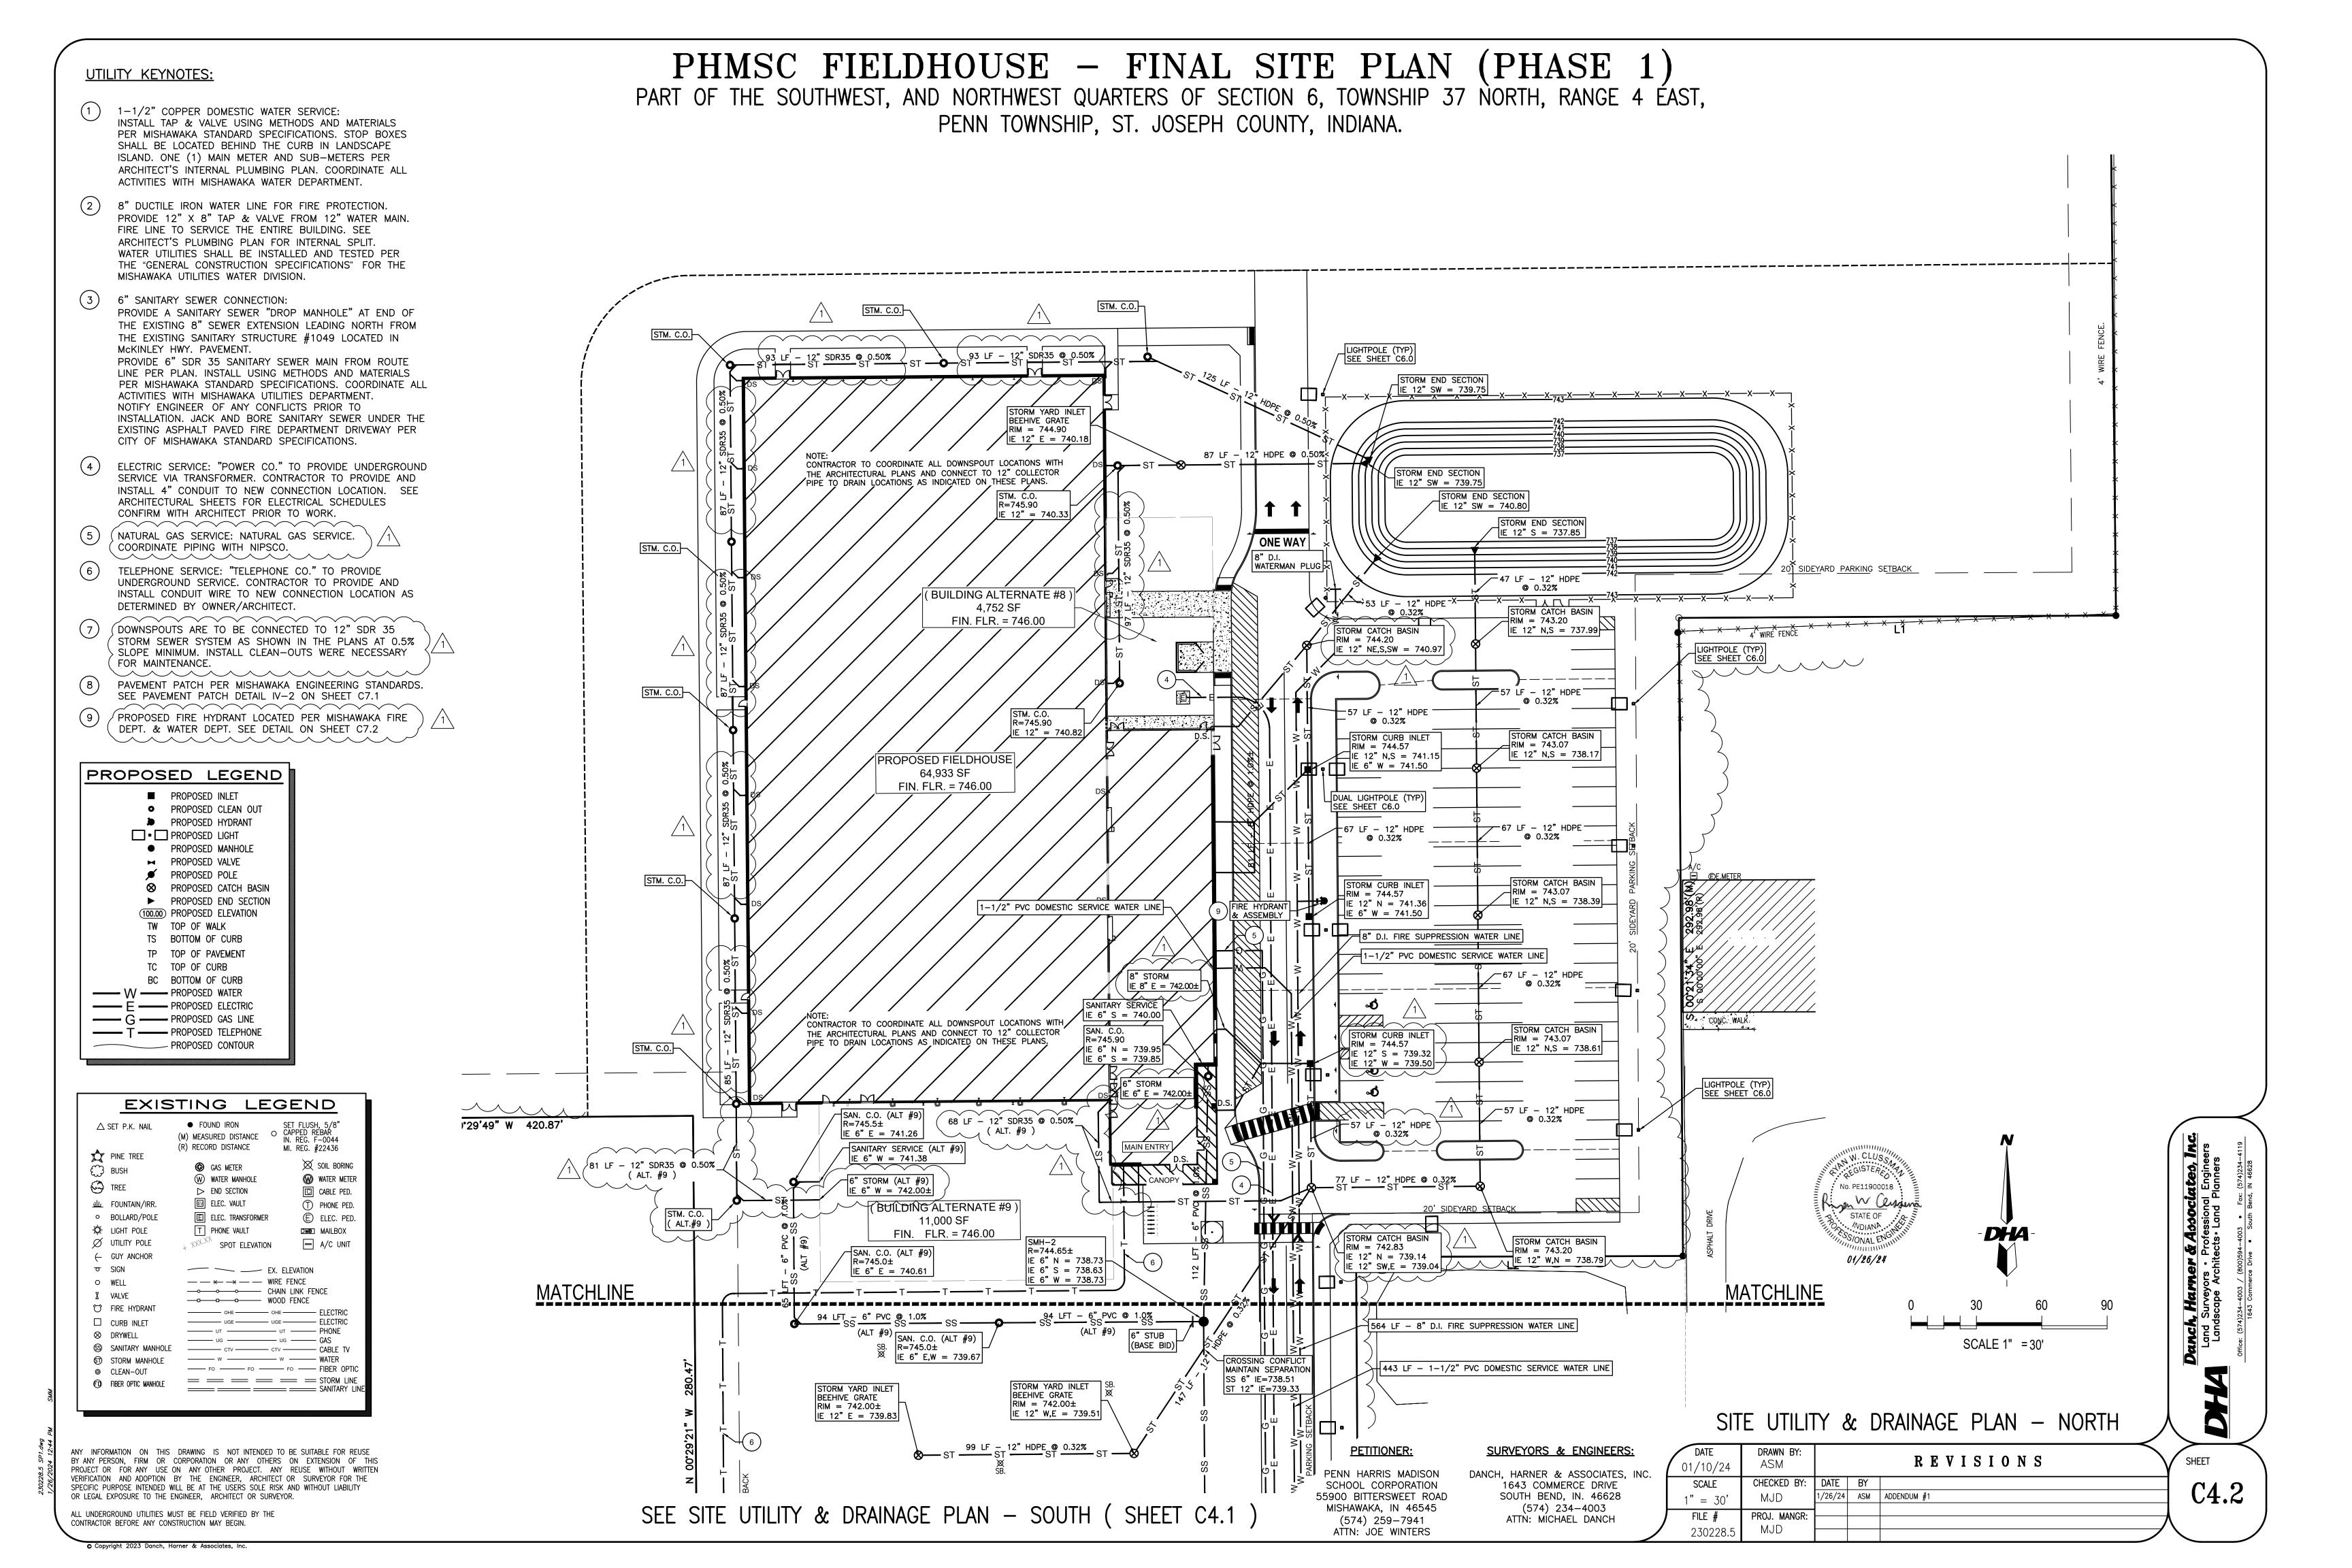

PHMSC FIELDHOUSE - FINAL SITE PLAN (PHASE 1)

PART OF THE SOUTHWEST, AND NORTHWEST QUARTERS OF SECTION 6, TOWNSHIP 37 NORTH, RANGE 4 ÉAST, PENN TOWNSHIP, ST. JOSEPH COUNTY, INDIANA.

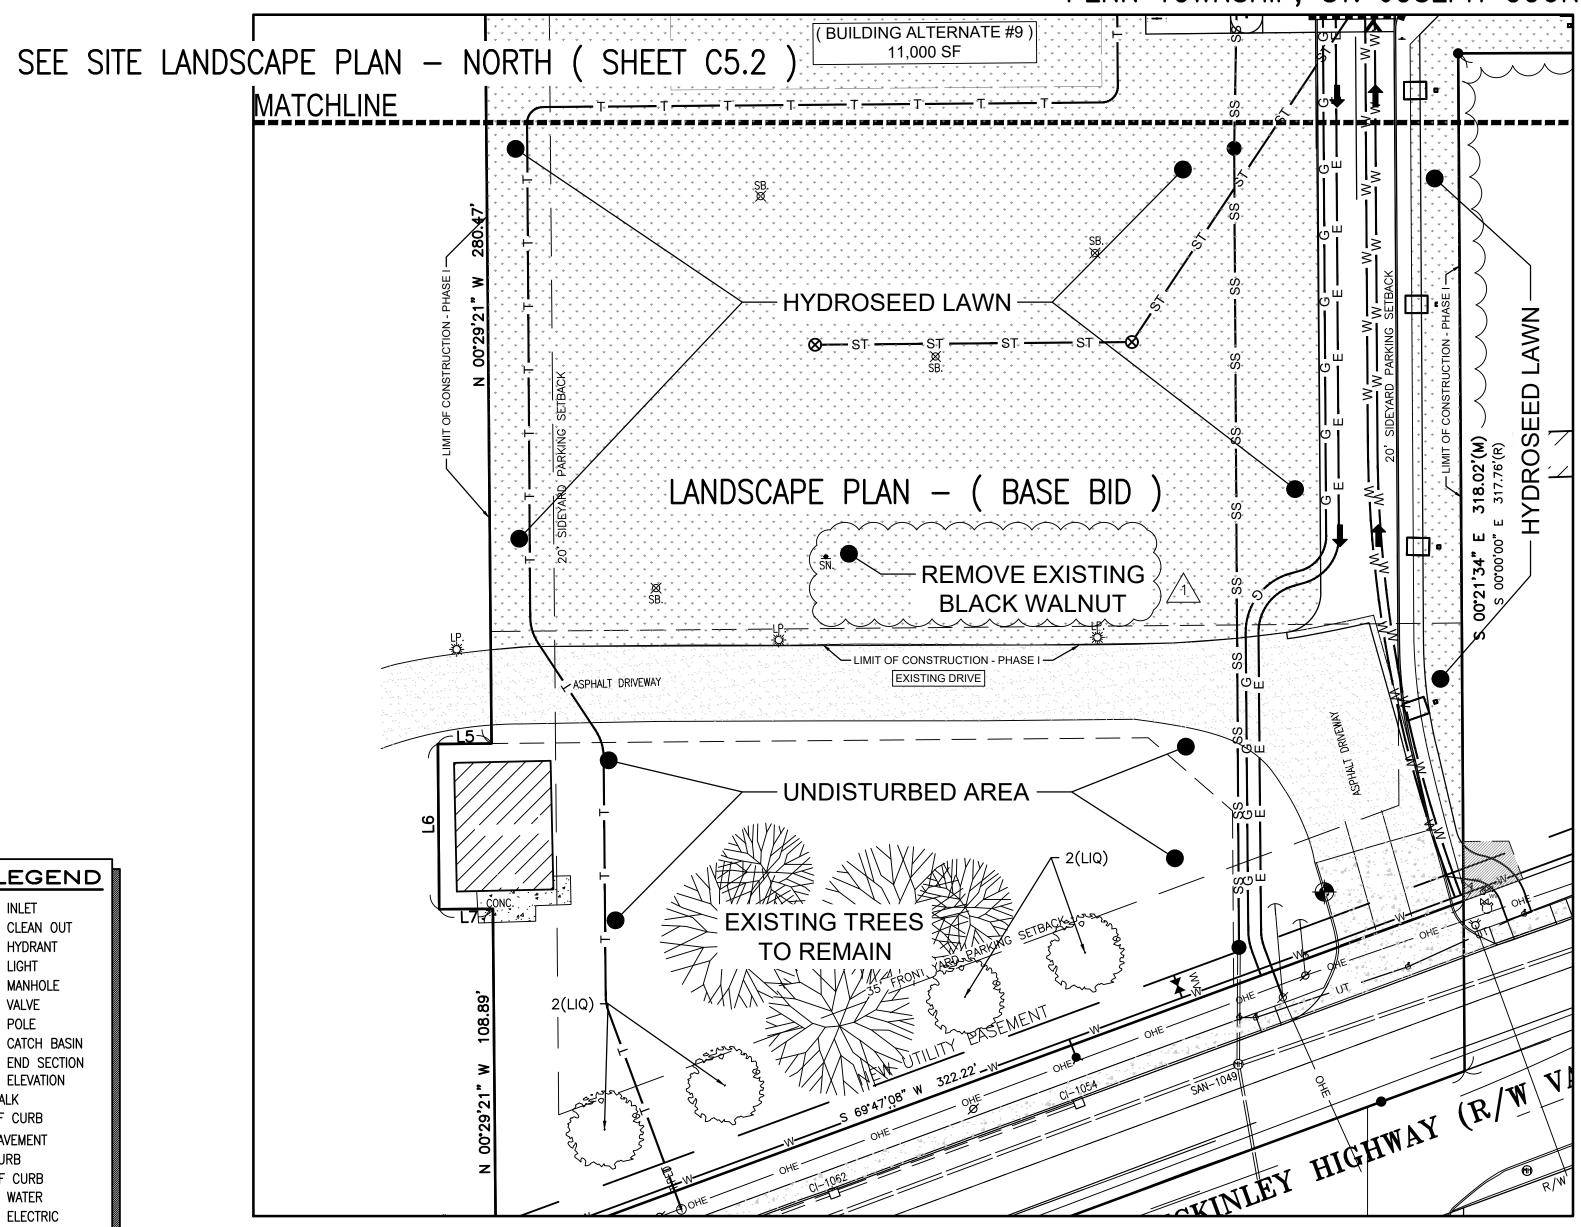


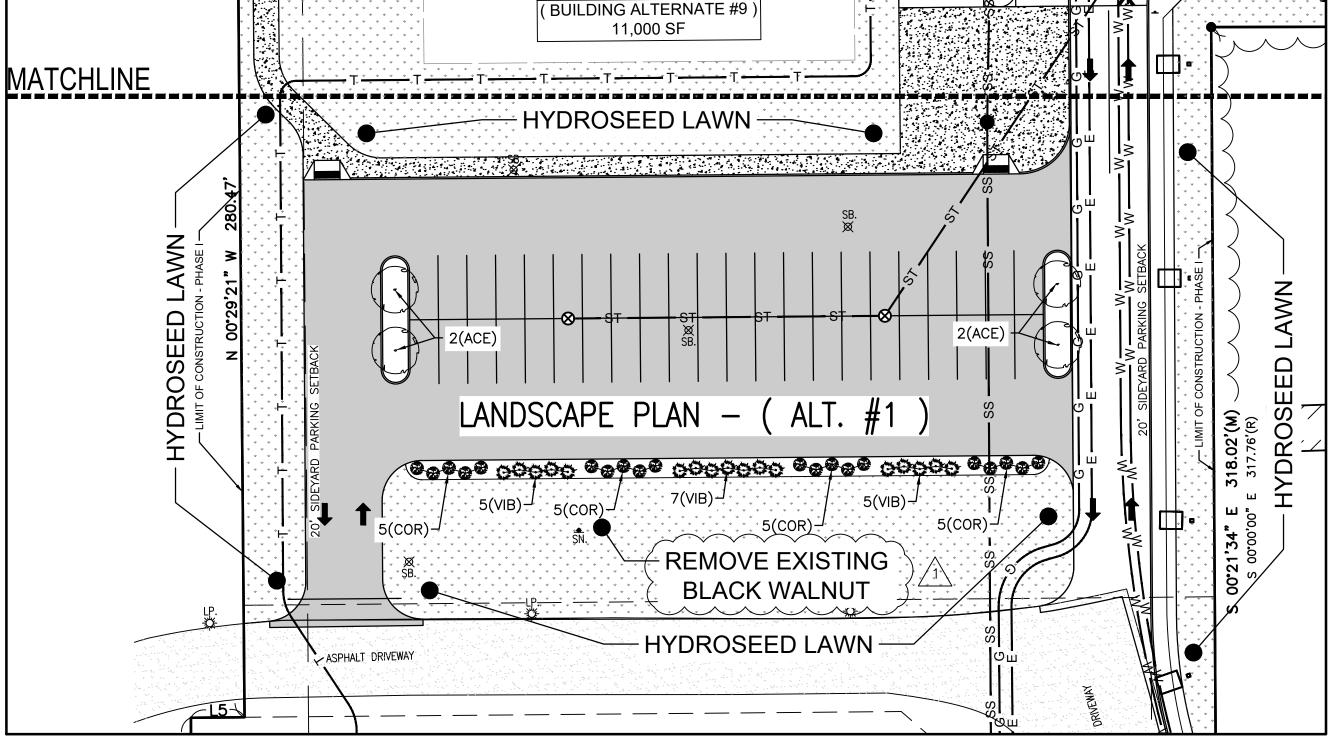

PRIOR TO CONSTRUCTION, CONTRACTOR SHALL REVIEW ENTIRE PLAN SET.

FOR CLARIFICATION AND/OR REVISIONS.

IF ANY DISCREPANCIES ARE FOUND, CONTRACTOR SHALL CONTACT ENGINEER

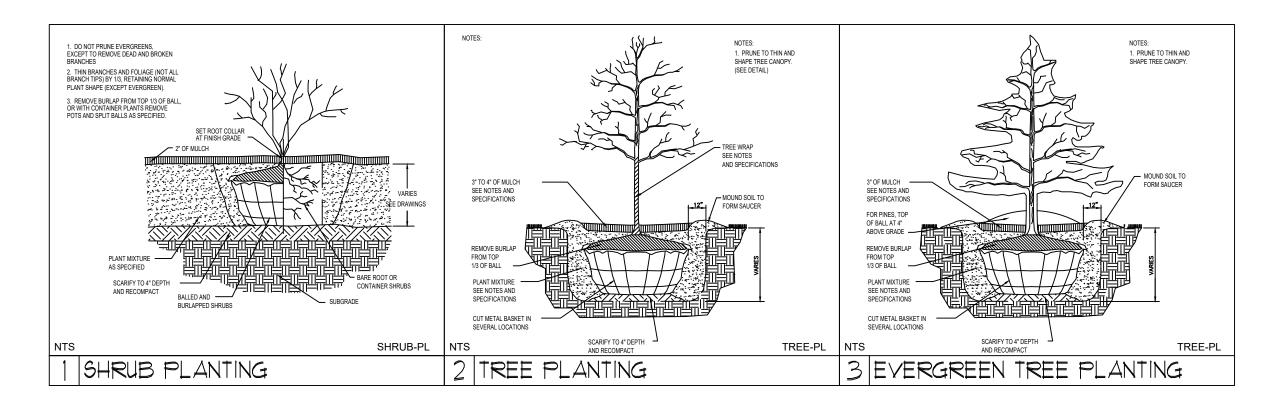

		JANU	SCAPE PLAN	QUANTITIES — (S	ООТП	<u>') </u>	
REES							
QUANTITIES BASE BID	QUANTITIES ALT #1	ABBR	COMMON NAME	BOTANICAL NAME	SIZE	CONT	REMARKS
4	4	LIQ	AMERICAN SWEETGUM	LIQUIDAMBAR STYRACIFLUA 'MORAINE'	3" CAL.	B&B	
-	4	ACE	OCTOBER GLORY MAPLE	ACER RUBRUM 'OCTOBER GLORY'	3" CAL.	B&B	
_	_	TAV	TECHNY ARBOR VITAE	THUJA "TECHNY" ARBOR VITAE	6' TALL	B&B	
QUANTITIES BASE BID	QUANTITIES ALT #1	ABBR	COMMON NAME	BOTANICAL NAME	SIZE	CONT	REMARKS
D. 10 L D.D	17	VIB	KOREANSPICE VIBURNUM	VIBURNUM CARLESII	24" HT.	5 GAL.	
_	'/						
- -	20	COR	RED TWIG DOGWOOD	CORNUS SERICEA 'CARDINAL'	36" HT.	B&B	
- - PRNAME	20 NTAL GF	RASSES					
-	20			CORNUS SERICEA 'CARDINAL' BOTANICAL NAME	SIZE	B&B CONT	REMARKS

- NERAL LANDSCAPE NOTES:
 CONTRACTOR SHALL BE RESPONSIBLE TO NOTIFY ALL UTILITY COMPANIES AND VERIFY LOCATION OF ALL PRIVATE AND PUBLIC ON SITE UTILITIES PRIOR TO CONSTRUCTION.
- CONTRACTOR SHALL BE RESPONSIBLE FOR THE VERIFICATION OF ALL SITE CONDITIONS WHICH MAY EFFECT THE LANDSCAPE PLANT MATERIALS AND SITE AMENITY INSTALLATION. CONTRACTOR ALSO MUST NOTIFY LANDSCAPE ARCHITECT OF CONDITIONS THAT MAY BE DETRIMENTAL TO HEALTHY PLANT DEVELOPMENT, OR MAY CAUSE VOID
- 3. CONTRACTOR SHALL BE RESPONSIBLE FOR THE INSTALLATION OF ALL LANDSCAPE MATERIALS IN ACCORDANCE WITH THE LATEST EDITION OF THE "USA STANDARD FOR NURSERY STOCK", PUBLISHED BY THE AMERICAN ASSOCIATION
- 1. CONTRACTOR SHALL BE RESPONSIBLE FOR A MINIMUM OF (1) YEAR GUARANTEE FOR ALL PLANT MATERIALS FROM THE DATE OF SURSTANTIAL COMPLETION. ANY DEAD PLANT MATERIALS SHALL BE REPLACED WITH MATERIAL FOLIAL IN SIZE AND QUALITY AS LISTED IN THE MASTER PLANT LIST. ALL COST FOR REPLACING PLANT MATERIALS WITHIN THE GUARANTEE PERIOD WILL BE AT THE RESPONSIBILITY OF THE CONTRACTOR.
- 5. THE LANDSCAPE CONTRACTOR IS RESPONSIBLE FOR COORDINATION WITH OTHER WORK DISCIPLINES TO ENSURE NO CONFLICT BETWEEN WORK TYPES.
- 6. ALL DECIDUOUS TREES AND EVERGREEN TREES SHALL BE BALLED AND BURLAP UNLESS OTHERWISE NOTED. 7. ALL SHRUBS MAY BE CONTAINER GROWN OR BALLED AND BURLAP.
- 8. THE CALIPER SIZE LISTED ON THE MASTER PLANT LIST INDICATES THE DIAMETER OF THE TRUNK TAKEN AT 6" ABOVE
- 9. SPACE PLANT MATERIALS AS INDICATED ON MASTER PLANT LIST OR PER PROPER HORTICULTURAL
- 10. CONTRACTOR SHALL PROVIDE A TWO YEAR STRAIGHTENING GUARANTEE IN LIEU OF STACKING AND GUYING TREES. 11. CONTRACTOR SHALL VERIFY QUANTITIES OF PROPOSED PLANT MATERIALS AND SITE AMENITIES SHOW ON THE MASTER MATERIALS LIST AND PLANS. IF A DISCREPANCY APPEARS, THE ACTUAL COUNT ON THE PLANS SHALL
- 12. KEEP BALLED AND CONTAINER PLANT MATERIAL WATERED UNTIL THEY ARE PLANTED. IF PLANTS CANNOT BE PLANTED IMMEDIATELY, THEY SHOULD BE HEELED IN AND COVERED WITH MULCH UNTIL TIME OF PLANTING.
- 13. CONDUCT SOILS TEST TO VERIFY FERTILITY OF TOPSOIL. AMEND SOIL IF PH IS LESS THAN 5.0 OR GREATER THAN 7.5. MAKE OTHER ADJUSTMENTS AS SOIL ANALYSIS INDICATES. ALL FINE GRADE SOIL PREPARATION OF PLANTING AND LAWN AREAS SHALL BE PERFORMED BY THE LANDSCAPE CONTRACTOR UNLESS OTHERWISE SPECIFIED .
- 14. TOPSOIL DEPTH TO BE A MINIMUM OF 6" IN ALL PLANTING BEDS AND 3" IN LAWN AREAS, GENERAL CONTRACTOR IS TO SUPPLY TOPSOIL TO THESE STANDARDS AND PROVIDE FINISH GRADE. LANDSCAPE CONTRACTOR TO PROVIDE FINAL GRADE FOR SEED APPLICATION AND PLANT MATERIAL INSTALLATION. TOPSOIL TO BE CLEAN FRIABLE LOAM FROM LOCAL SOURCE AND FREE FROM STONES AND DEBRIS OVER 3/4" IN DIAMETER. TOPSOIL MUST BE FREE FROM TOXINS AND HERBICIDES.
- 15. LANDSCAPE BEDS SHALL BE DEFINED BY COMMERCIAL GRADE 5" BLACK VINYL EDGING, PRODUCED BY AN ESTABLISHED MANUFACTURER OR APPROVED EQUAL.
- 16. LANDSCAPE BEDS TO RECEIVE 3"-4" INDUSTRY STANDARD SHREDDED HARDWOOD BARK MULCH.
- 17. ALL TREES NOT INCORPORATED INTO THE LANDSCAPE BEDS ARE TO RECEIVE A 3' RADIUS MULCH RING, 3" DEEP. 18. APPLY PRE-EMERGENT HERBICIDE TO ALL LANDSCAPE BEDS PRIOR TO MULCHING.
- 19. HYDROSEED: INSTALL HYDROSEED PER COMMON INDUSTRY STANDARDS WHERE INDICATED ON PLANS.

PETITIONER:

PENN HARRIS MADISON

SCHOOL CORPORATION

55900 BITTERSWEET ROAD

MISHAWAKA, IN 46545

(574) 259-7941

ATTN: JOE WINTERS

- 37.50% PERENIIAL RYE 31.00% KENTUCKY BLUE 31.50% CREEPING RED FESCUE
- 20. ALL LANDSCAPE & LAWN AREAS SHALL BE 100% IRRIGATED, IF APPROVED BY OWNER, IRRIGATION CONTRACTOR SHALL INSTALL ALL REQUIRED IRRIGATION STRUCTURES, PIPES, TAPS, VALVES, WIRING, BACK FLOW PREVENTERS, METERS, ETC. ALL UNDER PAVEMENT SLEEVES SHALL BE COORDINATED AND INSTALLED PRIOR TO PAVEMENT INSTALLATION BY THE SITE CONTRACTOR. ALL IRRIGATION PLANS ARE TO BE DESIGN BY A CERTIFIED IRRIGATION DESIGNER AND APPROVED BY THE LANDSCAPE ARCHITECT PRIOR TO ANY INSTALLATION.

SURVEYORS & ENGINEERS:

DANCH, HARNER & ASSOCIATES, INC.

1643 COMMERCE DRIVE

SOUTH BEND, IN. 46628

ATTN: MICHAEL DANCH

(574) 234-4003

BASE BID & ALT. #1) SITE LANDSCAPE PLAN - SOUTH

DRAWN BY: REVISIONS CHECKED BY: | DATE | BY SCALE 1/26/24 ASM ADDENDUM #1 1" = 30' FILE # PROJ. MANGR:

No. PE11900018 STATE OF 01/26/24

THE ENGINEER HAS INDICATED UNDERGROUND UTILITIES ON THESE PLANS BASED UPON

THE CONTRACTOR IS RESPONSIBLE FOR COORDINATING HIS WORK WITH THE UTILITIES, PROTECTING ALL UTILITIES, PAYING ALL COSTS FOR DAMAGE TO UTILITY FACILITIES, AND

AT THE START OF THIS PROJECT. THE CONTRACTOR SHALL NOT BEGIN UNDERGROUND

WORK UNTIL ALL UTILITIES HAVE BEEN ACCURATELY LOCATED ON THE GROUND. WATER

OF SOUTH BEND WATER DEPT.

INFORMATION PROVIDED BY THE VARIOUS UTILITIES. THE ACCURACY AND COMPLETENESS OF THIS INFORMATION IS UNKNOWN AND THE ENGINEER ACCEPTS NO LIABILITY FOR UTILITY

RESTORING ALL UTILITIES TO A CONDITION WHICH IS BETTER THAN THE ORIGINAL CONDITION

LINES DETERMINED FROM FIELD LOCATIONS AND SCALED FROM MAPS PROVIDED BY THE CITY

SHEET

SCALE 1" = 30'

CONTRACTOR BEFORE ANY CONSTRUCTION MAY BEGIN.

OR LEGAL EXPOSURE TO THE ENGINEER, ARCHITECT OR SURVEYOR.

PROPOSED LEGEND

■ PROPOSED INLET PROPOSED CLEAN OUT PROPOSED HYDRANT ☐ • ☐ PROPOSED LIGHT PROPOSED MANHOLE

PROPOSED POLE PROPOSED END SECTION 100.00 PROPOSED ELEVATION TW TOP OF WALK TS BOTTOM OF CURB

TP TOP OF PAVEMENT

BC BOTTOM OF CURB

PROPOSED ELECTRIC

roposed telephone

- PROPOSED CONTOUR

EXISTING LEGEND

MI. REG. #22436

WATER METER

C CABLE PED.

T PHONE PED.

E ELEC. PED.

MAILBOX

(M) MEASURED DISTANCE

(R) RECORD DISTANCE

GAS METER

(W) WATER MANHOLE

T PHONE VAULT

ANY INFORMATION ON THIS DRAWING IS NOT INTENDED TO BE SUITABLE FOR REUSE

BY ANY PERSON, FIRM OR CORPORATION OR ANY OTHERS ON EXTENSION OF THIS PROJECT OR FOR ANY USE ON ANY OTHER PROJECT. ANY REUSE WITHOUT WRITTEN

VERIFICATION AND ADOPTION BY THE ENGINEER, ARCHITECT OR SURVEYOR FOR THE

SPECIFIC PURPOSE INTENDED WILL BE AT THE USERS SOLE RISK AND WITHOUT LIABILITY

SPOT ELEVATION

_____ EX. ELEVATION

— → CHAIN LINK FENCE

----- UGE ------ ELECTRIC

_____ CTV _____ CTV ____ CABLE TV

——— ——— SANITARY LINE

— — *— *— — WIRE FENCE

———— WOOD FENCE

■ ELEC. VAULT

TC TOP OF CURB

— W — PROPOSED WATER

ALL UNDERGROUND UTILITIES MUST BE FIELD VERIFIED BY THE

EBUSH BUSH

BOLLARD/POLE

₩ LIGHT POLE

Ø UTILITY POLE

(— GUY ANCHOR

TIRE HYDRANT

☐ CURB INLET


STORM MANHOLE

CLEAN—OUT

ਰ SIGN

O WELL

▼ VALVE

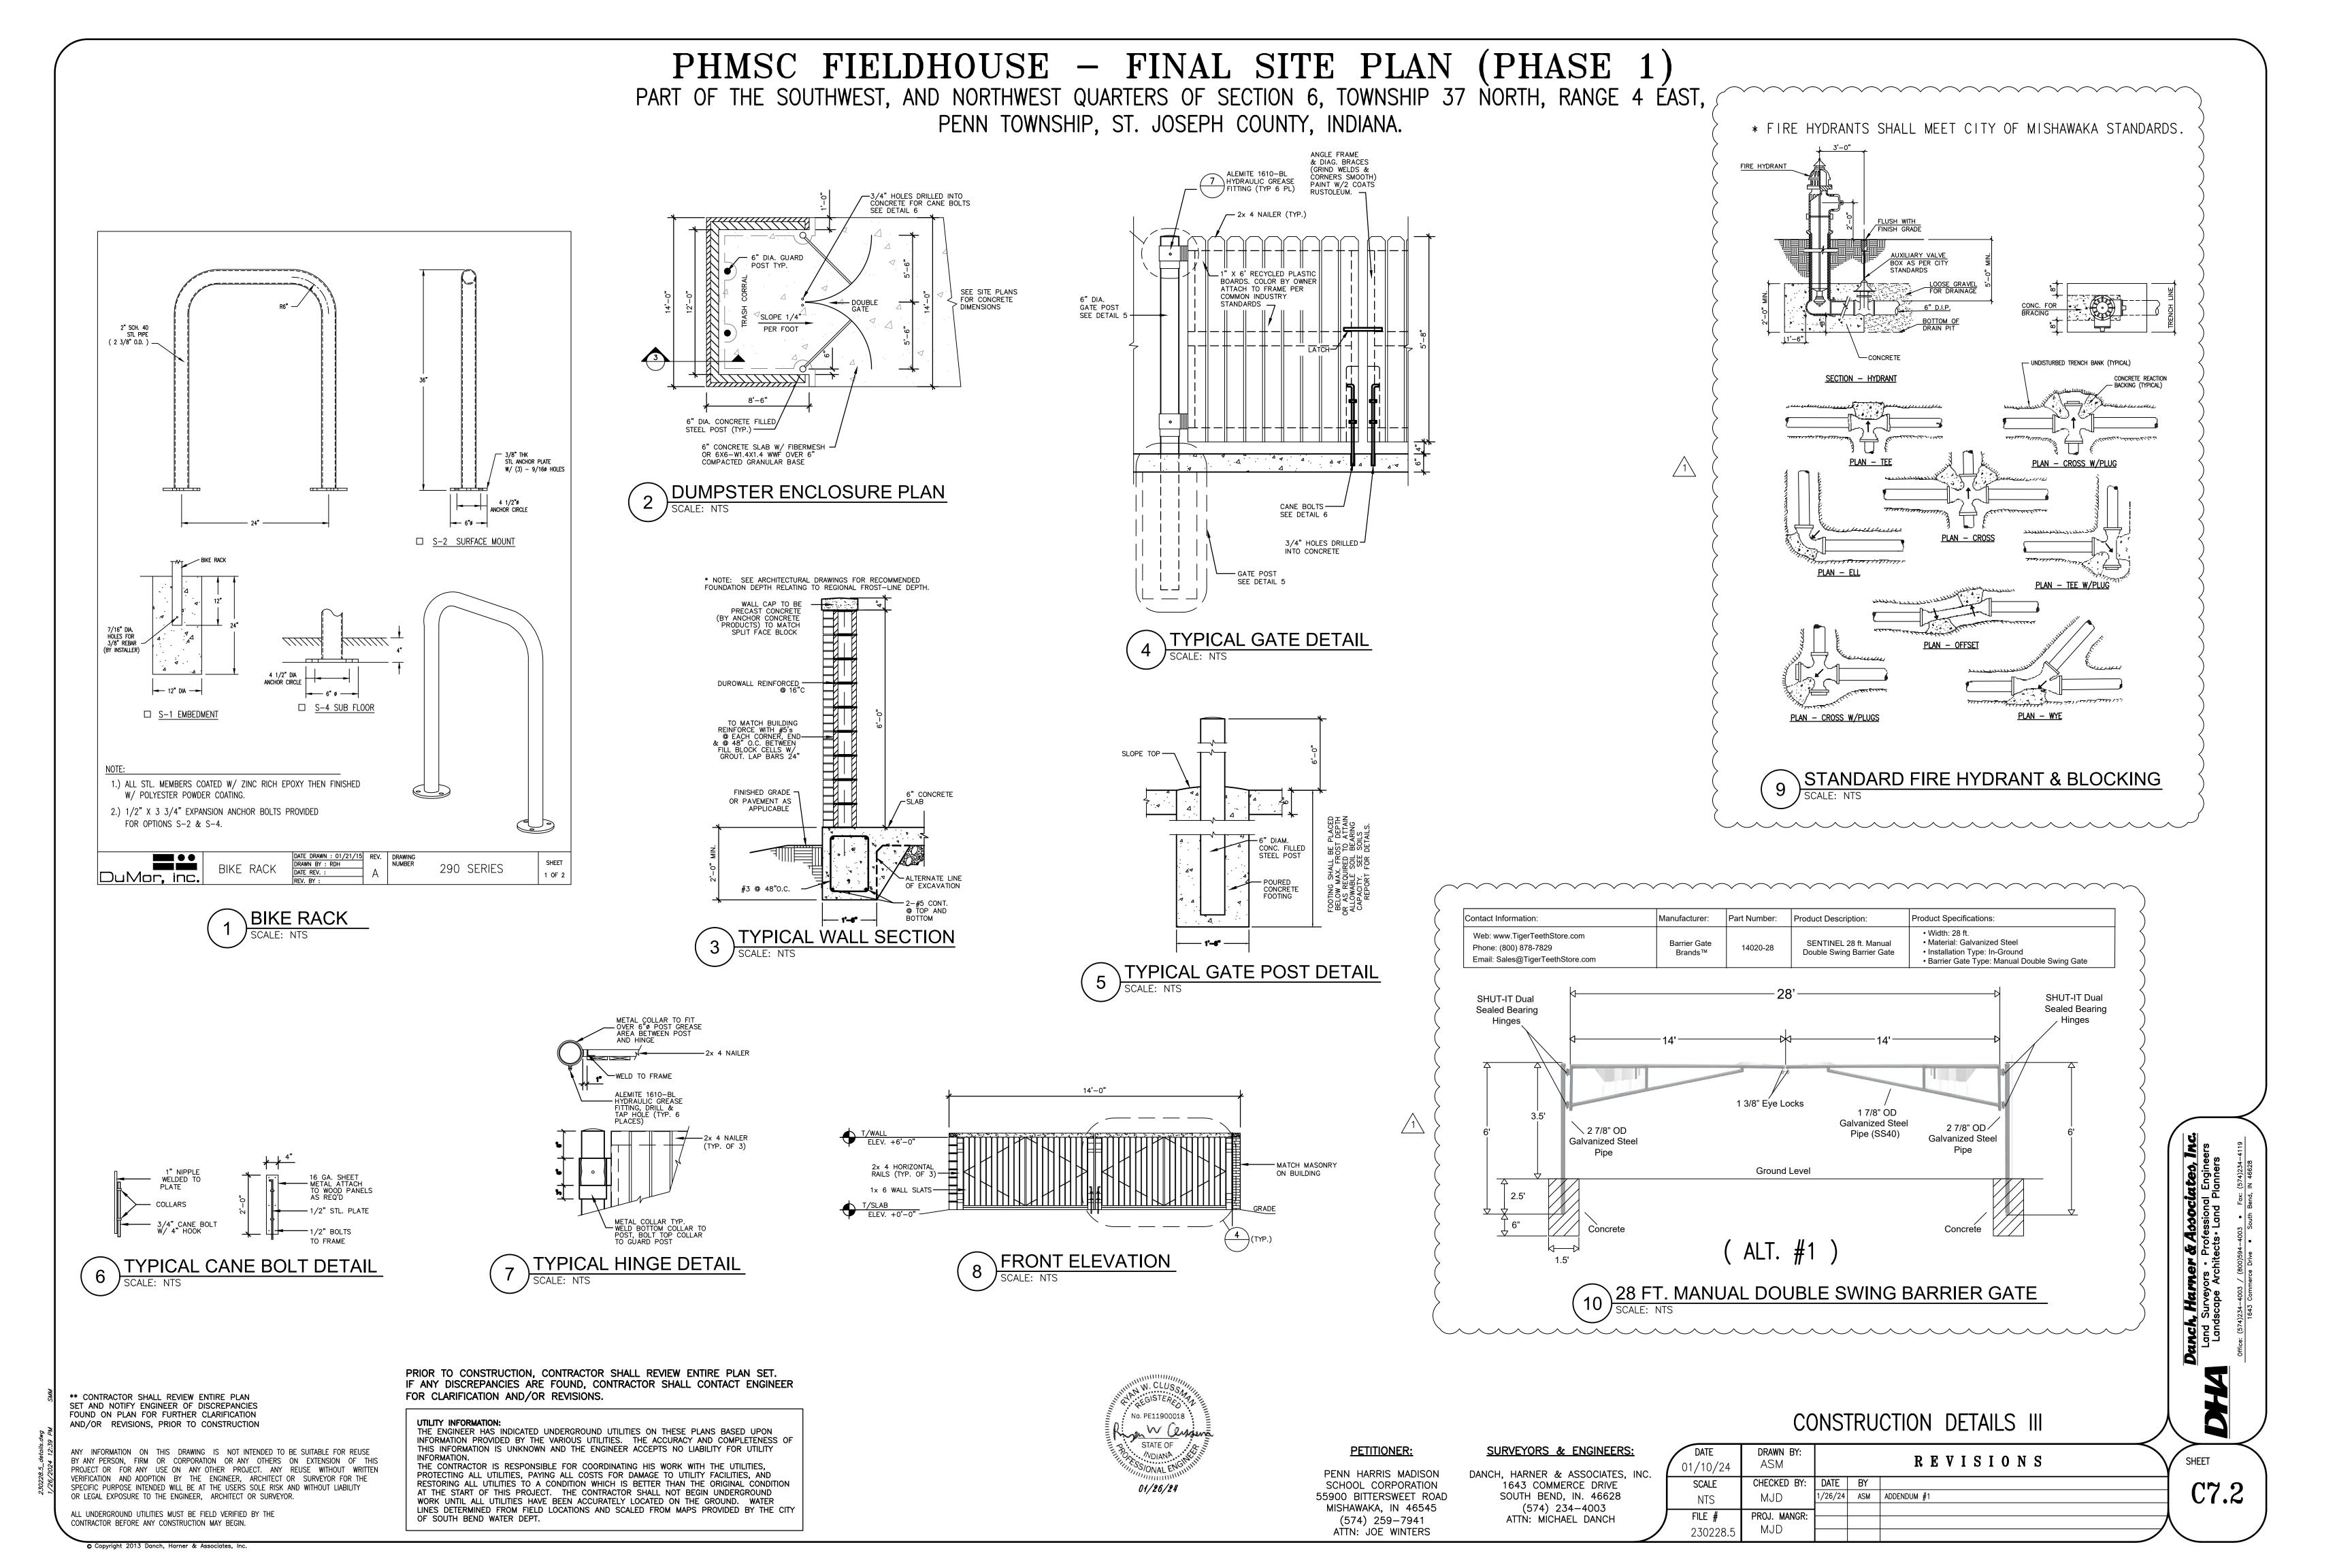

PART OF THE SOUTHWEST, AND NORTHWEST QUARTERS OF SECTION 6, TOWNSHIP 37 NORTH, RANGE 4 ÉAST, PENN TOWNSHIP, ST. JOSEPH COUNTY, INDIANA.

MISHAWAKA REQUIREMENTS AND NOTES:

CITY REQUIREMENTS SHALL TAKE PRECEDENCE OVER ANY OTHER GENERAL REQUIREMENTS ON THIS SHEET

<u>DEFINITIONS AND GENERAL PROCEDURES</u>

1. THE CITY OF MISHAWAKA ENGINEERING STANDARDS SHALL CONSIST OF THE CITY OF MISHAWAKA ENGINEERING STANDARDS (DRAWINGS). THE CURRENT ISSUE OF THE INDIANA DEPARTMENT OF TRANSPORTATION STANDARD SPECIFICATIONS, THE CURRENT ISSUE OF THE INDIANA DEPARTMENT OF TRANSPORTATION'S STANDARD DRAWINGS, AND THE CURRENT ISSUE OF THE INDIANA MANUAL ON UNIFORM TRAFFIC CONTROL DEVICES FOR STREETS AND HIGHWAYS. IN THE EVENT OF ANY CONFLICT BETWEEN THE CITY OF MISHAWAKA ENGINEERING STANDARDS AND ANY OTHER DOCUMENTS, THE CITY OF MISHAWAKA ENGINEERING STANDARDS SHALL PREVAIL.

2. CITY. THE CITY OF MISHAWAKA.

- 3. I.N.D.O.T. THE INDIANA DEPARTMENT OF TRANSPORTATION.
- 4. I.M.U.T.C.D. THE INDIANA MANUAL ON UNIFORM TRAFFIC CONTROL DEVICES FOR STREETS AND
- 5. STANDARDS. THE CITY OF MISHAWAKA ENGINEERING STANDARDS.
- 6. "AS-BUILT DRAWINGS" WILL BE REQUIRED ON ALL IMPROVEMENTS WHICH ARE TO BE DEDICATED TO, AND ACCEPTED BY, THE CITY FOR INCLUSION IN THE PUBLIC INFRASTRUCTURE; OR WILL IN ANY WAY IMPACT ANY PART OF THE EXISTING PUBLIC INFRASTRUCTURE. 7. A MAINTENANCE BOND, IN THE AMOUNT OF 10
- OF 3 YEARS, FROM THE DATE OF ACCEPTANCE OF SUCH IMPROVEMENTS, MUST BE PROVIDED BY THE CONTRACTOR FOR ANY IMPROVEMENTS THAT ARE TO BE ACCEPTED BY THE CITY.
- 1. PERMIT FEES ARE AS SET FORTH IN THE CURRENT CITY CODE OF ORDINANCES.
- 2. OBTAINING AND PROTECTING UTILITY LOCATIONS ARE THE SOLE RESPONSIBILITY OF THE 3. ONLY LICENSED AND BONDED CONTRACTORS (BONDED WITH THE CITY ENGINEER'S OFFICE)
- SHALL BE ALLOWED TO PERFORM ANY EXCAVATION, OR OTHER WORK, IN THE PUBLIC RIGHTS-OF-WAY OF THE CITY 4. AN "EXCAVATION PERMIT" SHALL BE OBTAINED FROM THE OFFICE OF THE CITY ENGINEER'S OFFICE PRIOR TO ANY TYPE OF EXCAVATION IN ANY STREET OR RIGHT-OF-WAY. A DRAWING INDICATING ALL PERTINENT INFORMATION REGARDING THE EXCAVATION (LOCATION, PURPOSE
- NEEDS TO BE SUBMITTED TO OBTAIN SUCH PERMIT. 5. NUMEROUS ARTERIAL STREETS IN THE CITY ARE DESIGNATED AS "HIGH VOLUME STREETS" AND REQUIRE A "HIGH VOLUME STREET CUT PERMIT". DETAILED DRAWINGS, AS IN ITEM #4, ABOVE, MUST BE SUBMITTED, WITH PARTICULARLY CLOSE ATTENTION TO TRAFFIC SAFETY AND MAINTENANCE, TO OBTAIN THIS PERMIT. THREE (3) WORKING DAYS ARE TO BE ALLOWED FOR

WIDTH, LENGTH, DEPTH, BARRICADES, TRAFFIC MAINTENANCE PLAN, DURATION OF WORK, ETC.)

- THE PROCESSING OF THIS PERMIT. 6. ANY WORK ON A STATE HIGHWAY, OR WITHIN STATE RIGHTS-OF-WAY, REQUIRES A PERMIT FROM THE INDIANA DEPARTMENT OF TRANSPORTATION PERMITS DEPARTMENT OF THE LAPORTE DISTRICT OFFICE. PLEASE CALL (219) 362-6125 FOR MORE INFORMATION
- 7. THE CONSTRUCTION OF ANY DRIVEWAY, CONNECTING WITH ANY CITY STREET, REQUIRES A DRIVEWAY PERMIT FROM THE CITY ENGINEER'S OFFICE. A DETAILED DRAWING INDICATING LOCATION OF THE DRIVEWAY (DISTANCE FROM ANY INTERSECTION AND EXISTING DRIVEWAYS, ADJACENT AND OPPOSITE) TAPERS OR RADII AND ANY OTHER INFORMATION NECESSARY TO PROPERLY SHOW THE PROPOSED WORK IS TO BE INCLUDED ON THE DRAWING AND BECOME PART OF THE PERMIT.

EXCAVATION

1. EMERGENCY EXCAVATION THE CITY ENGINEER'S OFFICE IS TO BE NOTIFIED AS SOON AS POSSIBLE IN THE EVENT OF ANY EMERGENCY EXCAVATION, FOLLOWED BY A PERMIT APPLICATION.

2. INITIAL EXCAVATION

- A. THE CONTRACTOR IS RESPONSIBLE FOR THE PLACEMENT OF ALL SAFETY LIGHTING, BARRICADES AND WARNING SIGNS. B. INITIAL ACCESS HOLE SHALL BE CUT ONLY AS LARGE AS REQUIRED TO PERFORM WORK.
- PAVED STREET PATCHING 1. TEMPORARY PATCH
- A. IF CONDITIONS DO NOT ALLOW THE PLACEMENT OF A PERMANENT CONCRETE PATCH, A TEMPORARY ASPHALT PATCH SHALL BE ALLOWED. TEMPORARY PATCHES SHALL BE A MINIMUM DEPTH OF 4" FOR LOCAL AND COLLECTOR STREETS AND A MINIMUM DEPTH OF 8" FOR ARTERIAL
- B. WHEN A TEMPORARY PATCH IS TO BE IN PLACE FOR MORE THAN 12 HOURS THE PERMITTEE SHALL FURNISH THE CITY ENGINEER'S OFFICE WITH THE NAME AND PHONE NUMBER OF THE PARTY RESPONSIBLE FOR AFTER HOURS MAINTENANCE.

2. WEATHER LIMITATIONS

- A. UNLESS SPECIAL PERMISSION IS OBTAINED, NO PERMANENT PATCHES SHALL BE PLACED BETWEEN OCTOBER 1ST AND MAY 1ST. DURING THESE PERIODS A DURABLE TEMPORARY PATCH
- SHALL BE PLACED IN THE ORIGINAL ACCESS HOLE. B. THE MAINTENANCE OF THIS TEMPORARY PATCH SHALL BE THE SOLE RESPONSIBILITY OF THE PERMITTEE. THE PERMITTEE SHALL PROVIDE THE CITY ENGINEER'S OFFICE WITH THE NAME AND TELEPHONE NUMBER OF THE PARTY RESPONSIBLE FOR THE MAINTENANCE OF THE PATCH.
- 3. PERMANENT PATCH INSTALLATION SEE DETAIL, SHEETS IV-2 AND IV-3, OF THESE

<u>PAVEMENT</u> 1. MATERIALS

- A. ALL MATERIALS ARE TO BE IN ACCORDANCE WITH THE CURRENT INDIANA DEPARTMENT OF TRANSPORTATION STANDARDS SPECIFICATIONS.
- B. CLASS "A" CONCRETE (BECAUSE OF ITS FREQUENT USE, IS DEFINED HERE) SHALL HAVE 6 SACKS (94 LB.) OF CEMENT PER CUBIC YARD OF CONCRETE AND 6 GALLONS OF WATER, MAXIMUM, PER SACK OF CONCRETE. FLY ASH MAY BE USED IN CONCRETE MIX IN ACCORDANCE WITH SECTIONS 702.05 AND 901.02 OF THE INDIANA DEPARTMENT OF TRANSPORTATION 1993
- 2. PAVEMENT JOINTS SHALL BE IN ACCORDANCE WITH THE CURRENT INDIANA DEPARTMENT OF TRANSPORTATION STANDARD SPECIFICATIONS.

SEWERS AND ASSOCIATED APPURTENANCES

THE OFFICE OF THE CITY ENGINEER.

- 1. A PERMANENT VIDEO RECORDING, OF ANY SANITARY SEWER CONSTRUCTED IN THE CITY IF REQUIRED, IS TO BE PROVIDED TO THE CITY ENGINEER'S OFFICE UPON COMPLETION OF THE WORK. THE VIDEO SHALL BE PROVIDED IN A FORMAT ACCEPTABLE TO THE CITY.
- 2. "AS-BUILT" DRAWINGS, SIGNED AND SEALED BY A LICENSED PROFESSIONAL ENGINEER, OF ANY SEWER CONSTRUCTION, SANITARY OR STORM SHALL BE PROVIDED TO THE CITY ENGINEER'S OFFICE UPON COMPLETION OF AND PRIOR TO THE CITY'S ACCEPTANCE OF THE PROJECT. THE "AS-BUILT" DRAWINGS SHALL, AT THE VERY LEAST, INCLUDE U.S.G.S. INVERT AND CASTING ELEVATIONS, LINE SLOPE, LOCATIONS OF THE TAPS (FROM DOWNSTREAM MANHOLE) LENGTH OF TAP FROM MAIN AND TAP ELEVATION AT THE PROPERTY LINE & OFFSETS IF NECESSARY.
- 3. THE CITY ENGINEER'S OFFICE SHALL BE NOTIFIED AT LEAST 24 HOURS IN ADVANCE OF ANY TESTING, IN ORDER TO BE ABLE TO WITNESS THE TESTS. TEST FOR SANITARY SEWERS SHALL
- INCLUDE BUT NOT BE LIMITED TO INFILTRATION, EXFILTRATION AND DEFLECTION. 4. INFILTRATION/EXFILTRATION TESTS ARE TO BE SIGNED AND SEALED BY A LICENSED
- PROFESSIONAL ENGINEER OR SURVEYOR. 5. MAXIMUM ALLOWABLE INFILTRATION RATE IS 100 GALLONS PER INCH DIAMETER PER MILE OF SEWER PER DAY. MANHOLES, IF TESTED SEPARATELY, SHALL HAVE A MAXIMUM ALLOWABLE
- INFILTRATION RATE OF 0.1 GALLONS PER HOUR PER FOOT OF DIAMETER PER FOOT OF HEAD. 6. ALL FLEXIBLE SEWER PIPING SHALL BE SUBJECT TO DEFLECTION TESTING. THE MAXIMUM ACCEPTABLE PIPE DEFLECTION AFTER INSTALLATION IS FIVE PERCENT (5 DIAMETER. THE PIPE WILL BE TESTED BY THE CONTRACTOR 30 DAYS OR GREATER AFTER THE INSTALLATION AND SHALL BE TESTED WITH A 9 POINT MANDREL FOR MAXIMUM DEFLECTION. A COPY OF THE TEST RESULTS, CERTIFIED BY A PROFESSIONAL ENGINEER SHALL BE SUBMITTED TO
- 7. ALL SANITARY PIPING SHALL BE SUBJECT TO A LOW PRESSURE AIR TESTING. VITRIFIED CLAY PIPE (VCP) AND DUCTILE IRON PIPE SHALL BE TESTED IN ACCORDANCE WITH ASTM C 828-86. PLASTIC PIPING SHALL BE TESTED IN ACCORDANCE WITH THE UNI-BELL PLASTIC PIPE ASSOCIATION - UNI-B-6-79. COPIES OF THIS PROCEDURE MAY BE OBTAINED FROM UNI-BELL 2655 VILLA CREEK DRIVE, SUITE 150, DALLAS, TEXAS 75234. A COPY OF THE TEST RESULTS CERTIFIED BY A PROFESSIONAL ENGINEER SHALL BE SUBMITTED TO THE OFFICE OF THE CITY ENGINEER.
- 1. THE DEVELOPER IS RESPONSIBLE FOR PAYMENT TO THE CITY OF MISHAWAKA PRIOR TO THE INSTALLATION OF ALL TRAFFIC CONTROL SIGNING AND STREET NAME SIGNS ON ALL STREETS TO BE DEDICATED TO THE CITY. ALL TRAFFIC CONTROL DEVICES ARE TO BE IN CONFORMANCE WITH THE I.M.U.T.C.D.
- 2. THE CONTRACTOR IS RESPONSIBLE FOR PROPER TRAFFIC CONTROL AND WARNING SIGNING AND DEVICES AS REQUIRED BY THE I.M.U.T.C.D. FOR THE DURATION OF CONSTRUCTION ON ANY PUBLIC STREET. FAILURE TO DO SO WILL RESULT IN THE CITY PROVIDING THE NECESSARY

UTILITY NOTES:

MATERIAL REQUIREMENTS: SANITARY SEWER, STORM SEWER, AND WATER LINES

- 1. ALL WATER PIPE 2" AND SMALLER SHALL BE TYPE 'K' COPPER
- 2. ALL WATER PIPE 2 1/2" AND LARGER SHALL BE CLASS 52 DUCTILE IRON. 3. ALL STORM SEWERS SHALL BE TESTED FOR LEAKAGE IN ACCORDANCE WITH CITY STANDARDS
- PRIOR TO ACCEPTANCE BY THE OWNER THE ENGINEER SHALL WITNESS THE TESTS. COPIES OF THE TEST RESULTS SHALL BE FURNISHED TO THE OWNER, THE CITY AND THE ENGINEER. 4. ALL STORM SEWER SHALL BE CLASS III RCP OR HDPE DOUBLE WALL.
- 5. ALL SANITARY SEWER SHALL BE ESVCP (ASTM C700), OR SDR 35 PVC (ASTM D3034) ESVCP JOINTS SHALL CONFORM TO ASTM C425. PVC PIPE JOINTS SHALL CONFORM TO
- 6. ALL MANHOLES SHALL BE REINFORCED CONCRETE PRECAST (ASTM C478).

BACKFLOW / CROSS CONNECTION REQUIREMENTS:

3. USE PVB ON LAWN SPRINKLER LINES.

- . USE RPZ ON DOMESTIC LINES, INSIDE BUILDING. THE RPZ SHALL BE MOUNTED IN A HORIZONTAL ORIENTATION.
- 2. USE DDCV ON FIRE LINES. THE DDCV SHALL BE LISTED ON THE USC APPROVED LIST. MOUNT IN APPROVED ORIENTATION.

SANITARY SEWER, STORM SEWER, AND WATER LINES GENERAL NOTES:

- 1. ALL LOCAL PERMITS SHALL BE OBTAINED BEFORE CONSTRUCTION IS BEGUN ON THIS PROJECT. 2. IF POLLUTION OR NUISANCE CONDITIONS ARE CREATED, IMMEDIATE CORRECTIVE ACTION SHALL BE TAKEN
- 3. SEWER TO WATER MAIN SEPARATION DISTANCES SHALL COMPLY WITH SECTION 38 OF THE RECOMMENDED STANDARDS
- FOR WASTEWATER FACILITIES, 1997 EDITION. SEE ITEM 8 BELOW. 4. ALL TRENCHES SHALL BE DEWATERED USING DEEP WELLS OR WELL POINTS PRIOR TO EXCAVATION. IF NEEDED, THE CONTRACTOR SHALL PROVIDE SHEETING, SHORING, BRACING AND/OR A TRENCH BOX, IN ACCORDANCE WITH LOCAL, STATE AND FEDERAL REGULATIONS, FOR ALL EXCAVATION WORK
- 5. MINIMUM COVER FOR WATER LINES IS 5.0 FT. 6. P.V.C. SANITARY SEWERS SHALL BE TESTED FOR DEFLECTION USING A MANDRELL WHICH IS 95% OF THE INSIDE DIAMETER OF THE PIPE. AS DEFINED IN THE APPLICABLE A.S.T.M. STANDARDS. ANY PIPE FAILING THE TEST SHALL BE RE-EXCAVATED AND REPLACED, SO THAT ALL COMPLETED PIPE PASSES A RETEST. THE DEFLECTION TEST SHALL BE PERFORMED NOT LESS THAN 30 DAYS AFTER BACKFILL OF THE TRENCHES. ALL OTHER DETAILS OF THE MANDRELL TEST SHALL BE IN ACCORDANCE WITH "TEN
- 7. ALL SANITARY SEWERS SHALL BE TESTED FOR INFILTRATION OR EXFILTRATION HYDROSTATICALLY, WITH A MINIMUM TESTING HEAD OF 2 FEET, TAKING INTO CONSIDERATION THE STATIC GROUNDWATER ELEVATION WITH RESPECT TO THE PIPE AT THE TIME OF THE TEST. THE MAXIMUM ALLOWABLE LEAKAGE SHALL BE 100 GALLONS PER DAY PER INCH DIAMETER PER MILE OF PIPE.
- 8. ALL SANITARY SEWERS LAID PARALLEL TO WATER MAINS SHALL BE SEPARATED AT LEAST 10 FEET, MEASURED EDGE TO EDGE, FROM SAID WATER MAINS. WHENEVER A SANITARY SEWER CROSSES A WATER MAIN, THE MINIMUM VERTICAL SEPARATION SHALL BE 18", ALL IN ACCORDANCE WITH IDEM REGULATIONS AND "TEN STATES STANDARDS".
- 9. THE RESULTS OF THE INFILTRATION/EXFILTRATION TEST ON THE COMPLETED SEWER SHALL BE SUBMITTED TO DANCH, HARNER & ASSOCIATES, INC. WITHIN THREE MONTHS OF COMPLETION OF CONSTRUCTION.
- 10. ALL NEW WATER LINES, INCLUDING NEW FIRE HYDRANT, SHALL BE DISINFECTED IN ACCORDANCE WITH CITY, STATE AND FEDERAL REGULATIONS. THE NEW LINES SHALL BE FLUSHED PRIOR TO DISINFECTION. COPIES OF ACCEPTABLE BACTERIAL TEST RESULTS SHALL BE FURNISHED TO THE OWNER, THE ENGINEER AND THE CITY PRIOR TO ACTIVATING THE NEW WATER PIPING.
- 11. ALL WATER LINES SHALL BE PRESSURE TESTED @ 150 PSI FOR 2 HOURS
- 12. ALL SANITARY SEWER MANHOLES SHALL BE INSPECTED AFTER COMPLETION FOR GENERAL CONDITION, CRACKS, LEAKAGE OF GROUNDWATER OR OTHER DEFECTS. IF PORTIONS OF THE MANHOLES ARE ANTICIPATED TO BE EXPOSED TO STATIC GROUNDWATER AFTER COMPLETION, THE MANHOLE SHALL BE TESTED FOR WATER TIGHTNESS IN ACCORDANCE WITH THE APPLICABLE PROVISIONS OF TEN STATES STANDARDS, LATEST EDITION, AND IDEM REGULATIONS
- 13. NO ROOF DRAINS, FOOTING DRAINS AND/OR SURFACE WATER DRAINS MAY BE CONNECTED TO THE SANITARY SEWER SYSTEM INCLUDING TEMPORARY CONNECTIONS DURING CONSTRUCTION.
- 14. SANITARY FEATURES SHALL COMPLY WITH ANY ADDITIONAL REQUIREMENTS OF THE ST. JOSEPH COUNTY HEALTH DEPARTMENT, AND/OR THE CITY OF MISHAWAKA.

PHONE, GAS, ELECTRIC, CATV UTILITY AND IRRIGATION SLEEVE NOTES:

- 1. CONTRACTOR IS TO UNCOVER AND CONFIRM ALL TAP LOCATIONS. IF DISCREPANCIES EXIST, NOTIFY ENGINEER PRIOR TO COMMENCING WORK. 2. CONTRACTOR IS TO COORDINATE ALL UTILITY CONNECTIONS WITH THE APPROPRIATE
- UTILITY COMPANIES. 3. ROUTINGS SHOWN ARE APPROXIMATE. 4. CONTRACTOR IS TO COORDINATE AND ASSURE THAT ANY REQUIRED IRRIGATION SLEEVES
- ARE PLACED PRIOR TO PAVING. 5. TELEPHONE, ELECTRIC AND TV ROUTINGS ARE TO BE COORDINATED WITH THE APPROPRIATE UTILITIES. CONTRACTOR IS TO PROVIDE CONDUIT UNDER PAVED AREAS
- AS REQUIRED BY THE APPROPRIATE UTILITY 6. GRANULAR BACKFILL MATERIAL IS REQUIRED IN ALL UTILITY TRENCHES LOCATED UNDER PAVEMENT OR SIDEWALKS. BACKFILL SHALL BE COMPACTED TO 100% OF STANDARD PROCTOR DENSITY PER SOILS REPORT.

UTILITY INFORMATION:

THE ENGINEER HAS INDICATED UNDERGROUND UTILITIES ON THESE PLANS BASED UPON INFORMATION PROVIDED BY THE VARIOUS UTILITIES. THE ACCURACY AND COMPLETENESS OF THIS INFORMATION IS UNKNOWN AND THE ENGINEER ACCEPTS NO LIABILITY FOR UTILITY INFORMATION. THE CONTRACTOR IS RESPONSIBLE FOR COORDINATING HIS WORK WITH THE UTILITIES. PROTECTING ALL UTILITIES. PAYING ALL COSTS FOR DAMAGE TO UTILITY FACILITIES, AND RESTORING ALL UTILITIES TO A CONDITION WHICH IS BETTER THAN THE ORIGINAL CONDITION AT THE START OF THIS PROJECT. THE CONTRACTOR SHALL NOT BEGIN UNDERGROUND WORK UNTIL ALL UTILITIES HAVE BEEN ACCURATELY

EROSION CONTROL NOTES:

EROSION CONTROL:

EROSION NOTE: GENERAL CONTRACTOR IS RESPONSIBLE FOR ASSURING COMPLIANCE WITH ALL LOCAL AND STATE REQUIREMENTS FOR EROSION CONTROL. PRIMARY RESPONSIBILITY FOR MAINTENANCE OF THE EROSION CONTROL PROTECTION WILL REMAIN WITH THE GENERAL CONTRACTOR. GENERAL CONTRACTOR WILL ALSO BE REQUIRED TO CLEAN OUT ALL DRAINAGE STRUCTURES IMMEDIATELY PRIOR TO PROJECT TURNOVER.

1. LAND DISTURBANCE WHICH REMOVES VEGETATION SHALL BE DONE IN A WAY THAT WILL

EXPOSED AREAS DURING SITE DEVELOPMENT IF A DISTURBED AREA IS TO REMAIN

INACTIVE FOR A PERIOD EXCEEDING 14 DAYS, TEMPORARY RYE GRASS SEEDING WILL

- MINIMIZE EROSION. 2. THE DURATION OF TIME WHICH AN AREA REMAINS EXPOSED SHALL BE KEPT TO A PRACTICAL MINIMUM. THE AREA SHALL BE STABILIZED AS QUICKLY AS PRACTICAL TEMPORARY VEGETATION OR MULCHING SHALL BE USED WHERE REQUIRED TO PROTECT
- BE PLACED TO PROVIDE VEGETATION. 4. PERMANENT AND FINAL VEGETATION SHALL BE INSTALLED AS SOON AS PRACTICAL. 5. STRAW BALE CHECK DAMS AND SILT FENCING SHALL BE PLACED AROUND ANY SOIL STOCKPILE THAT BECOMES INACTIVE FOR A PERIOD OF TIME EXCEEDING 15 DAYS.

GRADING, DRAINAGE & PAVING NOTES:

PAVING, STRIPING & CURB NOTES

- 1. WORKMANSHIP AND MATERIALS FOR ALL PAVING TO CONFORM TO STATE AND LOCAL STANDARD DRAWINGS AND SPECIFICATIONS, LATEST EDITION. 2. PARKING LOT SUBGRADE SHALL BE FINE GRADED TO ASSURE POSITIVE DRAINAGE AWAY
- FROM THE BUILDING AND TOWARDS THE COLLECTION LOCATIONS. 3. ALL ASPHALT PAVING SHALL BE LAID ON A STRAIGHT, EVEN, AND UNIFORM GRADE WITH A MINIMUM 1% AND MAXIMUM 3% SLOPE TOWARDS THE COLLECTION POINTS. DO
- NOT ALLOW NEGATIVE GRADES OR PONDING OF WATER 4. SLOPE BUILDING SIDEWALKS AWAY FROM BUILDING AT 1%.
- 5. PAVED AREAS ARE TO BE ROUGH GRADED TO +/- 0.10 FT. AND PROOF ROLLED. ANY NON-ACCEPTABLE AREAS MUST BE CORRECTED PRIOR TO THE PLACEMENT OF STONE.
- 6. EXPANSION JOINTS 1/2" ASPHALT IMPREGNATED FULL DEPTH, 40 FT. O.C. MAXIMUM AND AT SIDEWALK INTERSECTIONS. CRACK CONTROL SCORING AT SIDEWALK WIDTH DIMENSION, OR AS NOTED ON THE PLANS.
- 7. STRIPING OF PARKING STALLS AND OTHER AREAS TO BE AS SHOWN ON THE PLANS. ALL LINES TO BE SINGLE STRIPE, YELLOW, 4" WIDE, STRAIGHT, EVENLY SPACED, AND UNIFORM IN LENGTH.
- 8. HANDICAP PARKING AND RAMP SHALL COMPLY WITH ALL GOVERNMENTAL CODES AND STANDARDS. HANDICAP SPACES TO BE MARKED WITH THE INTERNATIONAL HANDICAP SYMBOL IN A BLUE FIELD. EACH SPACE SHALL BE ADDITIONALLY MARKED WITH
- 9. REFER TO THE PROJECT DETAIL SHEET FOR PAVING DIMENSIONS, COURSES AND THICKNESSES.

OFFSITE CONSTRUCTION NOTES

- ALL WORK TO COMPLY WITH LOCAL AND STATE CODES & STANDARDS OF CONSTRUCTION 2. THE CONTRACTOR IS RESPONSIBLE FOR EXAMINING ALL SITE CONDITIONS PRIOR TO
- THE START OF CONSTRUCTION.
- 3. THE CONTRACTOR SHALL COORDINATE THE WATER AND SEWER WORK IN THE RIGHT OF WAY WITH ALL APPROPRIATE AGENCIES.
- 4. RIGHT OF WAY DRAINAGE PATTERNS SHALL ALSO BE MAINTAINED. 5. ANY AREAS DISTURBED ARE TO BE REPAIRED TO A CONDITION EQUAL TO OR BETTER
- THAN EXISTED PRIOR TO DISTURBANCE 6. CONTRACTOR TO INSTALL IMPROVEMENTS SHOWN AND TO COORDINATE WITH THE APPROPRIATE GOVERNMENTAL AGENCY FOR CLARIFICATION AND ANY NECESSARY

SITE GRADING

- STRIP BUILDING AND PAVING AREAS OF ALL ORGANIC TOPSOIL MATERIALS. STOCKPILE SUITABLE TOPSOILS FOR RESPREADING ONTO LANDSCAPE AREAS. ALL EXCESS EXCAVATED MATERIALS SHALL BE REMOVED FROM THE SITE AT
- THE CONTRACTORS EXPENSE. 2. ALL SOILS SHALL BE GRADED TO PROVIDE SMOOTH CONTOURS AND POSITIVE DRAINAGE AWAY FROM BUILDINGS. DO NOT ALLOW FOR PONDING OF WATER.
- AFTER TOPSOIL REMOVAL, CONTRACTOR IS TO PROOF ROLL THE BUILDING AND PAVING AREAS. ANY NON-ACCEPTABLE AREAS MUST BE CORRECTED PRIOR TO BEGINNING ANY
- FILL OPERATIONS. AFTER COMPLETION OF PROOF ROLLING, FILL CAN BE PLACED USING SUITABLE ON-SITE OR BORROW MATERIALS IN MAXIMUM 8" LIFTS. FILL TO BE COMPACTED
- TO 100% STANDARD PROCTOR DENSITY. PAVED AREAS ARE TO BE ROUGH GRADED TO +/- 0.10 FT. AND PROOF ROLLED. ANY NON-ACCEPTABLE AREAS MUST BE CORRECTED PRIOR TO THE PLACEMENT OF STONE.
- 6. PARKING LOT SHALL BE GRADED TO ASSURE POSITIVE DRAINAGE AND NO PONDING CURBS TO BE WHERE SHOWN ON THE PLAN AND INTEGRAL WITH SIDEWALK AT PAVING EDGE, AS APPROPRIATE.

- ALL WORK TO COMPLY WITH APPLICABLE CITY OF MISHAWAKA CONSTRUCTION STANDARDS. PARKING AREAS SHALL BE GRADED TO ASSURE POSITIVE FLOW AWAY FROM THE
- BUILDING. NO PONDING OF WATER IS TO BE ALLOWED. CONTRACTOR IS TO CONFIRM ALL UTILITY LOCATIONS. IF DISCREPANCIES
- EXIST, NOTIFY ENGINEER PRIOR TO COMMENCING WORK. 4. GRANULAR BACKFILL MATERIAL IS REQUIRED IN ALL PIPE TRENCHES LOCATED
- UNDER PAVEMENT OR SIDEWALKS. BACKFILL SHALL BE COMPACTED TO 100% STANDARD . REFER TO STANDARD DETAILS FOR SPECIFICATIONS FOR PRECAST DRYWELLS. PIPE TRENCHING AND BACKFILL, FRENCH DRAIN TRENCH DETAILS AND MATERIALS, INLETS, AND CASTING

GENERAL NOTES

- ALL WORK TO COMPLY WITH LOCAL AND STATE CODES & STANDARDS OF CONSTRUCTION
- 2. ĂLL ŤESŤINĞ RĚQUÍRED BY GOVERŇMEŇTAL AŬTHORITIES IS TO BE PERFORMED BY THÉ OWNER'S TESTING AGENCY. THE CONTRACTOR IS RESPONSIBLE FOR VERIFYING ALL QUANTITIES. QUANTITIES
- GIVEN ARE APPROXIMATE AND MUST BE VERIFIED. ANY DISCREPANCIES ARE TO BE REPORTED TO THE ENGINEER.
- 4. THE CONTRACTOR IS RESPONSIBLE FOR EXAMINING ALL SITE CONDITIONS PRIOR TO THE START OF CONSTRUCTION.
- 5. THE CONTRACTOR IS RESPONSIBLE FOR PROVIDING THE OWNER WITH TWO COPIES OF 'RED LINED" AS-BUILT PLANS OF THE DESIGNATED IMPROVEMENTS. 6. CONTRACTOR IS TO VERIFY ALL DIMENSIONS AND ELEVATIONS PRIOR TO THE START OF THE WORK AND BRING ANY DISCREPANCIES TO THE ATTENTION OF THE ENGINEER FOR RESOLUTION. PLANS INDICATE APPROXIMATE ELEVATIONS AND ROUTING. THE
- DISCREPANCIES WHICH HAVE NOT BEEN BROUGHT TO HIS ATTENTION PRIOR TO CONSTRUCTION. 7. CONTRACTOR TO LOCATE ALL UNDERGROUND UTILITIES ON THE SITE AND RIGHT OF WAY PRIOR TO STARTING WORK AND SHALL CONDUCT HIS OPERATIONS IN SUCH A MANNER AS TO ENSURE THAT THOSE UTILITIES WILL NOT BE DAMAGED OR DISTURBED.

ENGINEER SHALL NOT BE RESPONSIBLE FOR ANY DIMENSIONAL OR ELEVATION

- CONTRACTOR SHALL ALSO CONTACT ALL APPROPRIATE UTILITY COMPANIES, INCLUDING MUNICIPAL UTILITIES, TO COORDINATE ALL UTILITY INSTALLATIONS 8. CONTRACTOR IS TO COMPLY WITH RECOMMENDATIONS MADE IN THE GEOTECHNICAL
- 9. DETAILS AND SPECIFICATIONS SHOWN ON THIS PLAN ARE INTENDED TO COMPLEMENT THE PROJECT PLANS AND STANDARD DETAILS. IN CASES OF CONFLICTS BETWEEN THESE PLANS AND OTHER SPECIFICATIONS, THE MORE RESTRICTIVE CASE
- APPLIES, UNLESS SPECIFICALLY OVERRIDDEN. 10. THESE TECHNICAL SPECIFICATIONS ARE INTENDED TO COMPLEMENT AND COORDINATE WITH THE REQUIREMENTS CONTAINED IN THE PROJECT MANUAL. IN THE CASE OF CONFLICTING REQUIREMENTS, THE MOST RESTRICTIVE SPECIFICATION SHALL BE ENFORCED. REFER ALSO TO THE CITY OF MISHAWAKA SPECIFICATIONS AND RELATED DOCUMENTS WHICH ARE CONTAINED HEREIN BY REFERENCE.



SHEET

CONSTRUCTION SPECIFICATIONS

DRAWN BY: REVISIONS 01/10/24 CHECKED BY: | DATE | BY SCALE 1/26/24 ASM ADDENDUM #1 FILE # PROJ. MANGR:

** CONTRACTOR SHALL REVIEW ENTIRE PLAN SET AND NOTIFY ENGINEER OF DISCREPANCIES FOUND ON PLAN FOR FURTHER CLARIFICATION AND/OR REVISIONS, PRIOR TO CONSTRUCTION

ANY INFORMATION ON THIS DRAWING IS NOT INTENDED TO BE SUITABLE FOR REUSE BY ANY PERSON, FIRM OR CORPORATION OR ANY OTHERS ON EXTENSION OF THIS PROJECT OR FOR ANY USE ON ANY OTHER PROJECT. ANY REUSE WITHOUT WRITTEN VERIFICATION AND ADOPTION BY THE ENGINEER, ARCHITECT OR SURVEYOR FOR THE SPECIFIC PURPOSE INTENDED WILL BE AT THE USERS SOLE RISK AND WITHOUT LIABILITY

ALL UNDERGROUND UTILITIES MUST BE FIELD VERIFIED BY THE CONTRACTOR BEFORE ANY CONSTRUCTION MAY BEGIN.

OR LEGAL EXPOSURE TO THE ENGINEER. ARCHITECT OR SURVEYOR.

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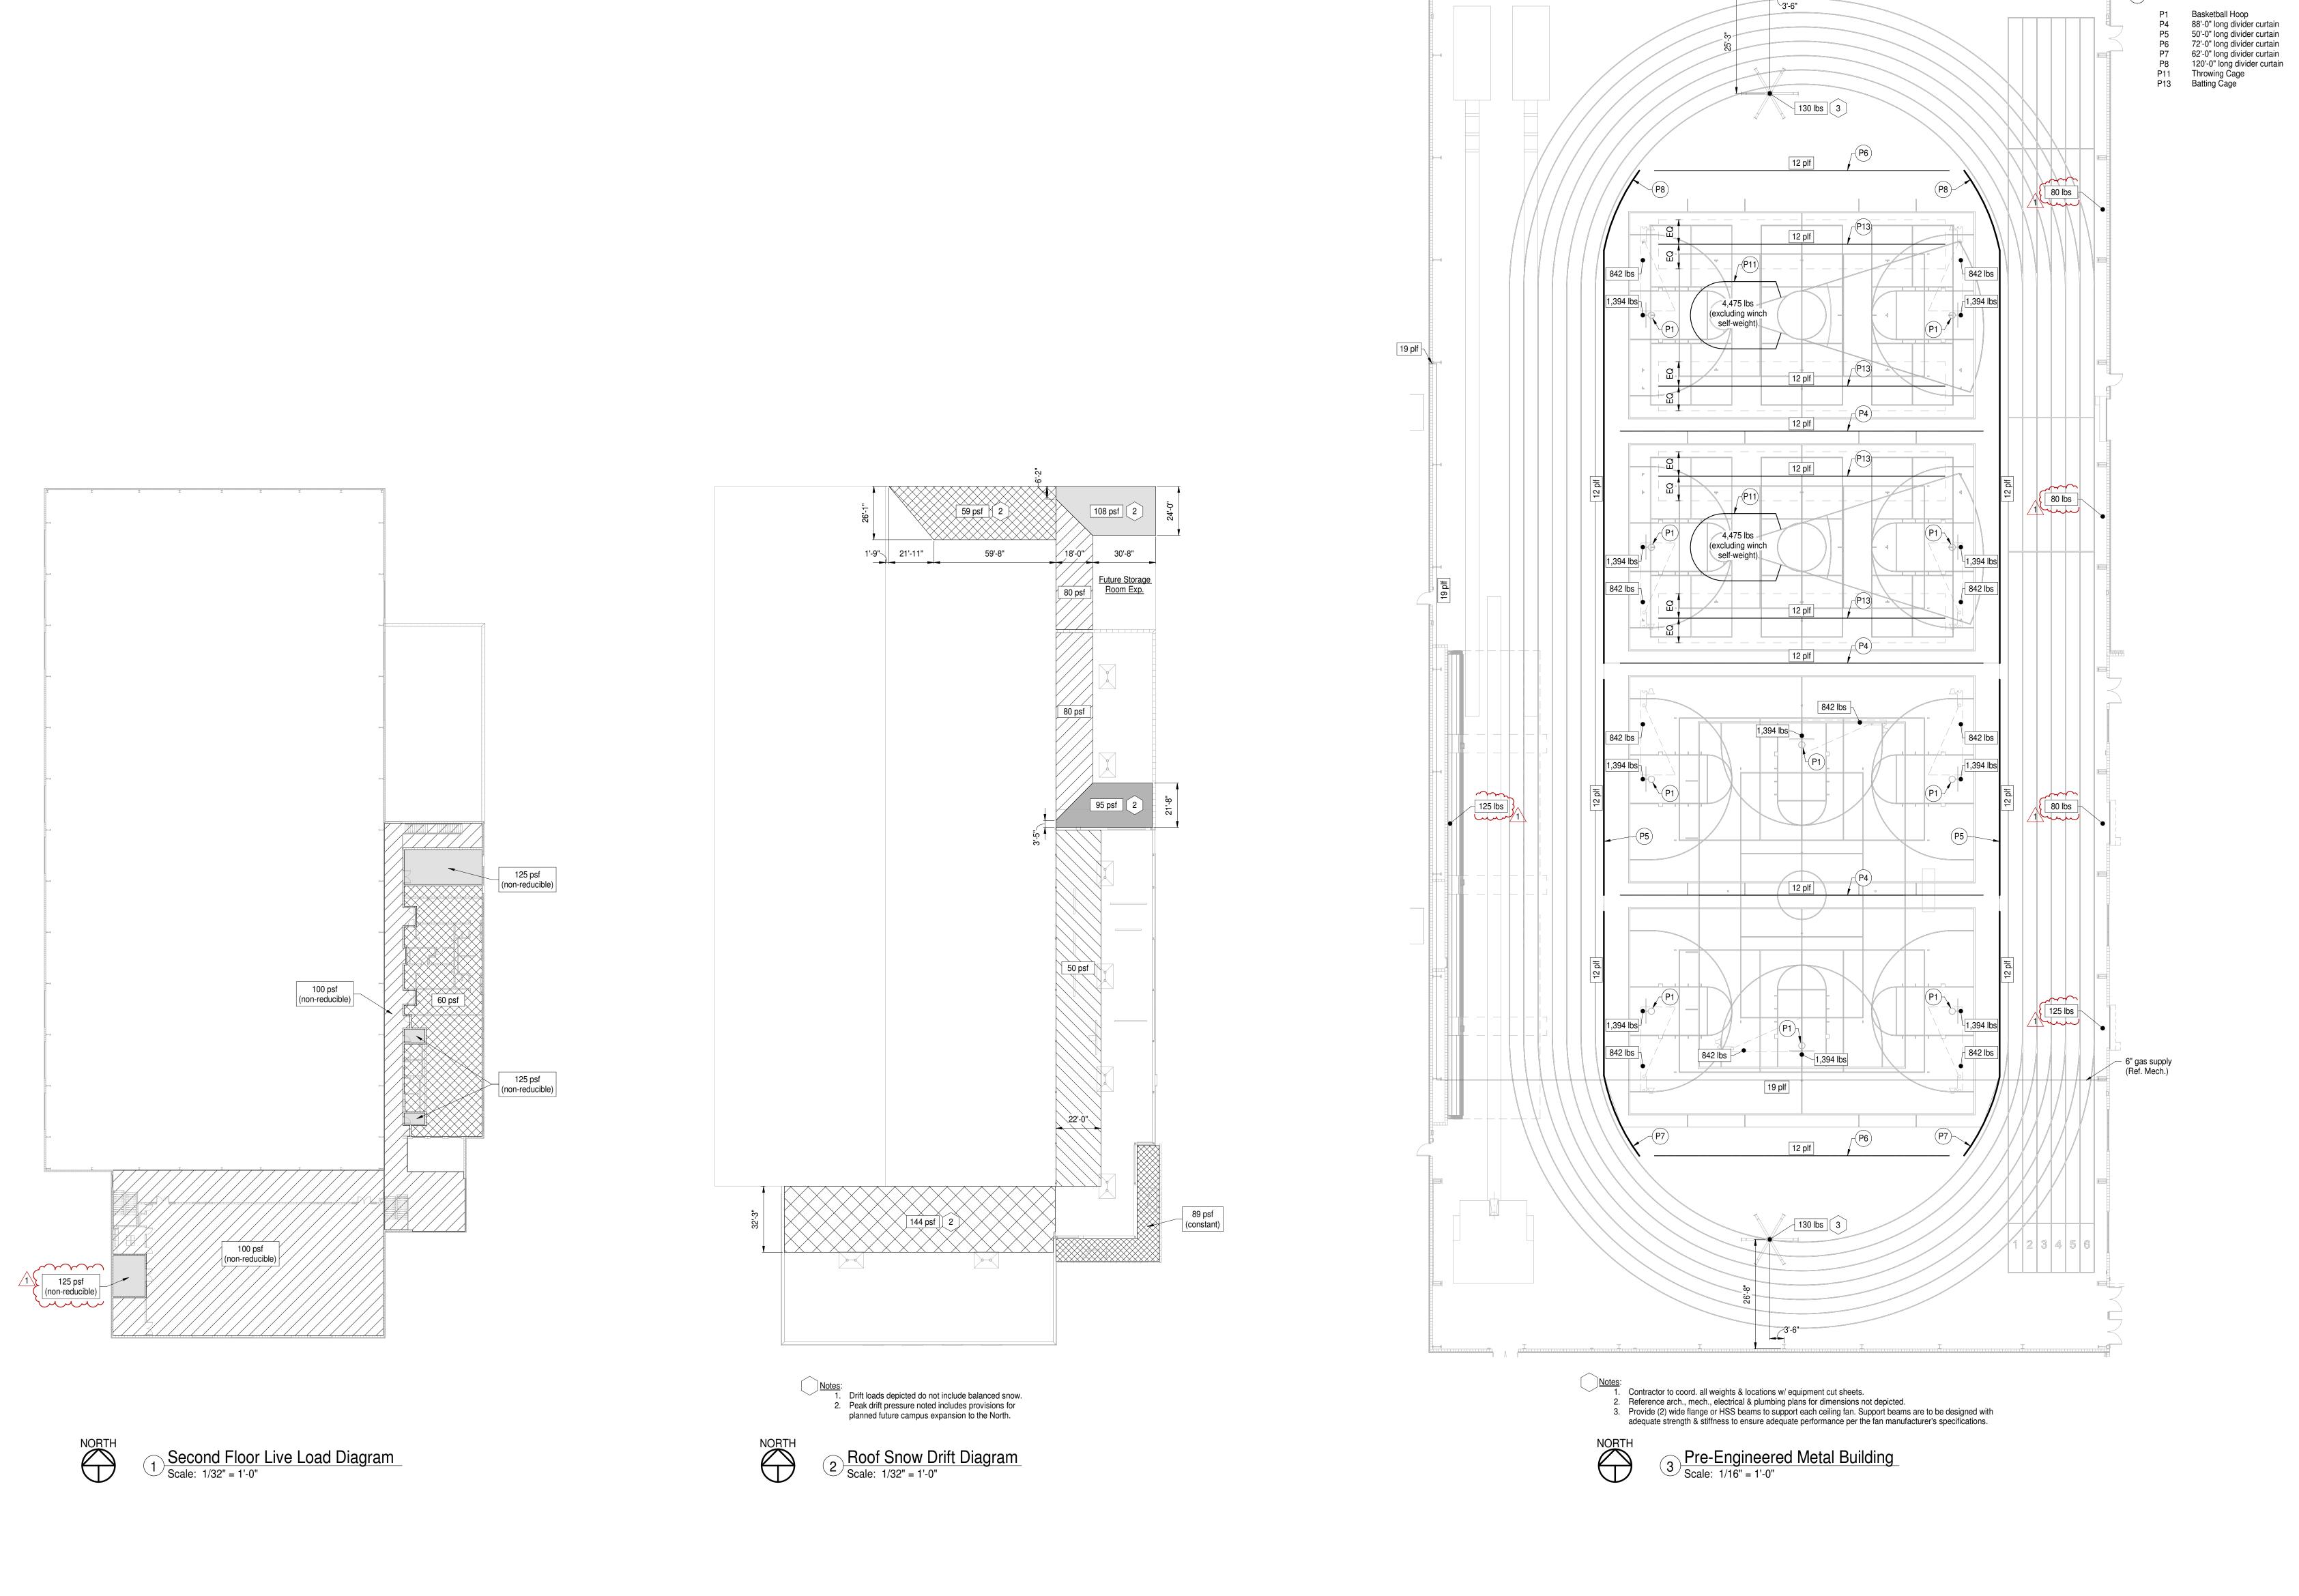
SURVEYORS & ENGINEERS:

PETITIONER:

ATTN: JOE WINTERS

PENN HARRIS MADISON DANCH, HARNER & ASSOCIATES, INC. SCHOOL CORPORATION 55900 BITTERSWEET ROAD MISHAWAKA, IN 46545 (574) 259-7941

1643 COMMERCE DRIVE SOUTH BEND, IN. 46628 (574) 234-4003 ATTN: MICHAEL DANCH



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PENN HIGH SCHOOL FIELDHOUSE

12641 McKinley Highway, Mishawaka, Indiana 46545

PENN-HARRIS-MADISON SCHOOL CORPORATION




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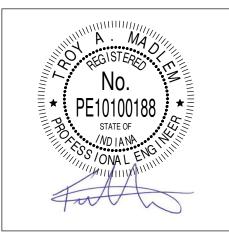
317.848.0966 WWW.FHAI.COM350 E NEW YORK ST #300, INDIANAPOLIS, IN 46204

CONSULTANT





Construction Documents

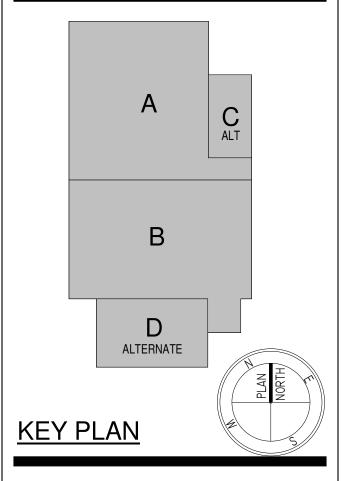


PROJECT MANAGER: JAA
DRAWN BY: TCM
PROJECT NUMBER: 222130.00

	SSUE DATE: January 10, 2024	1
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1	Addendum #1	01/26/202
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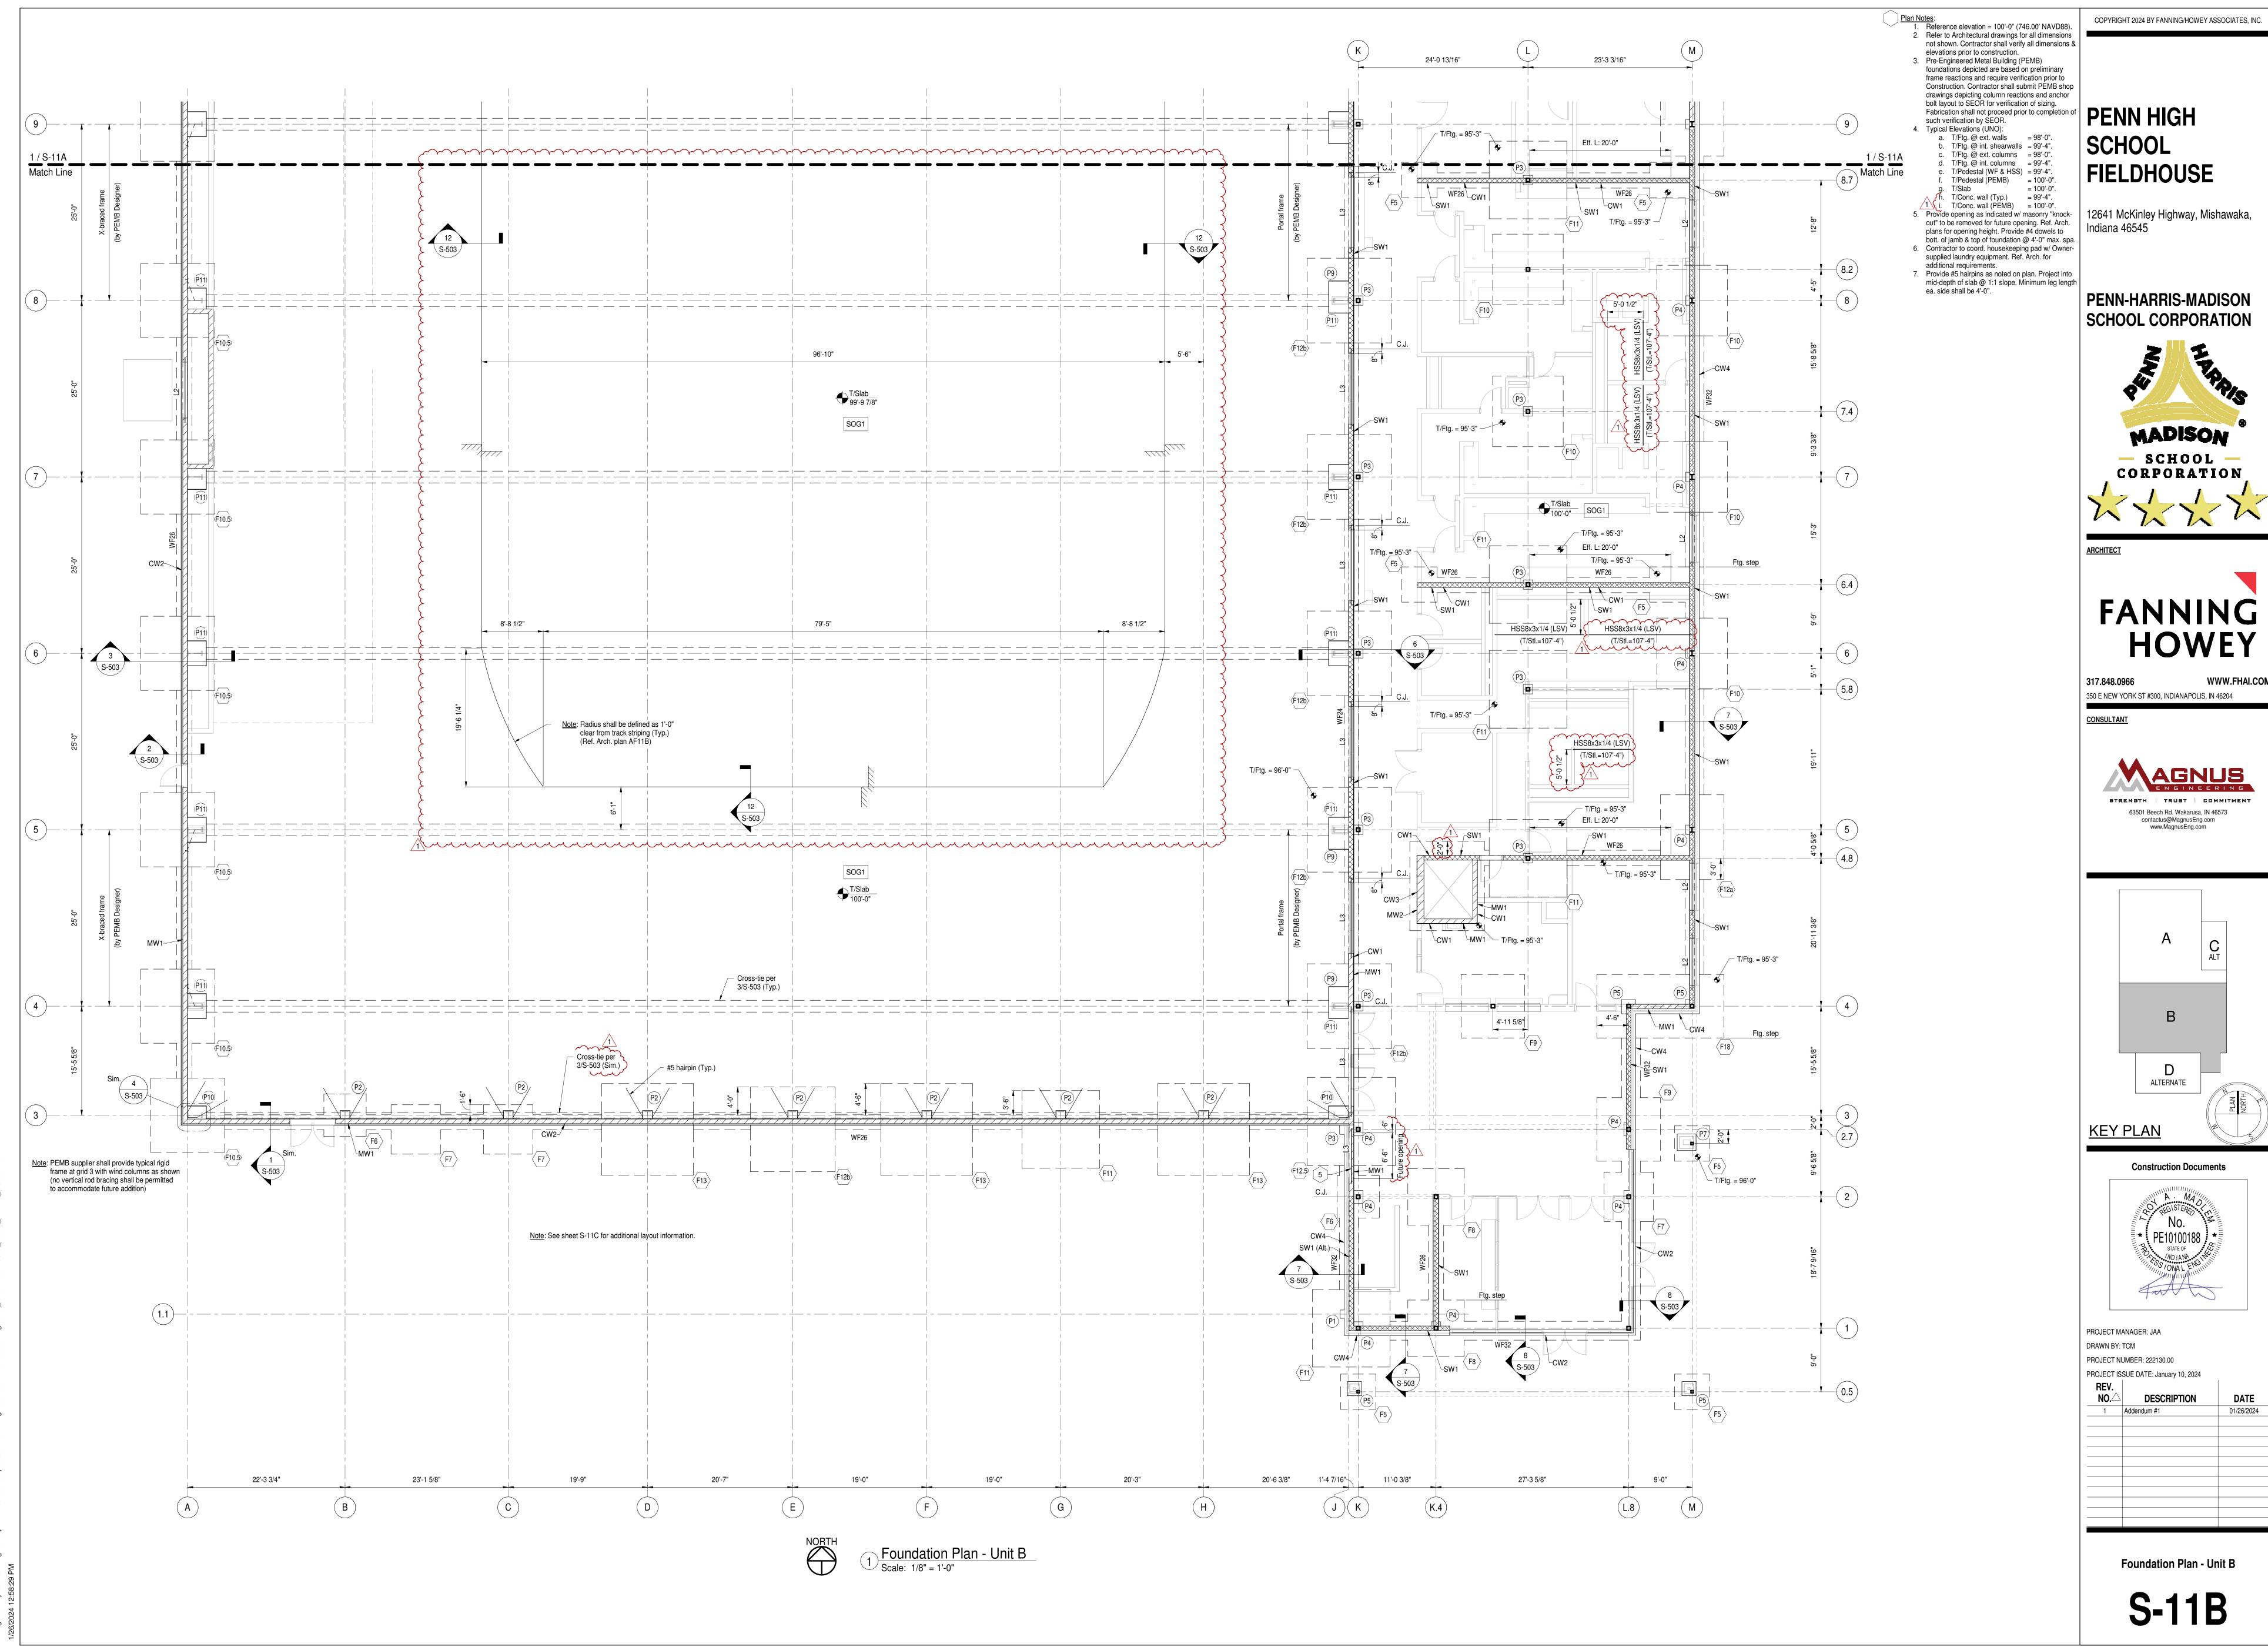
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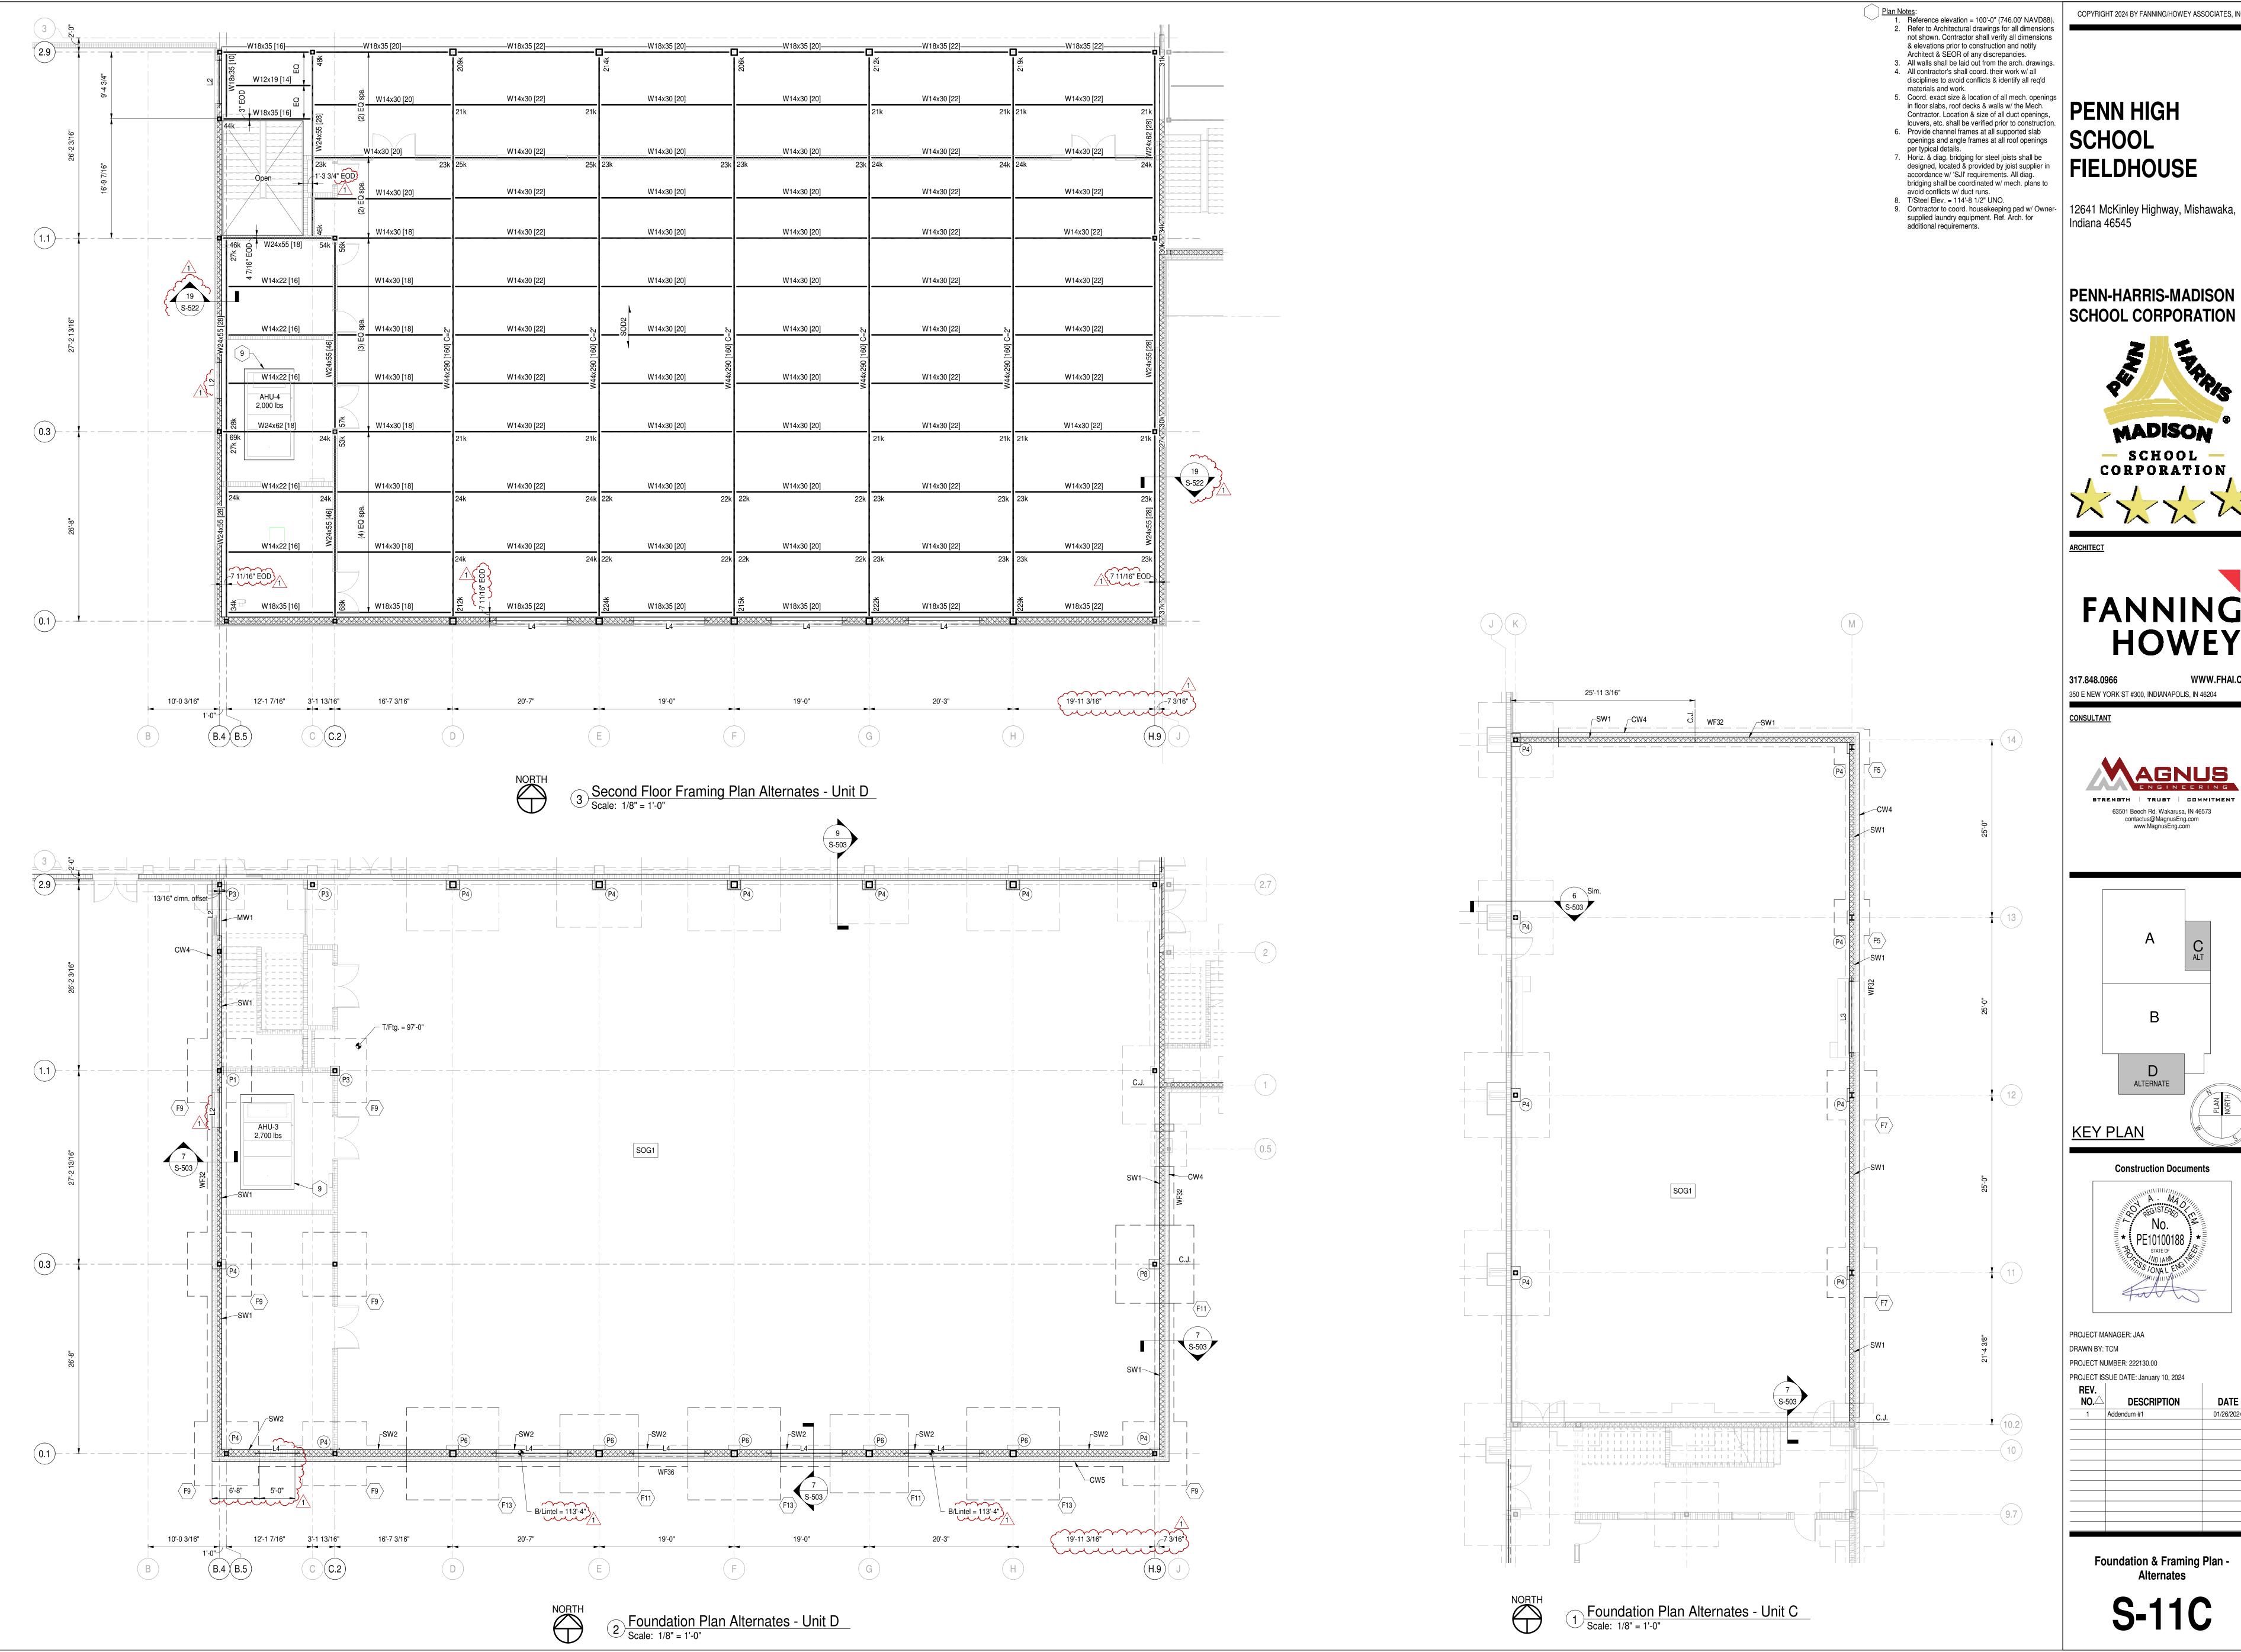






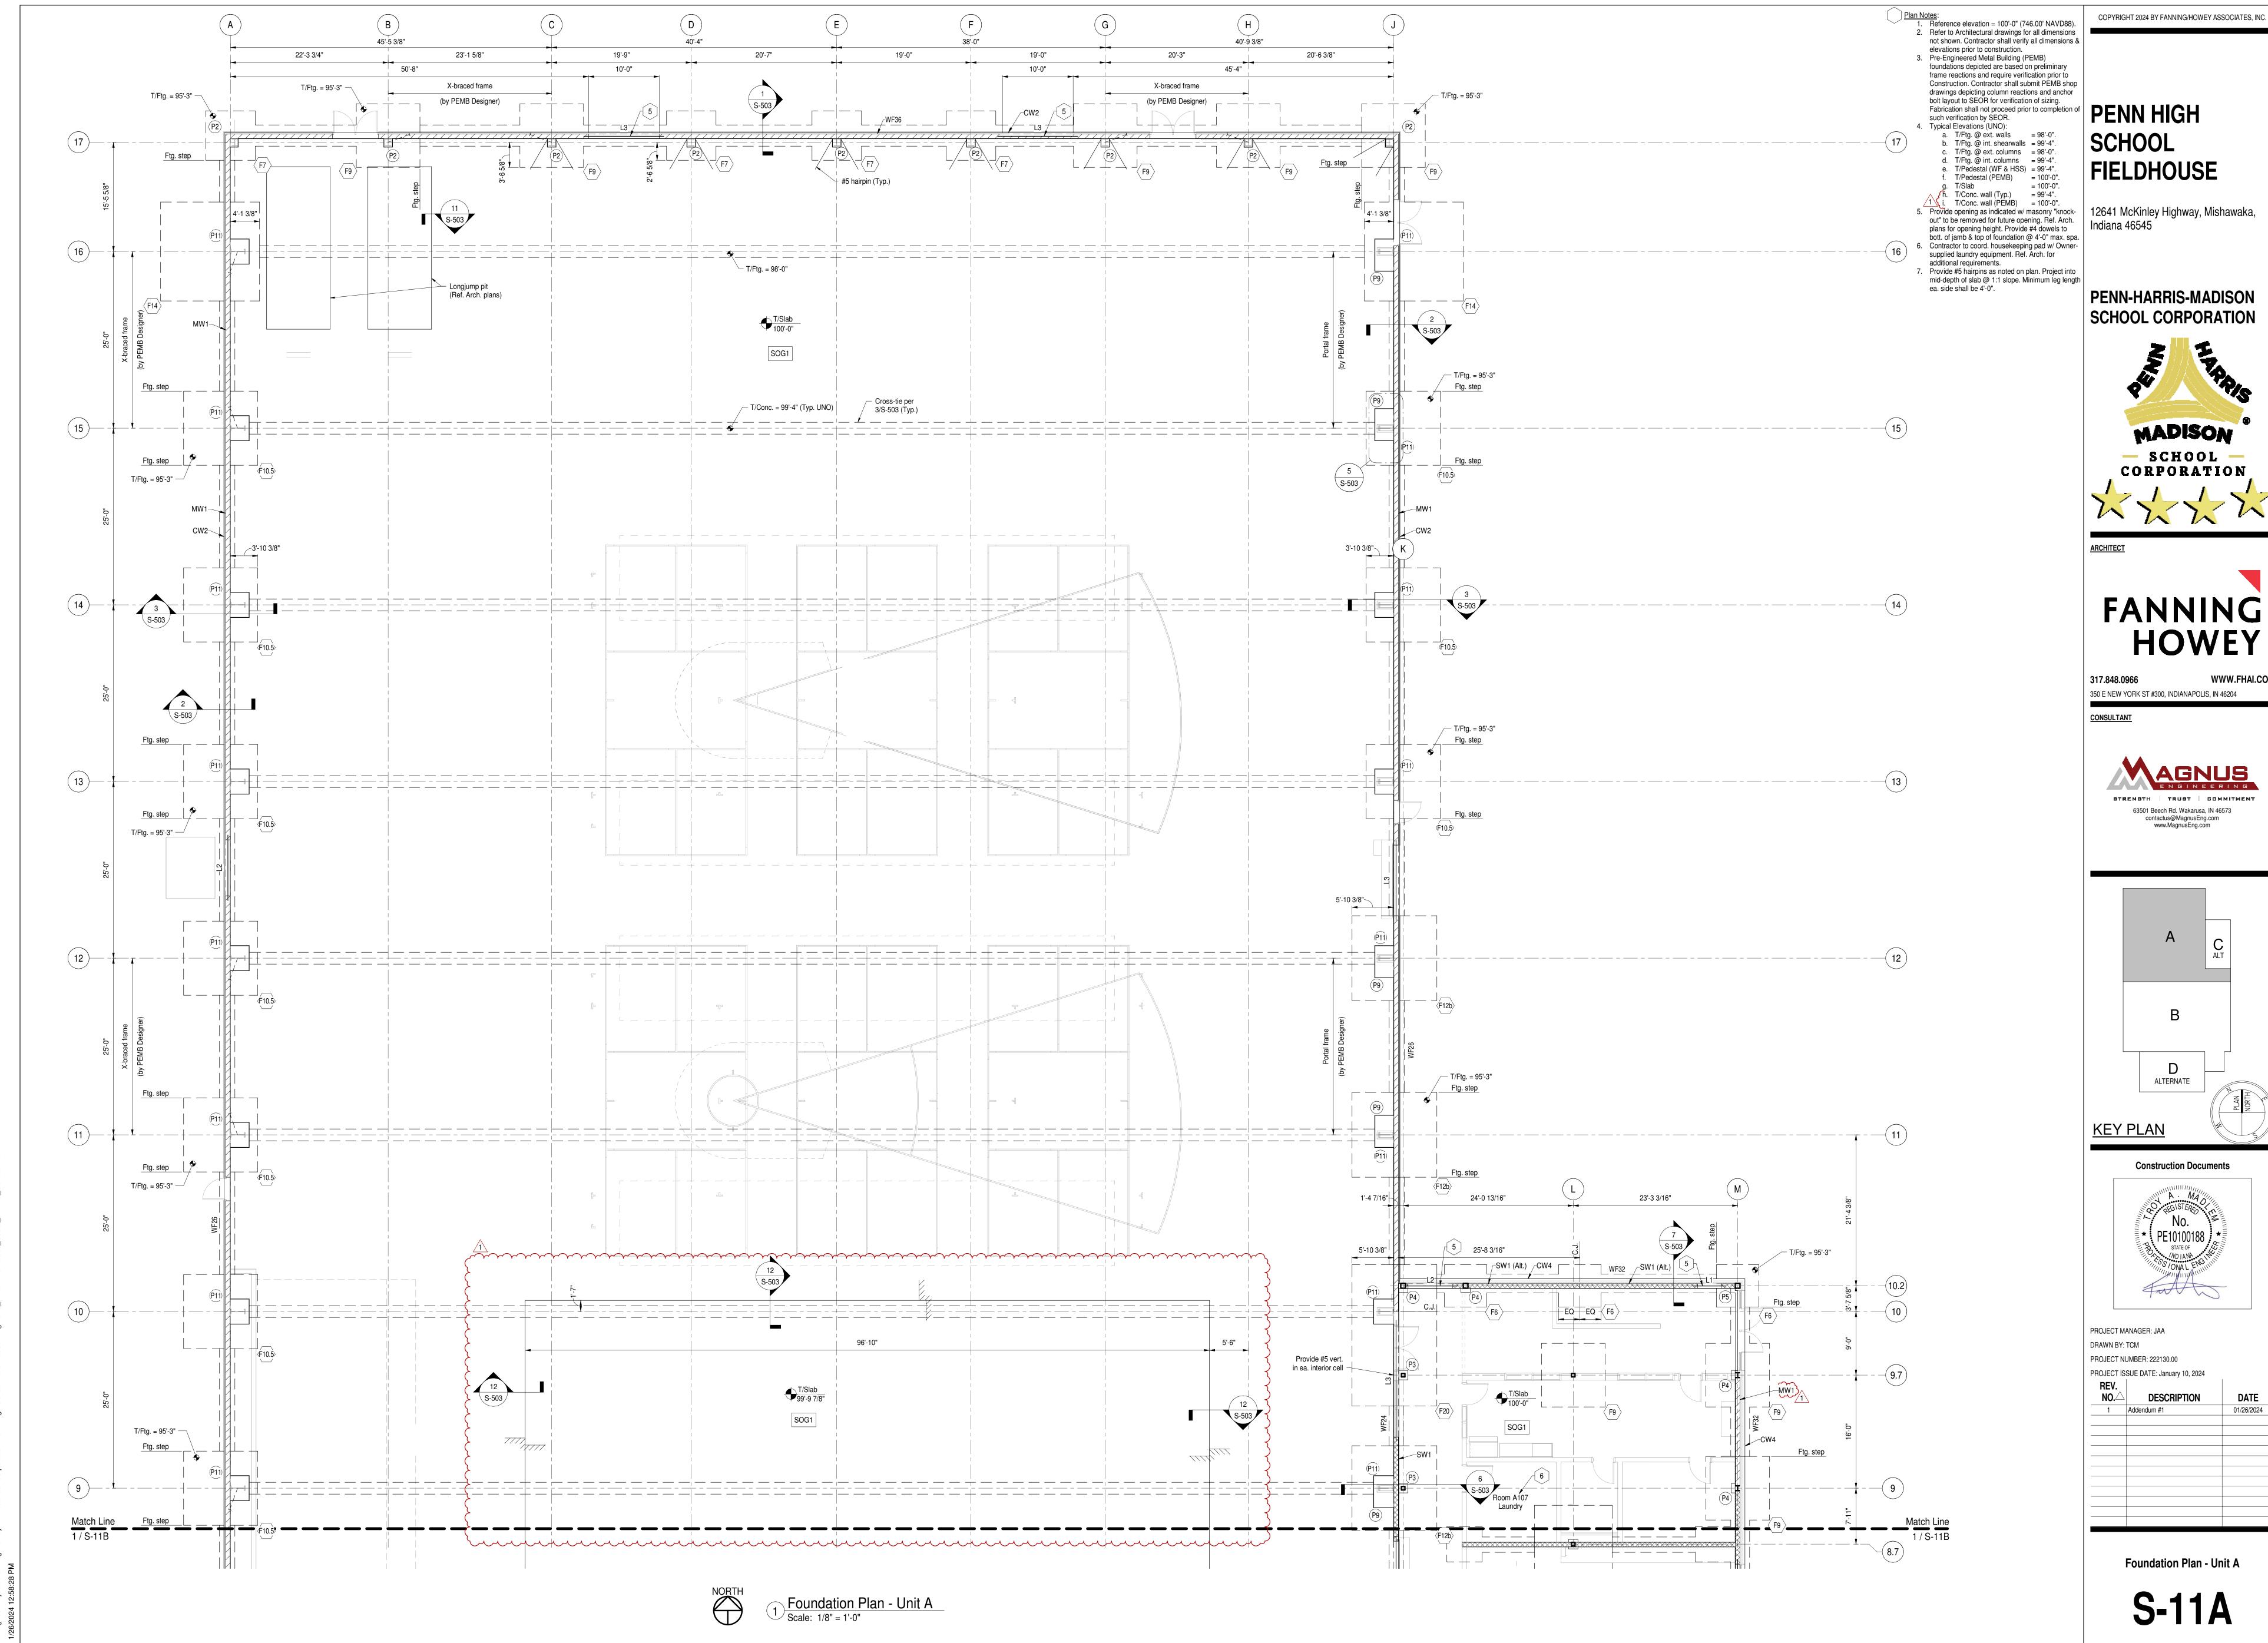

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1	Addendum #1	01/26/2024
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PENN HIGH

PENN-HARRIS-MADISON SCHOOL CORPORATION





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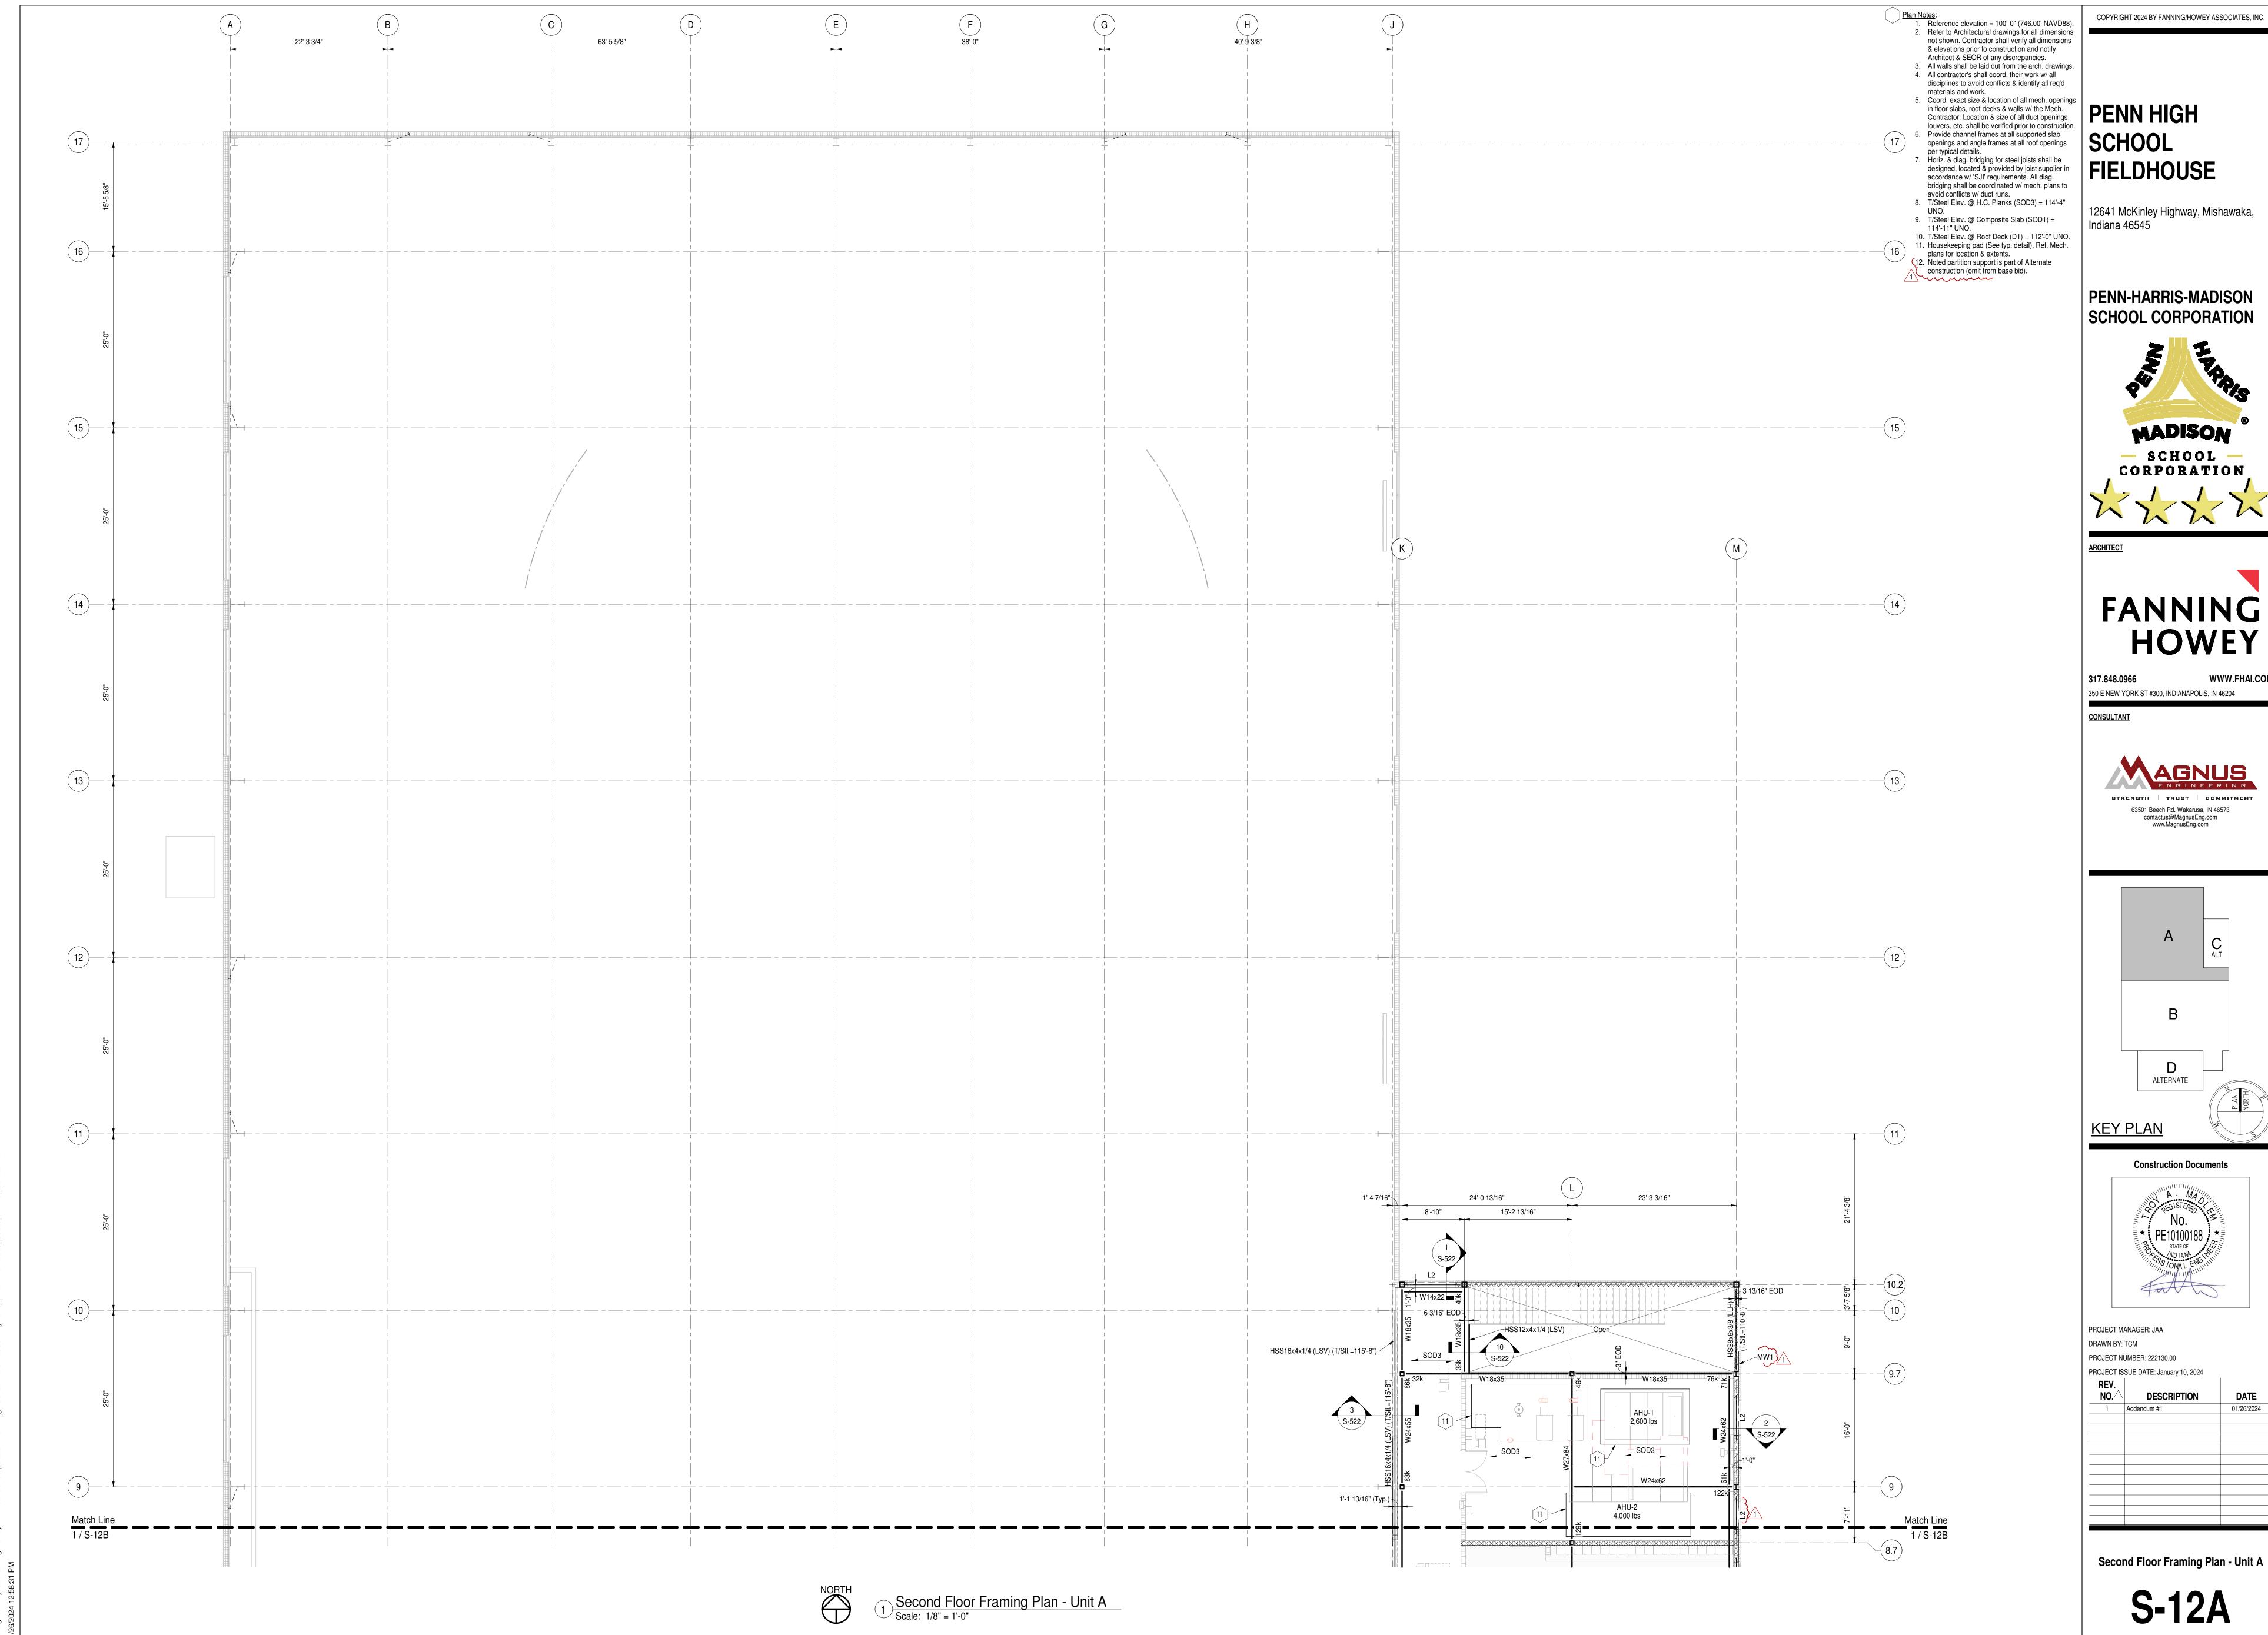
ALTERNATE

Construction Documents



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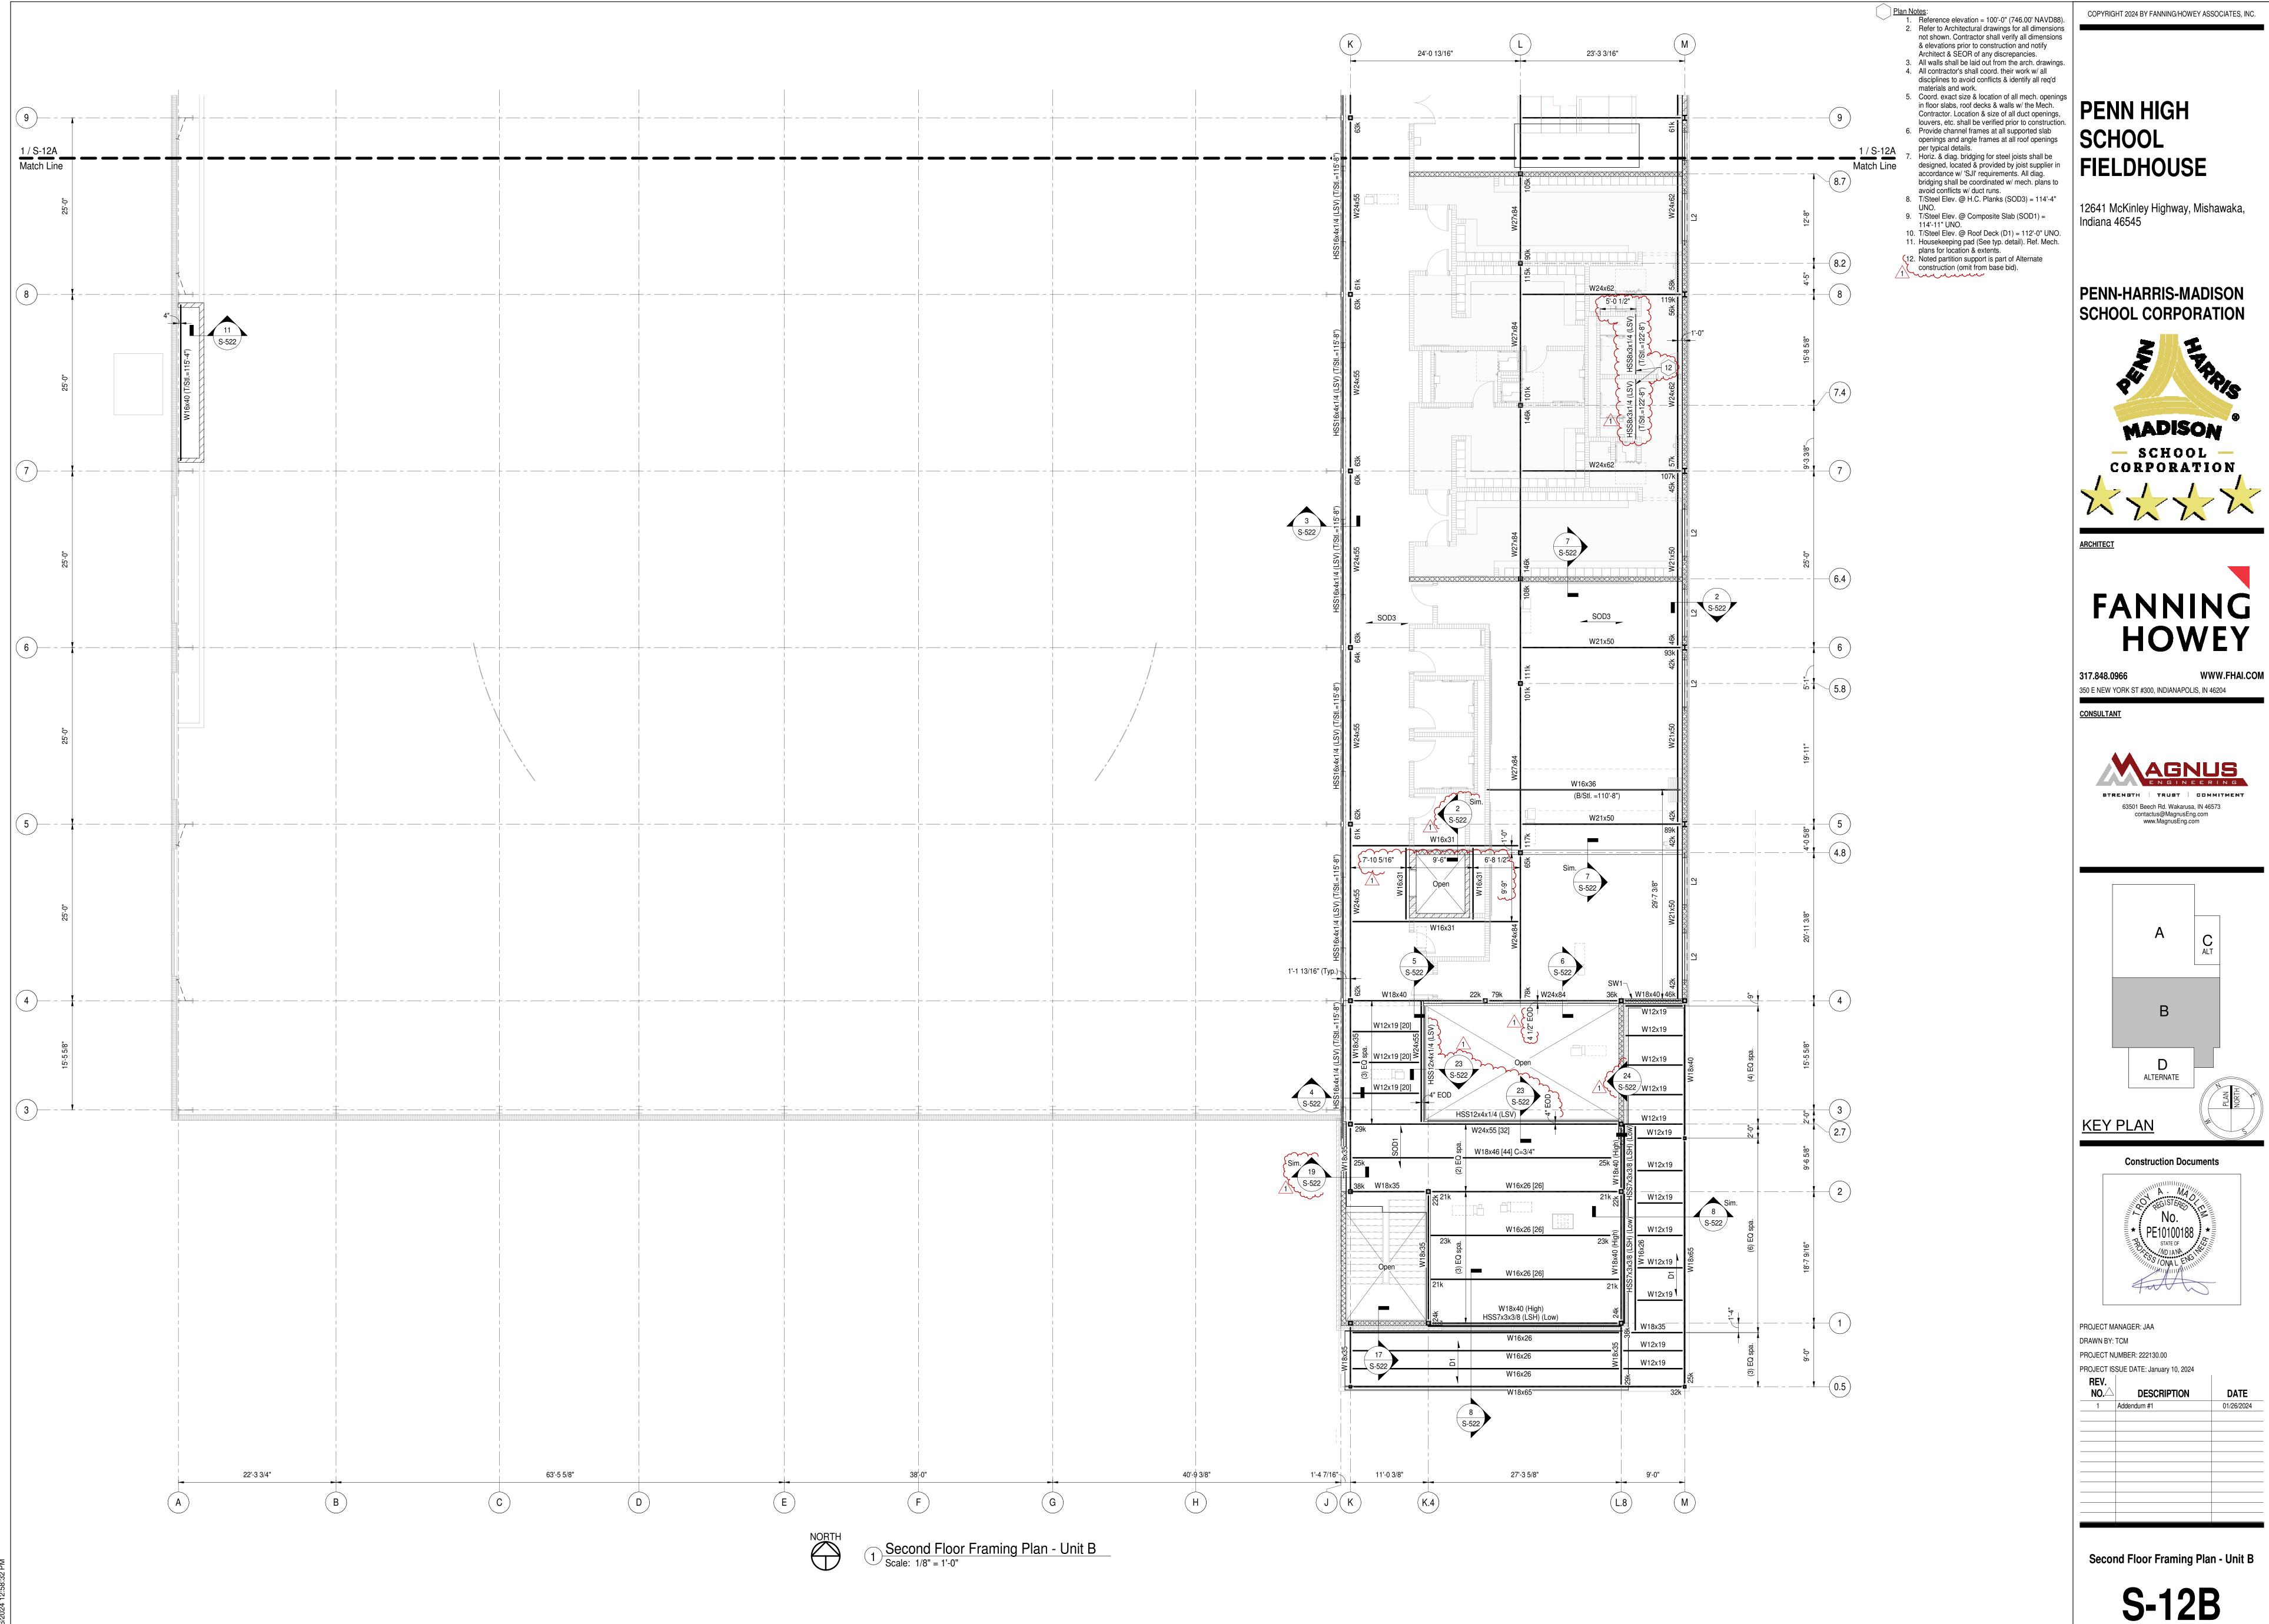
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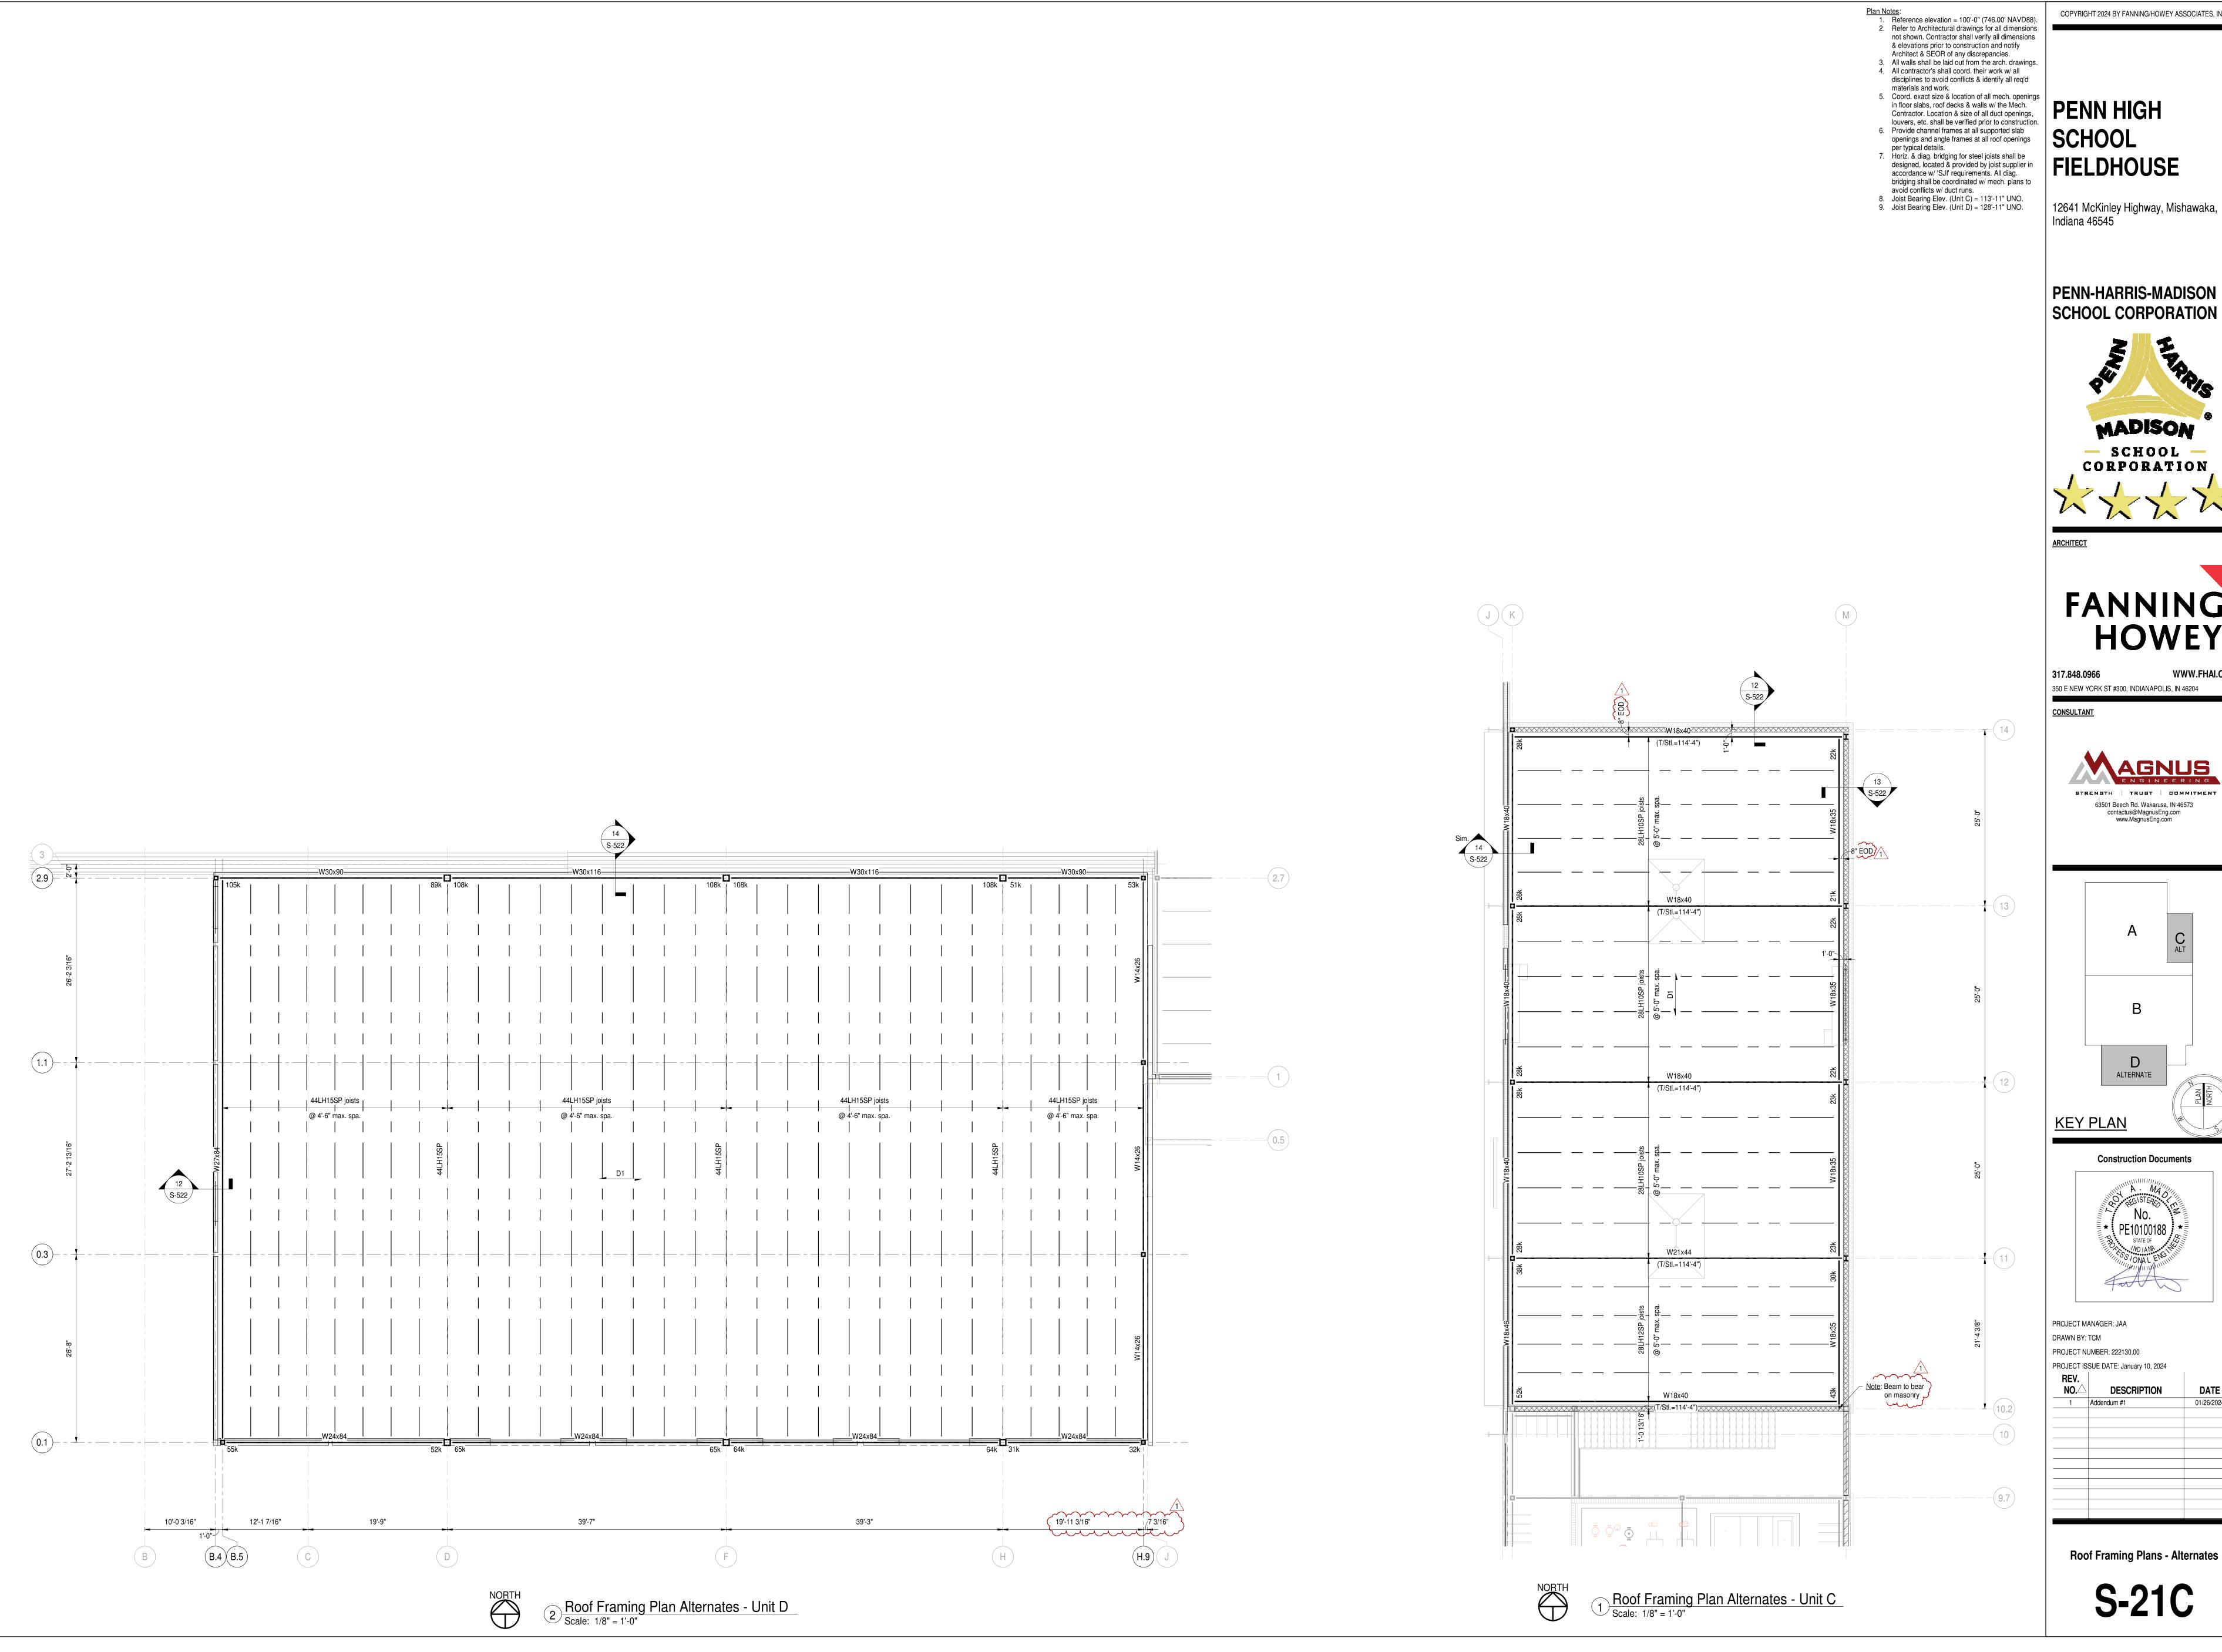




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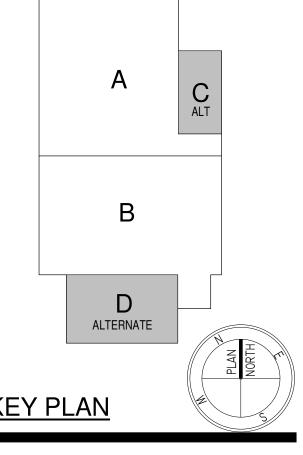
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PENN-HARRIS-MADISON




FANNING


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Construction Documents



REV. NO.△	DESCRIPTION	DATE
1	Addendum #1	01/26/2024

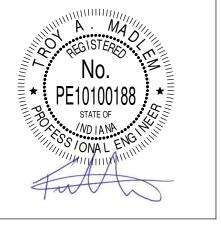

PENN HIGH SCHOOL **FIELDHOUSE**

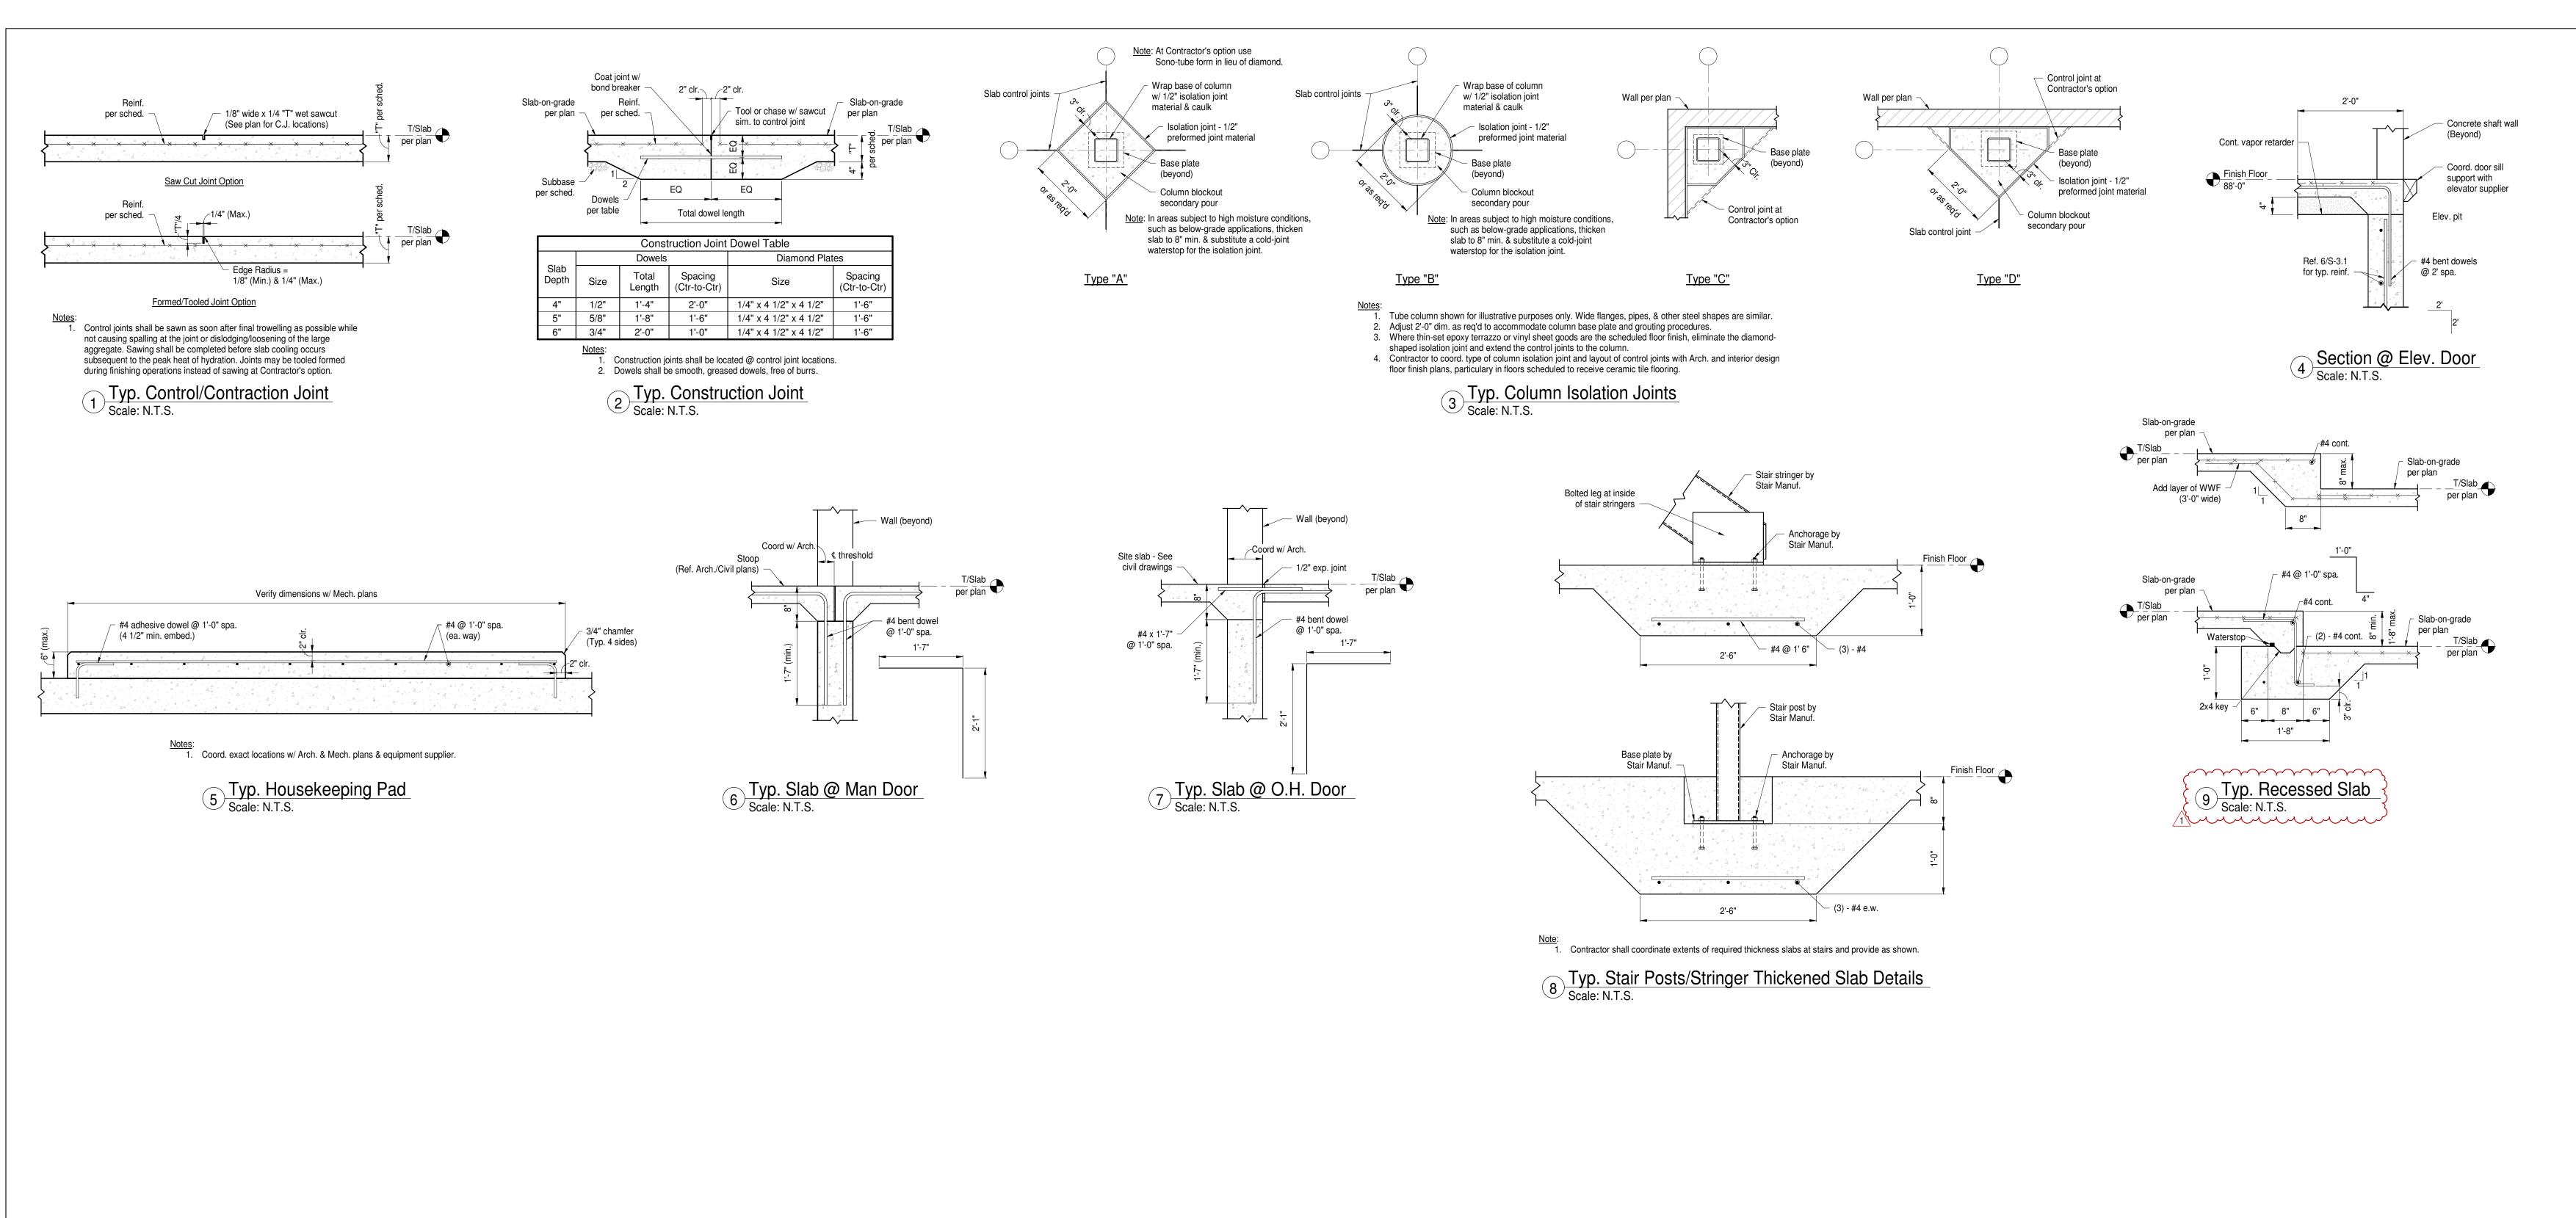12641 McKinley Highway, Mishawaka, Indiana 46545

PENN-HARRIS-MADISON SCHOOL CORPORATION




ARCHITECT



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Construction Documents




PROJECT MANAGER: JAA DRAWN BY: TCM PROJECT NUMBER: 222130.00

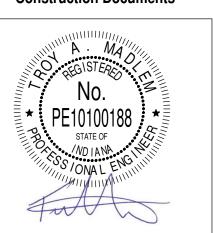PROJECT ISSUE DATE: January 10, 2024

REV. No. $ riangle$	DESCRIPTION	DATE
1	Addendum #1	01/26/2024

Typ. Foundation/Conc. Details

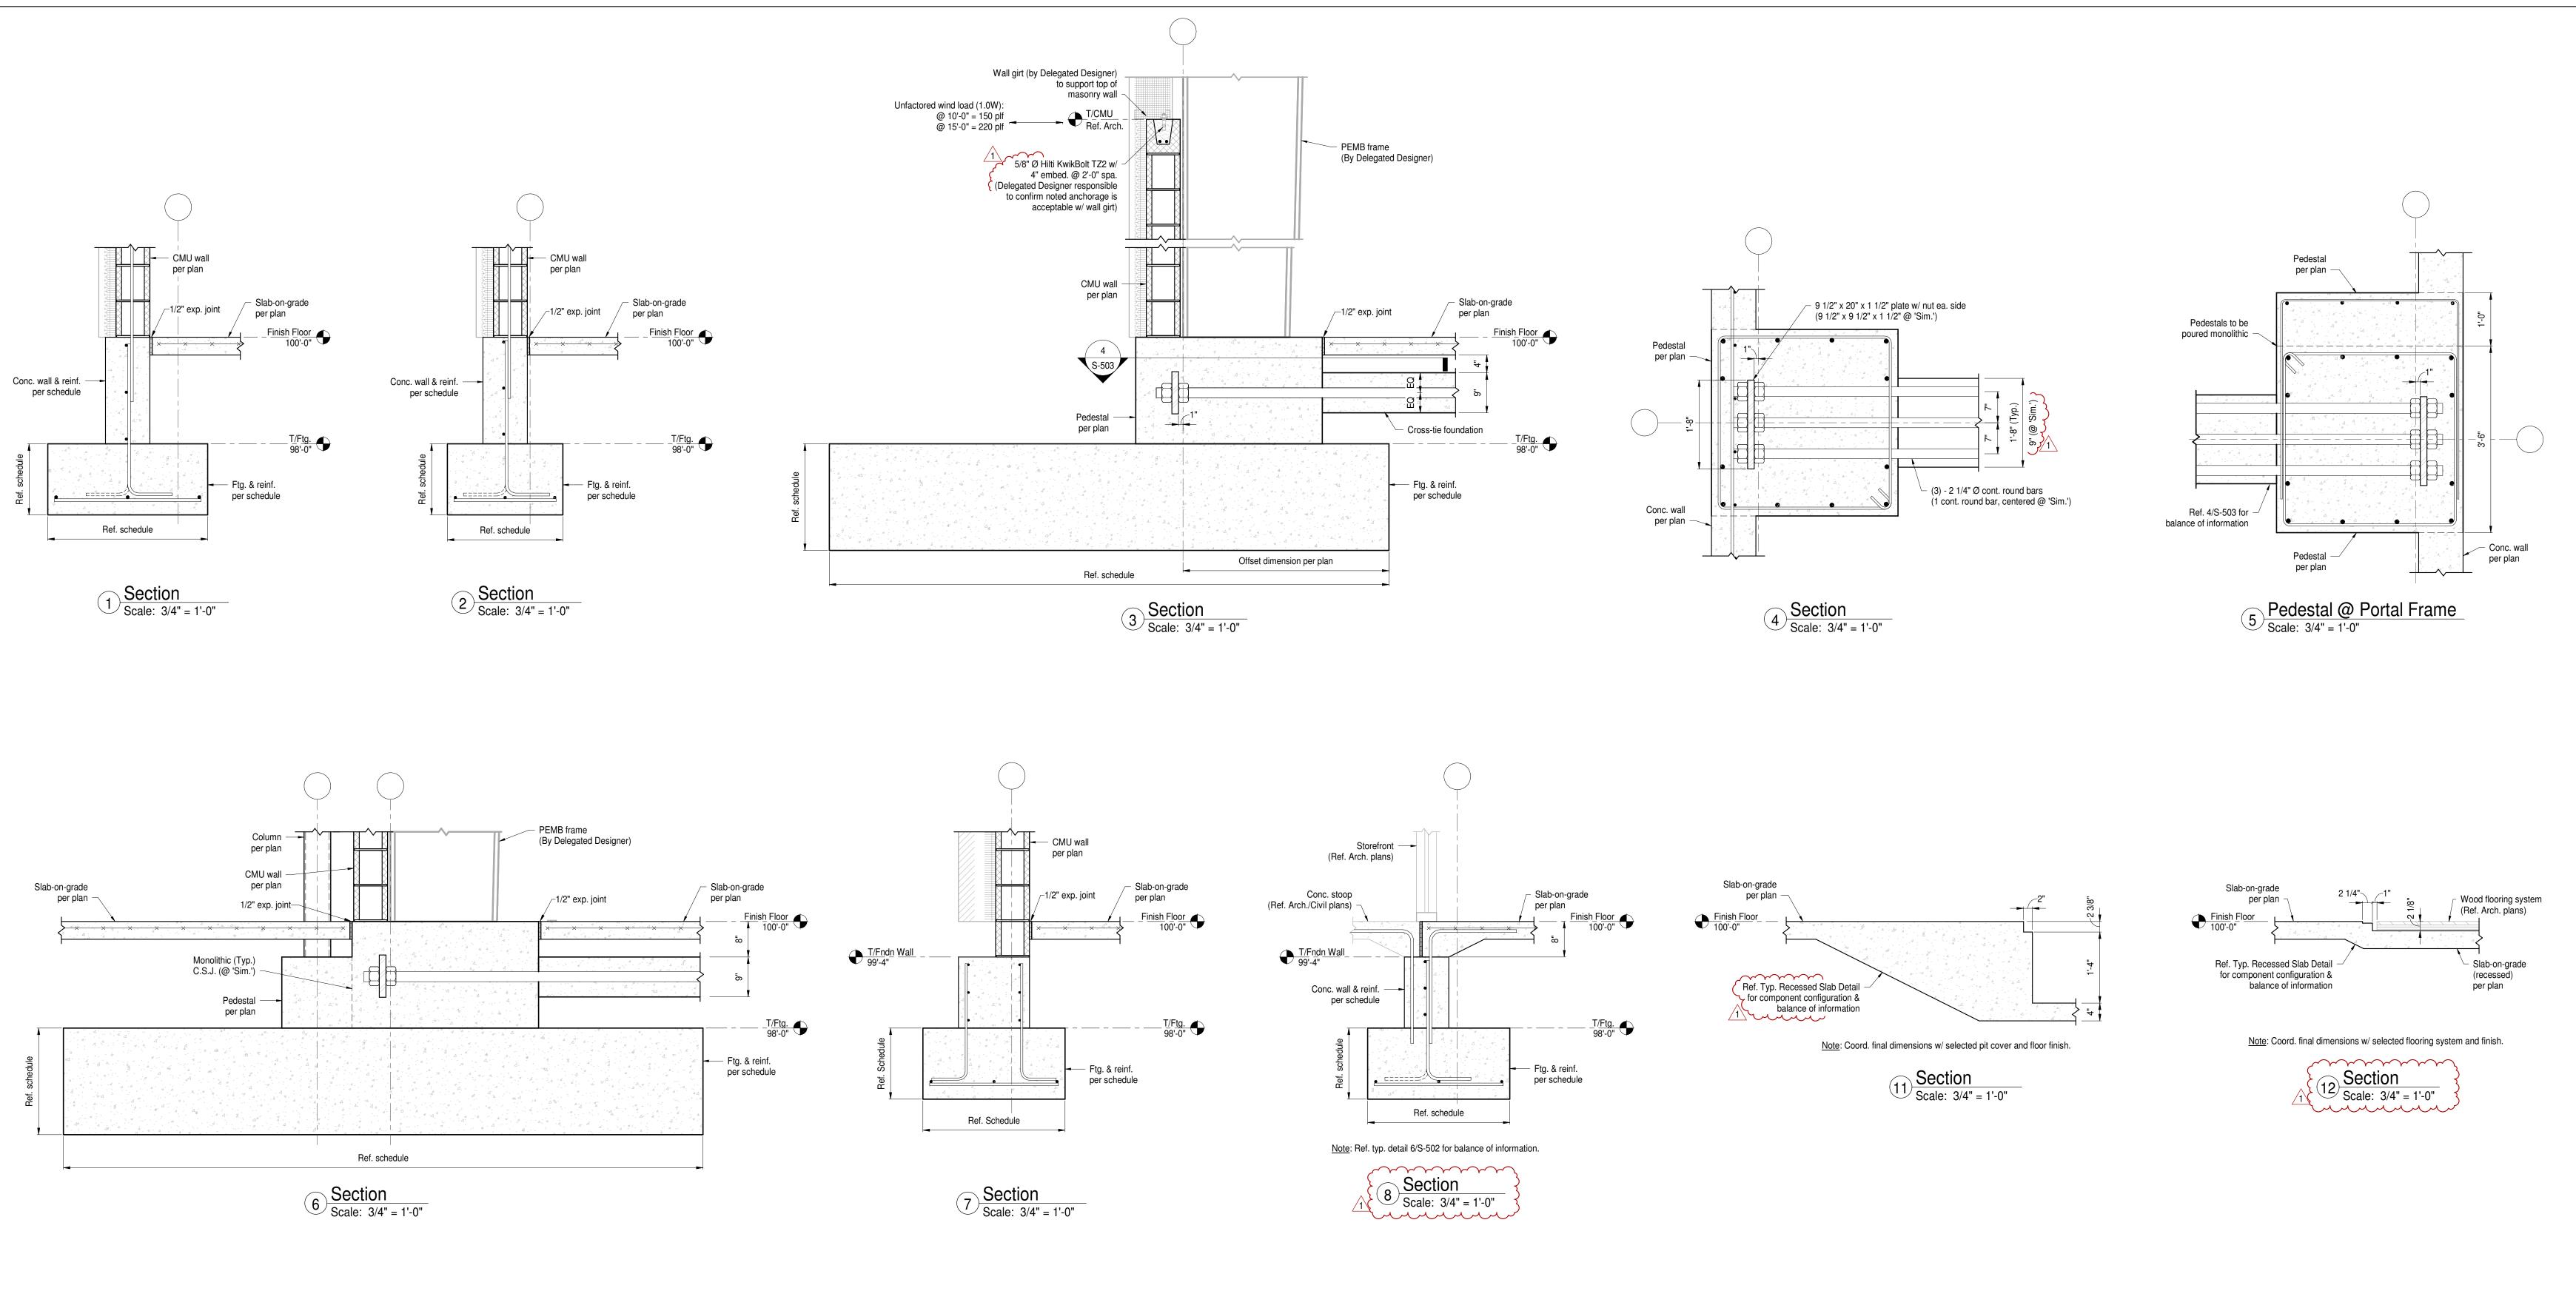



12641 McKinley Highway, Mishawaka, Indiana 46545

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ARCHITECT

FANNING HOWEY

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CONSULTANT



PROJECT MANAGER: JAA

DRAWN BY: TCM


PROJECT NUMBER: 222130.00


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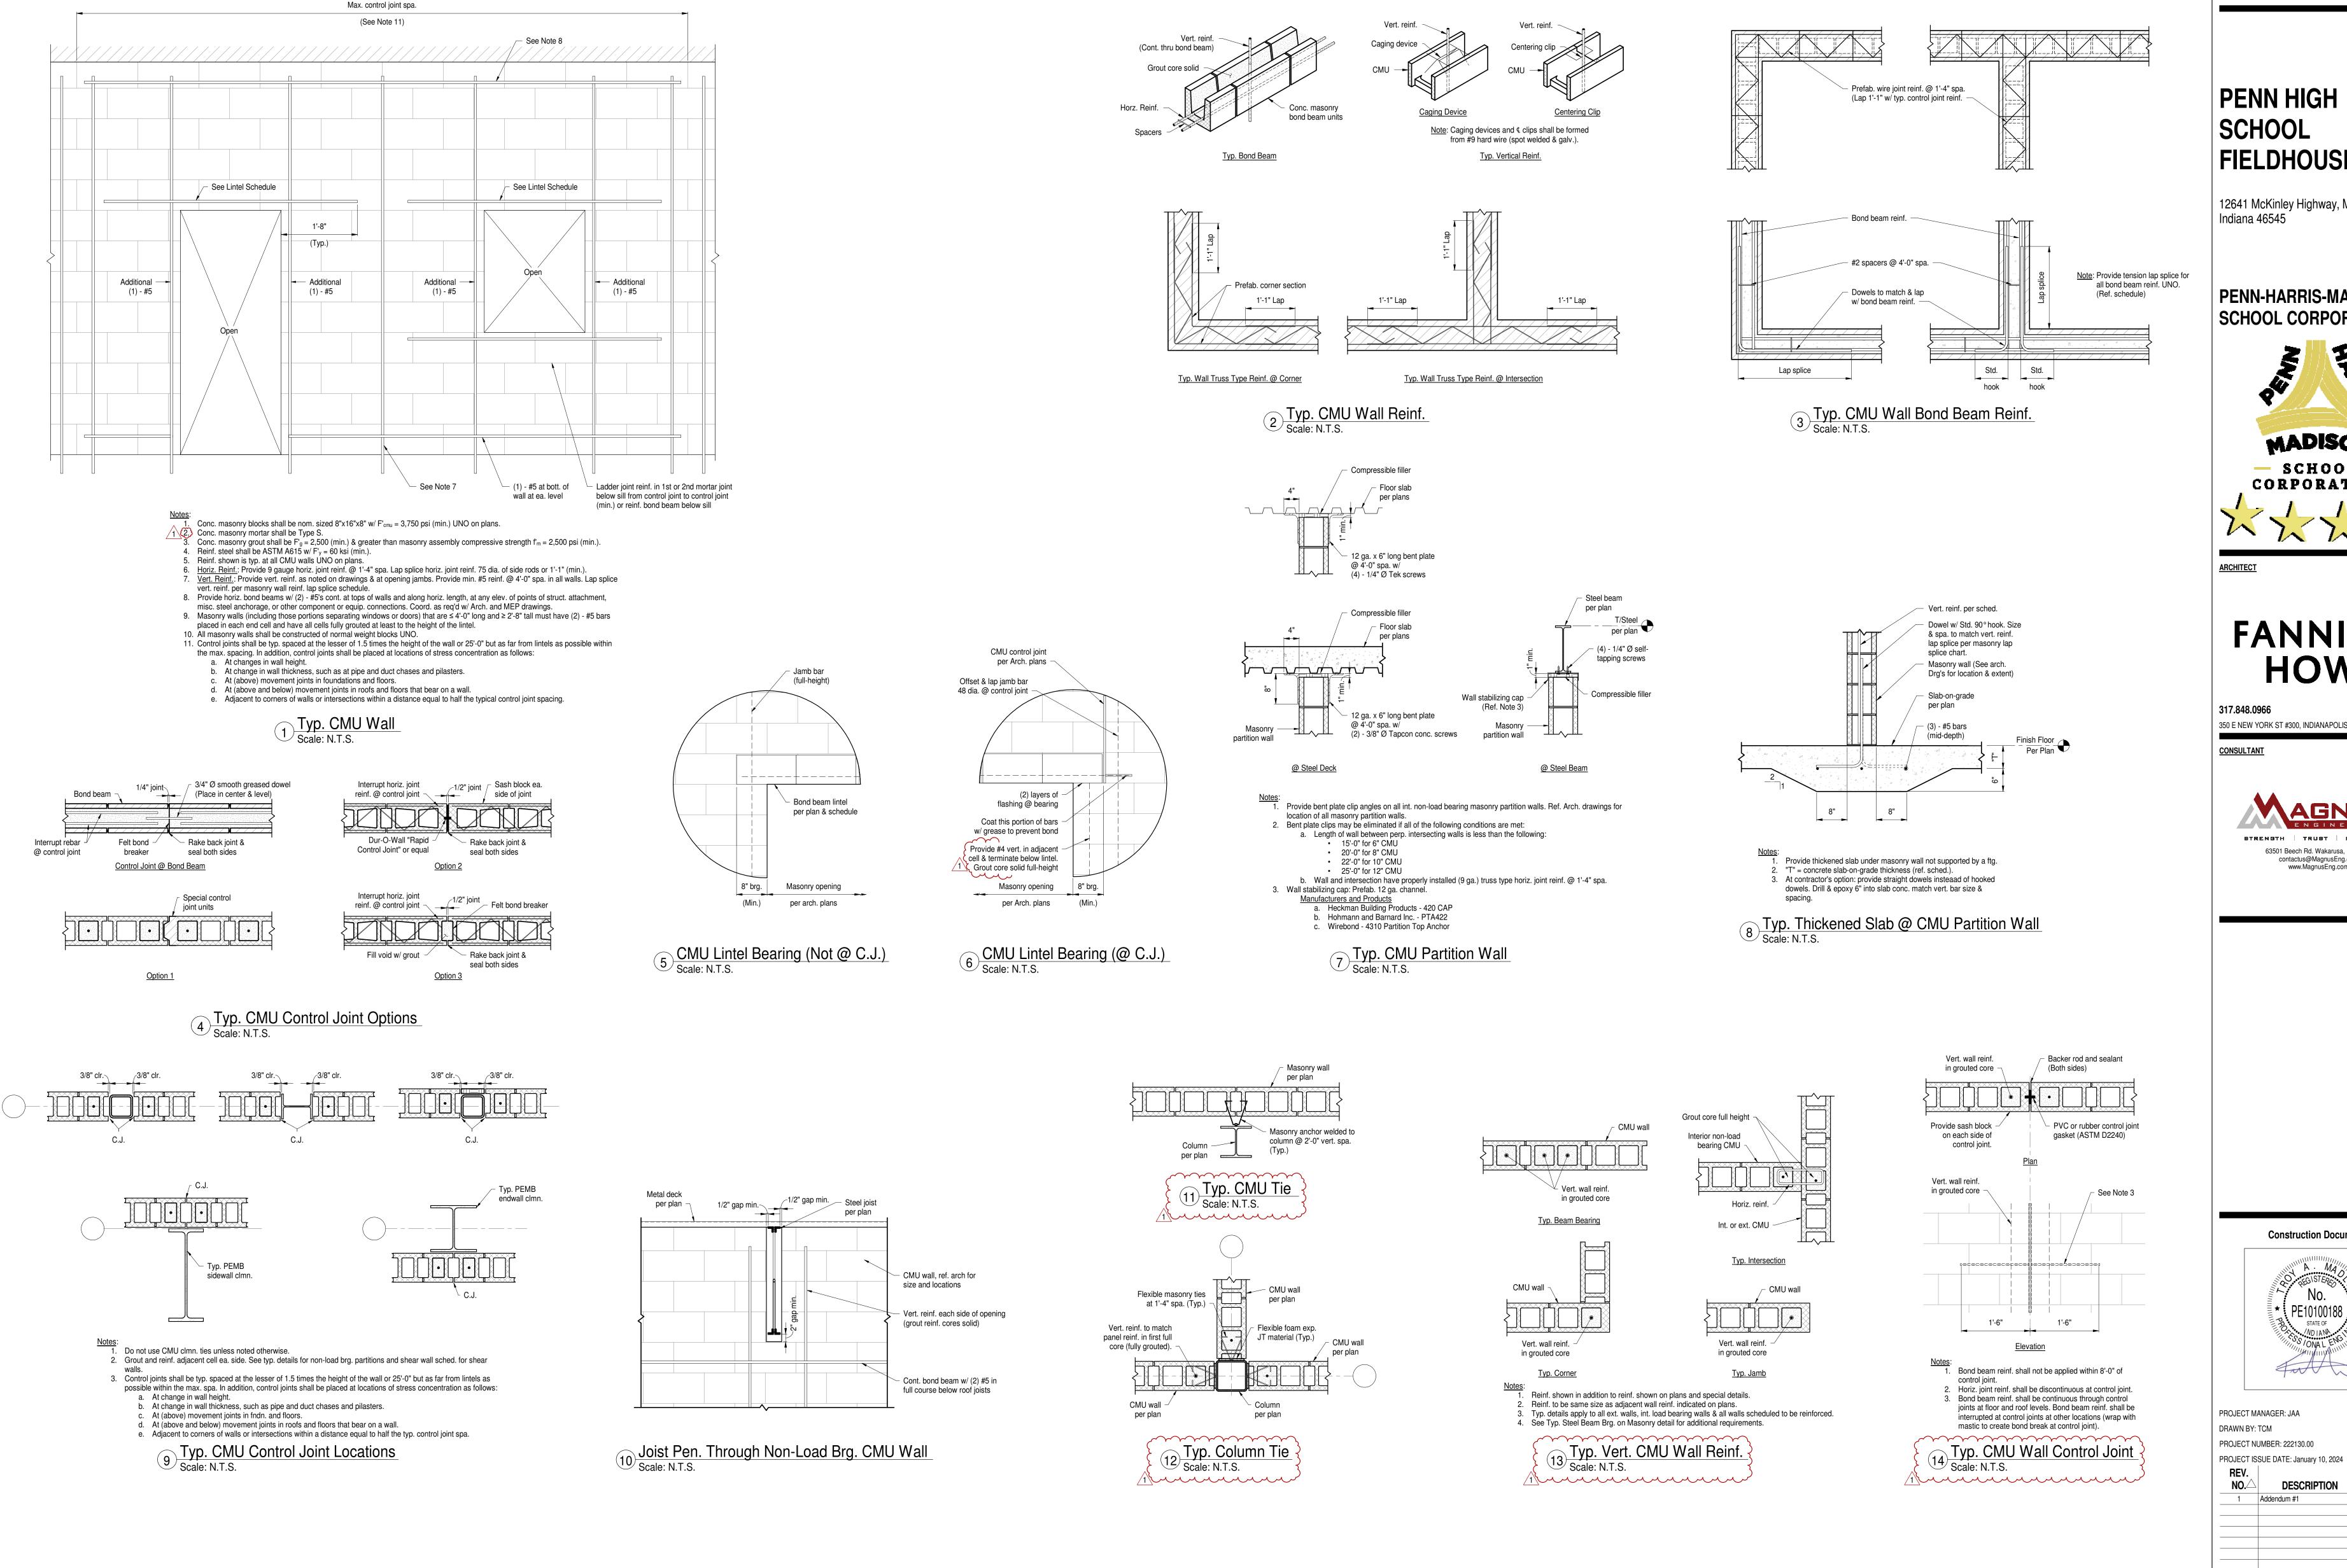
REV. NO.△	DESCRIPTION	DATE
1	Addendum #1	01/26/2024

Foundation Details

S-503



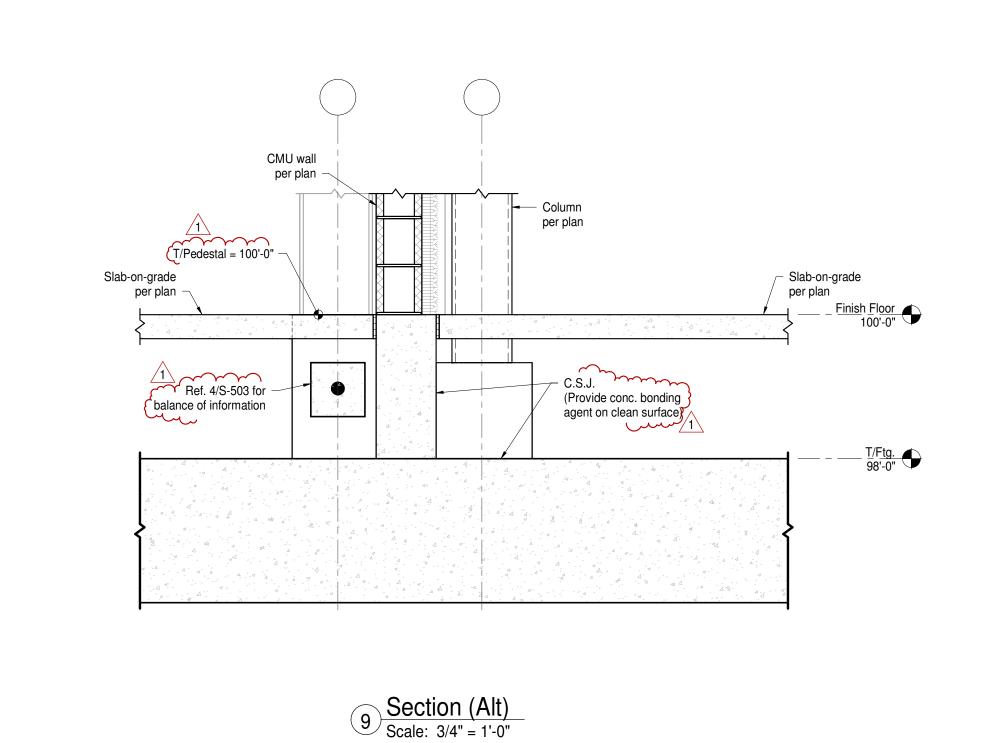

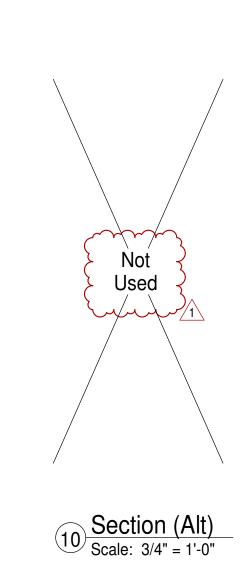

PENN HIGH SCHOOL **FIELDHOUSE**

12641 McKinley Highway, Mishawaka, Indiana 46545

PENN-HARRIS-MADISON SCHOOL CORPORATION



ARCHITECT




WWW.FHAI.COM 350 E NEW YORK ST #300, INDIANAPOLIS, IN 46204

CONSULTANT



www.MagnusEng.com


Construction Documents

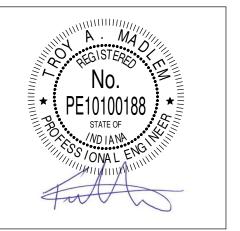

PROJECT MANAGER: JAA DRAWN BY: TCM PROJECT NUMBER: 222130.00

REV. NO. DESCRIPTION 1 Addendum #1

Typ. Masonry Details

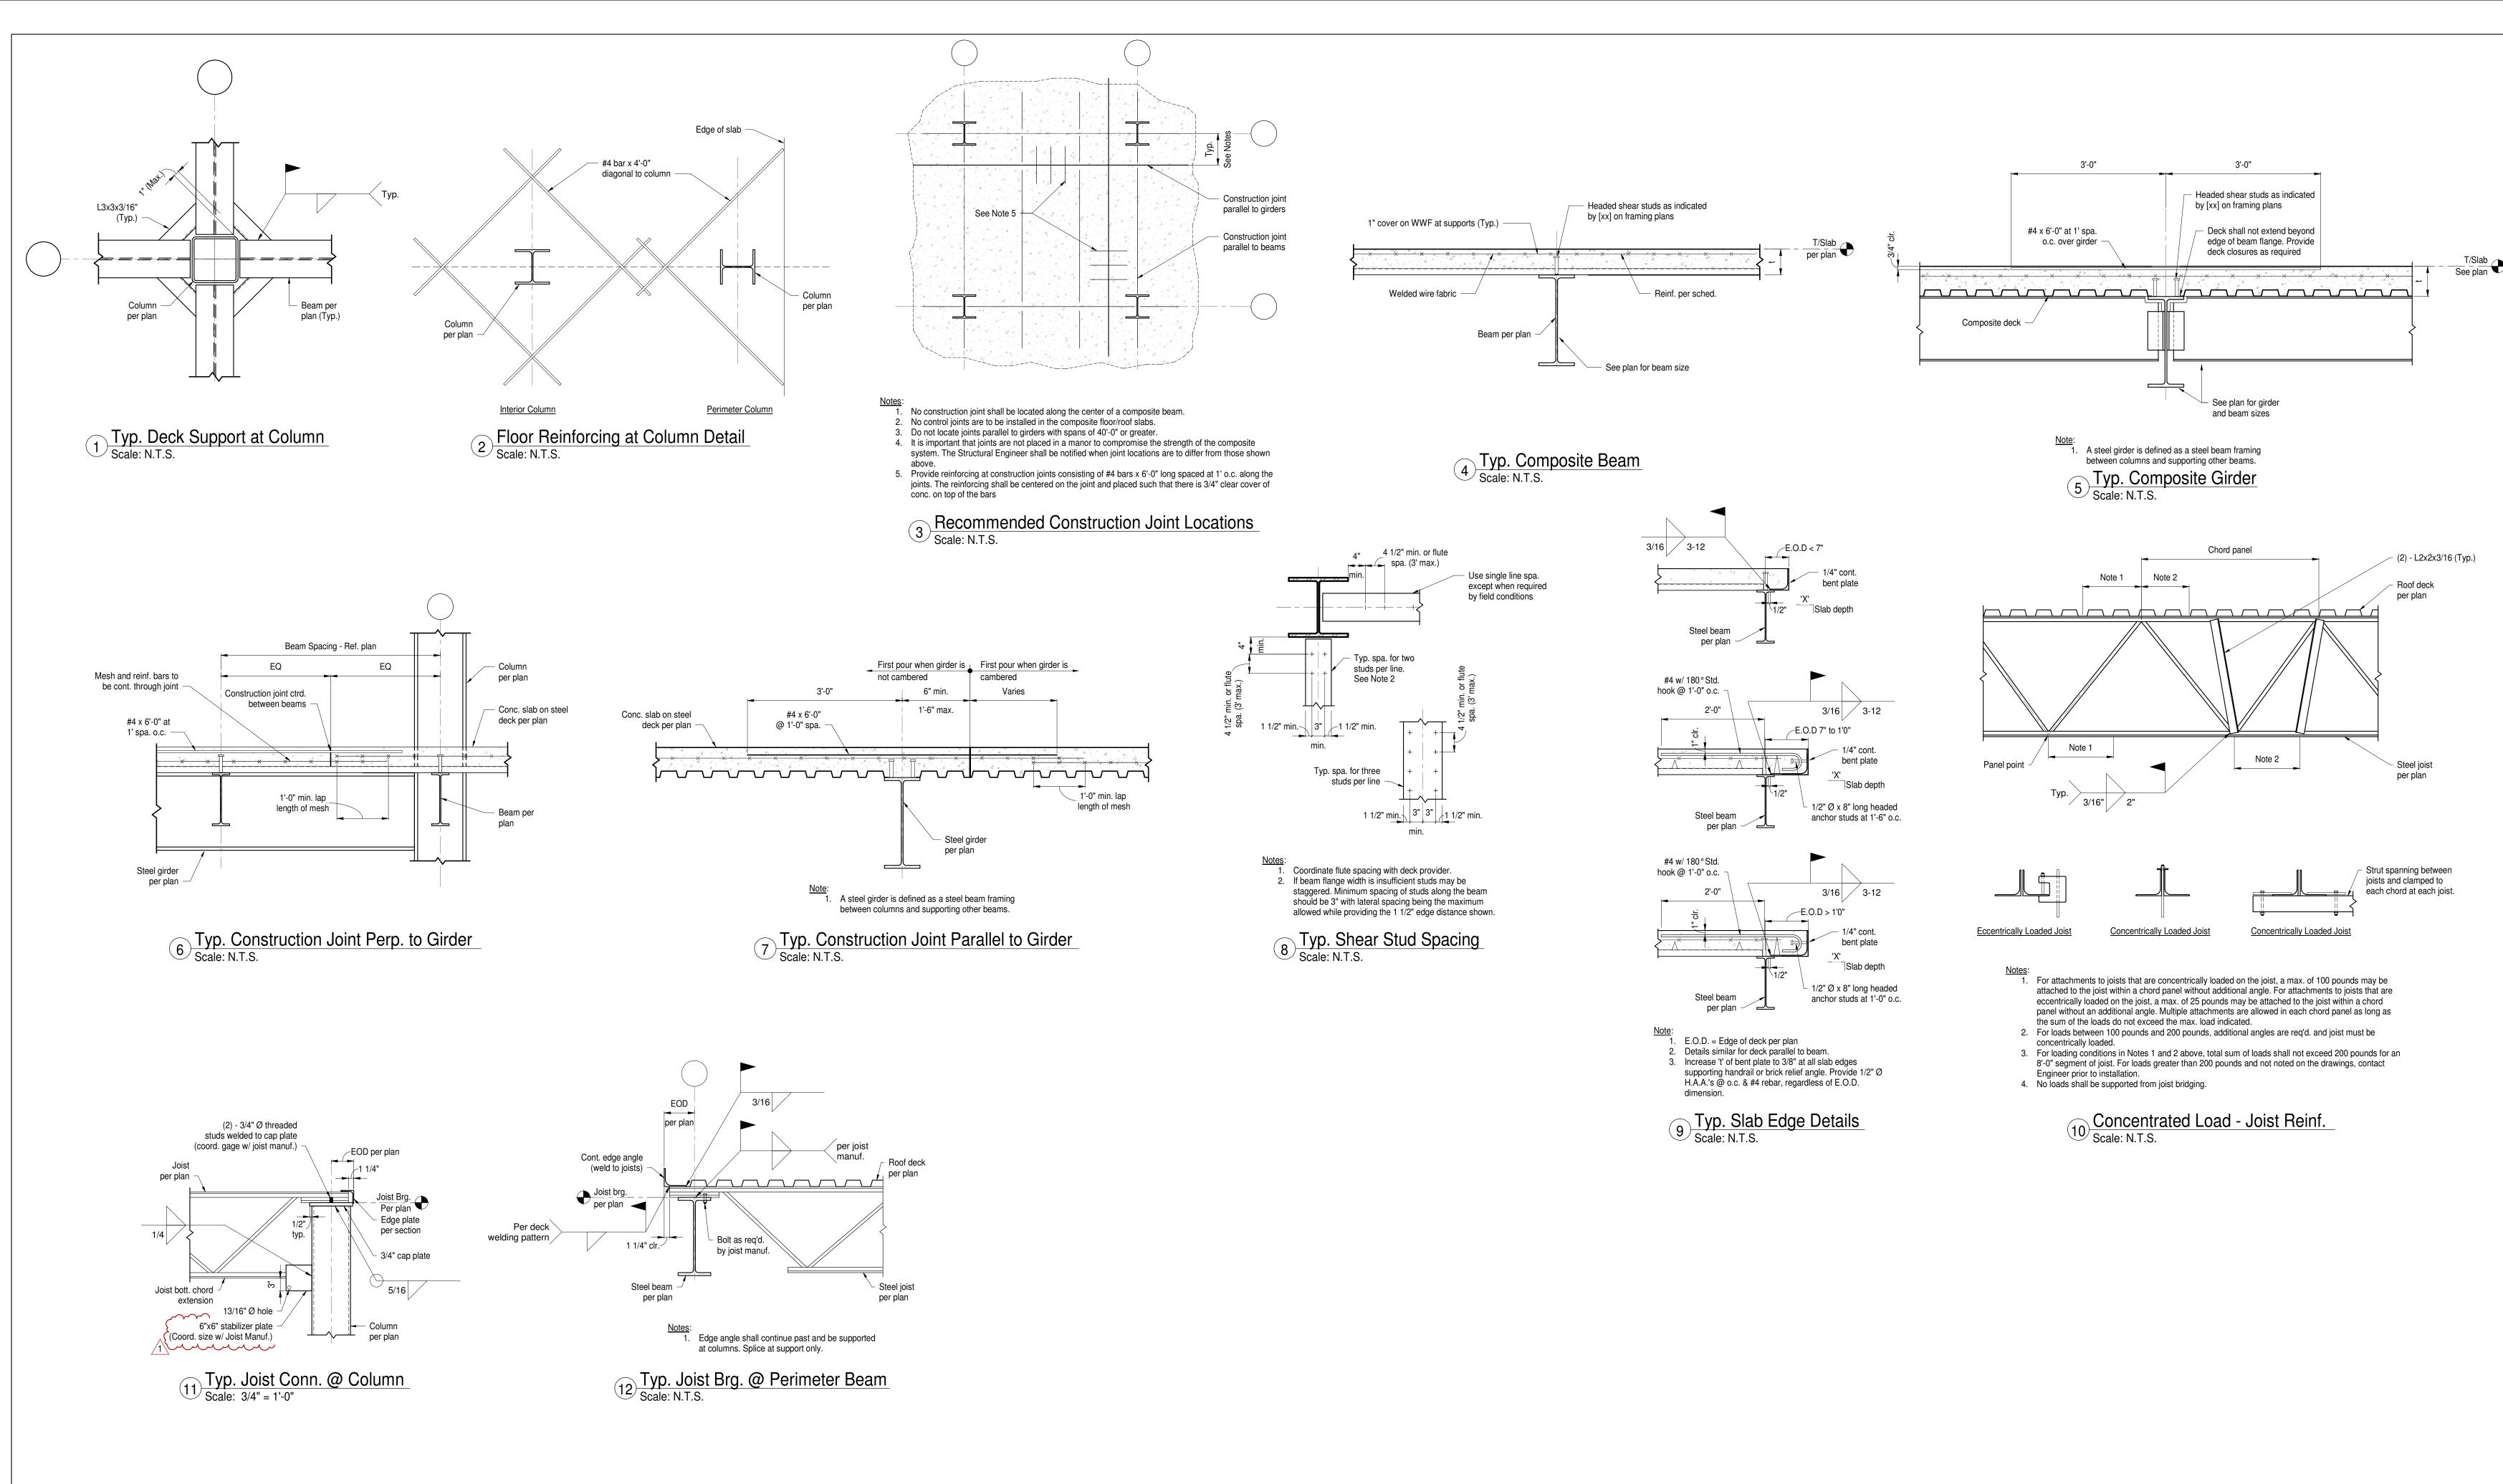



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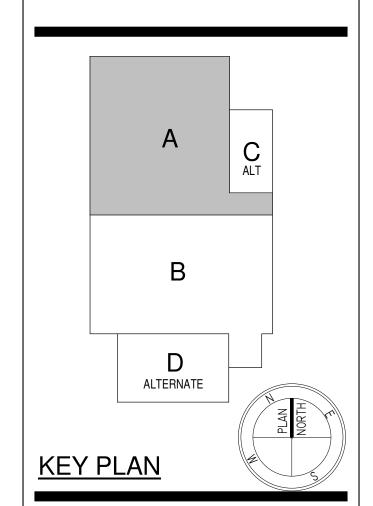
ARCHITECT

FANNING HOWEY


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CONSULTANT





Construction Documents

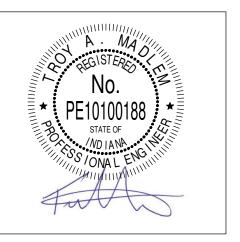

PROJECT MANAGER: JAA

DRAWN BY: TCM


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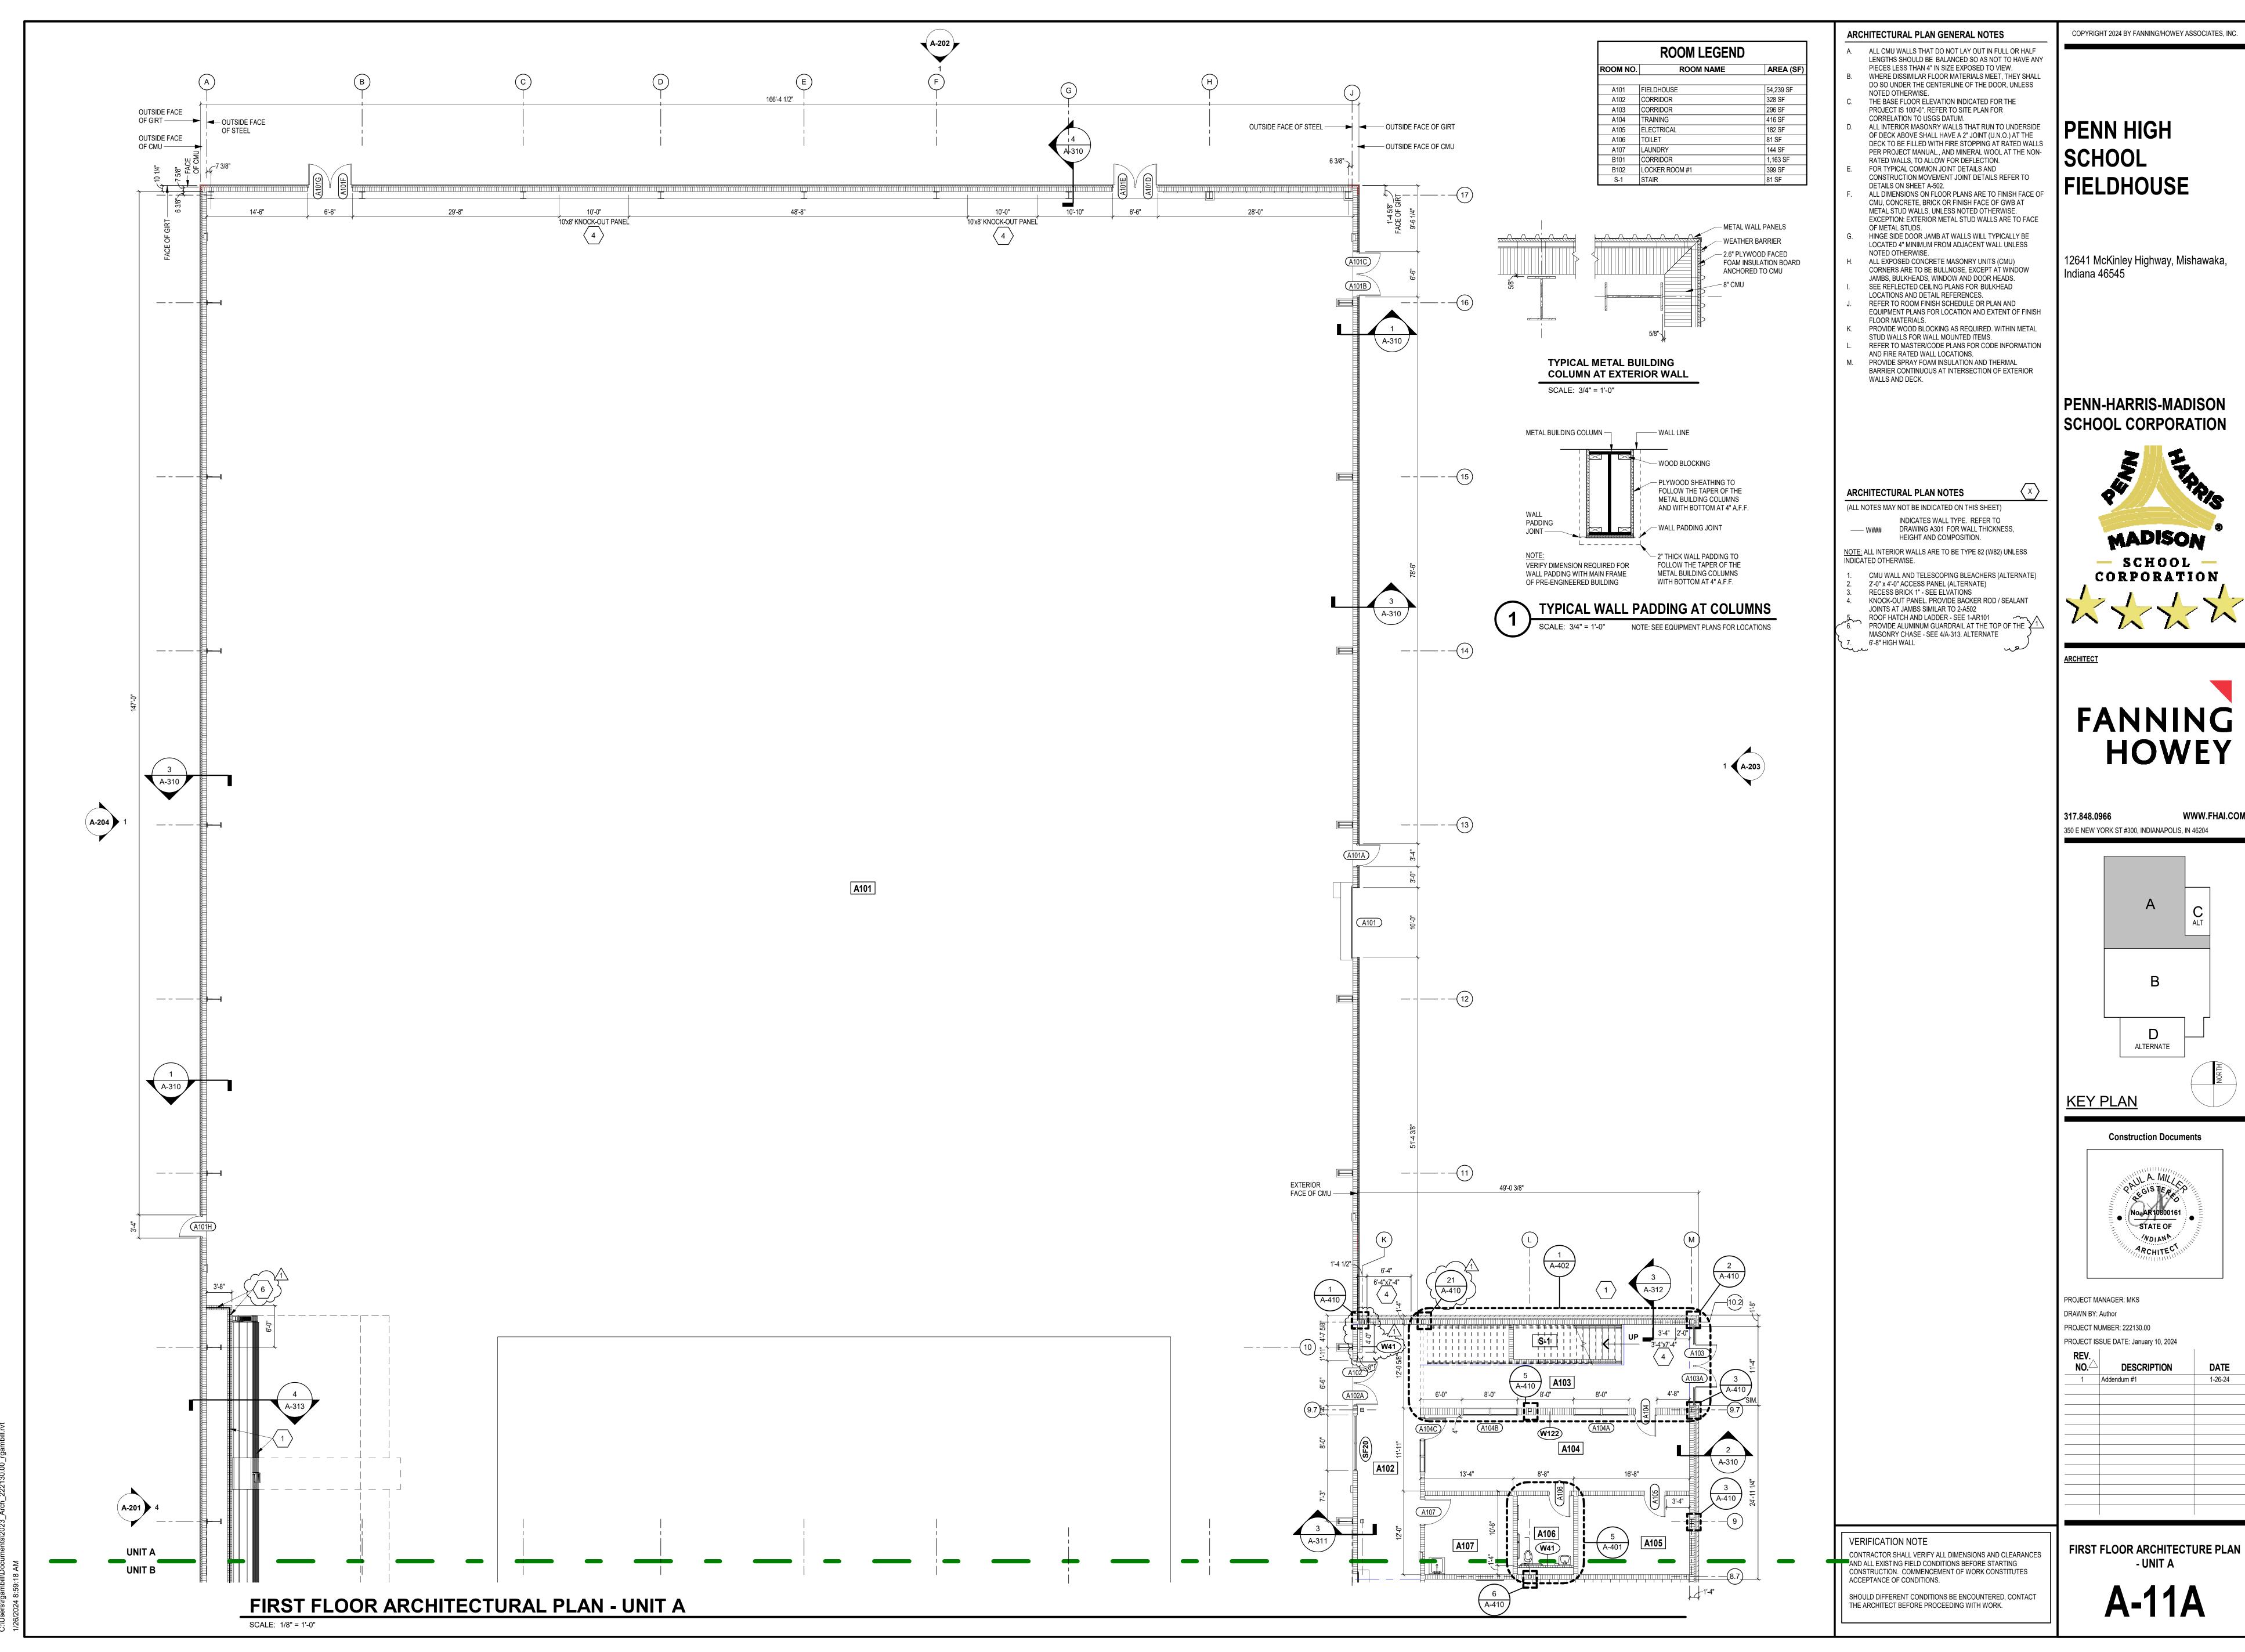
PROJECT ISSUE DATE: January 10, 2024


REV. NO.△	DESCRIPTION	DATE
1	Addendum #1	01/26/2024

Typ. Steel Details


S-520




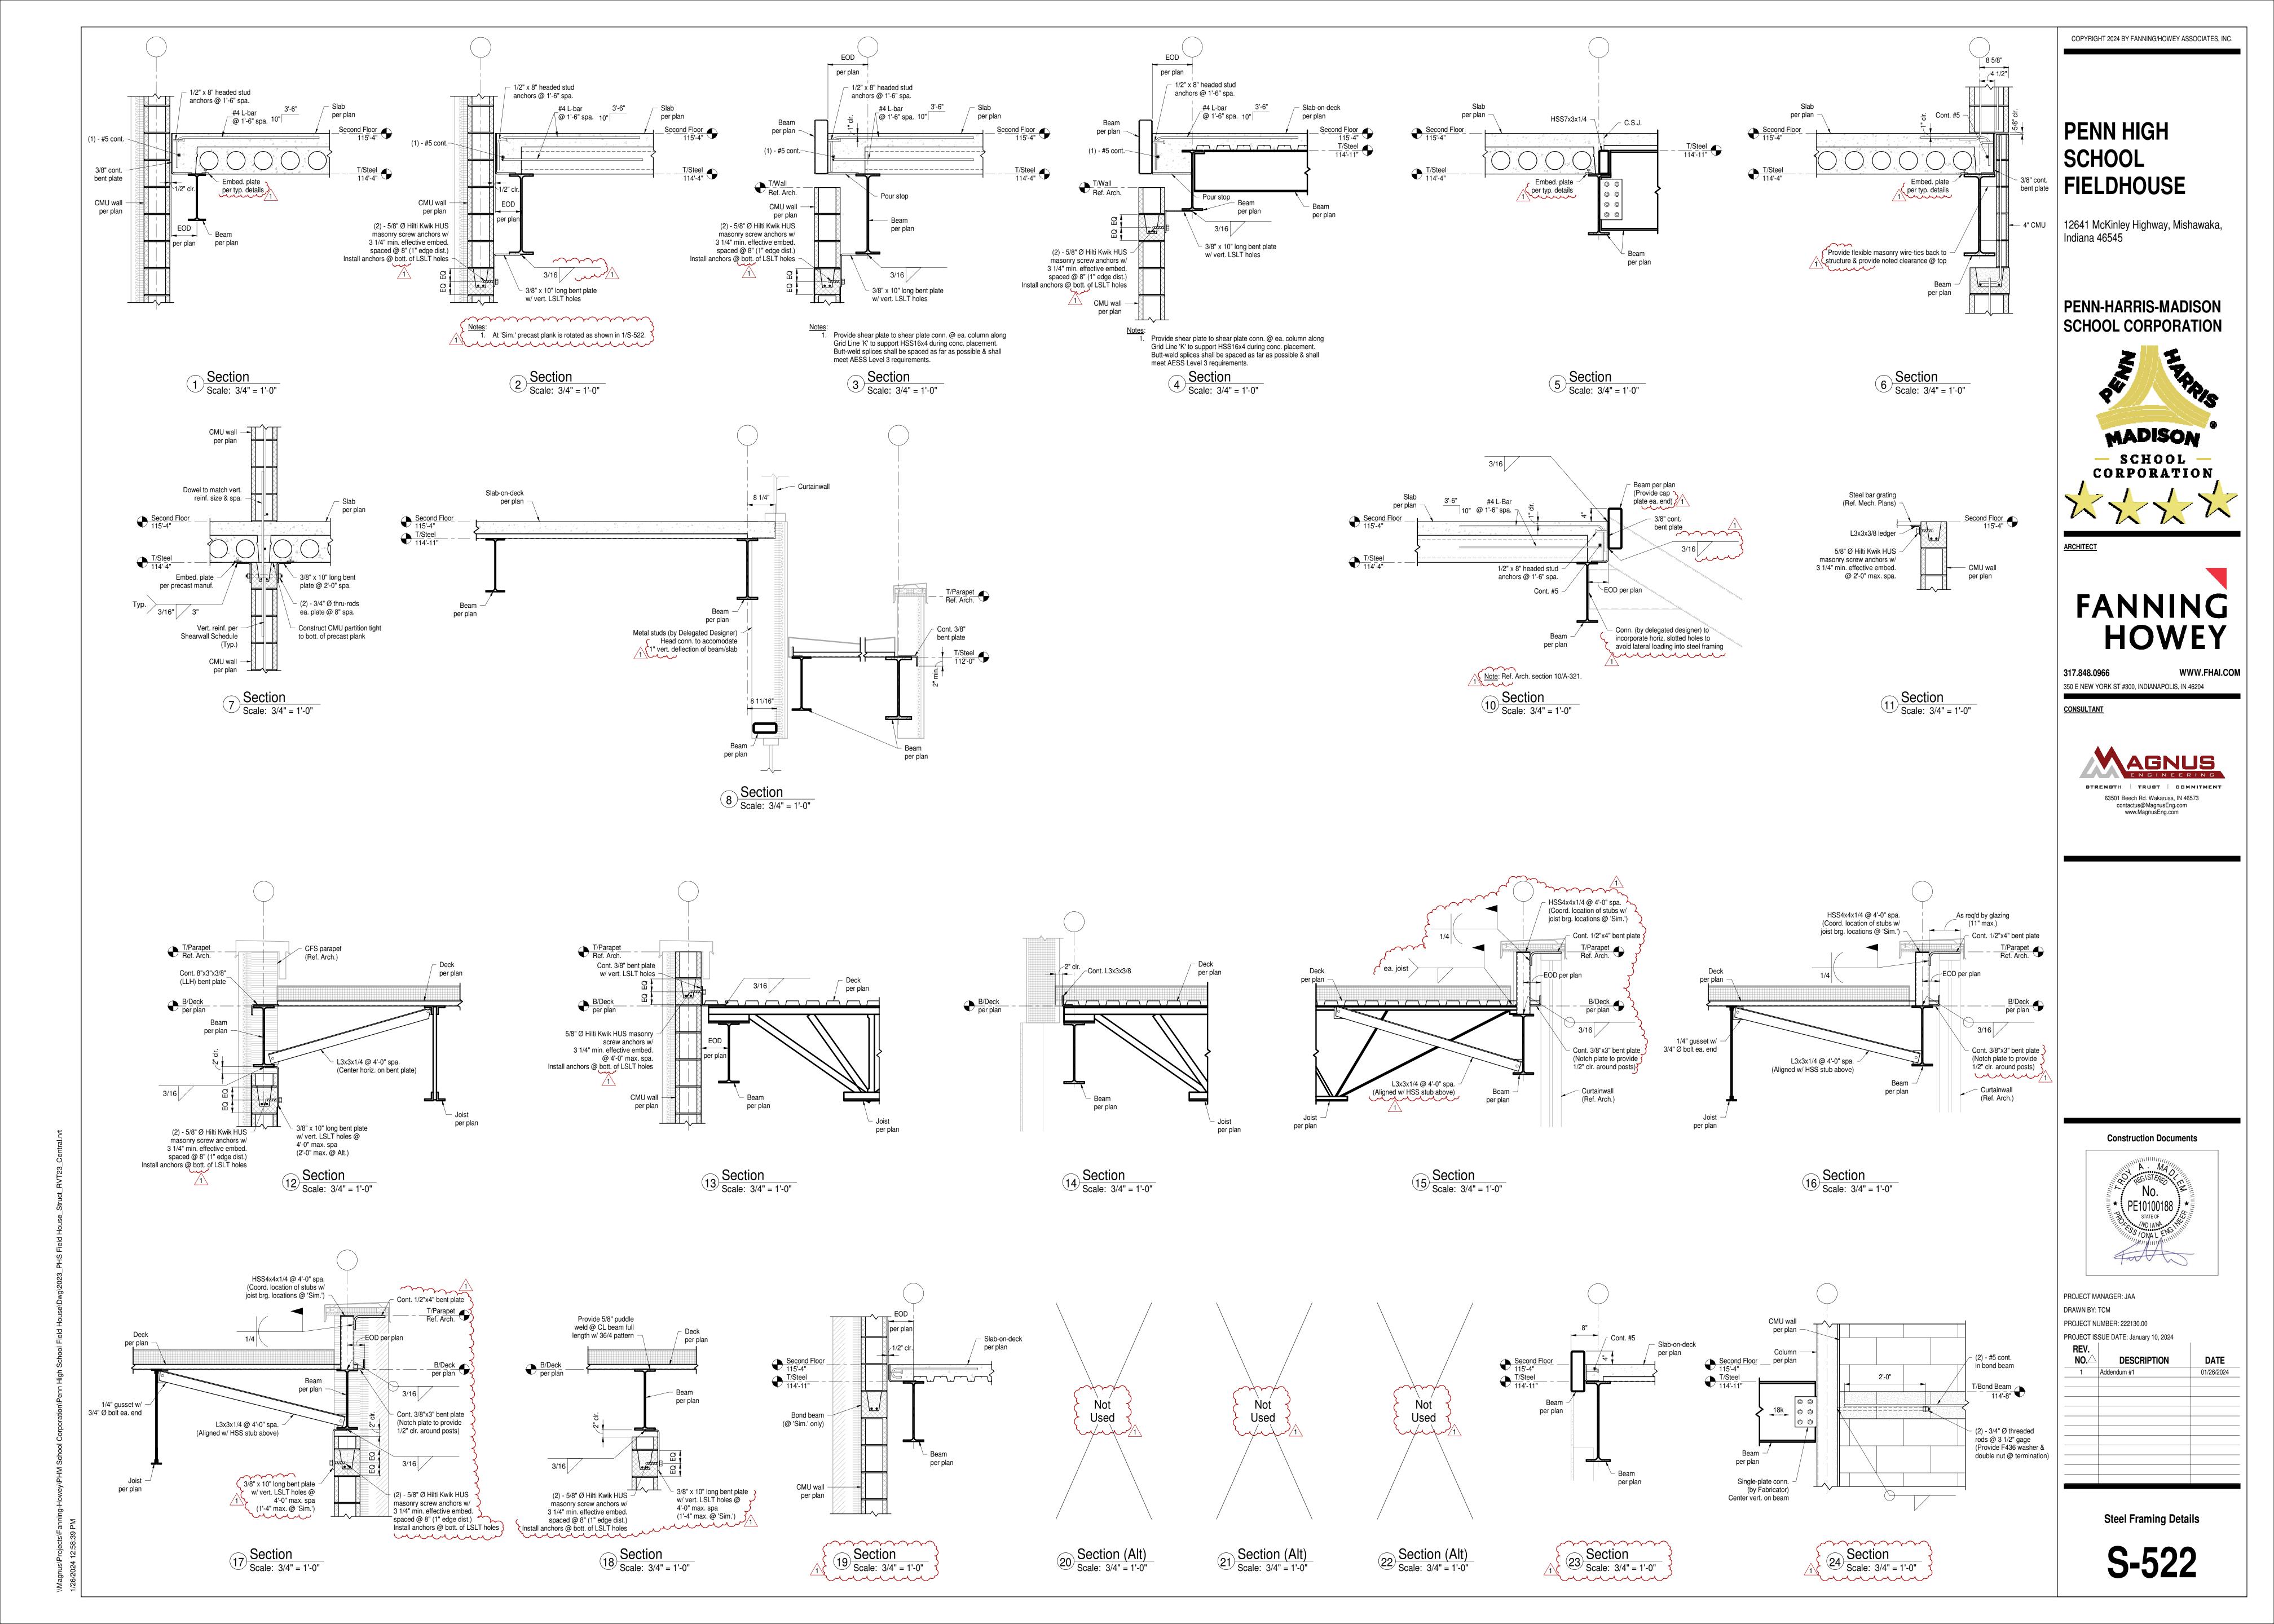


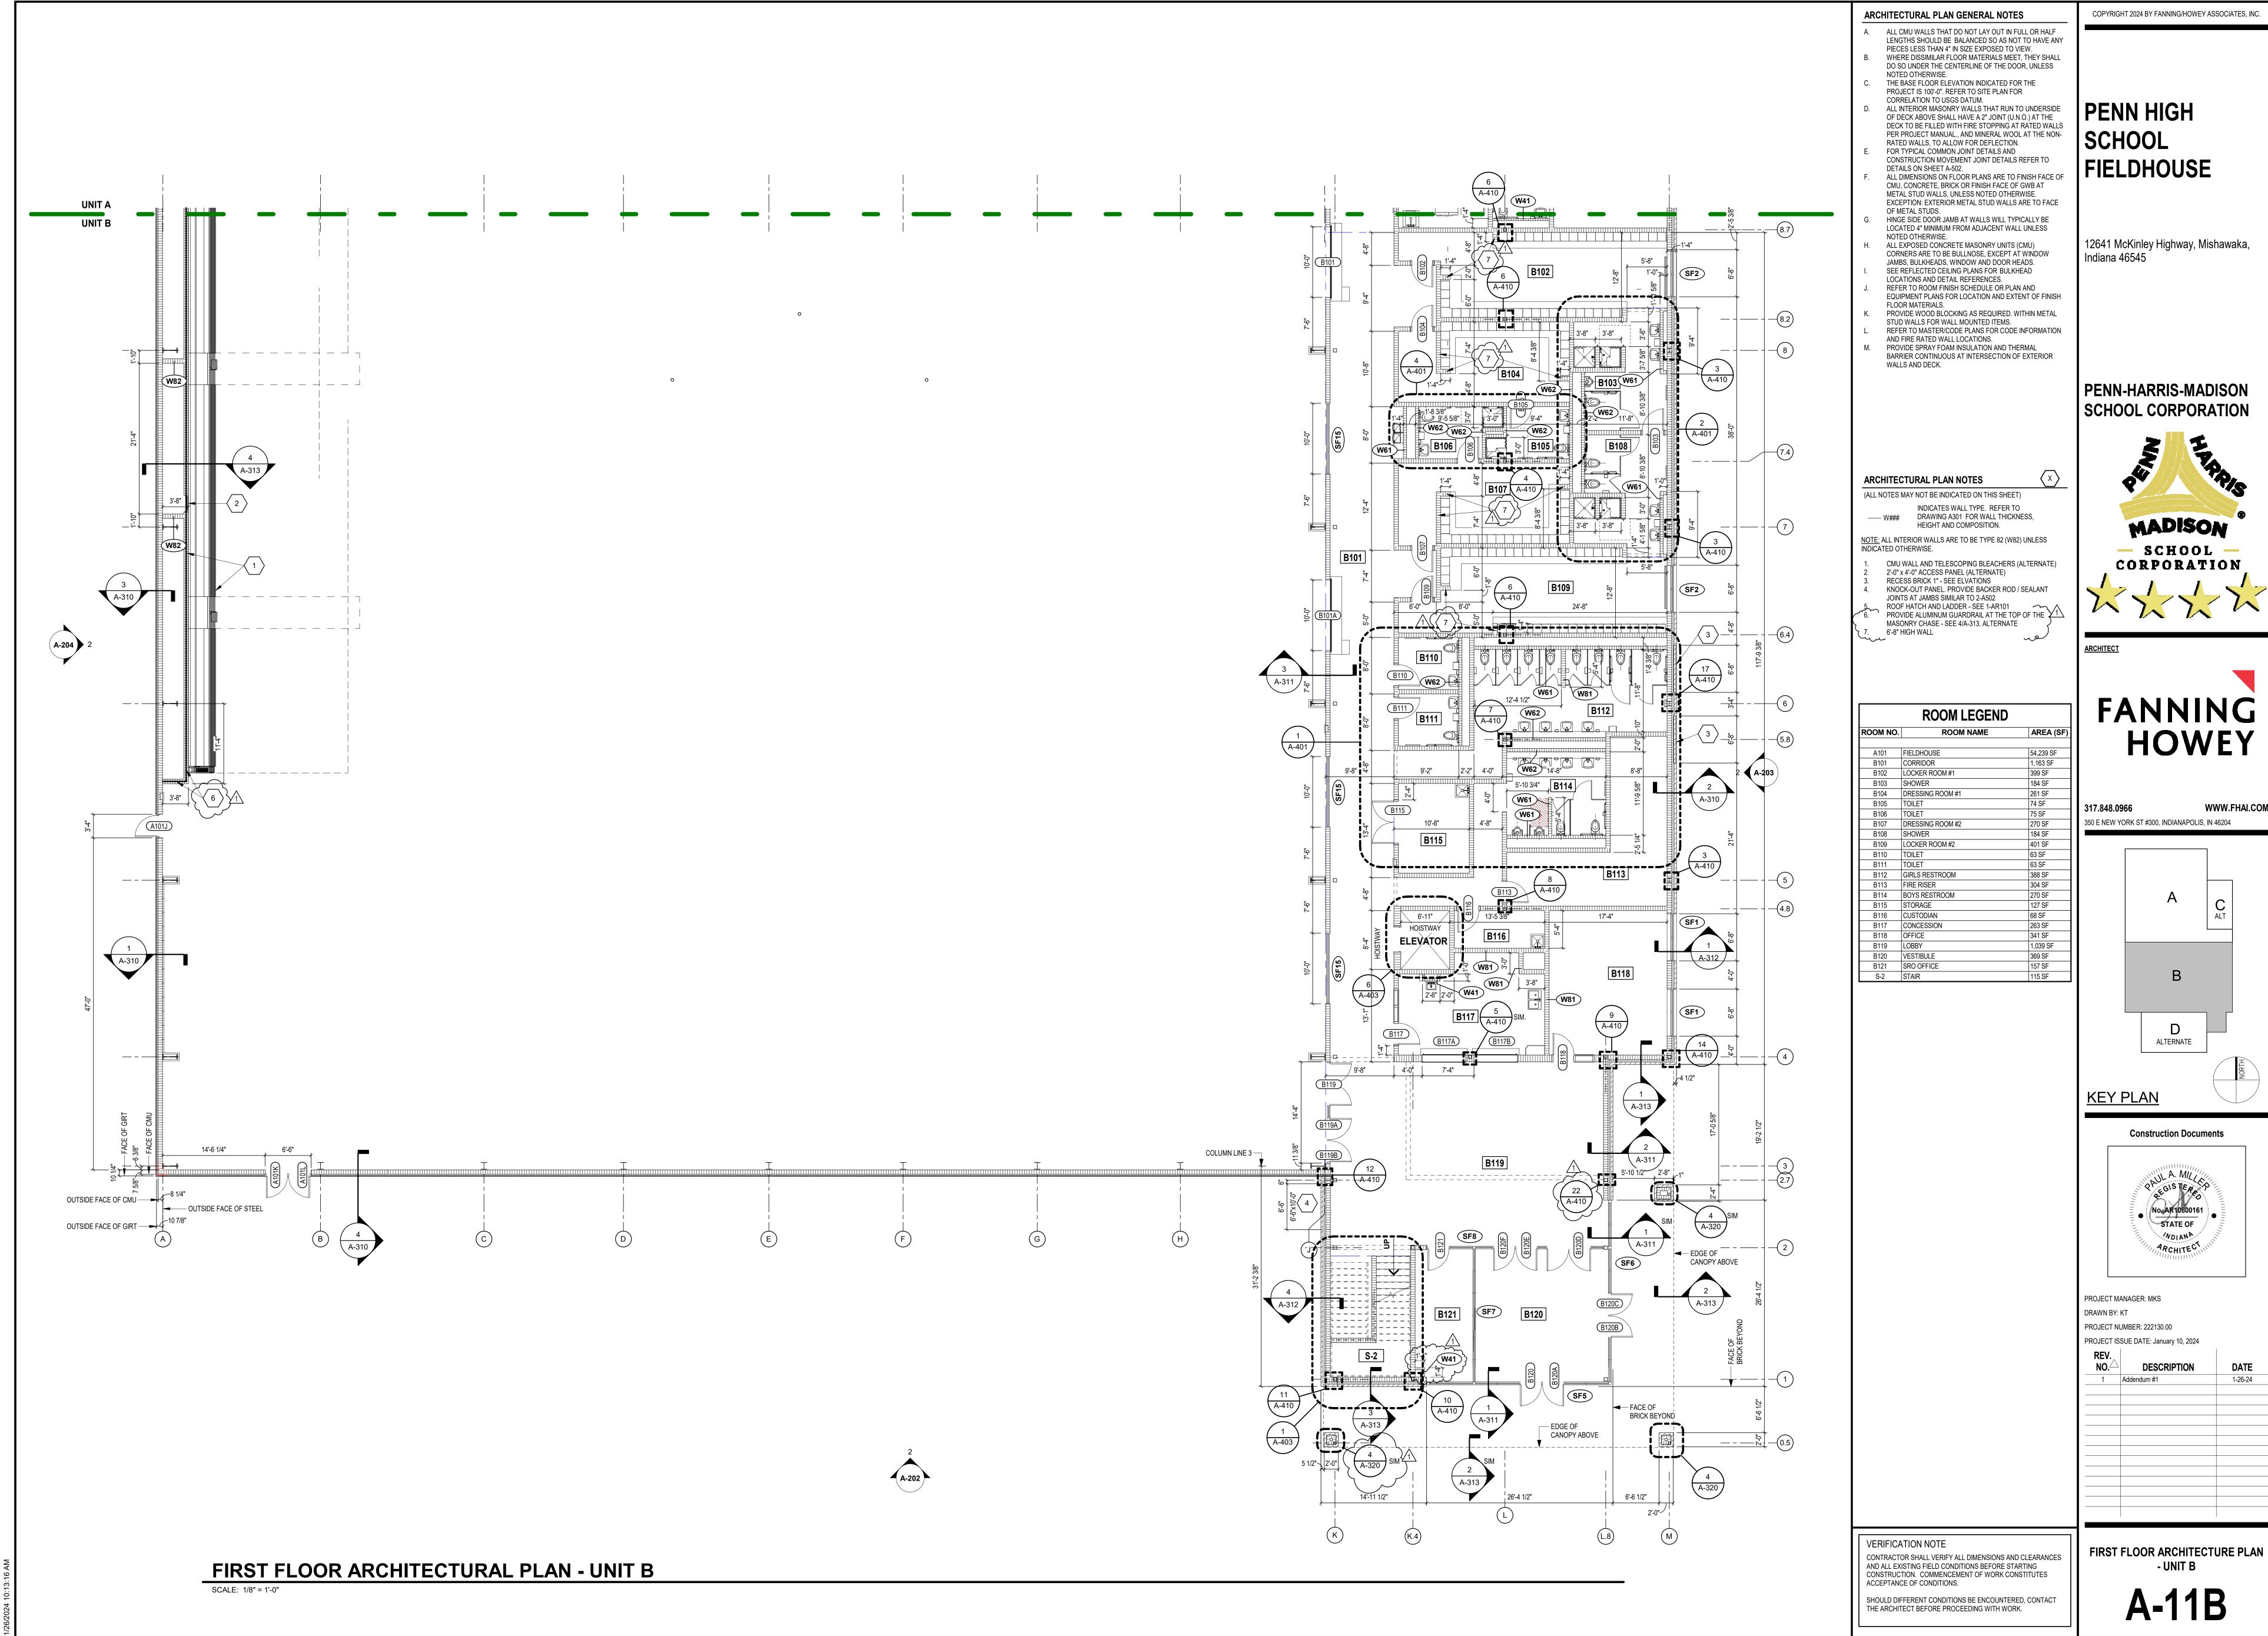


HOWEY

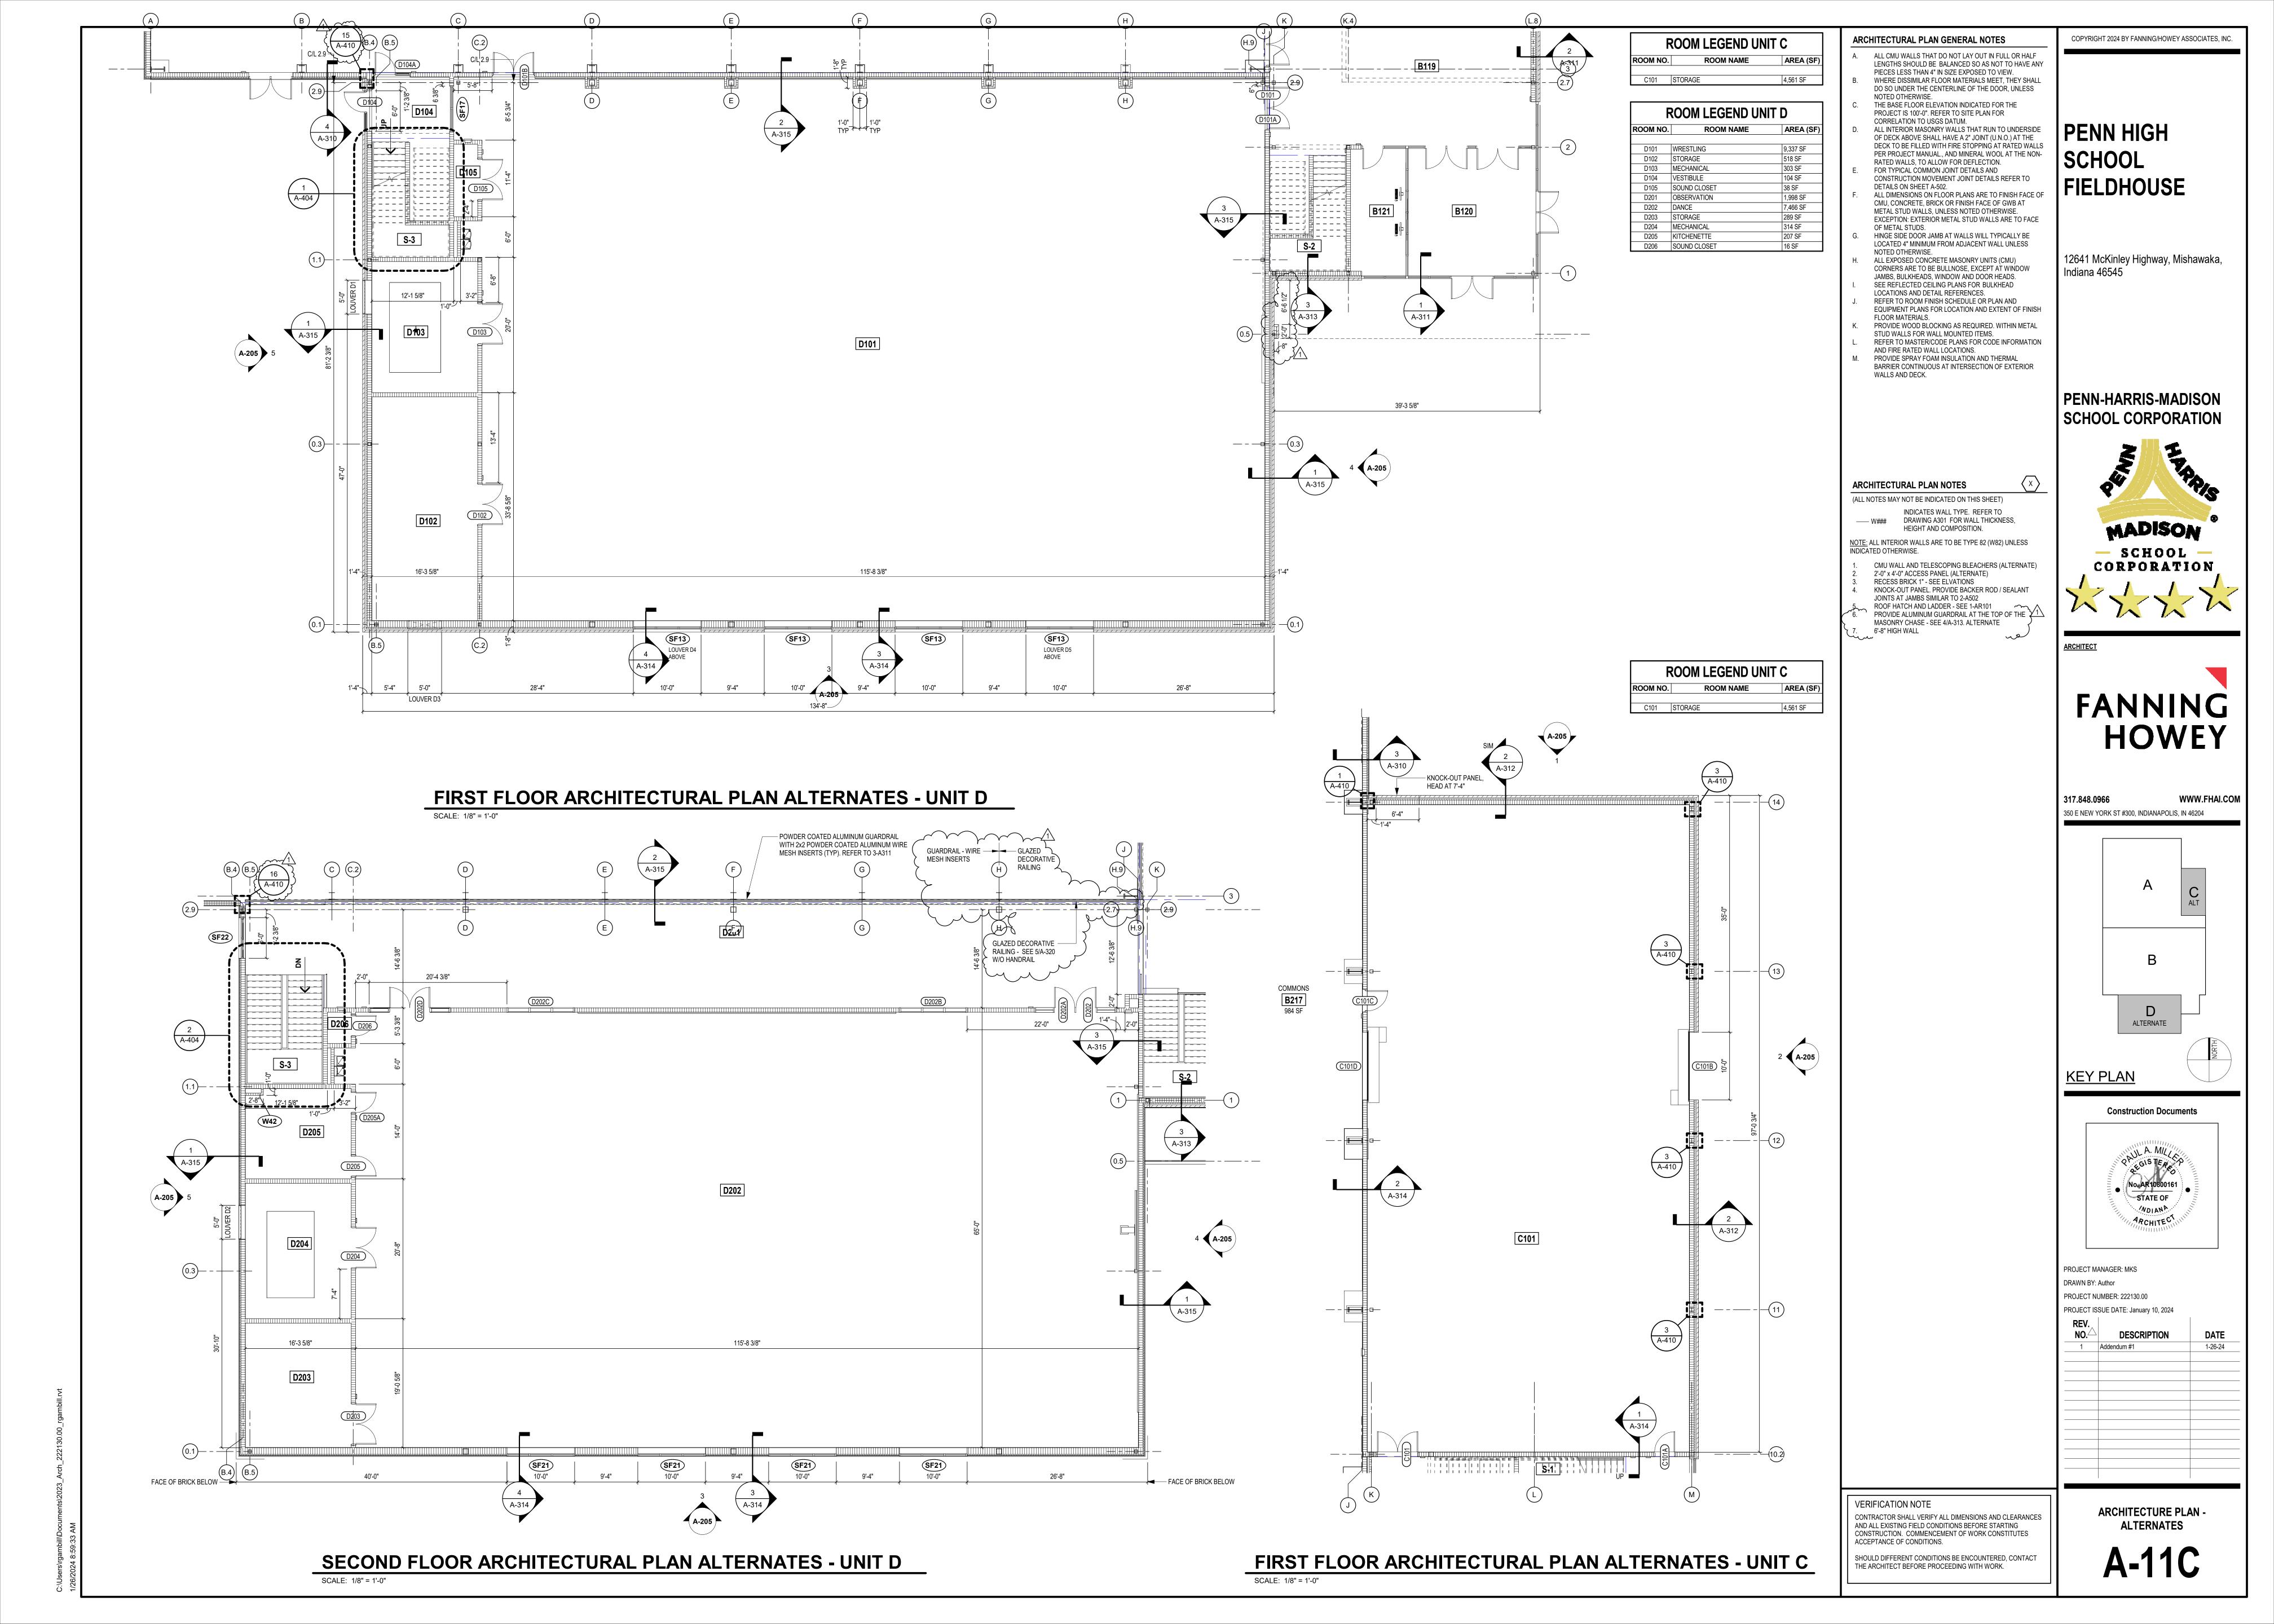


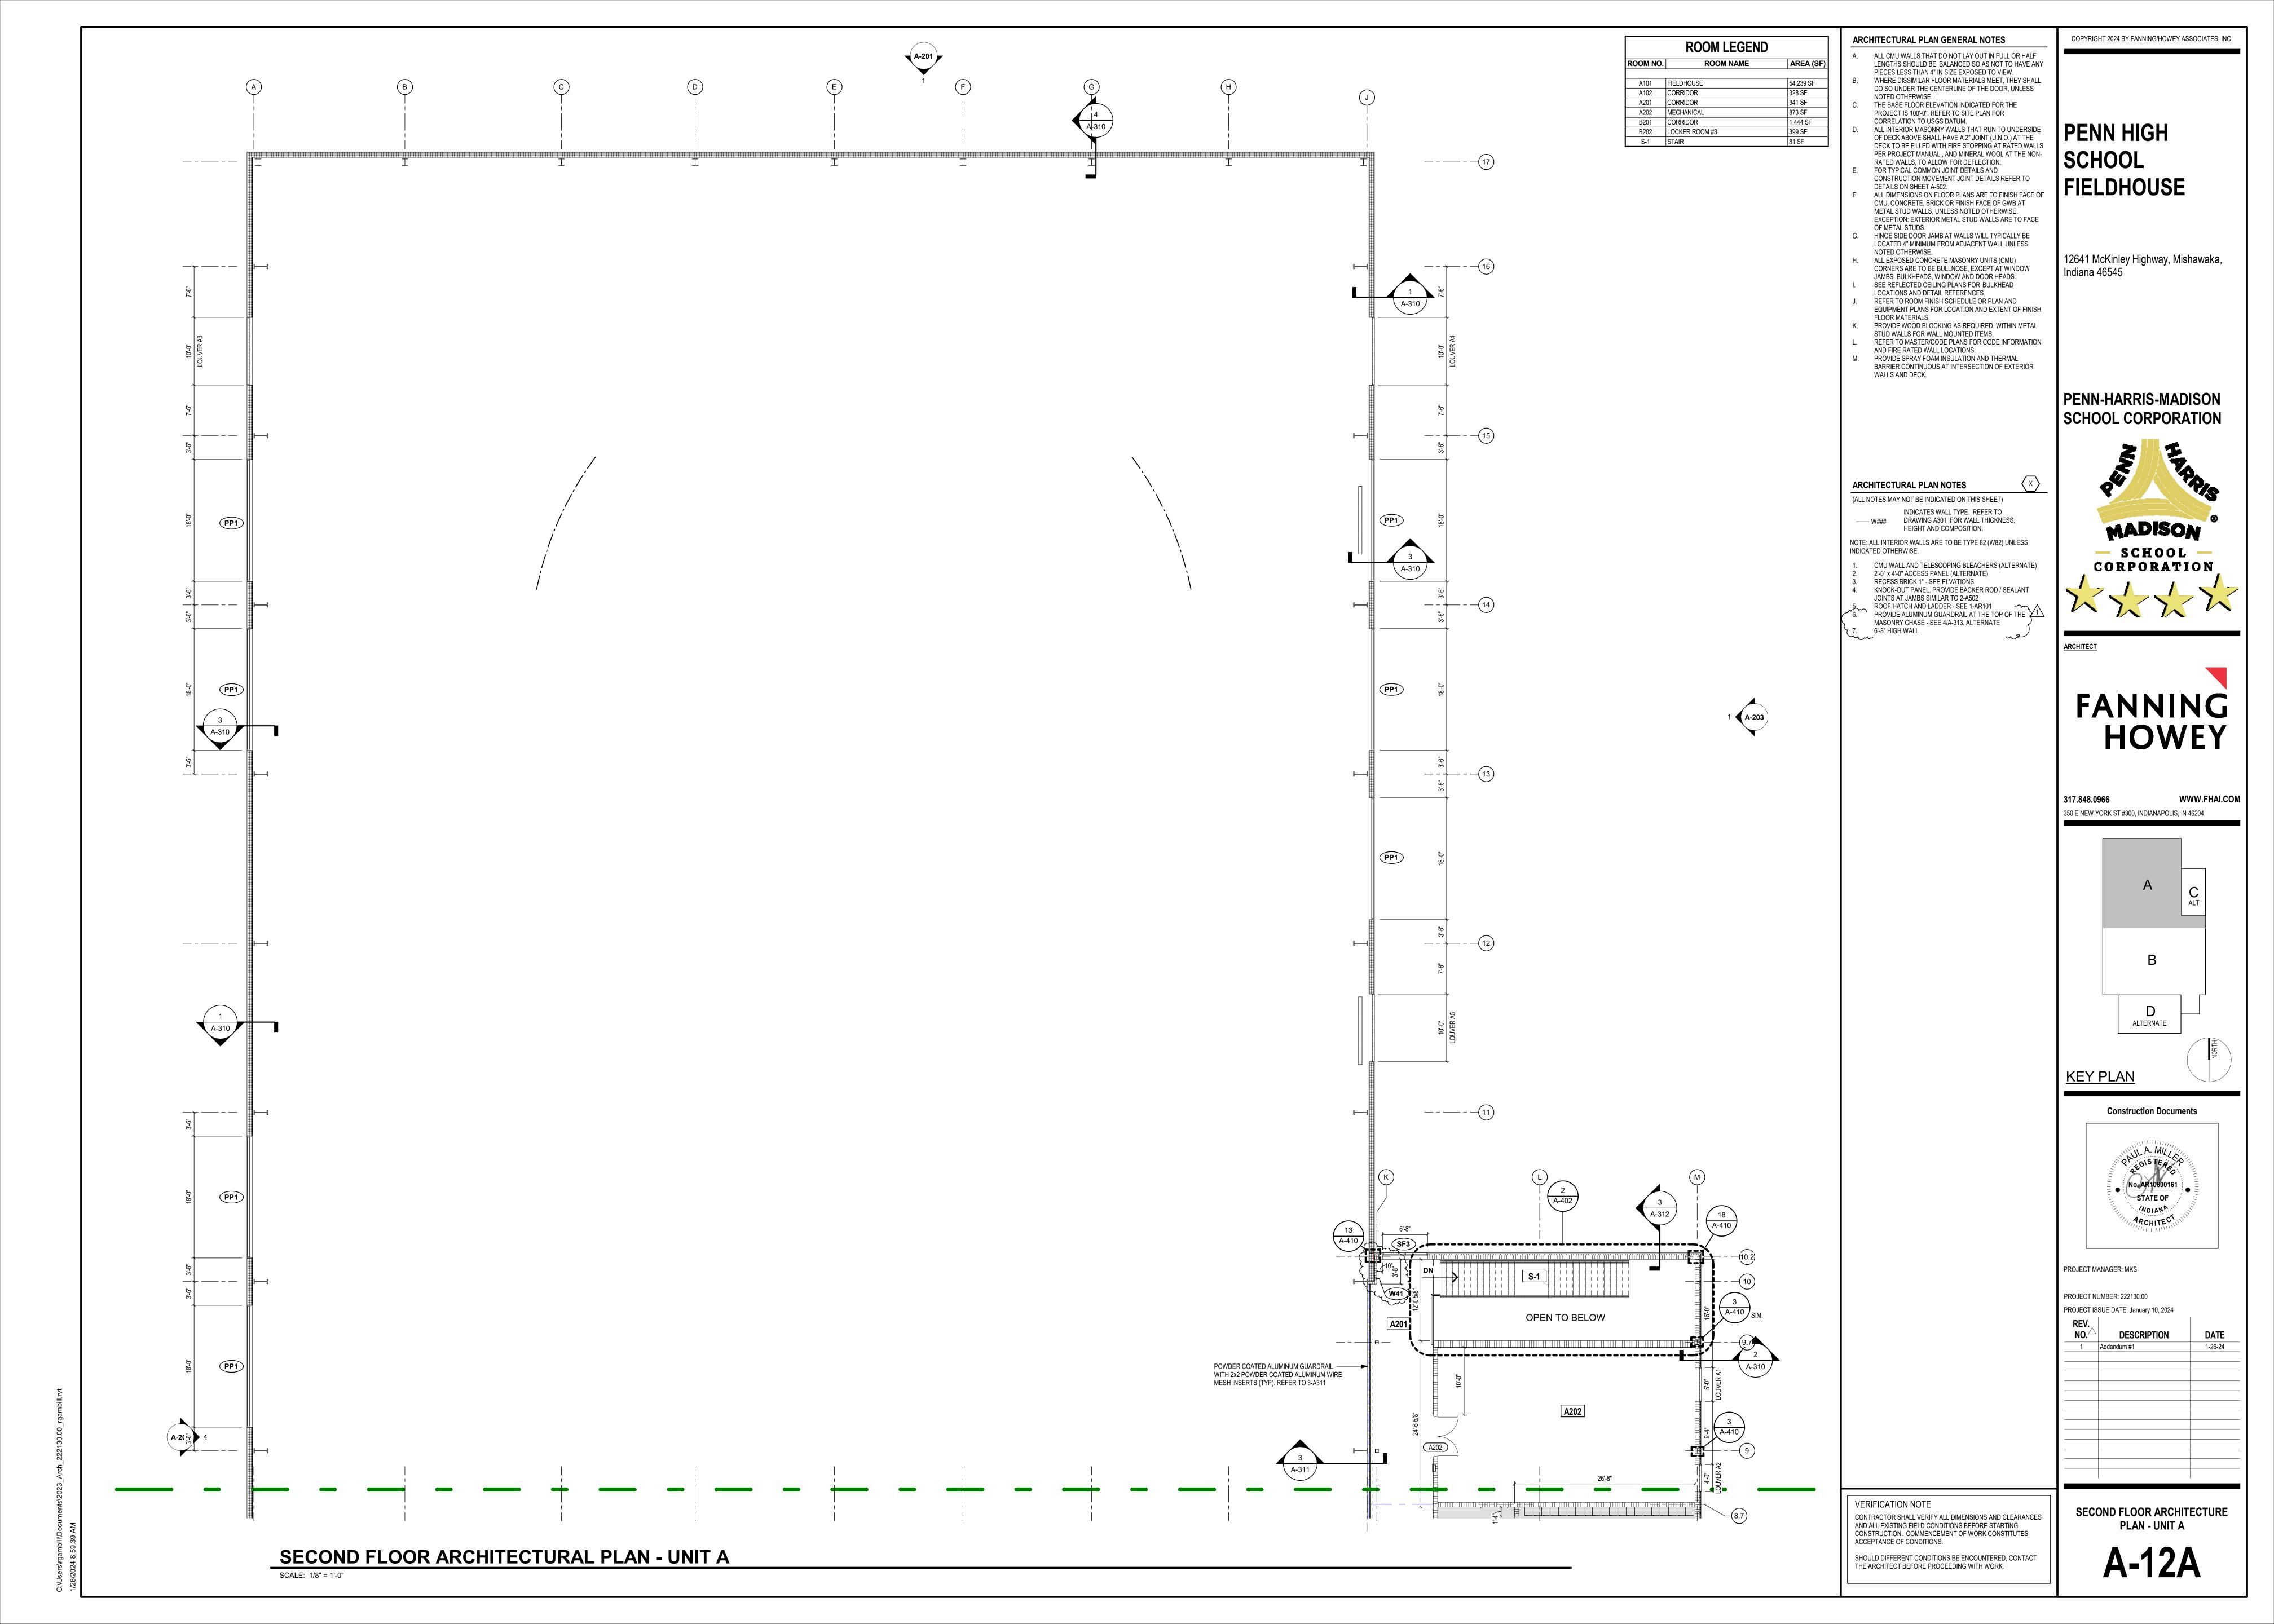

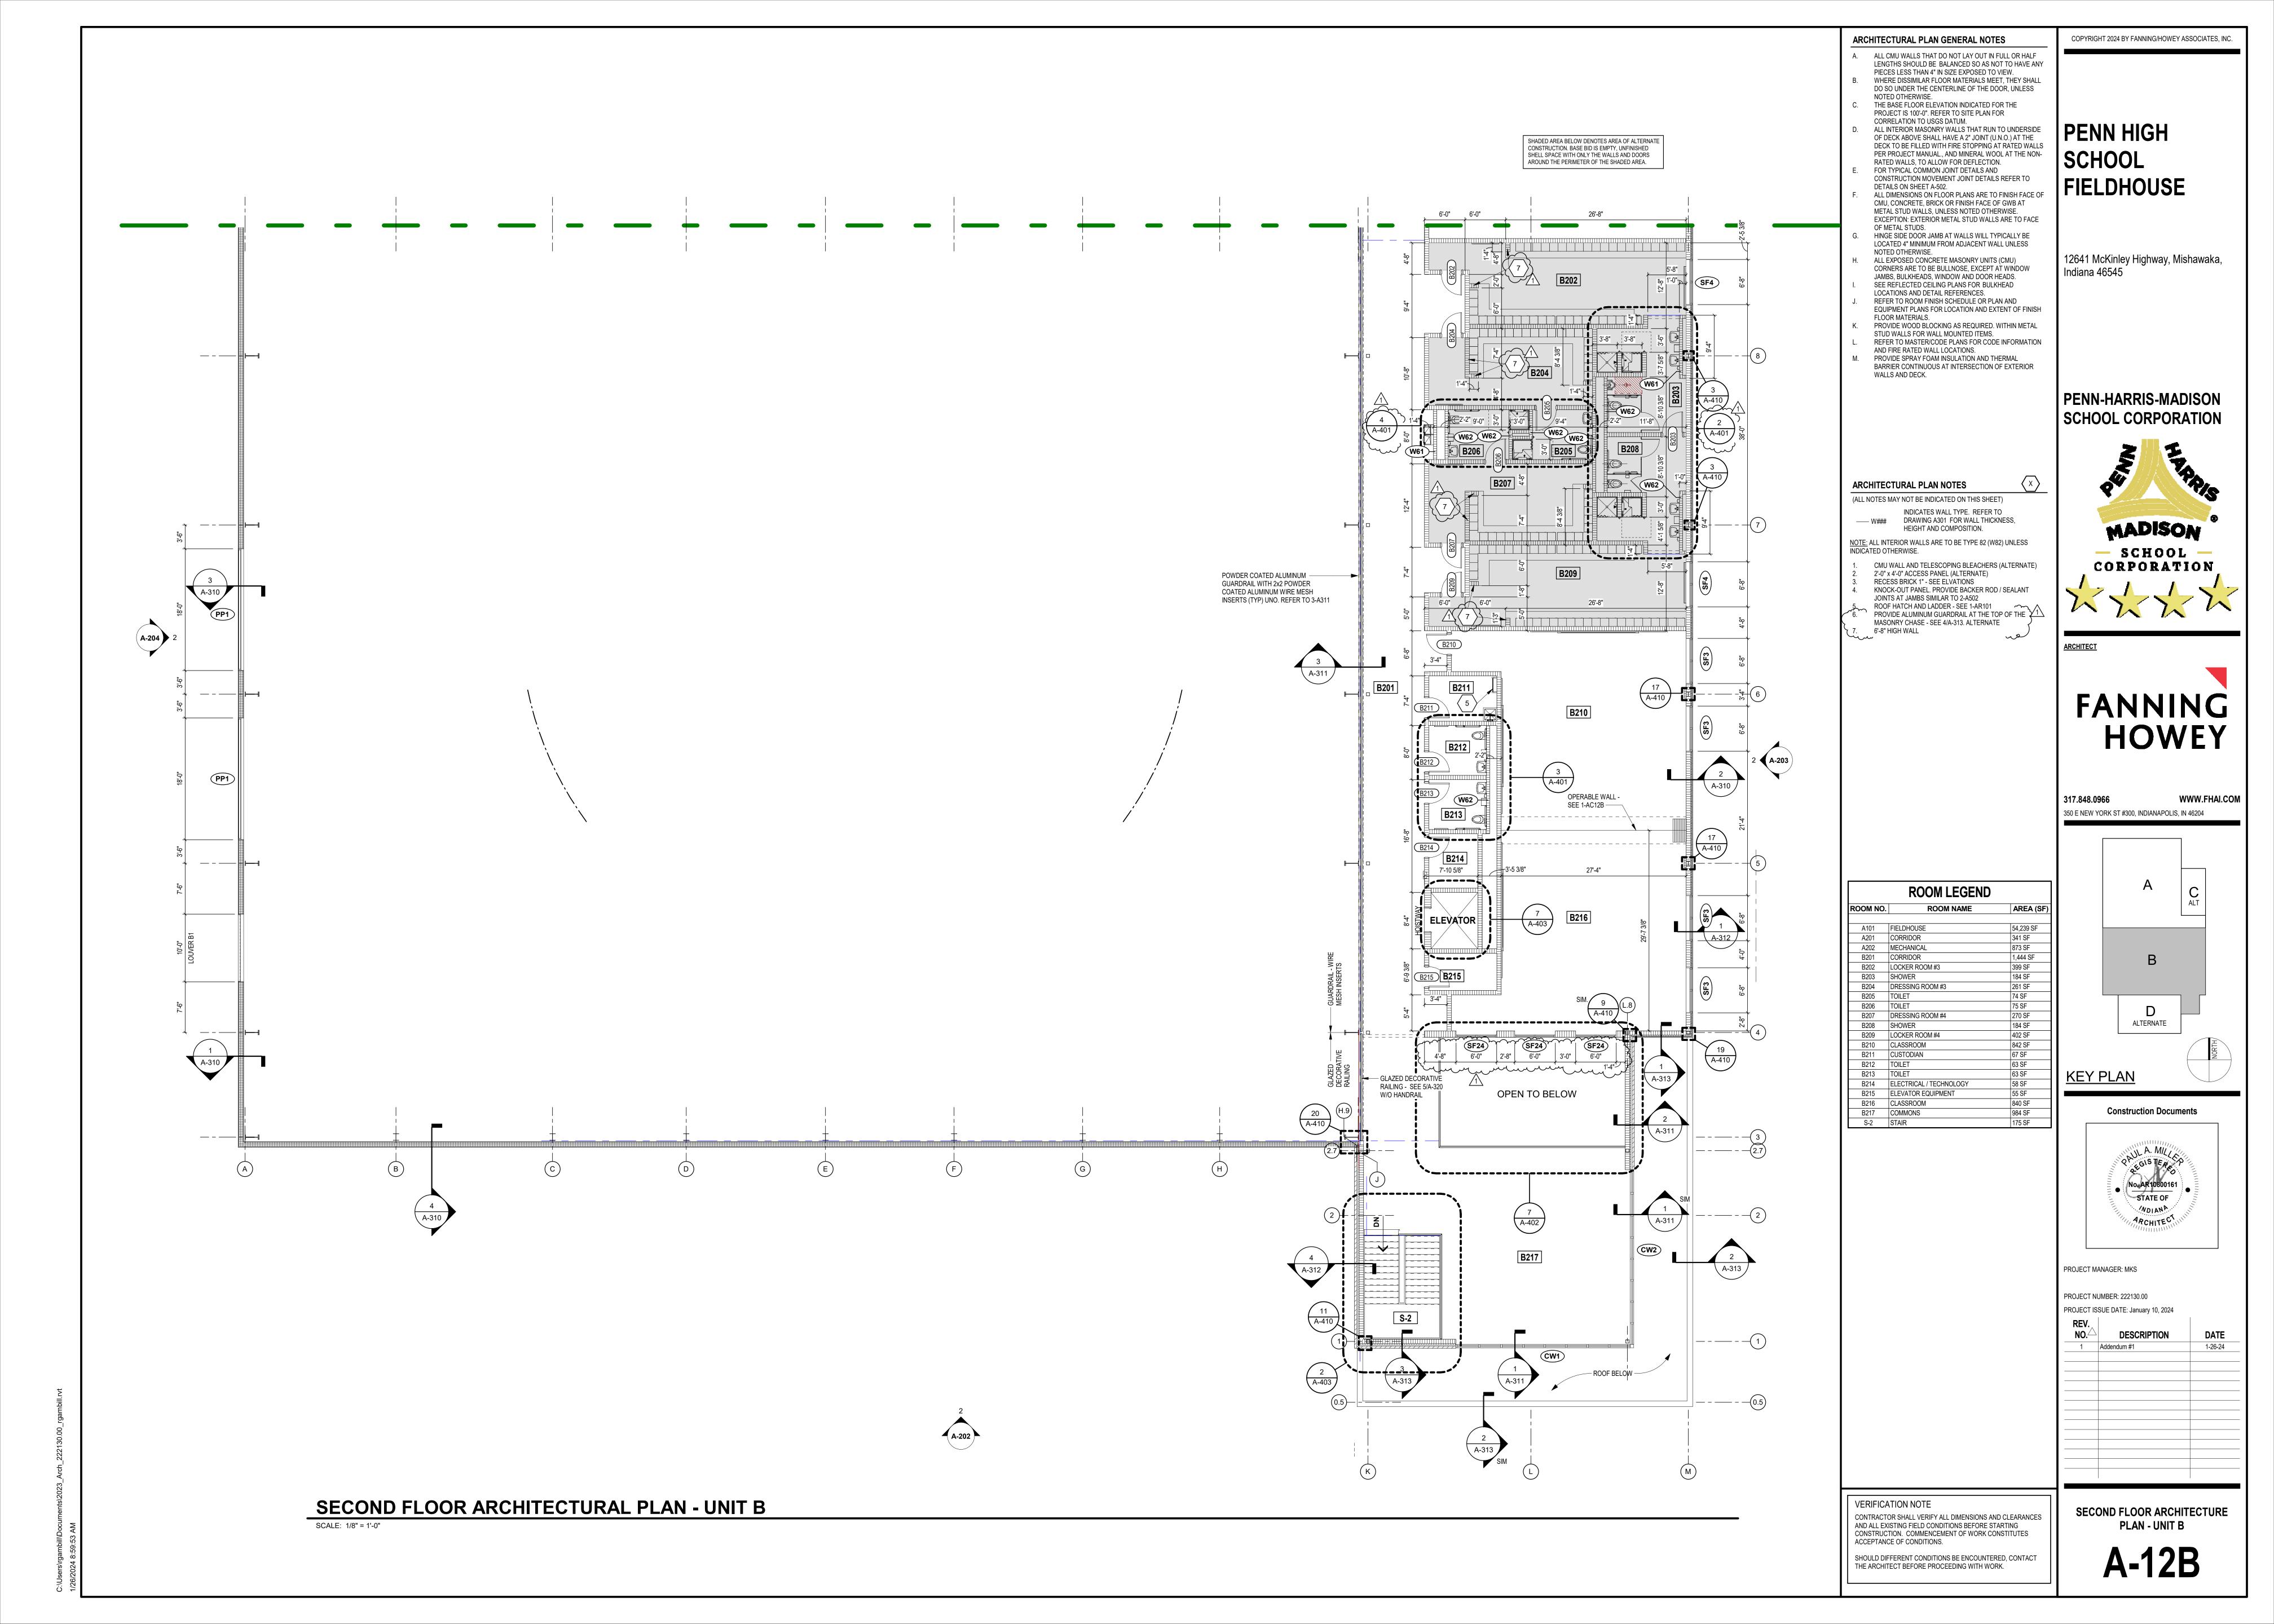

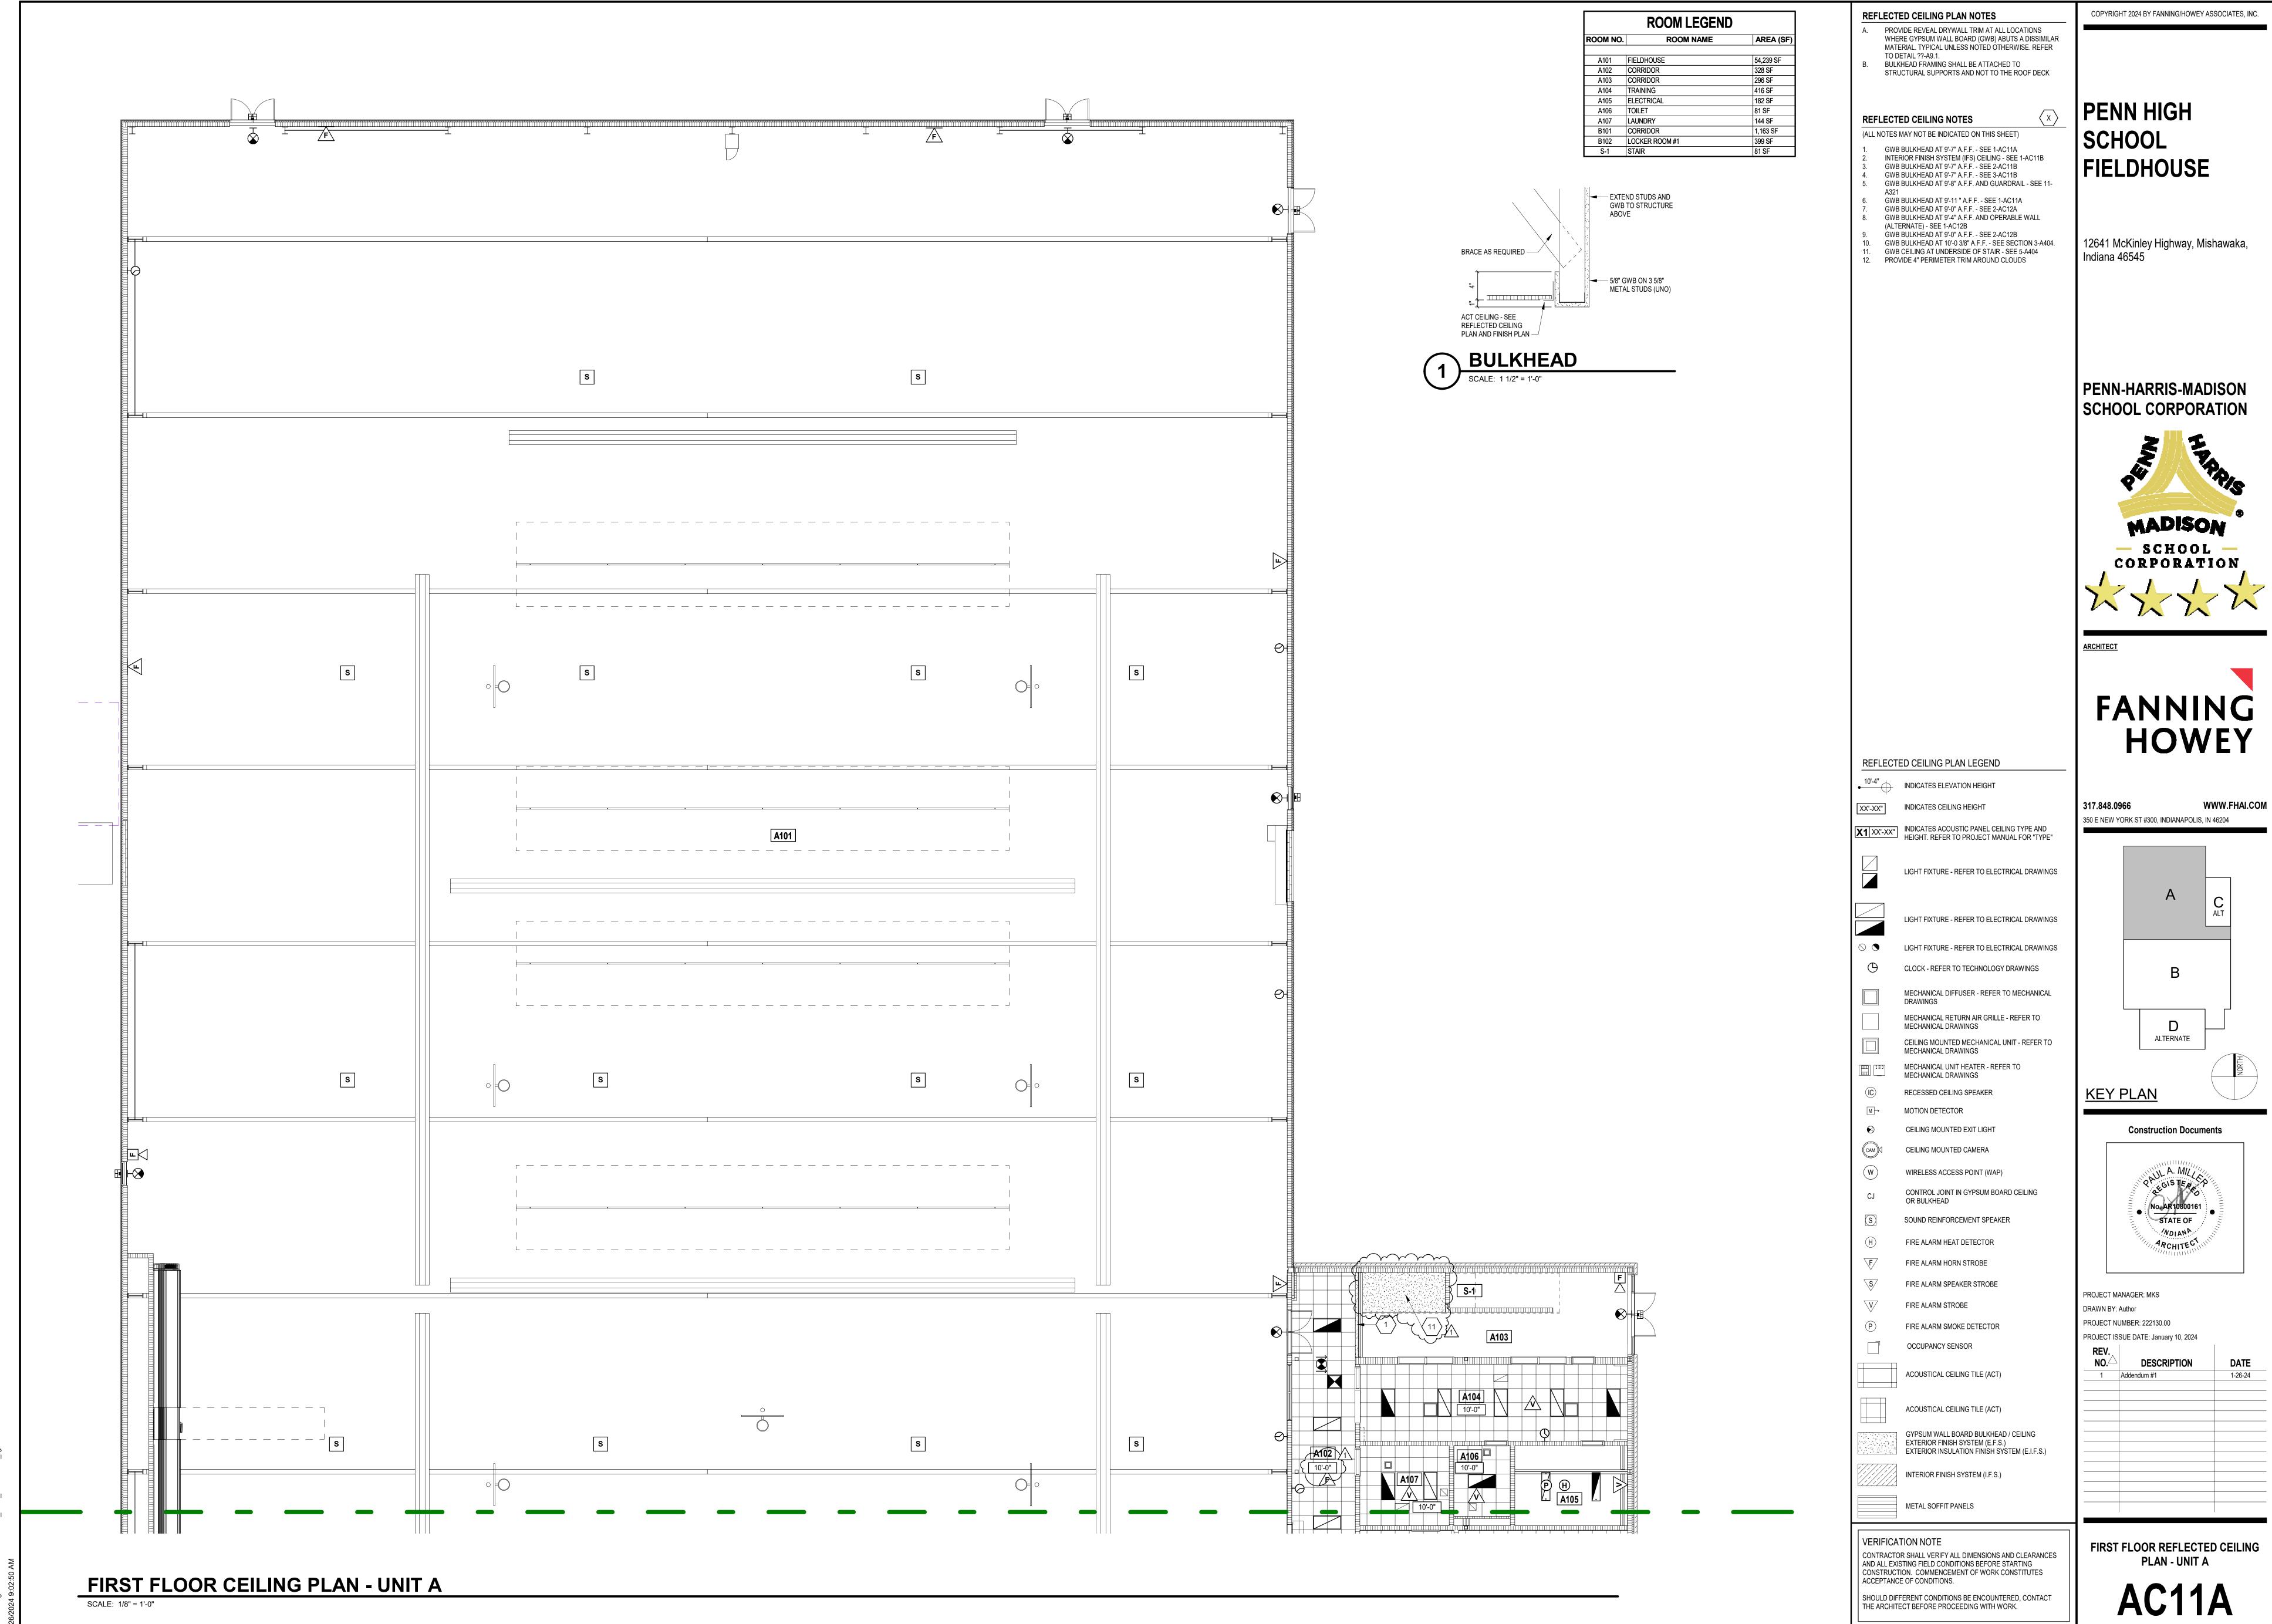



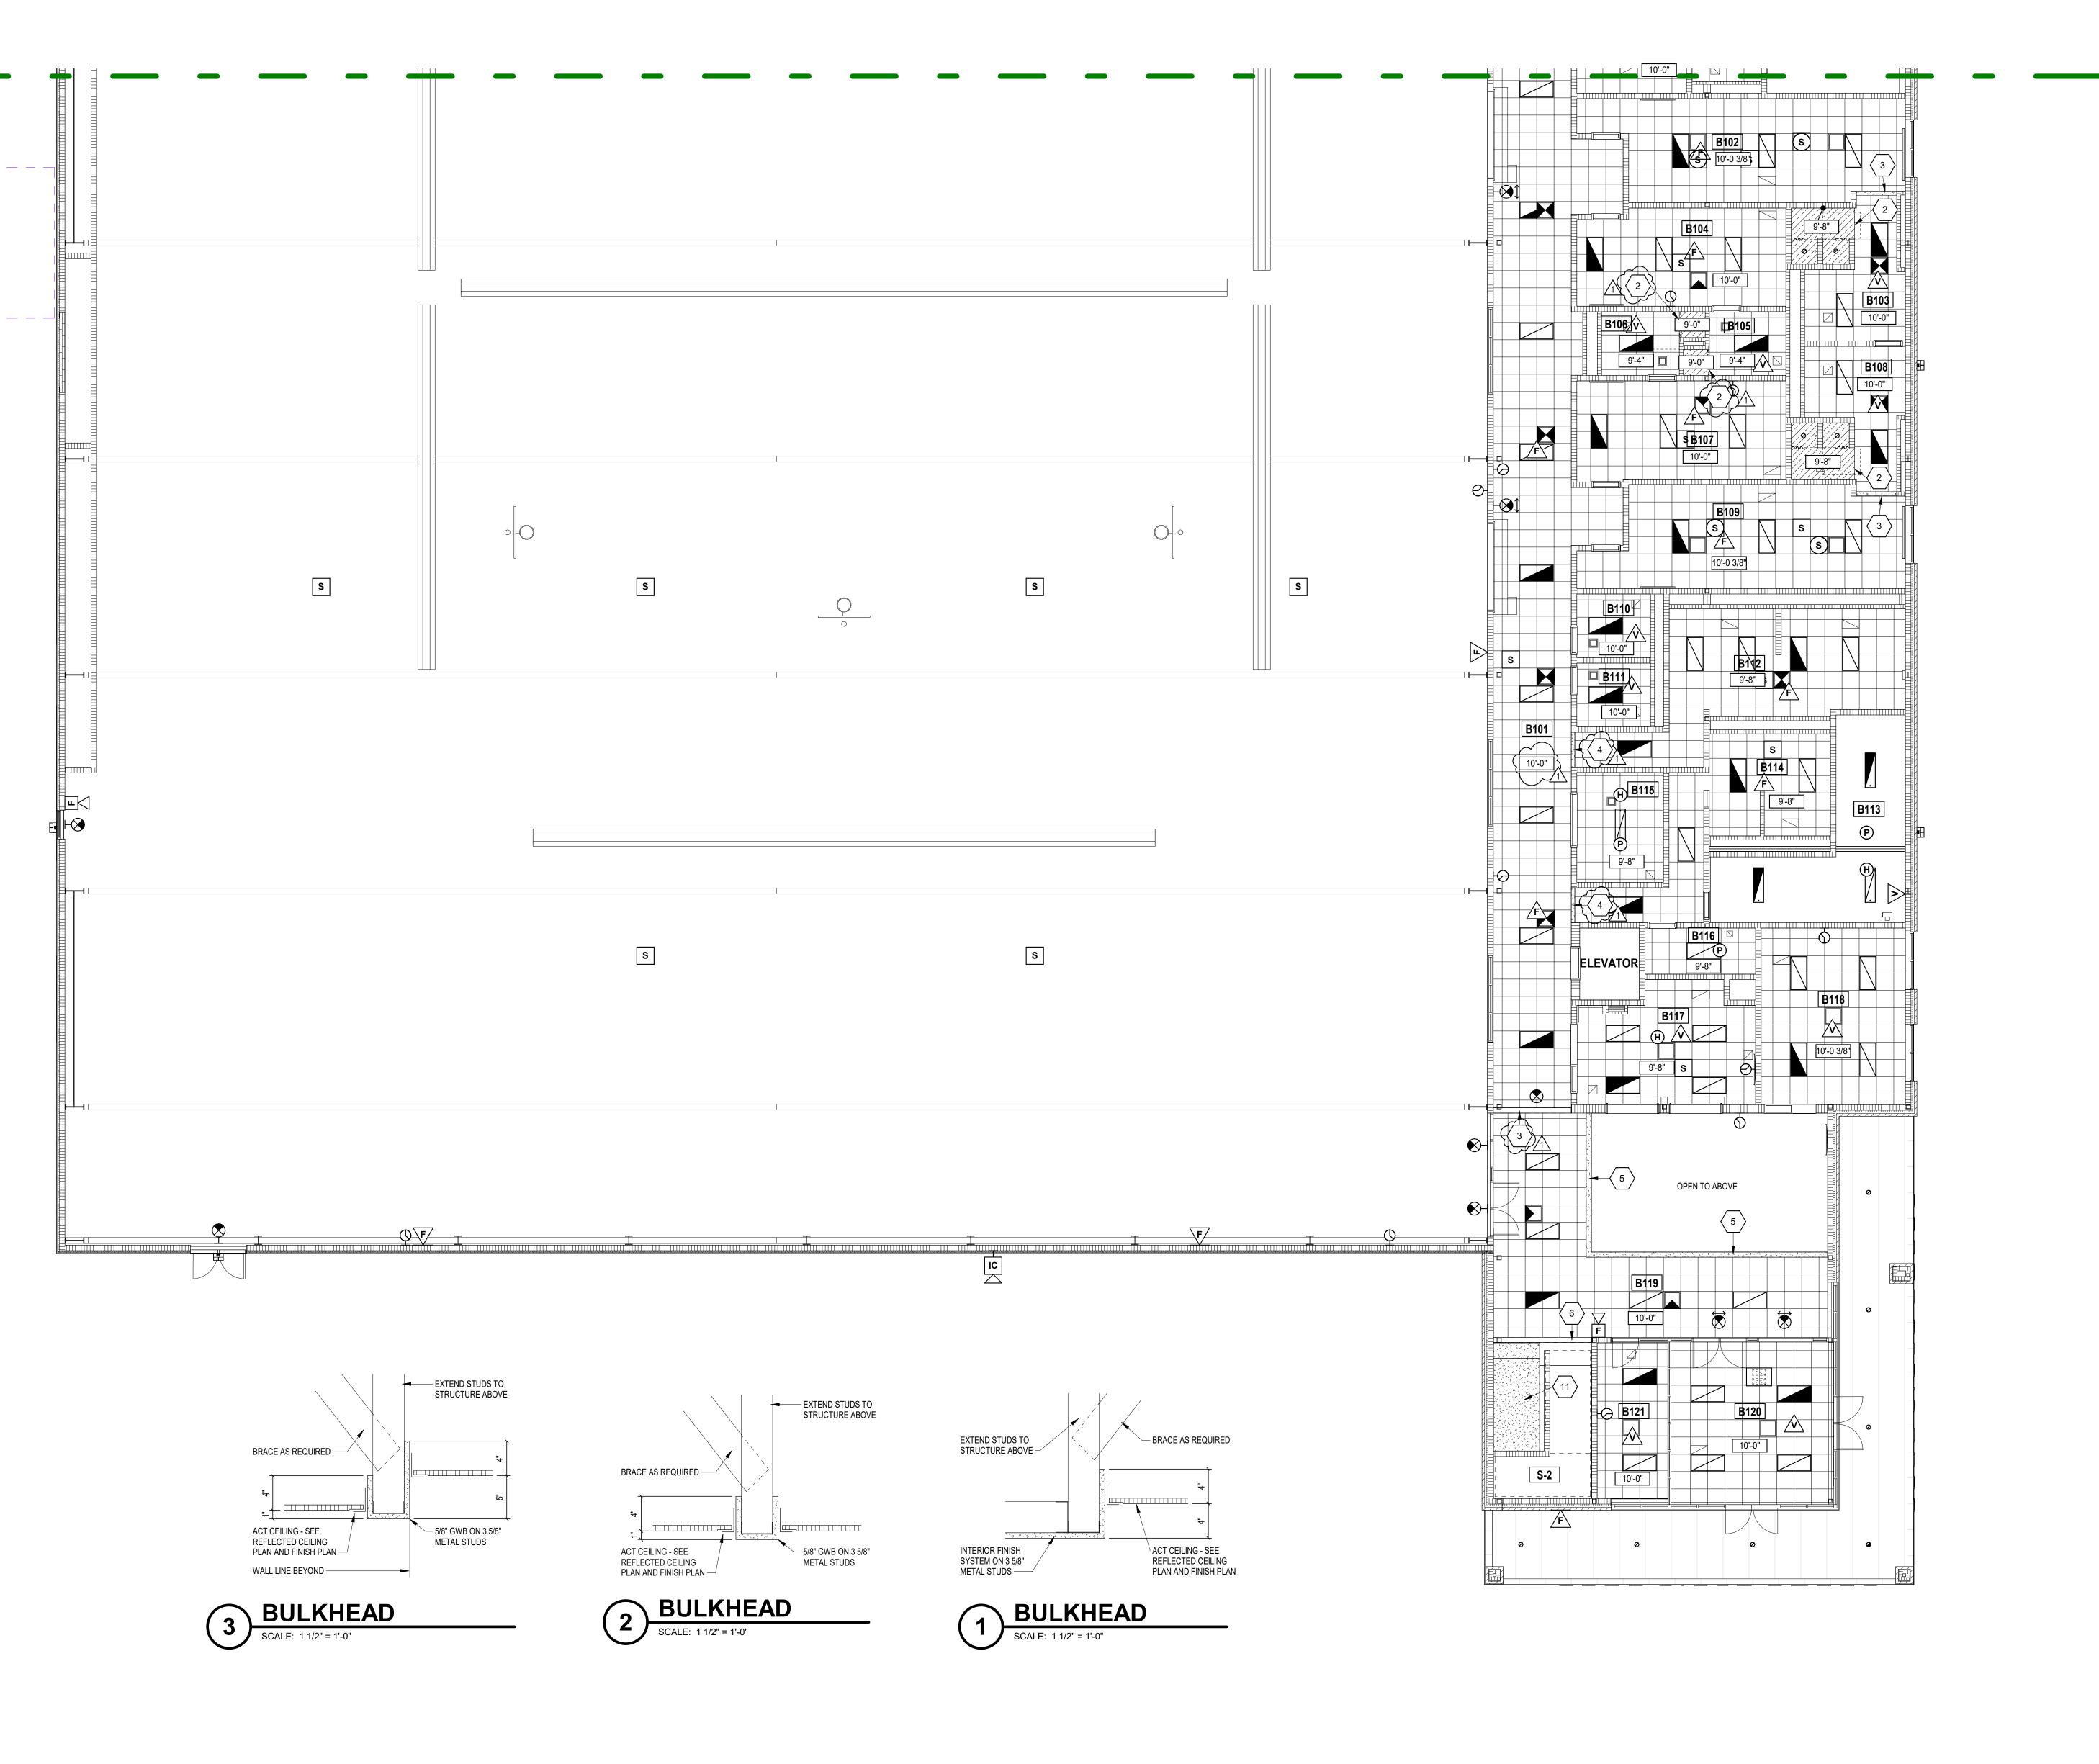

REFLECTED CEILING PLAN NOTES

A. PROVIDE REVEAL DRYWALL TRIM AT ALL LOCATIONS WHERE GYPSUM WALL BOARD (GWB) ABUTS A DISSIMILAR MATERIAL. TYPICAL UNLESS NOTED OTHERWISE. REFER

TO DETAIL ??-A9.1. B. BULKHEAD FRAMING SHALL BE ATTACHED TO STRUCTURAL SUPPORTS AND NOT TO THE ROOF DECK

PENN HIGH REFLECTED CEILING NOTES SCHOOL (ALL NOTES MAY NOT BE INDICATED ON THIS SHEET)

GWB BULKHEAD AT 9'-7" A.F.F. - SEE 1-AC11A INTERIOR FINISH SYSTEM (IFS) CEILING - SEE 1-AC11B GWB BULKHEAD AT 9'-7" A.F.F. - SEE 2-AC11B GWB BULKHEAD AT 9'-7" A.F.F. - SEE 3-AC11B GWB BULKHEAD AT 9'-8" A.F.F. AND GUARDRAIL - SEE 11-

6. GWB BULKHEAD AT 9'-11 " A.F.F. - SEE 1-AC11A
7. GWB BULKHEAD AT 9'-0" A.F.F. - SEE 2-AC12A
8. GWB BULKHEAD AT 9'-4" A.F.F. AND OPERABLE WALL (ALTERNATE) - SEE 1-AC12B

9. GWB BULKHÉAD AT 9'-0" A.F.F. - SEE 2-AC12B GWB BULKHEAD AT 10'-0 3/8" A.F.F. - SEE SECTION 3-A404. 11. GWB CEILING AT UNDERSIDE OF STAIR - SEE 5-A40412. PROVIDE 4" PERIMETER TRIM AROUND CLOUDS

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FIELDHOUSE

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		ROOM LEGEND	
	AREA (SF)	ROOM NAME	ROOM NO.
PENN-HARRIS-MADISON			
PENN-HARRIS-MADISON	54,239 SF	FIELDHOUSE	A101
SCHOOL CORPORATION	328 SF	CORRIDOR	A102
SCHOOL CORPORATION	182 SF	ELECTRICAL	A105
	81 SF	TOILET	A106
_	144 SF	LAUNDRY	A107
2 III. 3	1,163 SF	CORRIDOR	B101
	399 SF	LOCKER ROOM #1	B102
	184 SF	SHOWER	B103
4 // // //	261 SF	DRESSING ROOM #1	B104
Q'// T/a	74 SF	TOILET	B105
	75 SF	TOILET	B106
	270 SF	DRESSING ROOM #2	B107
	184 SF	SHOWER	B108
MADISON	401 SF	LOCKER ROOM #2	B109
hiro	63 SF	TOILET	B110
6611001	63 SF	TOILET	B111
— school —	388 SF	GIRLS RESTROOM	B112
CORPORATION	304 SF	FIRE RISER	B113
1	270 SF	BOYS RESTROOM	B114
	127 SF	STORAGE	B115
	68 SF	CUSTODIAN	B116
	263 SF	CONCESSION	B117
	341 SF	OFFICE	B118
	1,039 SF	LOBBY	B119
	369 SF	VESTIBULE	B120
ARCHITECT	159 SF	SRO OFFICE	B121
	115 SF	STAIR	S-2



350 E NEW YORK ST #300, INDIANAPOLIS, IN 46204

ALTERNATE

Construction Documents

No. AR 10800161
STATE OF

MOIANA

ARCHITEC.

KEY PLAN

PROJECT MANAGER: MKS

PROJECT NUMBER: 222130.00

PROJECT ISSUE DATE: January 10, 2024

DESCRIPTION

WWW.FHAI.COM

317.848.0966

REFLECTED CEILING PLAN LEGEND • 10'-4" INDICATES ELEVATION HEIGHT

XX'-XX" INDICATES CEILING HEIGHT X1 XX'-XX" INDICATES ACOUSTIC PANEL CEILING TYPE AND HEIGHT. REFER TO PROJECT MANUAL FOR "TYPE"

LIGHT FIXTURE - REFER TO ELECTRICAL DRAWINGS LIGHT FIXTURE - REFER TO ELECTRICAL DRAWINGS

LIGHT FIXTURE - REFER TO ELECTRICAL DRAWINGS CLOCK - REFER TO TECHNOLOGY DRAWINGS

MECHANICAL DIFFUSER - REFER TO MECHANICAL DRAWINGS MECHANICAL RETURN AIR GRILLE - REFER TO MECHANICAL DRAWINGS CEILING MOUNTED MECHANICAL UNIT - REFER TO MECHANICAL DRAWINGS

MECHANICAL UNIT HEATER - REFER TO MECHANICAL DRAWINGS RECESSED CEILING SPEAKER

CEILING MOUNTED CAMERA WIRELESS ACCESS POINT (WAP)

> CONTROL JOINT IN GYPSUM BOARD CEILING OR BULKHEAD SOUND REINFORCEMENT SPEAKER

FIRE ALARM HORN STROBE

FIRE ALARM STROBE FIRE ALARM SMOKE DETECTOR

VERIFICATION NOTE CONTRACTOR SHALL VERIFY ALL DIMENSIONS AND CLEARANCES AND ALL EXISTING FIELD CONDITIONS BEFORE STARTING CONSTRUCTION. COMMENCEMENT OF WORK CONSTITUTES ACCEPTANCE OF CONDITIONS.

SHOULD DIFFERENT CONDITIONS BE ENCOUNTERED, CONTACT THE ARCHITECT BEFORE PROCEEDING WITH WORK.

FIRST FLOOR REFLECTED CEILING PLAN - UNIT B


FIRST FLOOR CEILING PLAN - UNIT B

MOTION DETECTOR CEILING MOUNTED EXIT LIGHT

FIRE ALARM HEAT DETECTOR

FIRE ALARM SPEAKER STROBE

OCCUPANCY SENSOR ACOUSTICAL CEILING TILE (ACT)

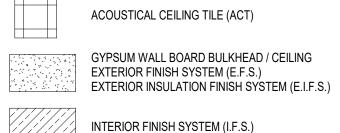


METAL SOFFIT PANELS

▼ ▼ F		<u> </u>		I	F	Φ
10'-0 3/8"	F		<u> </u>	c S	F	
9'-0" D105		· · ·	· · ·	·		
S-3						
D103	MF	S .	MP S		MP S	
P H			<u> </u>	<u> </u>		
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D102	MF	S	MPS		MPS	


. . . .

FIRST FLOOR CEILING PLAN ALTERNATE - UNIT D

SCALE: 1/8" = 1'-0"

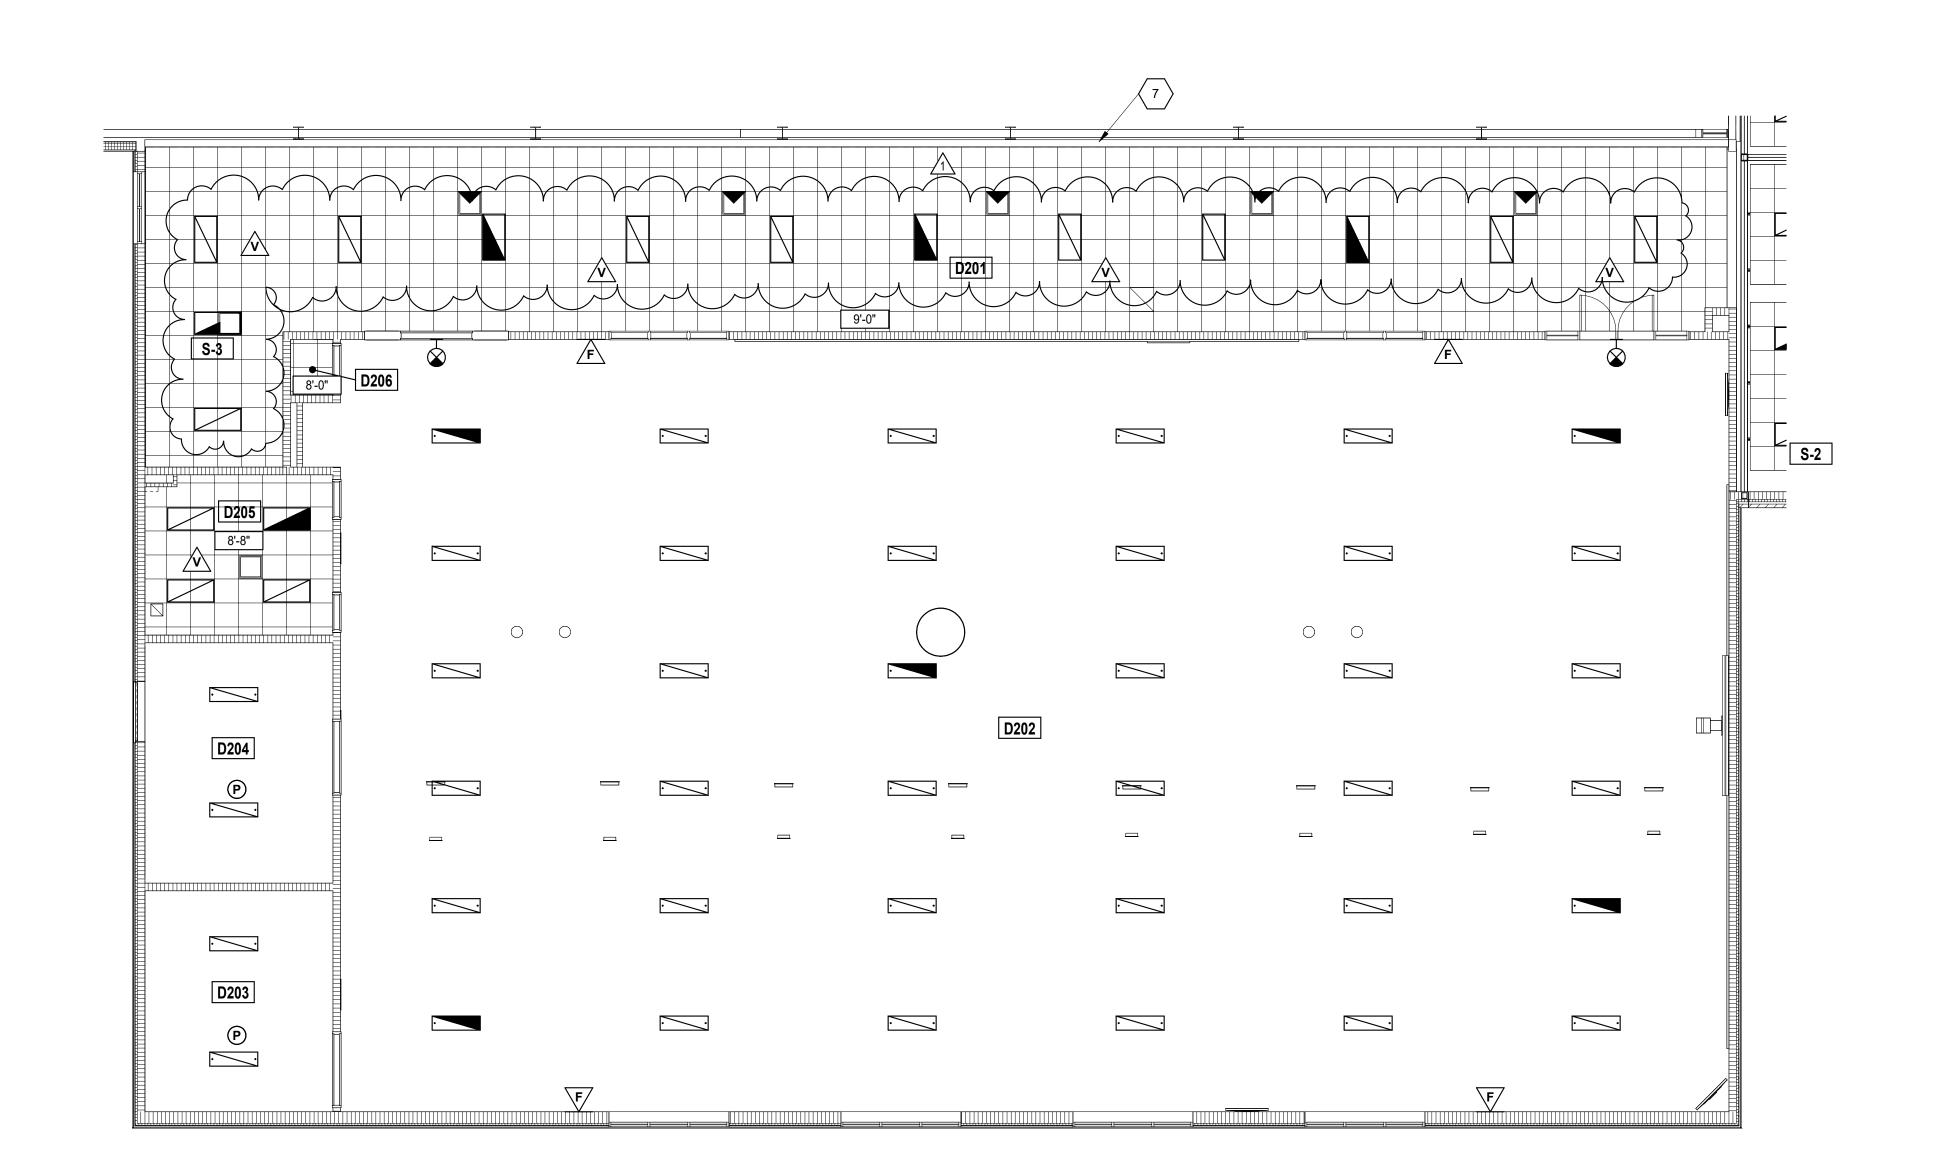

SECOND FLOOR CEILING PLAN ALTERNATE - UNIT D

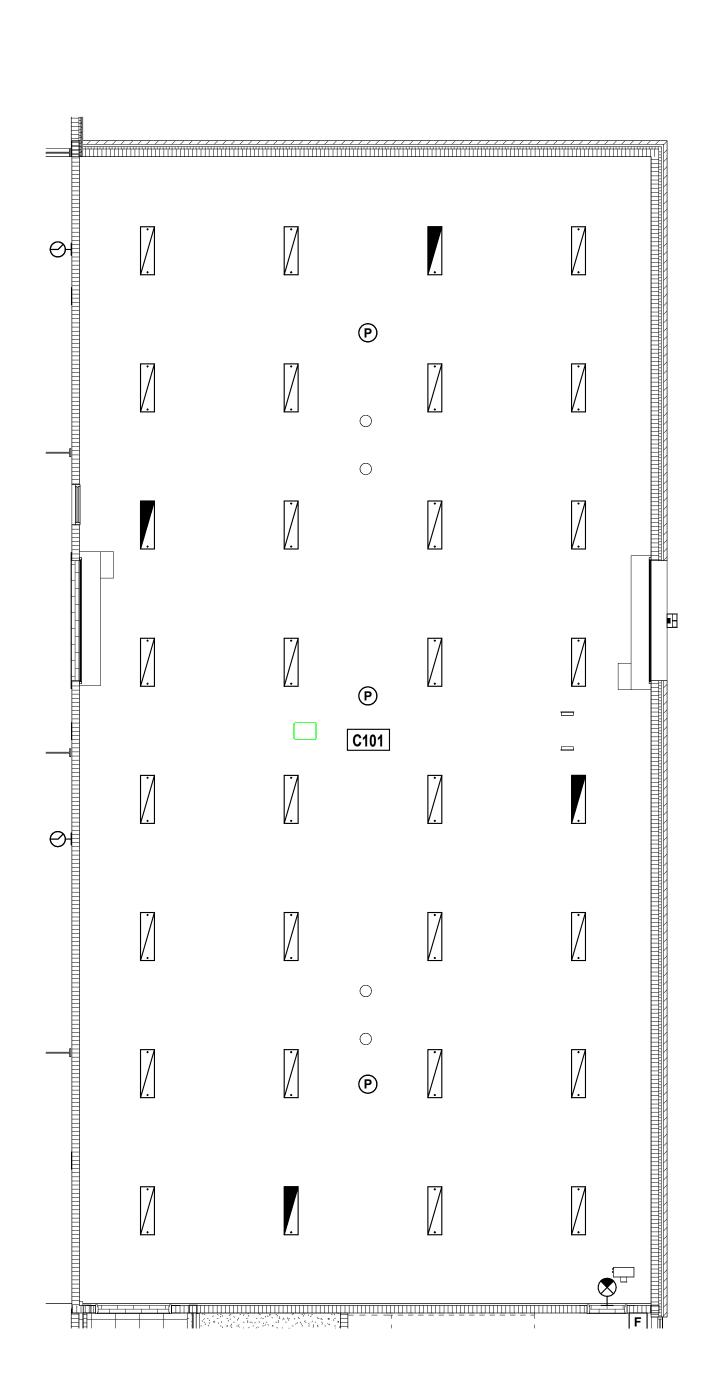

FIRST FLOOR CEILING PLAN ALTERNATE - UNIT C

ROOM LEGEND ROOM NO. ROOM NAME A103 CORRIDOR B119 LOBBY

WHERE GYPSUM WALL BOARD (GWB) ABUTS A DISSIMILAR MATERIAL. TYPICAL UNLESS NOTED OTHERWISE. REFER TO DETAIL ??-A9.1. B. BULKHEAD FRAMING SHALL BE ATTACHED TO STRUCTURAL SUPPORTS AND NOT TO THE ROOF DECK

PENN HIGH REFLECTED CEILING NOTES SCHOOL (ALL NOTES MAY NOT BE INDICATED ON THIS SHEET)

1. GWB BULKHEAD AT 9'-7" A.F.F. - SEE 1-AC11A INTERIOR FINISH SYSTEM (IFS) CEILING - SEE 1-AC11B GWB BULKHEAD AT 9'-7" A.F.F. - SEE 2-AC11B 4. GWB BULKHEAD AT 9'-7" A.F.F. - SEE 3-AC11B 5. GWB BULKHEAD AT 9'-8" A.F.F. AND GUARDRAIL - SEE 11-

10. GWB BULKHEAD AT 10'-0 3/8" A.F.F. - SEE SECTION 3-A404. 11. GWB CEILING AT UNDERSIDE OF STAIR - SEE 5-A404

6. GWB BULKHEAD AT 9'-11 " A.F.F. - SEE 1-AC11A 7. GWB BULKHEAD AT 9'-0" A.F.F. - SEE 2-AC12A 8. GWB BULKHEAD AT 9'-4" A.F.F. AND OPERABLE WALL (ALTERNATE) - SEE 1-AC12B 9. GWB BULKHEAD AT 9'-0" A.F.F. - SEE 2-AC12B

12. PROVIDE 4" PERIMETER TRIM AROUND CLOUDS

REFLECTED CEILING PLAN NOTES

A. PROVIDE REVEAL DRYWALL TRIM AT ALL LOCATIONS

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FIELDHOUSE

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PENN-HARRIS-MADISON SCHOOL CORPORATION



FANNING HOWEY

350 E NEW YORK ST #300, INDIANAPOLIS, IN 46204

ALTERNATE

Construction Documents

No. AR 10800161
STATE OF

MOIANA

ARCHITEC)

KEY PLAN

PROJECT MANAGER: MKS

PROJECT NUMBER: 222130.00

PROJECT ISSUE DATE: January 10, 2024

DESCRIPTION

REFLECTED CEILING PLAN LEGEND • 10'-4" INDICATES ELEVATION HEIGHT 317.848.0966 WWW.FHAI.COM INDICATES CEILING HEIGHT

LIGHT FIXTURE - REFER TO ELECTRICAL DRAWINGS LIGHT FIXTURE - REFER TO ELECTRICAL DRAWINGS LIGHT FIXTURE - REFER TO ELECTRICAL DRAWINGS CLOCK - REFER TO TECHNOLOGY DRAWINGS

X1 XX'-XX" INDICATES ACOUSTIC PANEL CEILING TYPE AND HEIGHT. REFER TO PROJECT MANUAL FOR "TYPE"

MECHANICAL DIFFUSER - REFER TO MECHANICAL MECHANICAL RETURN AIR GRILLE - REFER TO MECHANICAL DRAWINGS CEILING MOUNTED MECHANICAL UNIT - REFER TO

MECHANICAL DRAWINGS MECHANICAL UNIT HEATER - REFER TO MECHANICAL DRAWINGS RECESSED CEILING SPEAKER MOTION DETECTOR

CEILING MOUNTED EXIT LIGHT CEILING MOUNTED CAMERA WIRELESS ACCESS POINT (WAP)

CONTROL JOINT IN GYPSUM BOARD CEILING OR BULKHEAD SOUND REINFORCEMENT SPEAKER

FIRE ALARM HEAT DETECTOR FIRE ALARM HORN STROBE FIRE ALARM SPEAKER STROBE

FIRE ALARM STROBE FIRE ALARM SMOKE DETECTOR OCCUPANCY SENSOR


ACOUSTICAL CEILING TILE (ACT)


ACOUSTICAL CEILING TILE (ACT) GYPSUM WALL BOARD BULKHEAD / CEILING EXTERIOR FINISH SYSTEM (E.F.S.) EXTERIOR INSULATION FINISH SYSTEM (E.I.F.S.) INTERIOR FINISH SYSTEM (I.F.S.) METAL SOFFIT PANELS

VERIFICATION NOTE CONTRACTOR SHALL VERIFY ALL DIMENSIONS AND CLEARANCES

THE ARCHITECT BEFORE PROCEEDING WITH WORK.


AND ALL EXISTING FIELD CONDITIONS BEFORE STARTING CONSTRUCTION. COMMENCEMENT OF WORK CONSTITUTES ACCEPTANCE OF CONDITIONS. SHOULD DIFFERENT CONDITIONS BE ENCOUNTERED, CONTACT **REFLECTED CEILING PLANS -ALTERNATES**

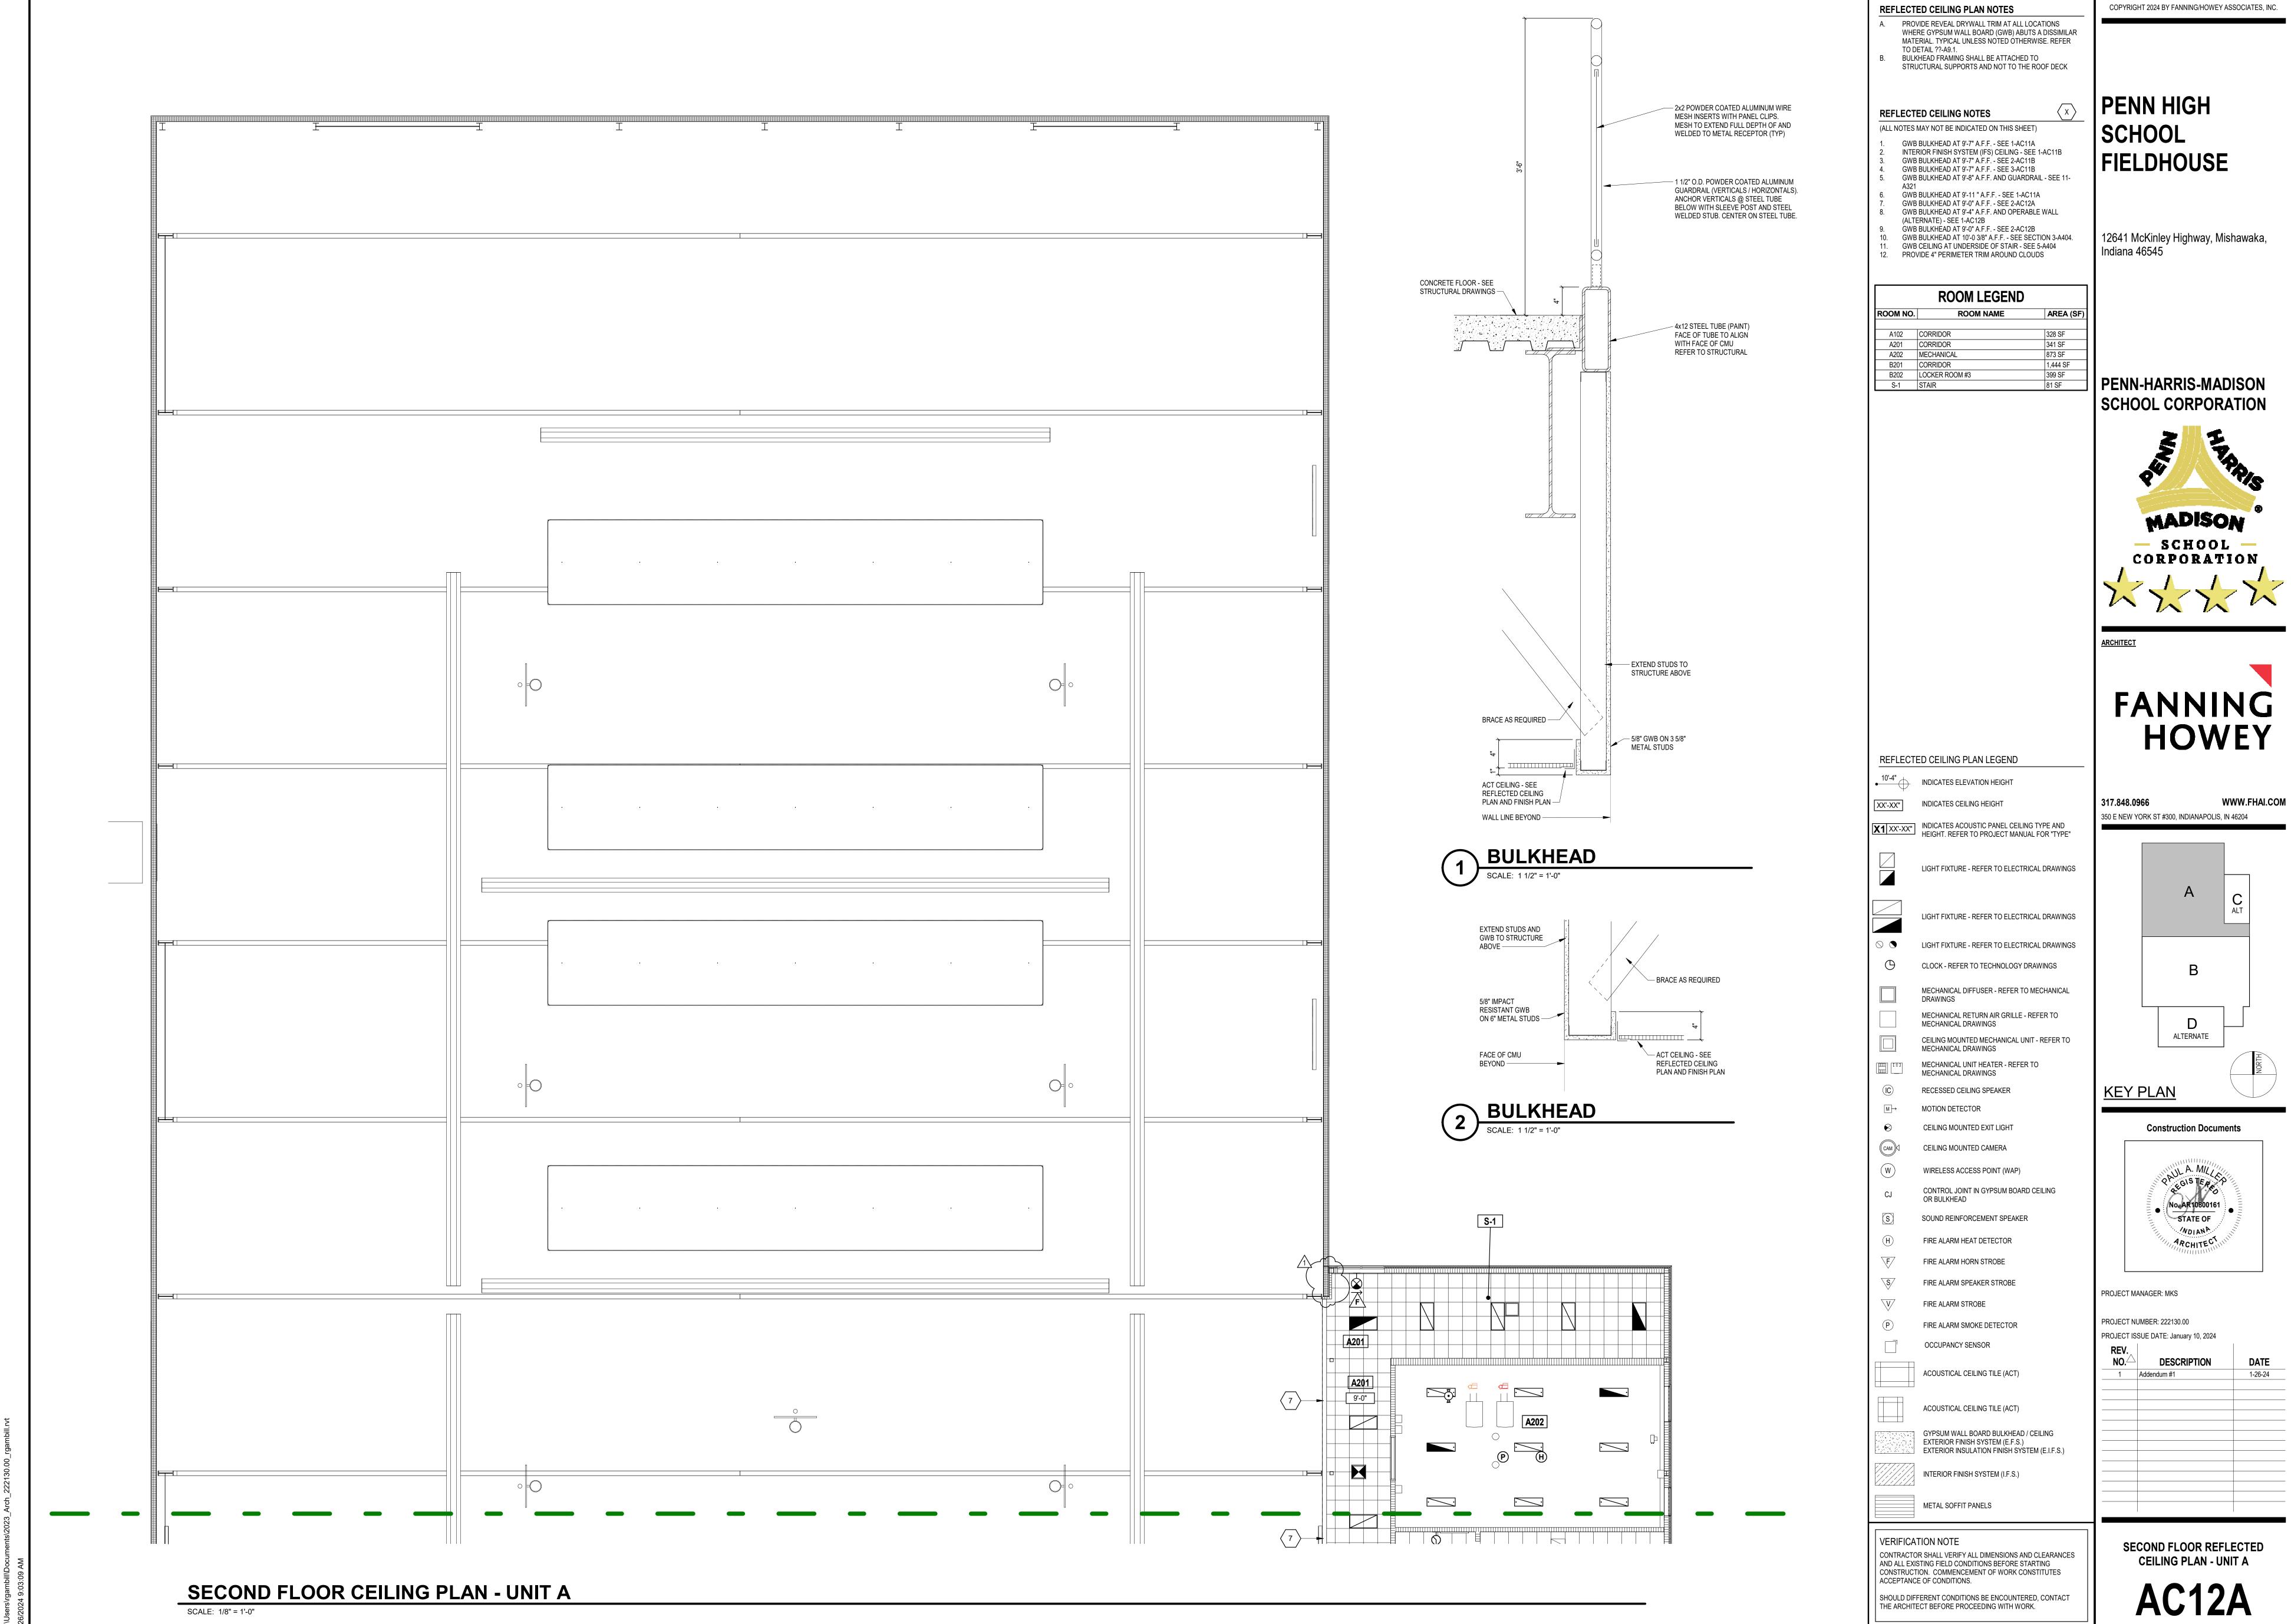


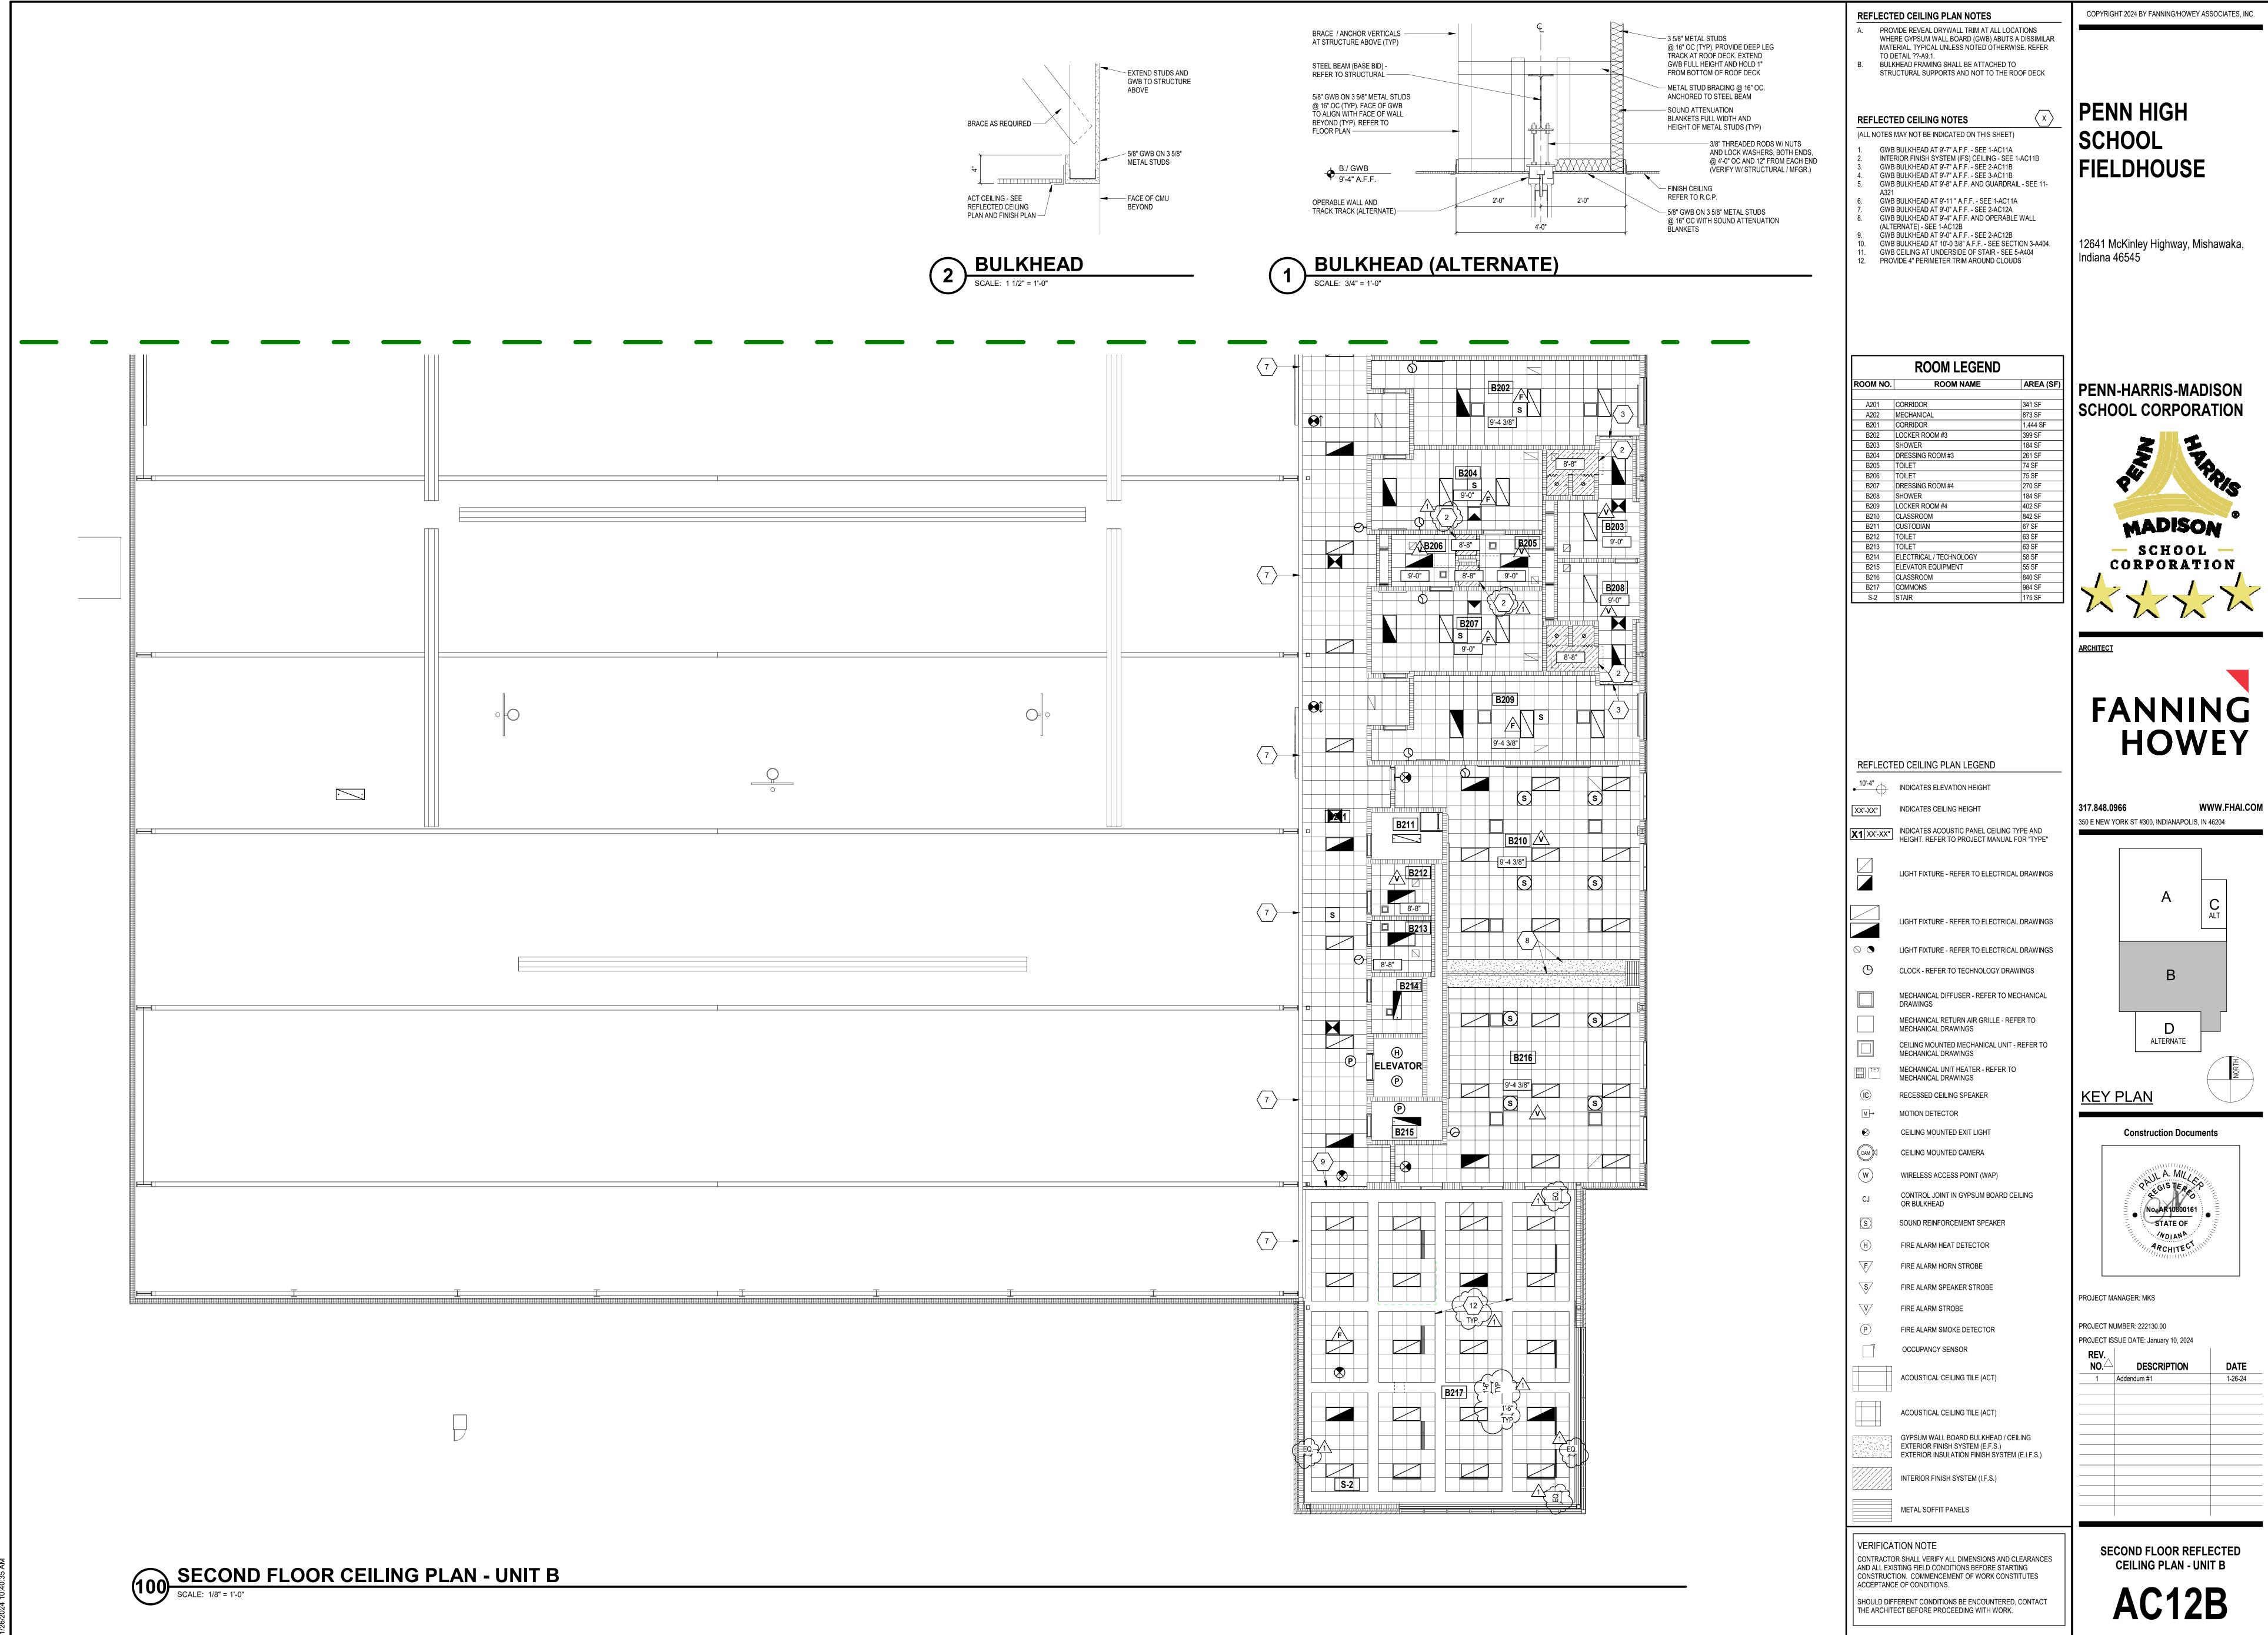






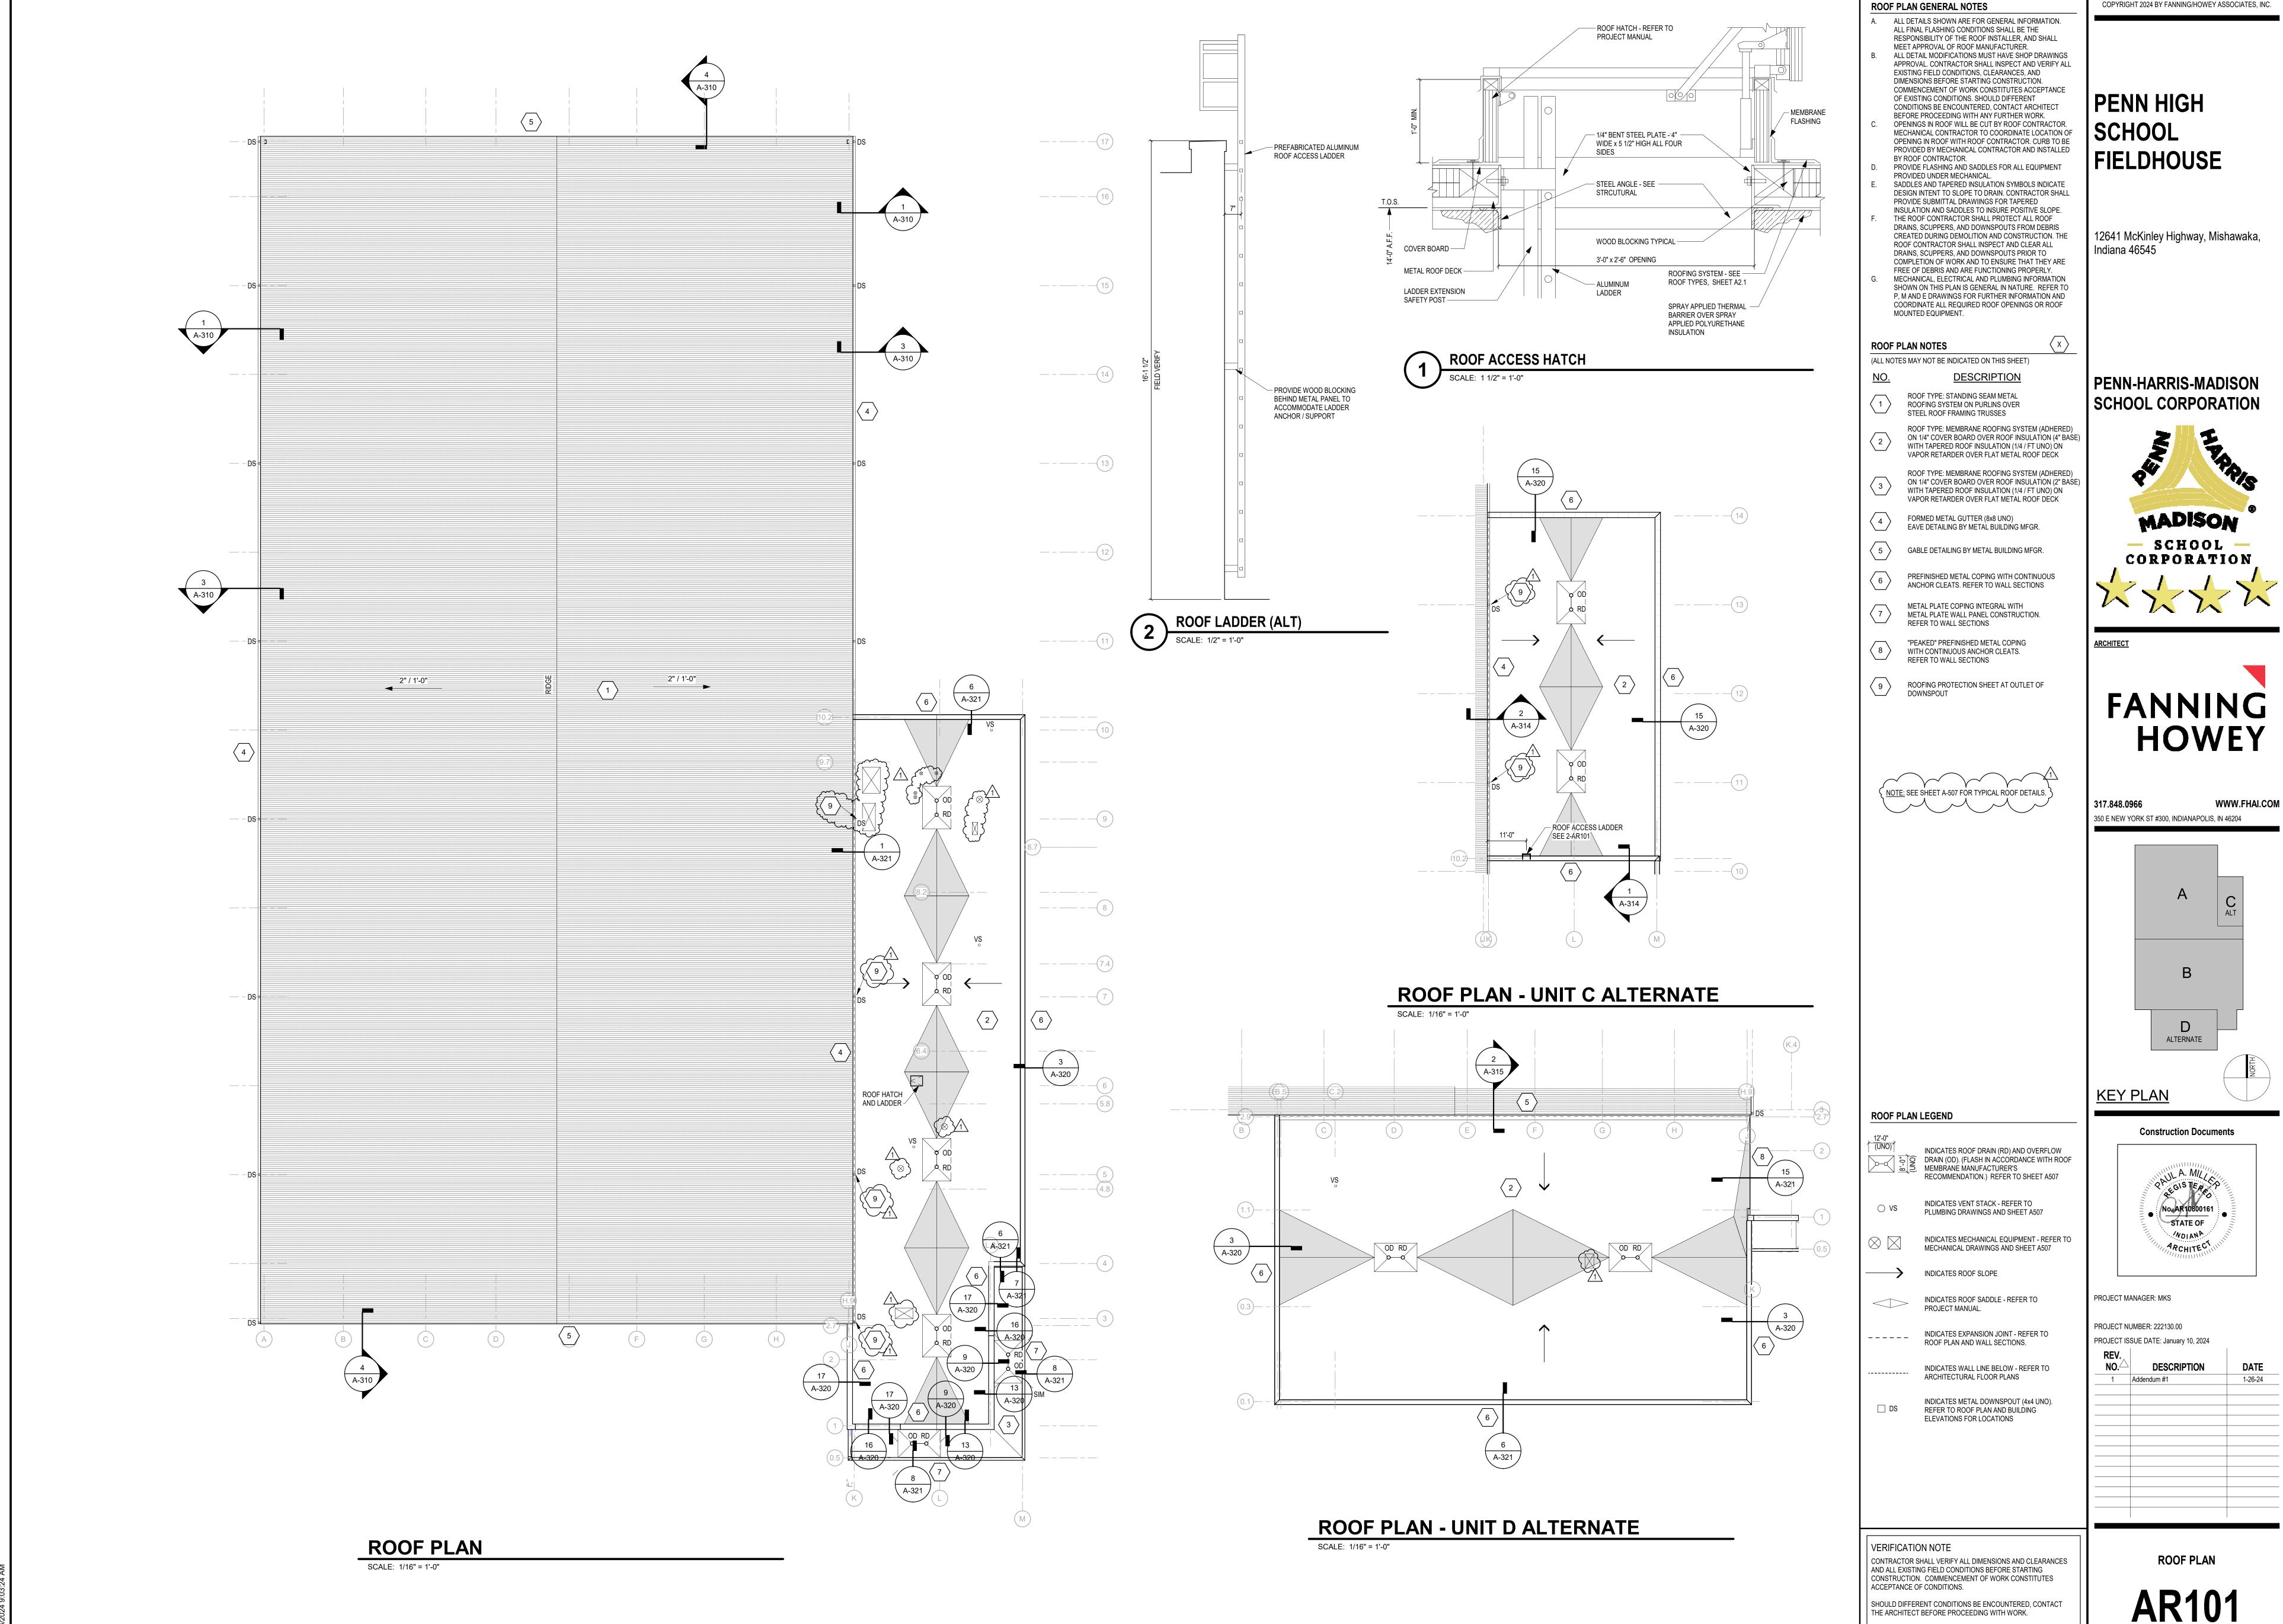


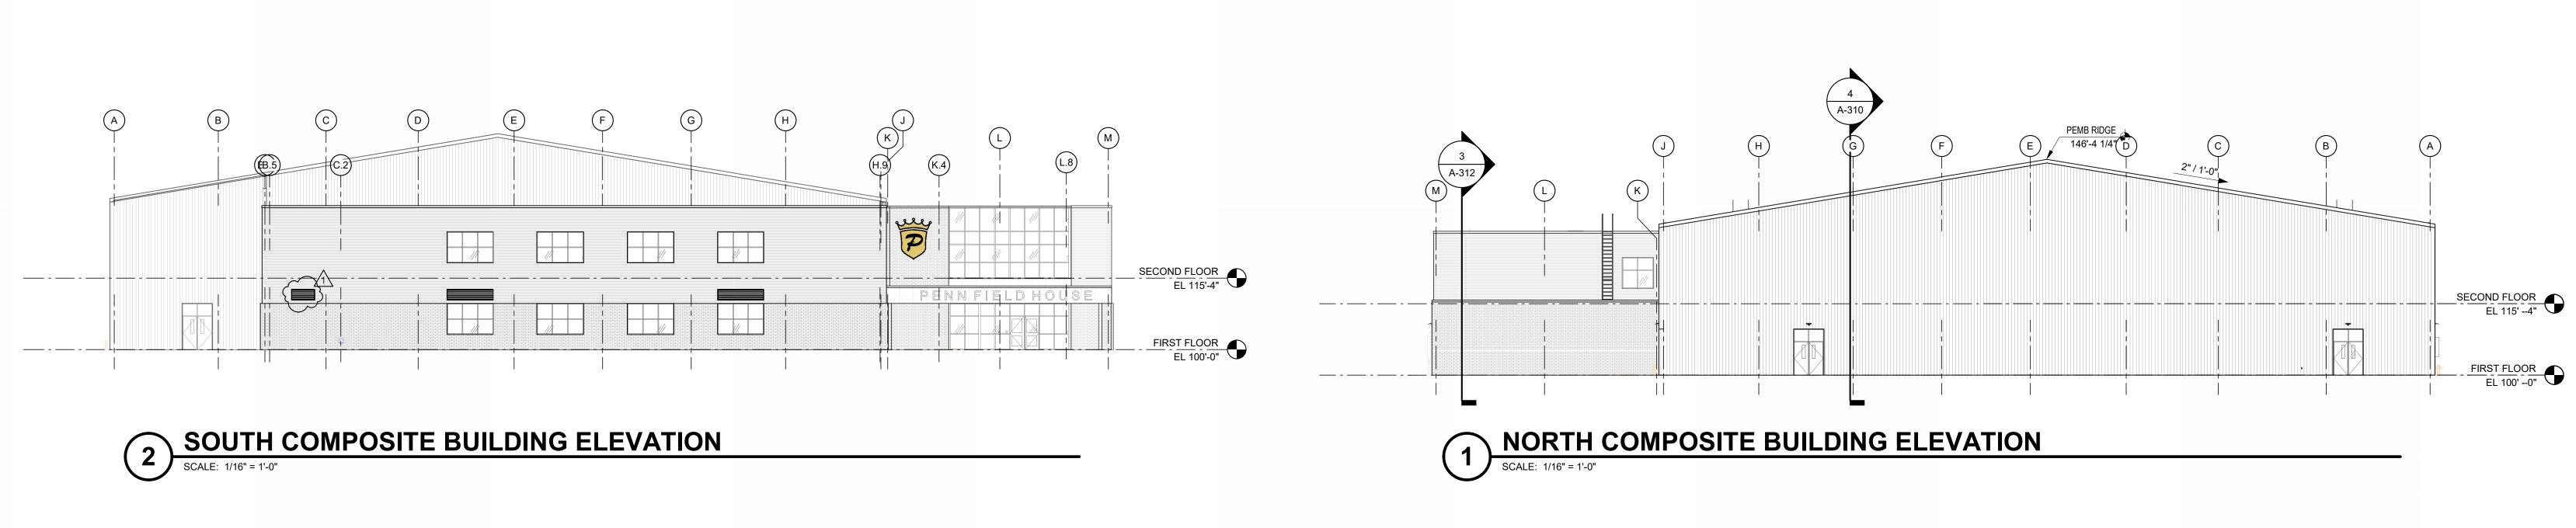

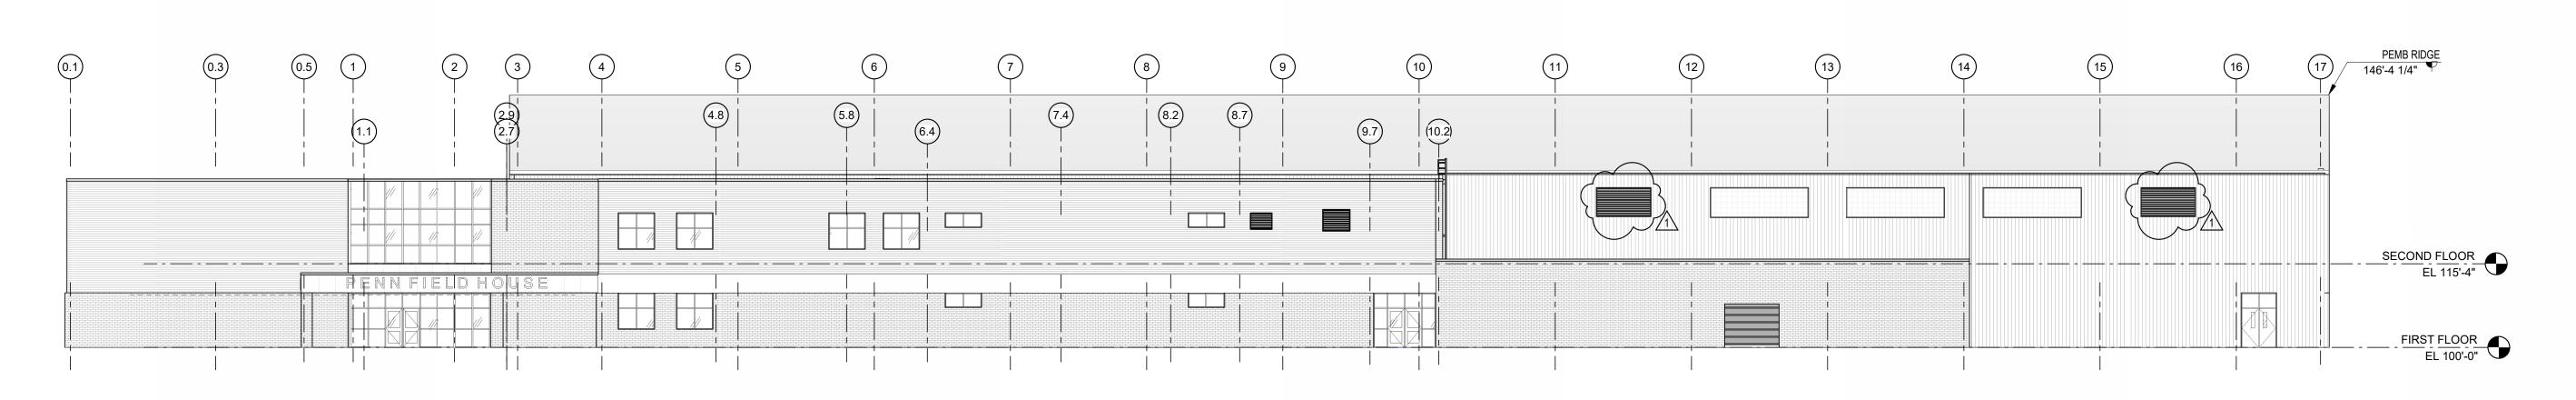

3 EAST COMPOSITE BUILDING ELEVATION

SCALE: 1/16" = 1'-0"

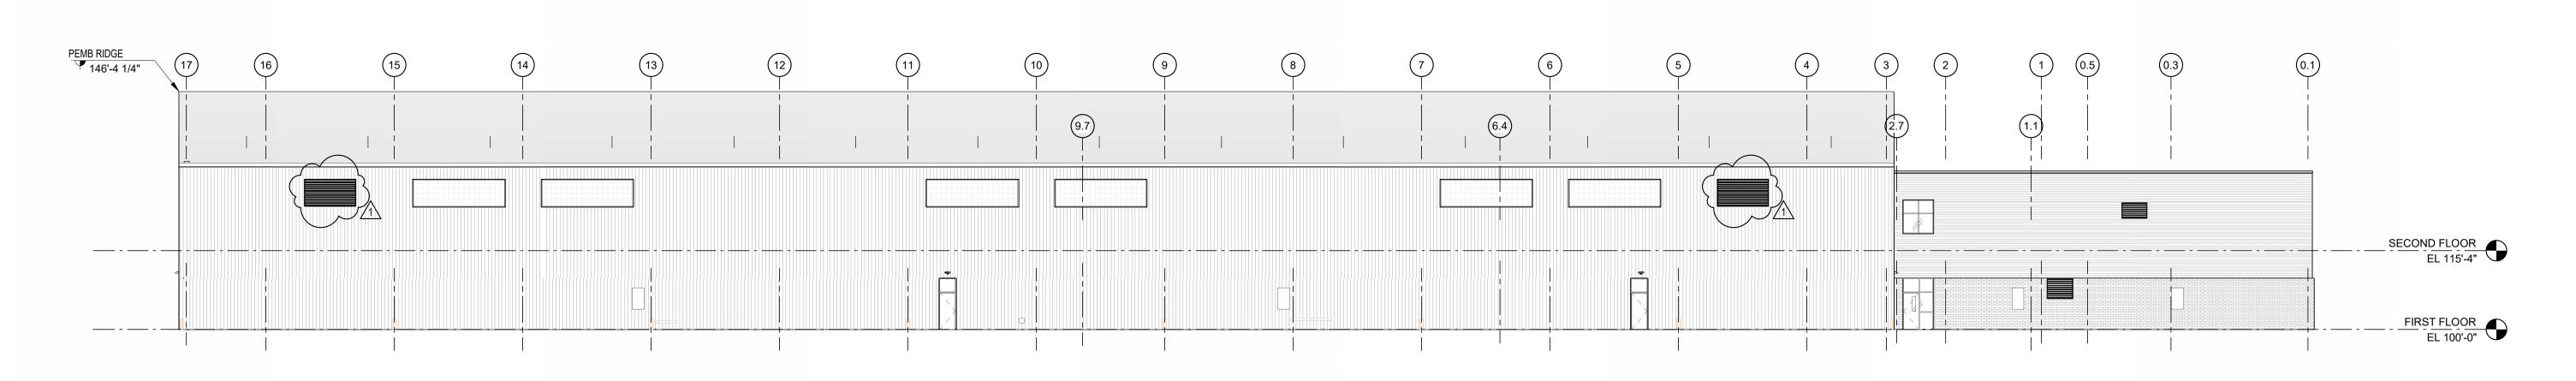

WEST COMPOSITE BUILDING ELEVATION

SCALE: 1/16" = 1'-0"

PENN HIGH SCHOOL FIELDHOUSE

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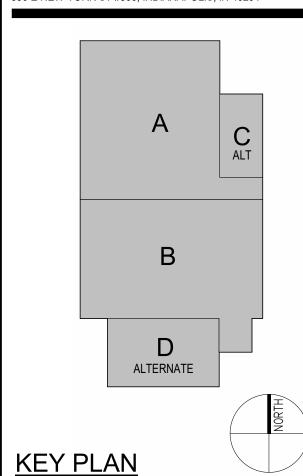
PENN-HARRIS-MADISON




ARCHITECT

FANNING HOWEY

317.848.0966 WWW.FHAI.COM 350 E NEW YORK ST #300, INDIANAPOLIS, IN 46204



Construction Documents

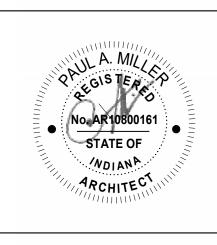

PROJECT MANAGER: MKS

DRAWN BY: Author


PROJECT NUMBER: 222130.00

PROJECT ISSUE DATE: January 10, 2024

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REV. NO.	DESCRIPTION	DATE
1	Addendum #1	1-26-24
-		


COMPOSITE BUILDING ELEVATIONS

A-201

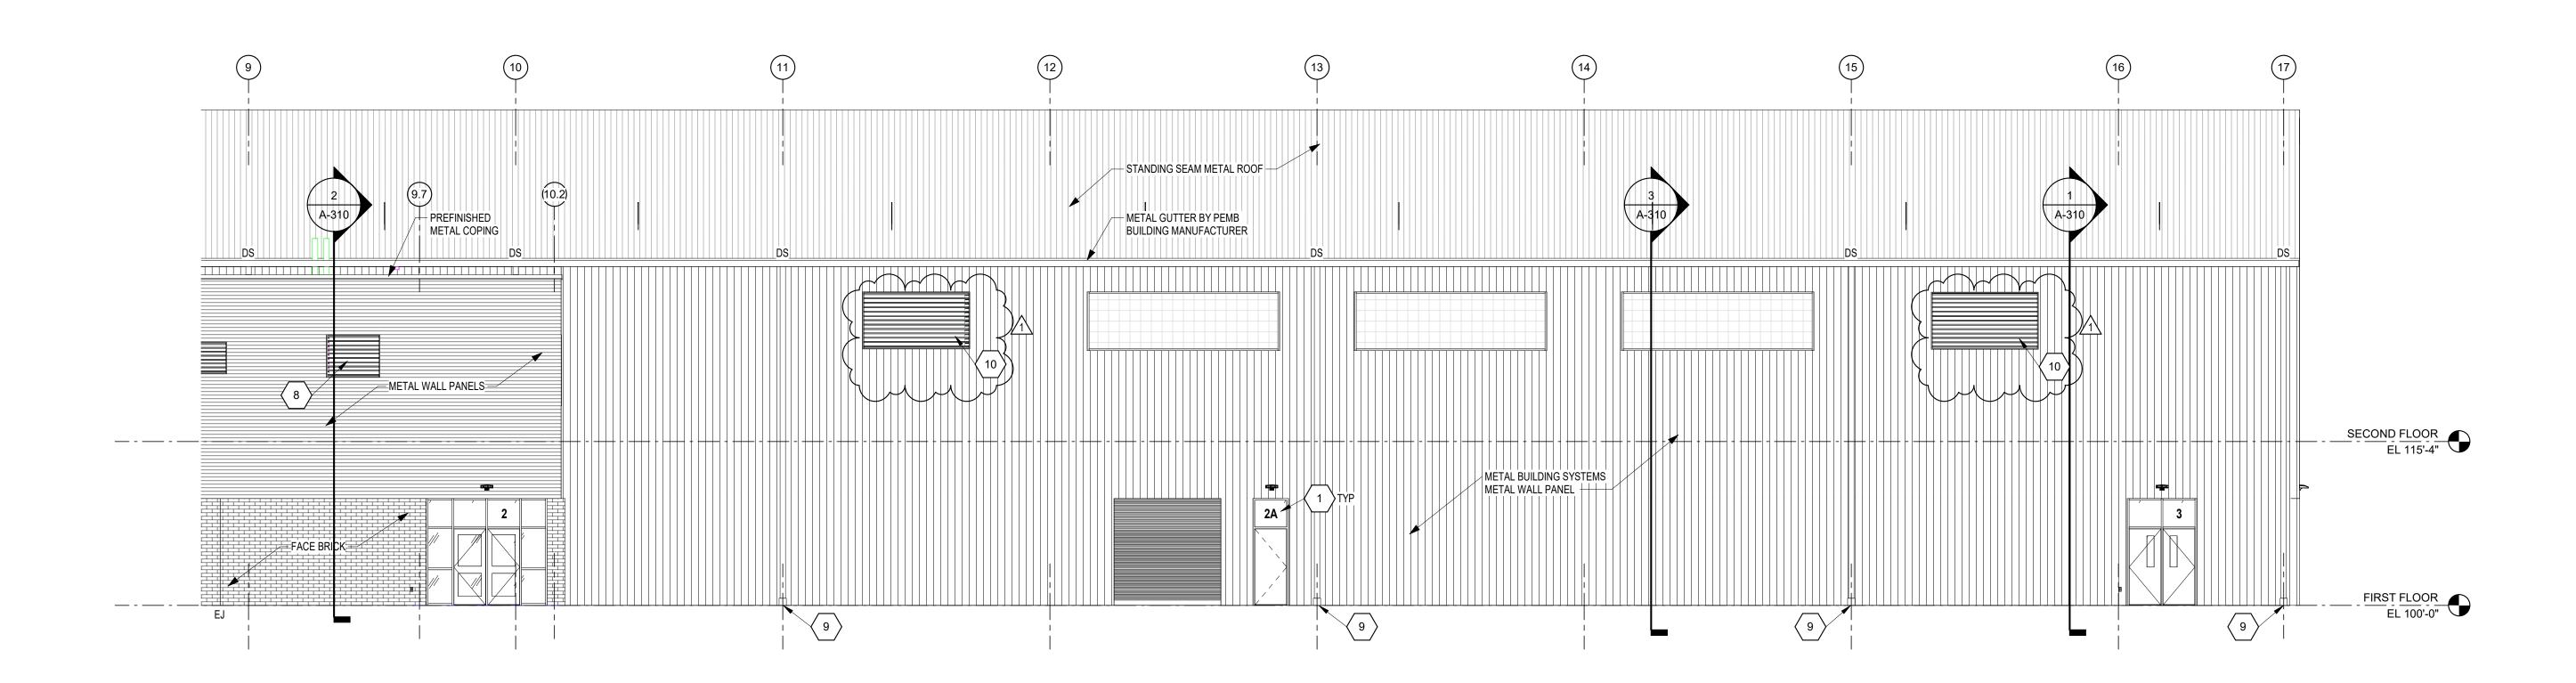

EAST ELEVATION - NORTH

SCALE: 1/8" = 1'-0"

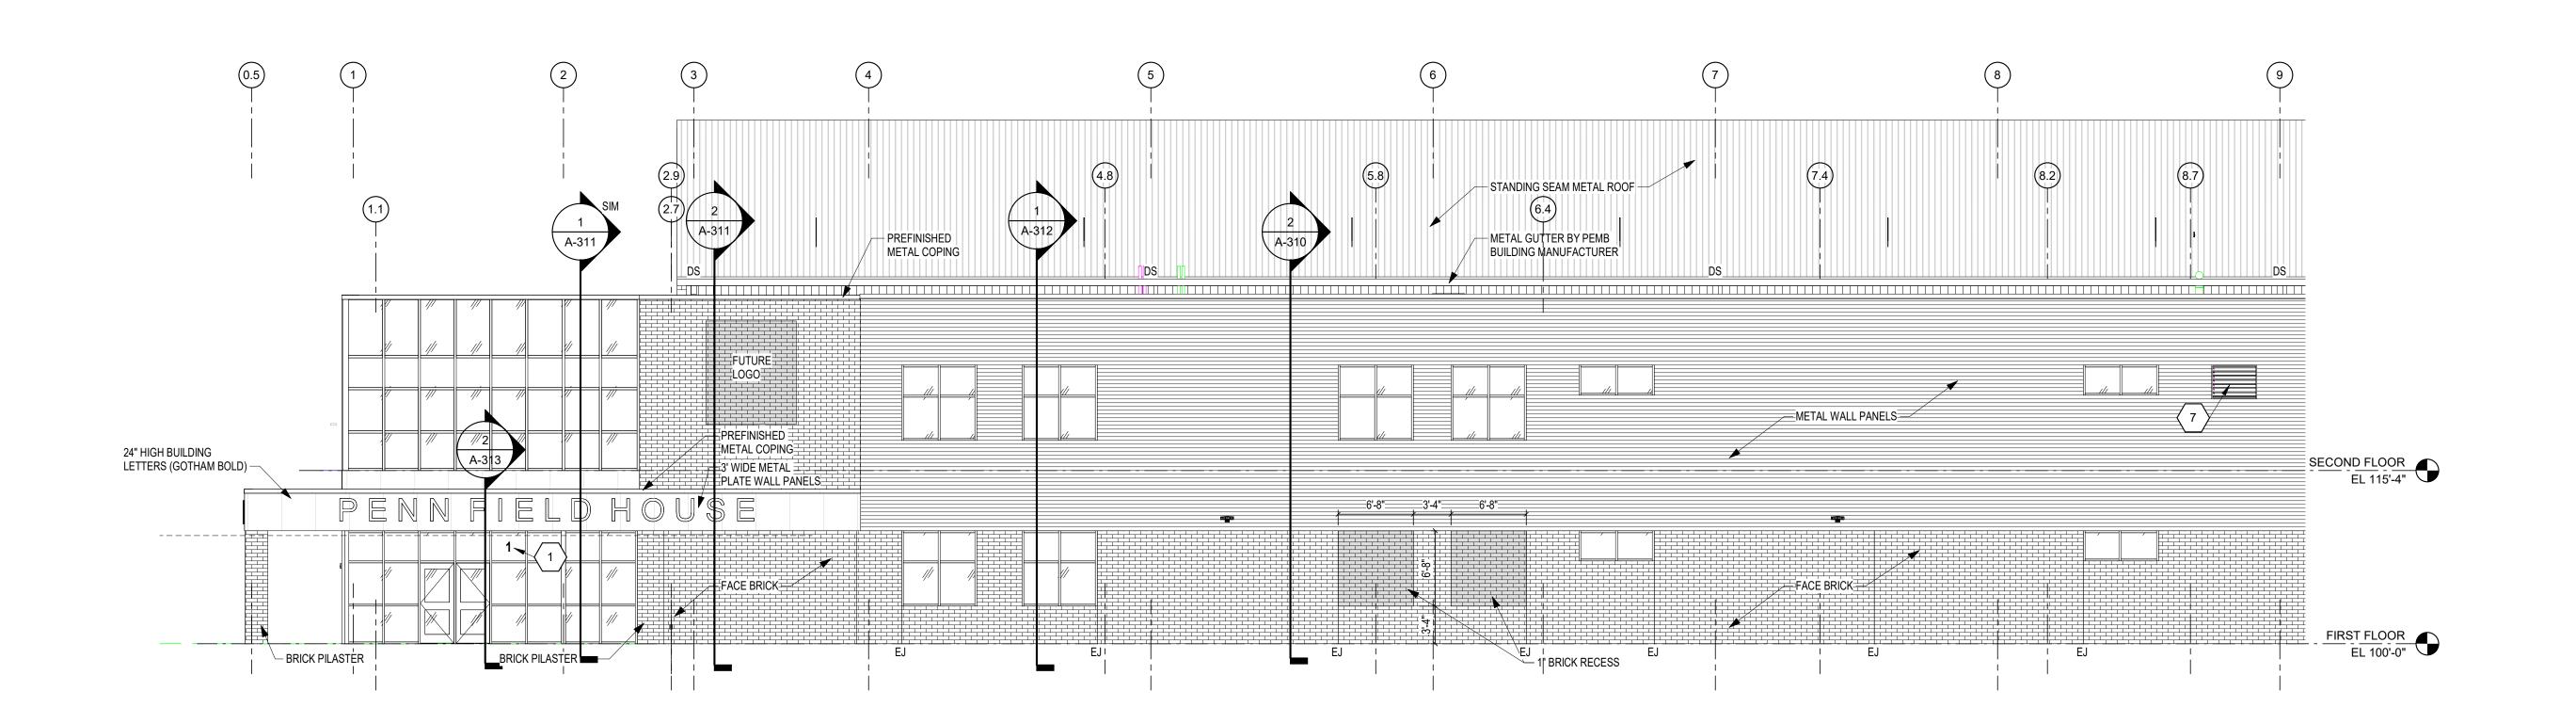

2 EAST ELEVATION - SOUTH

SCALE: 1/8" = 1'-0"

ELEVATIONS GENERAL NOTES

- A. REFER TO THE ELECTRICAL AND TECHNOLOGY DRAWINGS FOR CAMERA, LOCATIONS, SECURITY DEVICES, RECEPTACLES, LIGHT FIXTURES, ETC. COORDINATE LOCATIONS WITH VENEER COURSING TO PROVIDE
- CONSISTENT MOUNTING HEIGHTS. REFER TO PLUMBING DRAWINGS FOR EXTERIOR WALL HYDRANTS, SECONDARY ROOF DRAIN OUTLETS, ETC. COORDINATE PENETRATIONS THROUGH EXTERIOR ENVELOPE WITH OTHER TRADES. PROVIDE TRANSITION
- MEMBRANE TO MAINTAIN AIR BARRIER SYSTEM. REFER TO MECHANICAL DRAWINGS FOR EXTERIOR LOUVER LOCATIONS LOCATED IN EXTERIOR WALL AND EXTERIOR SOFFITS. COORDINATE PENETRATIONS THROUGH EXTERIOR ENVELOPE WITH OTHER TRADES. PROVIDE TRANSITION MEMBRANE TO MAINTAIN AIR BARRIER SYSTEM.

BUILDING ELEVATION NOTES

- (ALL NOTES MAY NOT BE INDICATED ON THIS SHEET)
- VINYL ENTRANCE NUMBERS FACE LIT LED ILLUMINATED CHANNEL LOGO MOUNTED FLUSH TO BRICK - OVERALL SIZE IS 8'-0" x 9'-2". THE SHIELD
- AND CROWN ARE TWO SEPARATE SIGNS. KNOX BOX AIR INTAKE LOUVER (D1) (5'-0" x 4'-0") HEAD AT 10'-0" ABOVE
- FIRST FLOOR LINE AIR INTAKE LOUVER (D2) (5'-0" x 3'-0") HEAD AT 9'-4" ABOVE SECOND FLOOR LINE.
- AIR INTAKE LOUVER (D4 & D5) (10'-0" x 2'-4") HEAD AT 13'-0" ABOVE FIRST FLOOR LINE AIR INTAKE LOUVER (A2) (4'-0" x 3'-0") HEAD AT 9'-4" ABOVE
- SECOND FLOOR LINE AIR INTAKE LOUVER (A1) (5'-0" x 4'-0") HEAD AT 10'-0" ABOVE
- SECOND FLOOR LINE

 9 DOWNSPOUT BOOT SEE PLUMBING DRAWINGS

 10. AIR INTAKE LOUVER (A3, A4, A5 & B1) (10'-0" x 5'-4") HEAD AT

29'-4" ABOVE FIRST FLOOR LINE AIR INTAKE LOUVER (D3) (5'-0" x 2'-4") HEAD AT 13'-0" ABOVE FIRST FLOOR LINE

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PENN HIGH SCHOOL FIELDHOUSE


12641 McKinley Highway, Mishawaka, Indiana 46545

PENN-HARRIS-MADISON





317.848.0966 WWW.FHAI.COM 350 E NEW YORK ST #300, INDIANAPOLIS, IN 46204

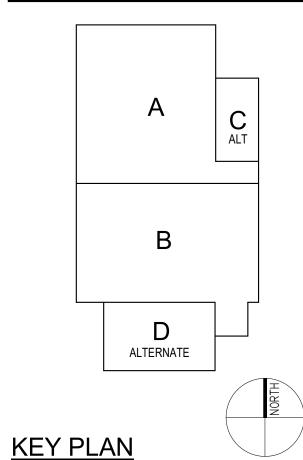

Construction Documents



PROJECT MANAGER: MKS

PROJECT NUMBER: 222130.00 PROJECT ISSUE DATE: January 10, 2024


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REV. No.	DESCRIPTION	DATE
1	Addendum #1	1-26-24
-		
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VERIFICATION NOTE

CONTRACTOR SHALL VERIFY ALL DIMENSIONS AND CLEARANCES AND ALL EXISTING FIELD CONDITIONS BEFORE STARTING CONSTRUCTION. COMMENCEMENT OF WORK CONSTITUTES ACCEPTANCE OF CONDITIONS.


SHOULD DIFFERENT CONDITIONS BE ENCOUNTERED, CONTACT THE ARCHITECT BEFORE PROCEEDING WITH WORK.

BUILDING ELEVATIONS

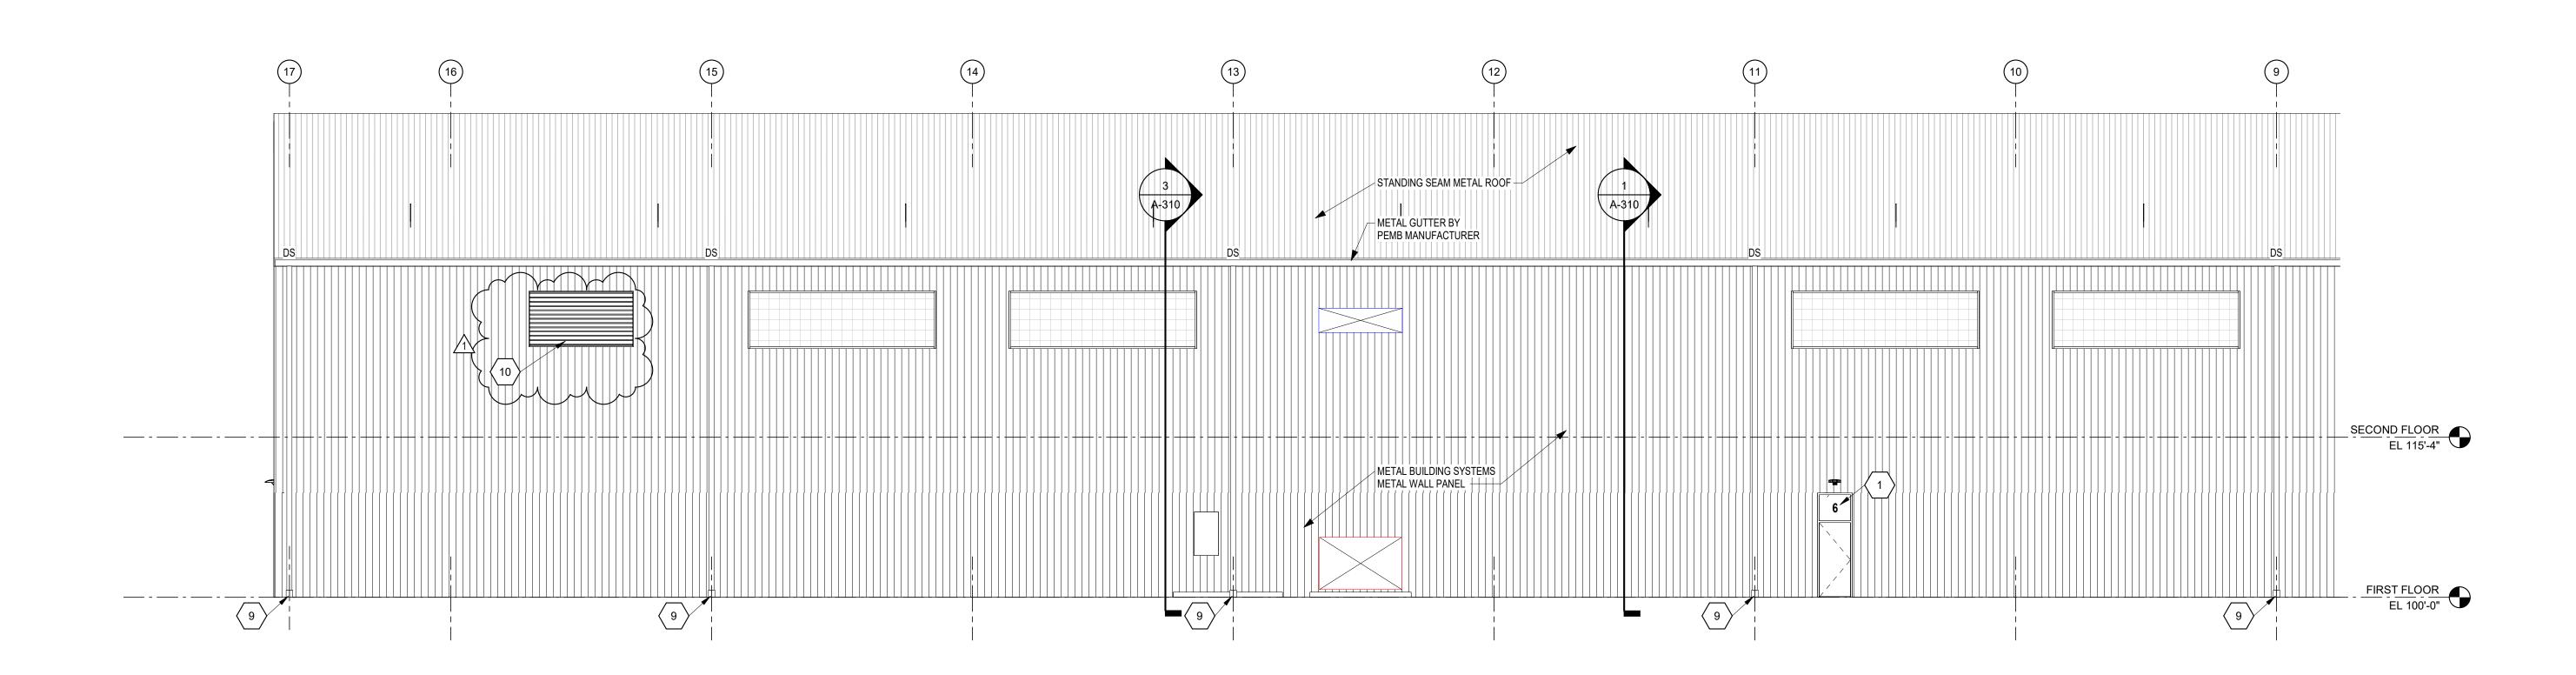

WEST ELEVATION - NORTH

SCALE: 1/8" = 1'-0"

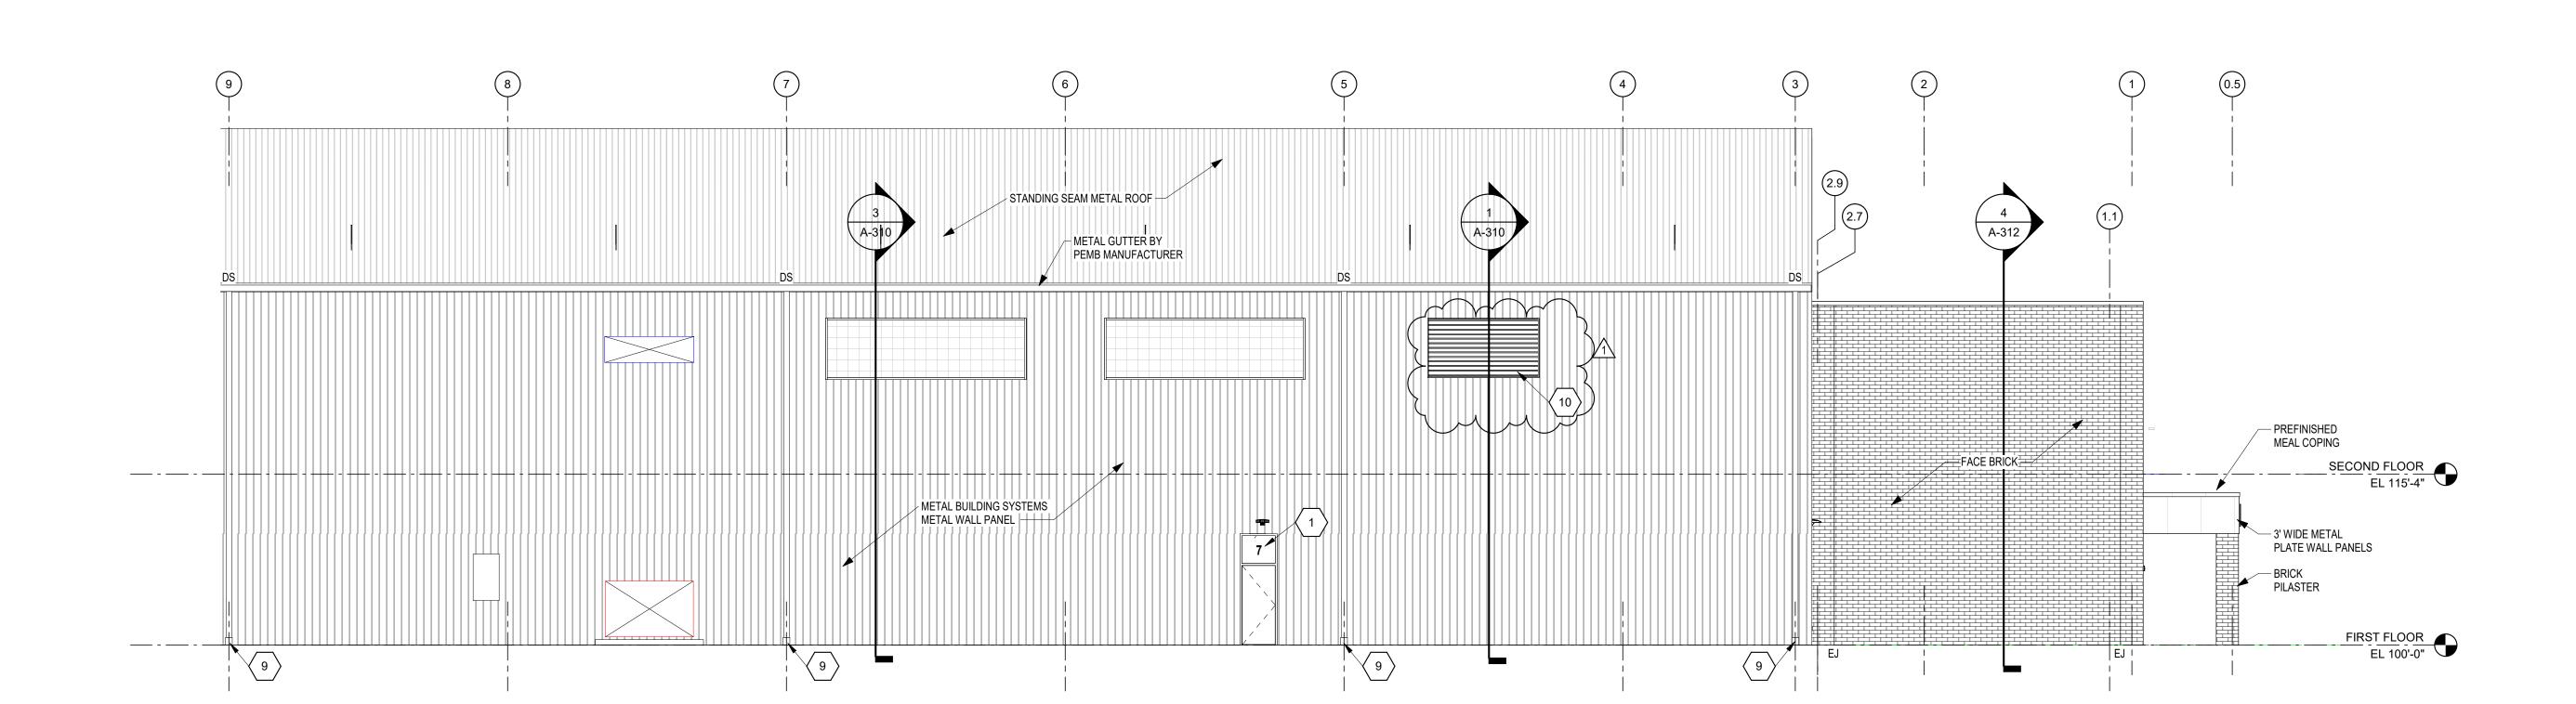

WEST ELEVATION - SOUTH

SCALE: 1/8" = 1'-0"

ELEVATIONS GENERAL NOTES

- A. REFER TO THE ELECTRICAL AND TECHNOLOGY DRAWINGS FOR CAMERA, LOCATIONS, SECURITY DEVICES, RECEPTACLES, LIGHT FIXTURES, ETC. COORDINATE
- LOCATIONS WITH VENEER COURSING TO PROVIDE
 CONSISTENT MOUNTING HEIGHTS.

 B. REFER TO PLUMBING DRAWINGS FOR EXTERIOR WALL
 HYDRANTS, SECONDARY ROOF DRAIN OUTLETS, ETC.
 COORDINATE PENETRATIONS THROUGH EXTERIOR
 ENVELOPE WITH OTHER TRADES. PROVIDE TRANSITION
- ENVELOPE WITH OTHER TRADES. PROVIDE TRANSITION MEMBRANE TO MAINTAIN AIR BARRIER SYSTEM.

 C. REFER TO MECHANICAL DRAWINGS FOR EXTERIOR LOUVER LOCATIONS LOCATED IN EXTERIOR WALL AND EXTERIOR SOFFITS. COORDINATE PENETRATIONS THROUGH EXTERIOR ENVELOPE WITH OTHER TRADES. PROVIDE TRANSITION MEMBRANE TO MAINTAIN AIR

BUILDING ELEVATION NOTES

BARRIER SYSTEM.

(ALL NOTES MAY NOT BE INDICATED ON THIS SHEET)

1. VINYL ENTRANCE NUMBERS

- 2. FACE LIT LED ILLUMINATED CHANNEL LOGO MOUNTED
 FLUSH TO BRICK OVERALL SIZE IS 8'-0" x 9'-2". THE SHIELD
 AND CROWN ARE TWO SEPARATE SIGNS.
- 3. KNOX BOX
 4. AIR INTAKE LOUVER (D1) (5'-0" x 4'-0") HEAD AT 10'-0" ABOVE FIRST FLOOR LINE

 AIR INTAKE LOUVER (D2) (5'-0" x 2'-0") HEAD AT 0'-4" ABOVE
- AIR INTAKE LOUVER (D2) (5'-0" x 3'-0") HEAD AT 9'-4" ABOVE SECOND FLOOR LINE.
 AIR INTAKE LOUVER (D4 & D5) (10'-0" x 2'-4") HEAD AT 13'-0"
- ABOVE FIRST FLOOR LINE

 ABOVE FIRST FLOOR LINE

 AIR INTAKE LOUVER (A2) (4'-0" x 3'-0") HEAD AT 9'-4" ABOVE
- 8. AIR INTAKE LOUVER (A1) (5'-0" x 4'-0") HEAD AT 10'-0" ABOVE SECOND FLOOR LINE
- SECOND FLOOR LINE

 9 DOWNSPOUT BOOT SEE PLUMBING DRAWINGS

 10. AIR INTAKE LOUVER (A3, A4, A5 & B1) (10'-0" x 5'-4") HEAD AT 29'-4" ABOVE FIRST FLOOR LINE

 11. AIR INTAKE LOUVER (D3) (5'-0" x 2'-4") HEAD AT 13'-0" ABOVE

FIRST FLOOR LINE

Indiana 46545

12641 McKinley Highway, Mishawaka,

PENN HIGH

FIELDHOUSE

SCHOOL

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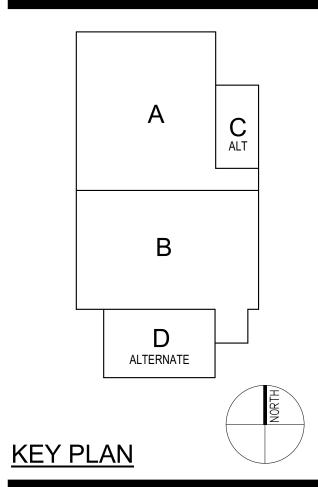
PENN-HARRIS-MADISON SCHOOL CORPORATION




RCHITECT



317.848.0966 WWW.FHAI.COM350 E NEW YORK ST #300, INDIANAPOLIS, IN 46204



Construction Documents

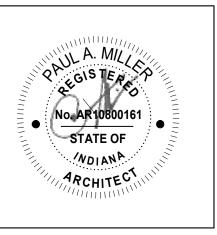

PROJECT MANAGER: MKS

PROJECT NUMBER: 222130.00
PROJECT ISSUE DATE: January 10, 2024

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NO.	DESCRIPTION	DATE
1	Addendum #1	1-26-24


VERIFICATION NOTE

CONTRACTOR SHALL VERIFY ALL DIMENSIONS AND CLEARANCES AND ALL EXISTING FIELD CONDITIONS BEFORE STARTING CONSTRUCTION. COMMENCEMENT OF WORK CONSTITUTES ACCEPTANCE OF CONDITIONS.

SHOULD DIFFERENT CONDITIONS BE ENCOUNTERED, CONTACT THE ARCHITECT BEFORE PROCEEDING WITH WORK.

BUILDING ELEVATIONS

A-204

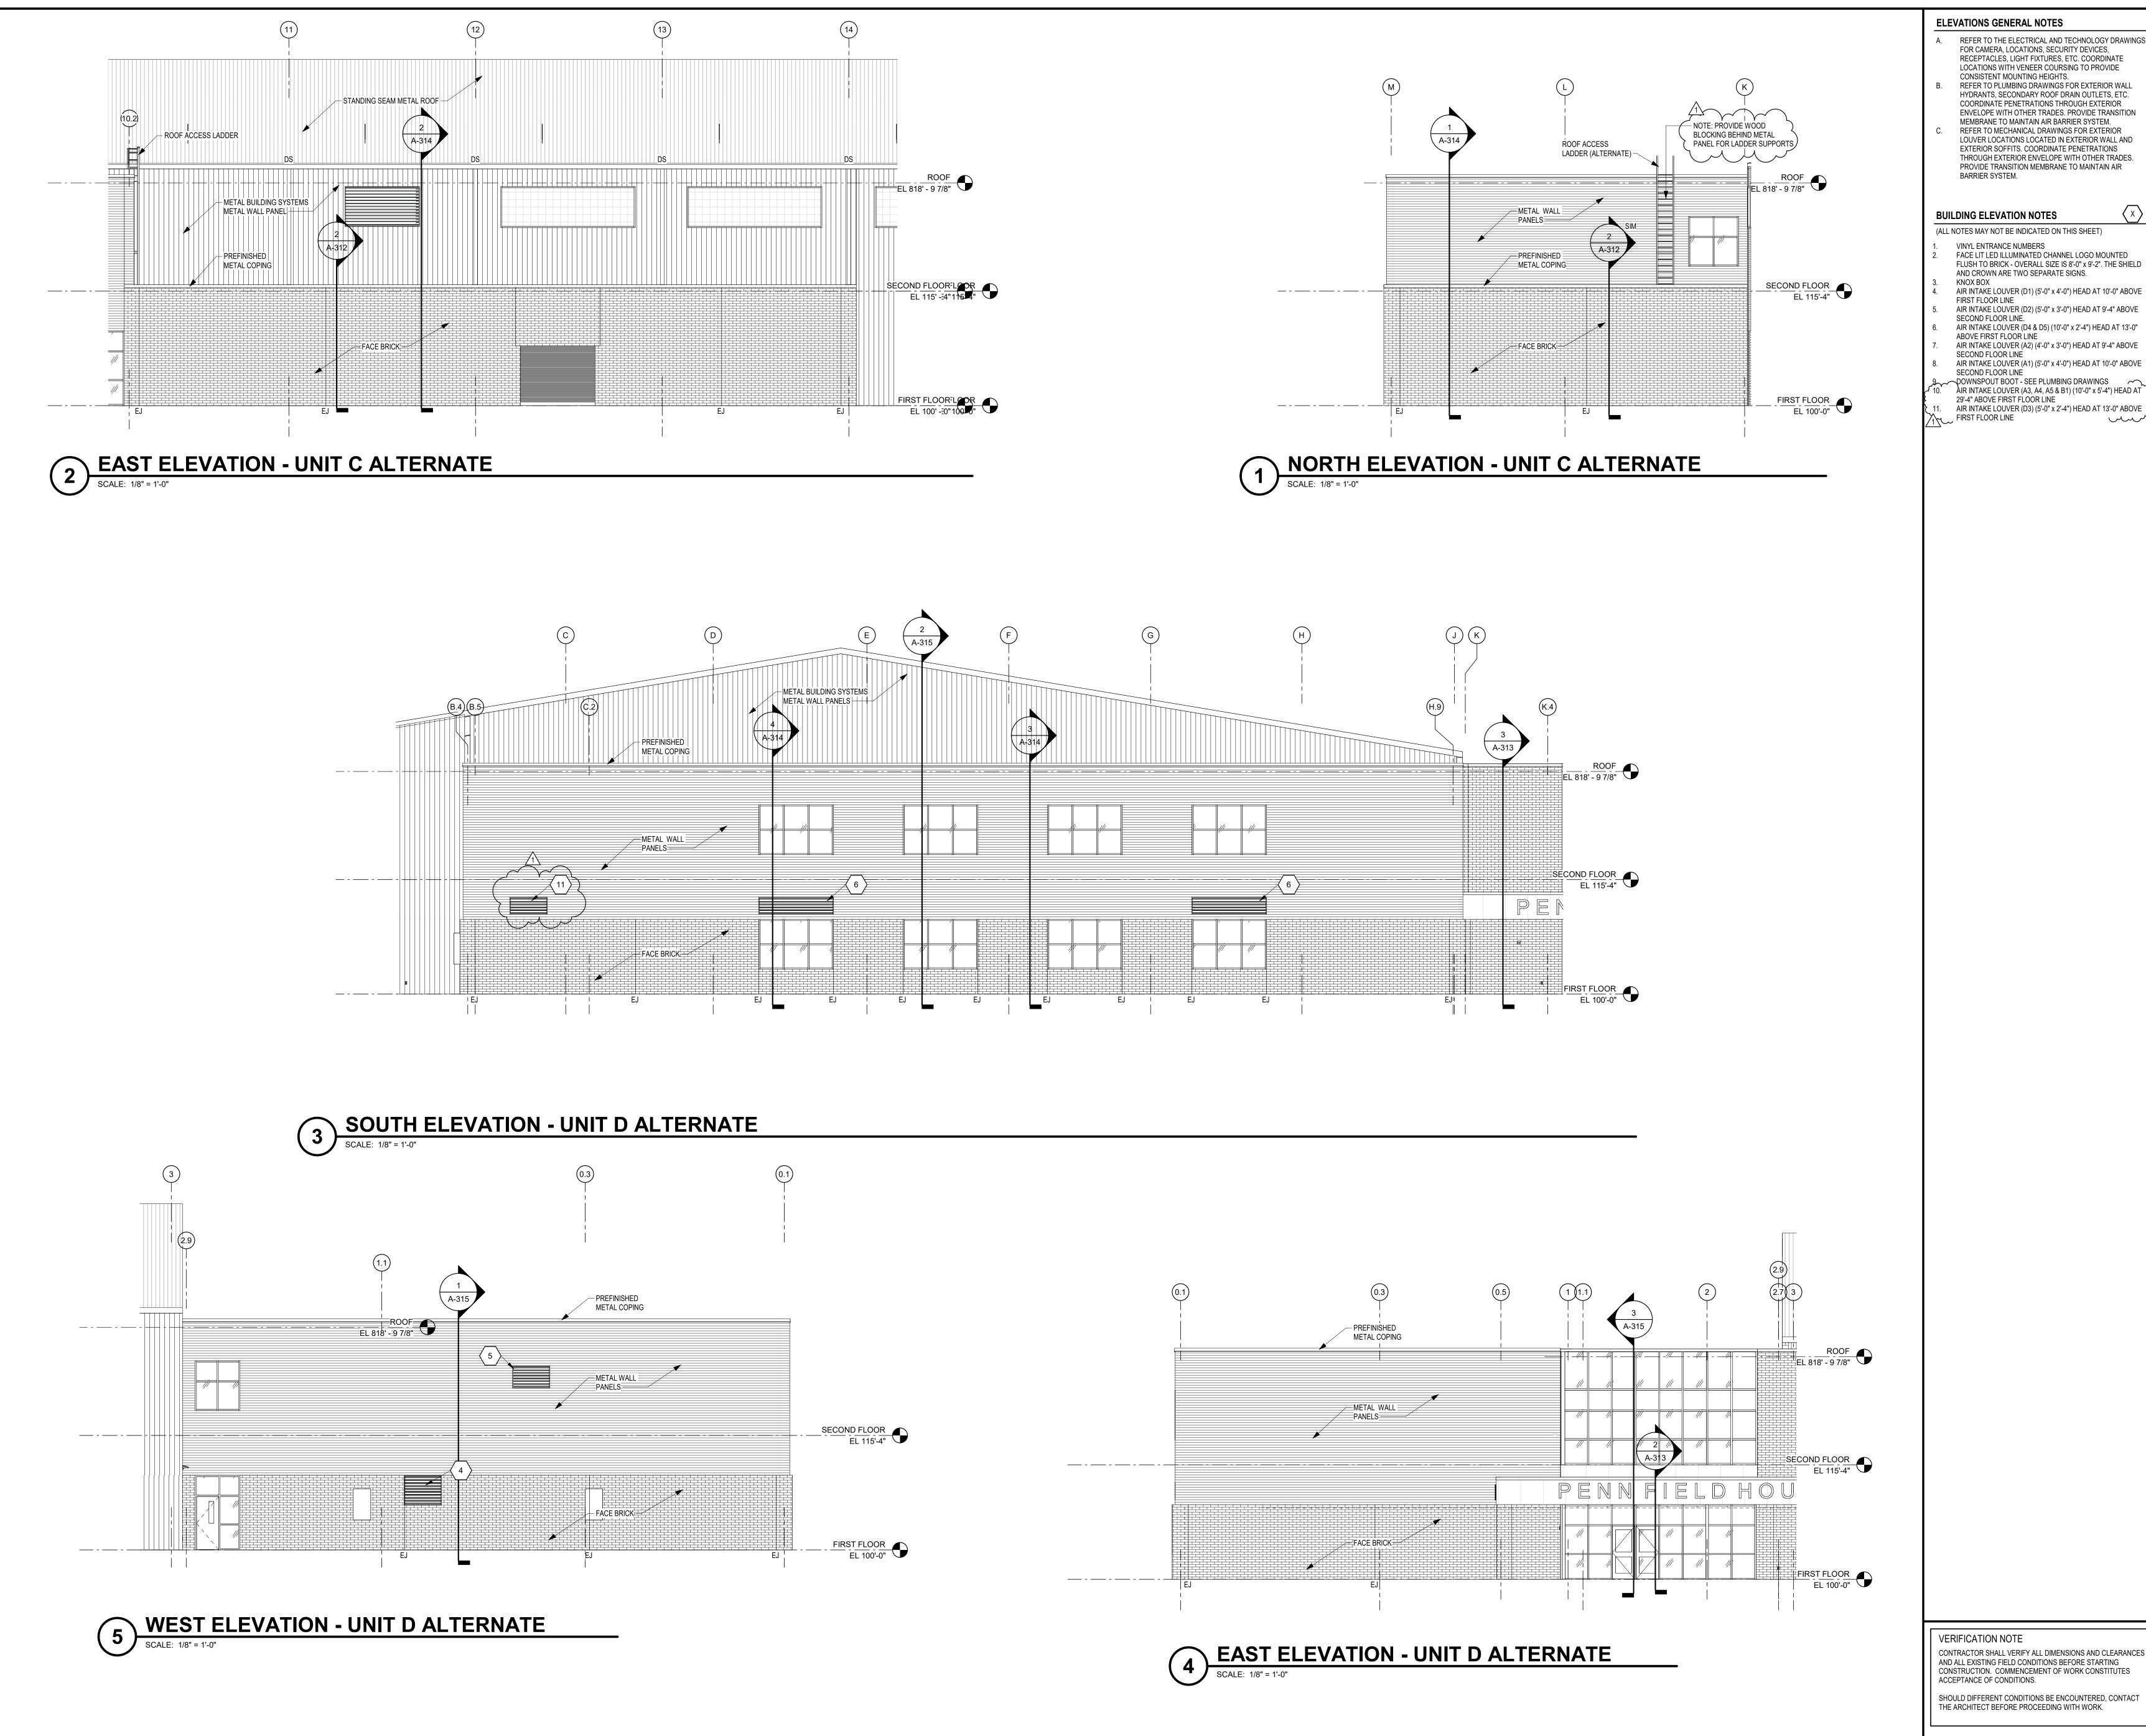

ELEVATIONS GENERAL NOTES

REFER TO THE ELECTRICAL AND TECHNOLOGY DRAWINGS FOR CAMERA, LOCATIONS, SECURITY DEVICES, RECEPTACLES, LIGHT FIXTURES, ETC. COORDINATE LOCATIONS WITH VENEER COURSING TO PROVIDE CONSISTENT MOUNTING HEIGHTS. REFER TO PLUMBING DRAWINGS FOR EXTERIOR WALL

HYDRANTS, SECONDARY ROOF DRAIN OUTLETS, ETC. COORDINATE PENETRATIONS THROUGH EXTERIOR ENVELOPE WITH OTHER TRADES. PROVIDE TRANSITION MEMBRANE TO MAINTAIN AIR BARRIER SYSTEM. REFER TO MECHANICAL DRAWINGS FOR EXTERIOR LOUVER LOCATIONS LOCATED IN EXTERIOR WALL AND EXTERIOR SOFFITS. COORDINATE PENETRATIONS THROUGH EXTERIOR ENVELOPE WITH OTHER TRADES.

PROVIDE TRANSITION MEMBRANE TO MAINTAIN AIR BARRIER SYSTEM.

(ALL NOTES MAY NOT BE INDICATED ON THIS SHEET) VINYL ENTRANCE NUMBERS

FACE LIT LED ILLUMINATED CHANNEL LOGO MOUNTED FLUSH TO BRICK - OVERALL SIZE IS 8'-0" x 9'-2". THE SHIELD AND CROWN ARE TWO SEPARATE SIGNS. KNOX BOX

FIRST FLOOR LINE AIR INTAKE LOUVER (D2) (5'-0" x 3'-0") HEAD AT 9'-4" ABOVE SECOND FLOOR LINE. AIR INTAKE LOUVER (D4 & D5) (10'-0" x 2'-4") HEAD AT 13'-0" ABOVE FIRST FLOOR LINE AIR INTAKE LOUVER (A2) (4'-0" x 3'-0") HEAD AT 9'-4" ABOVE SECOND FLOOR LINE

AIR INTAKE LOUVER (A1) (5'-0" x 4'-0") HEAD AT 10'-0" ABOVE SECOND FLOOR LINE

9 DOWNSPOUT BOOT - SEE PLUMBING DRAWINGS

10. AIR INTAKE LOUVER (A3, A4, A5 & B1) (10'-0" x 5'-4") HEAD AT 29'-4" ABOVE FIRST FLOOR LINE AIR INTAKE LOUVER (D3) (5'-0" x 2'-4") HEAD AT 13'-0" ABOVE

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SCHOOL


Indiana 46545



FANNING HOWEY

WWW.FHAI.COM 350 E NEW YORK ST #300, INDIANAPOLIS, IN 46204 ALTERNATE

Construction Documents

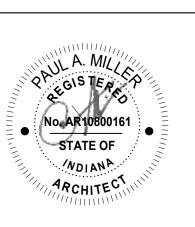

PROJECT MANAGER: MKS DRAWN BY: Author PROJECT NUMBER: 222130.00 PROJECT ISSUE DATE: January 10, 2024

KEY PLAN


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1	Addendum #1	1-26-24
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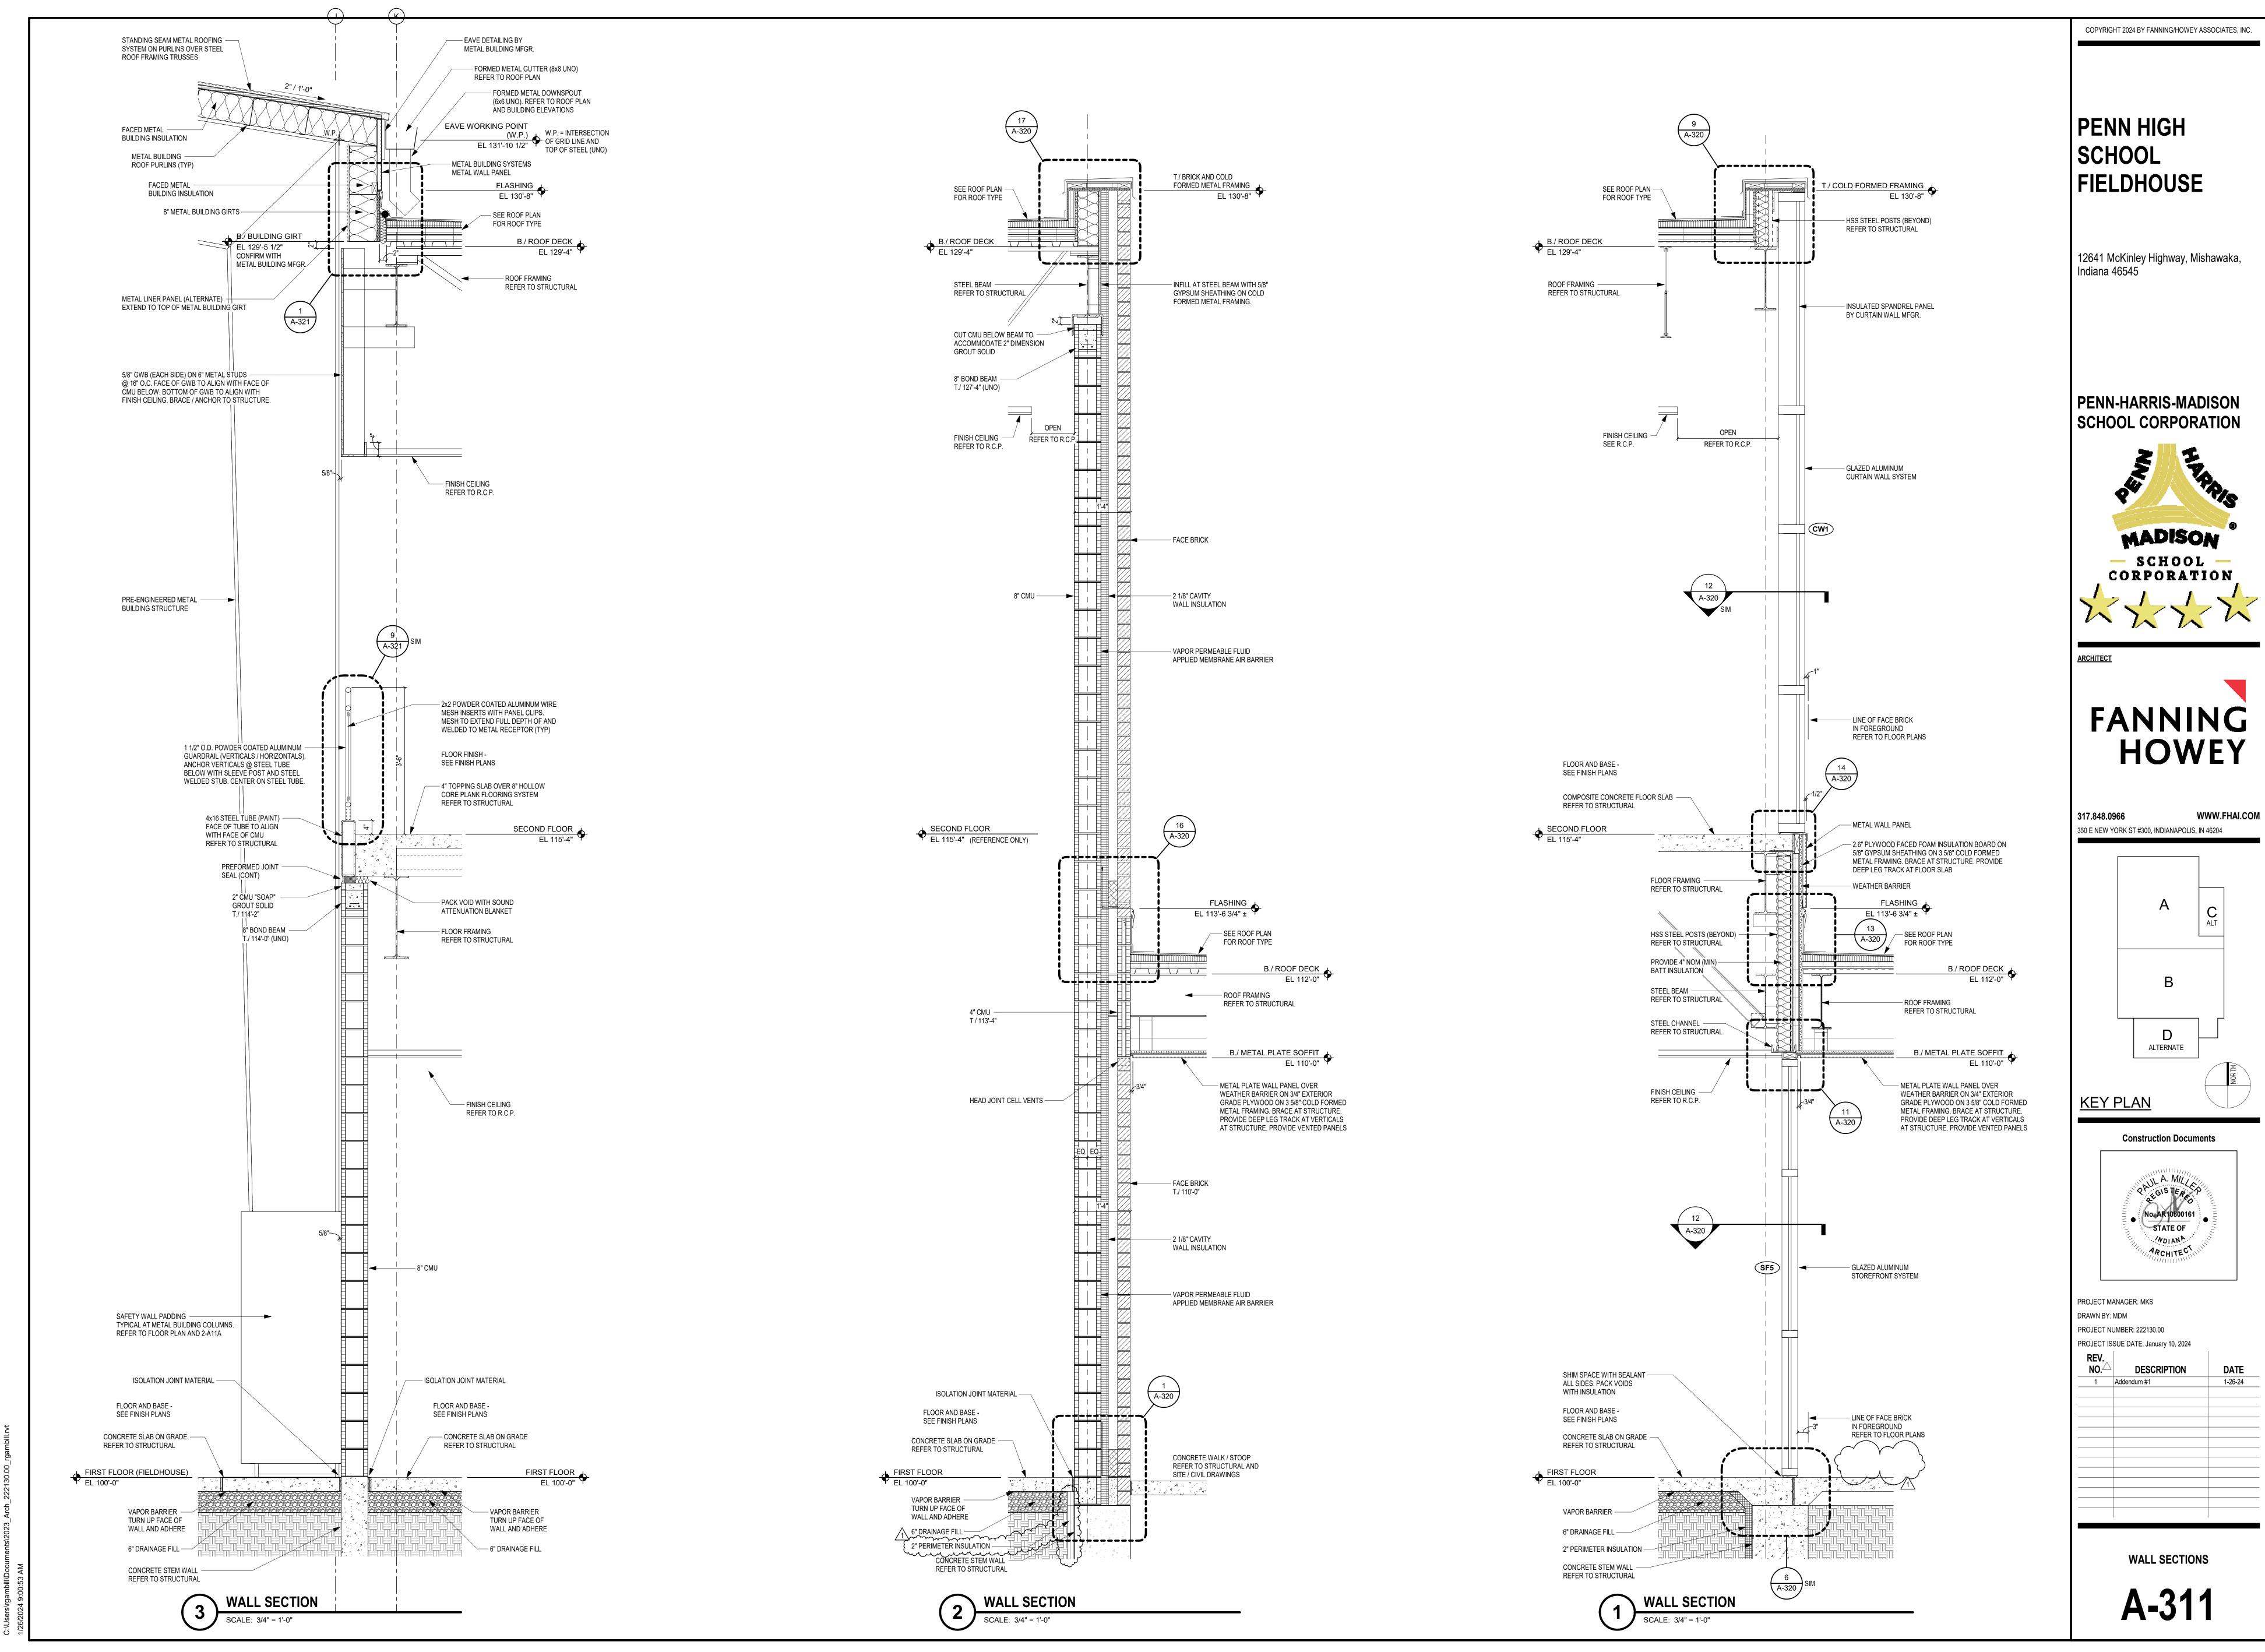
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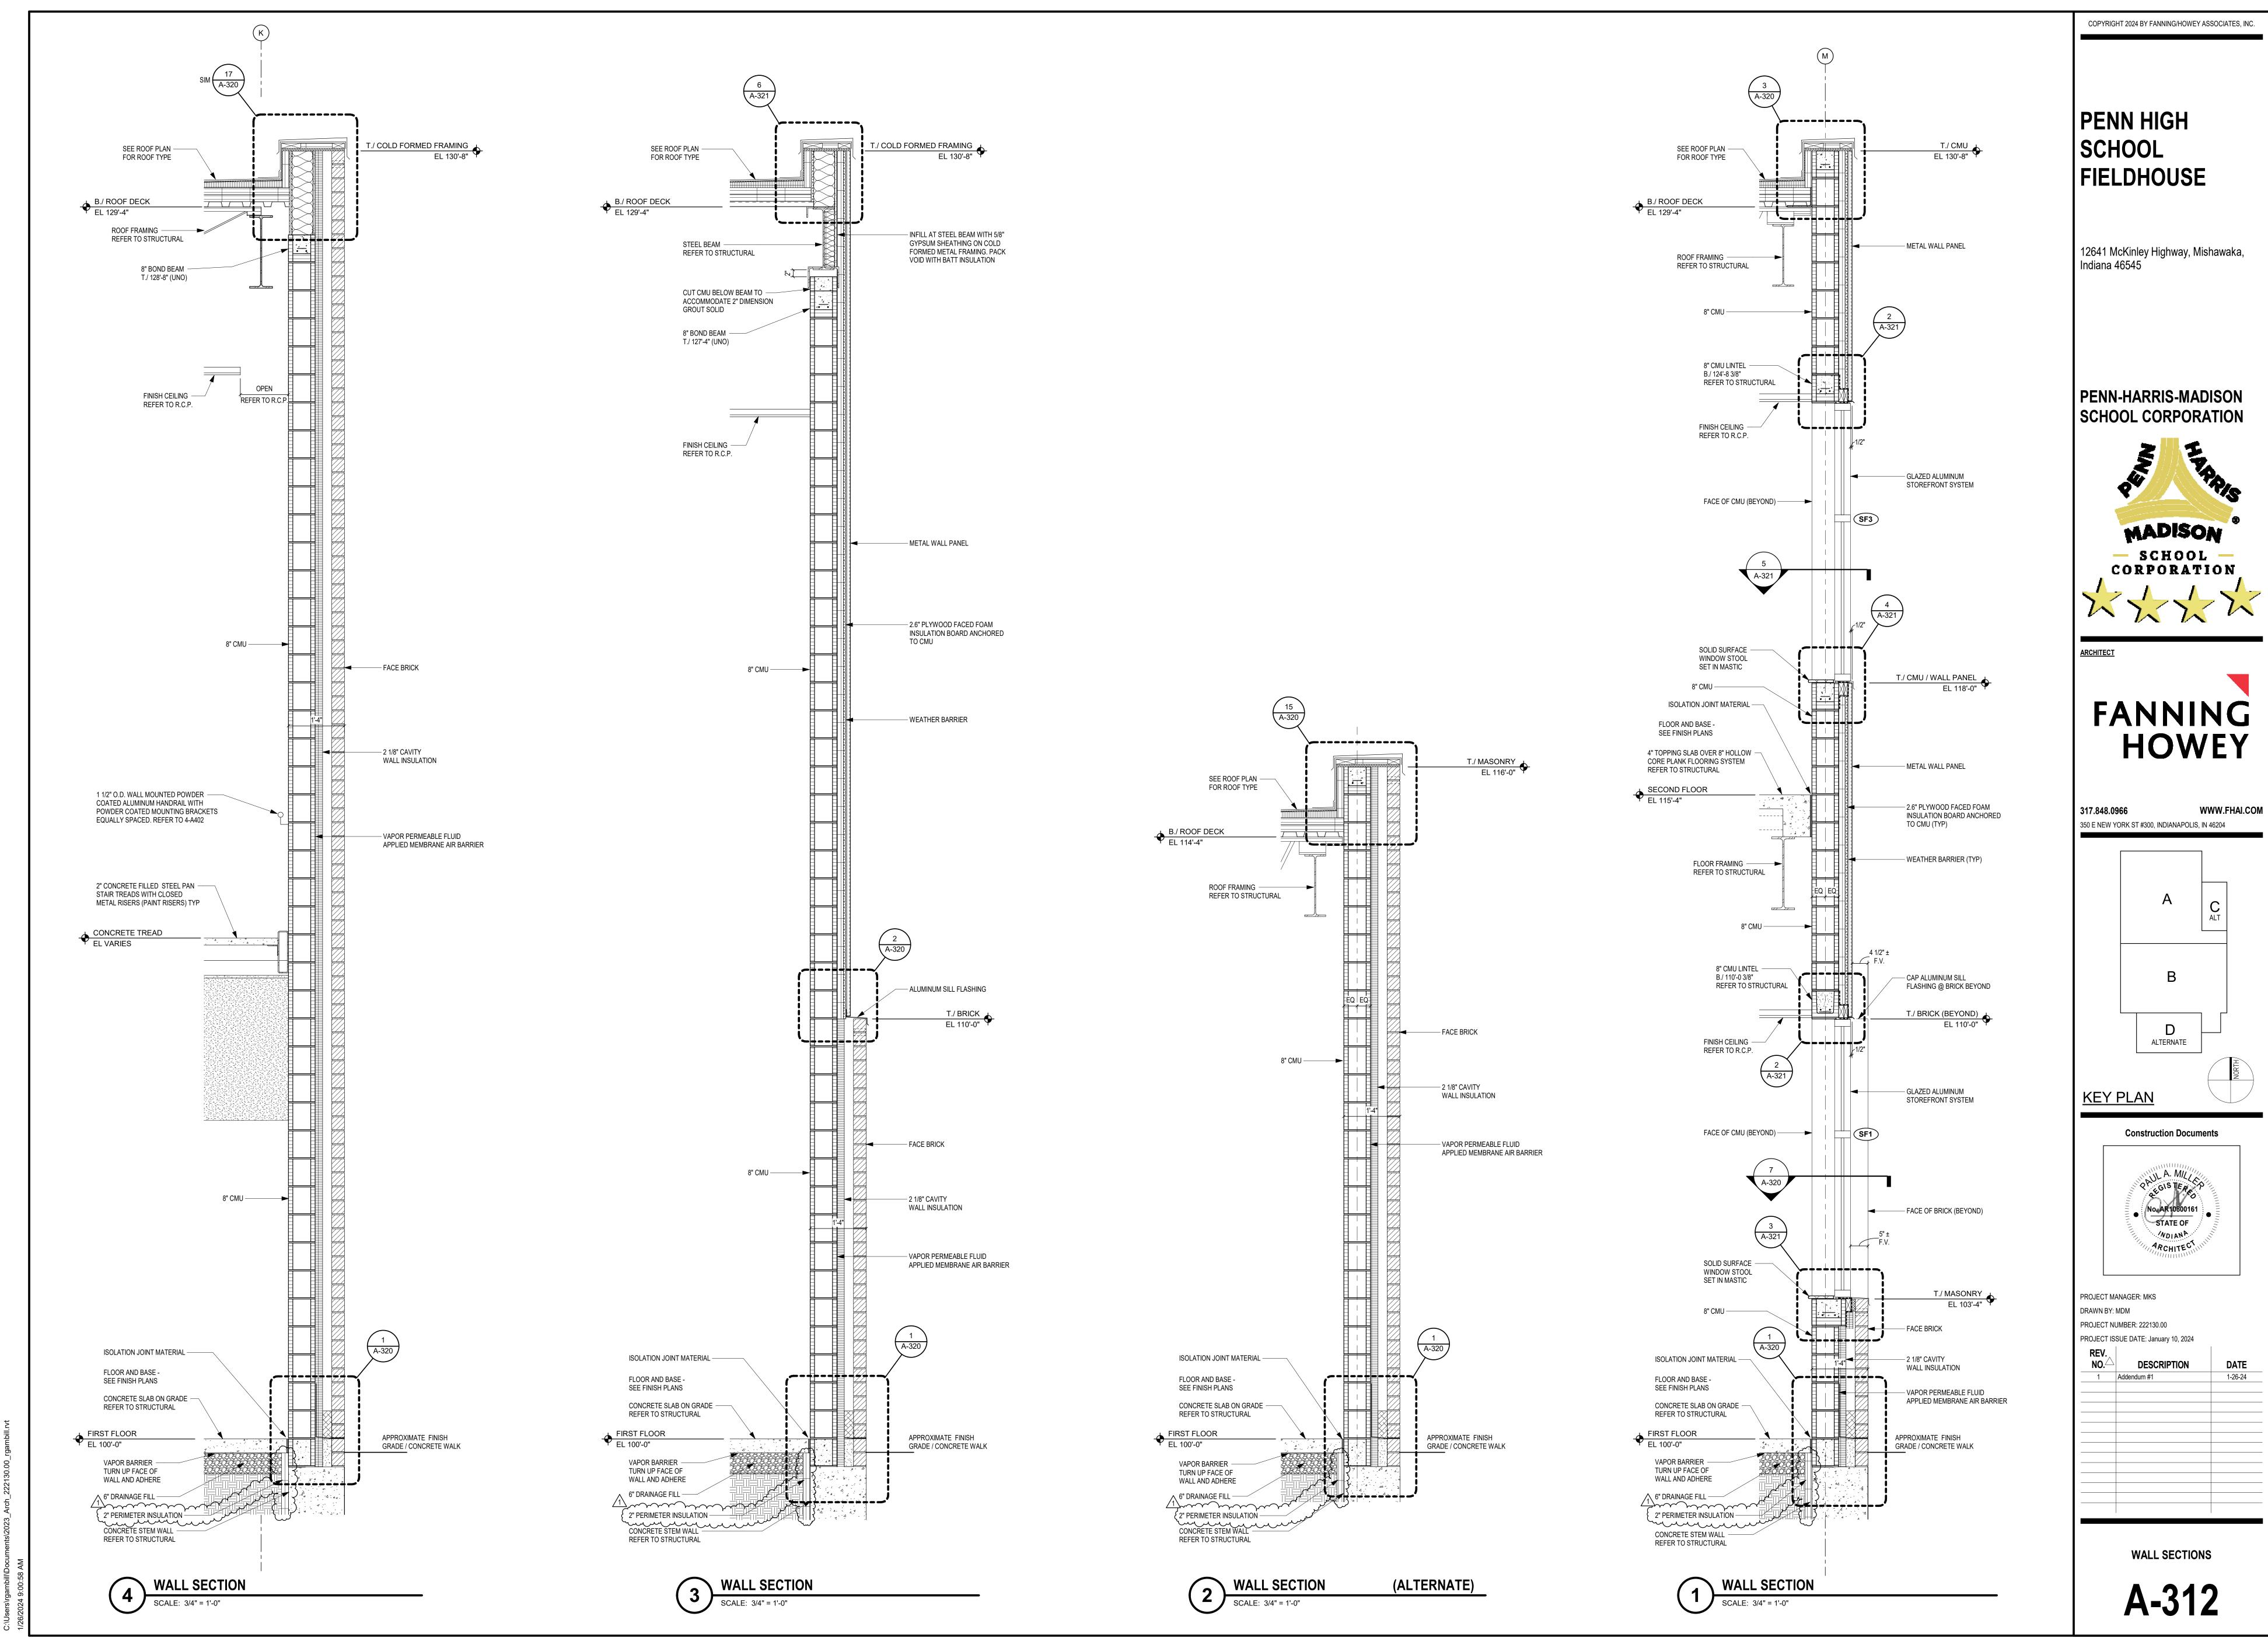
CONTRACTOR SHALL VERIFY ALL DIMENSIONS AND CLEARANCES AND ALL EXISTING FIELD CONDITIONS BEFORE STARTING CONSTRUCTION. COMMENCEMENT OF WORK CONSTITUTES ACCEPTANCE OF CONDITIONS.

SHOULD DIFFERENT CONDITIONS BE ENCOUNTERED, CONTACT THE ARCHITECT BEFORE PROCEEDING WITH WORK.


ELEVATIONS (ALTERNATE)







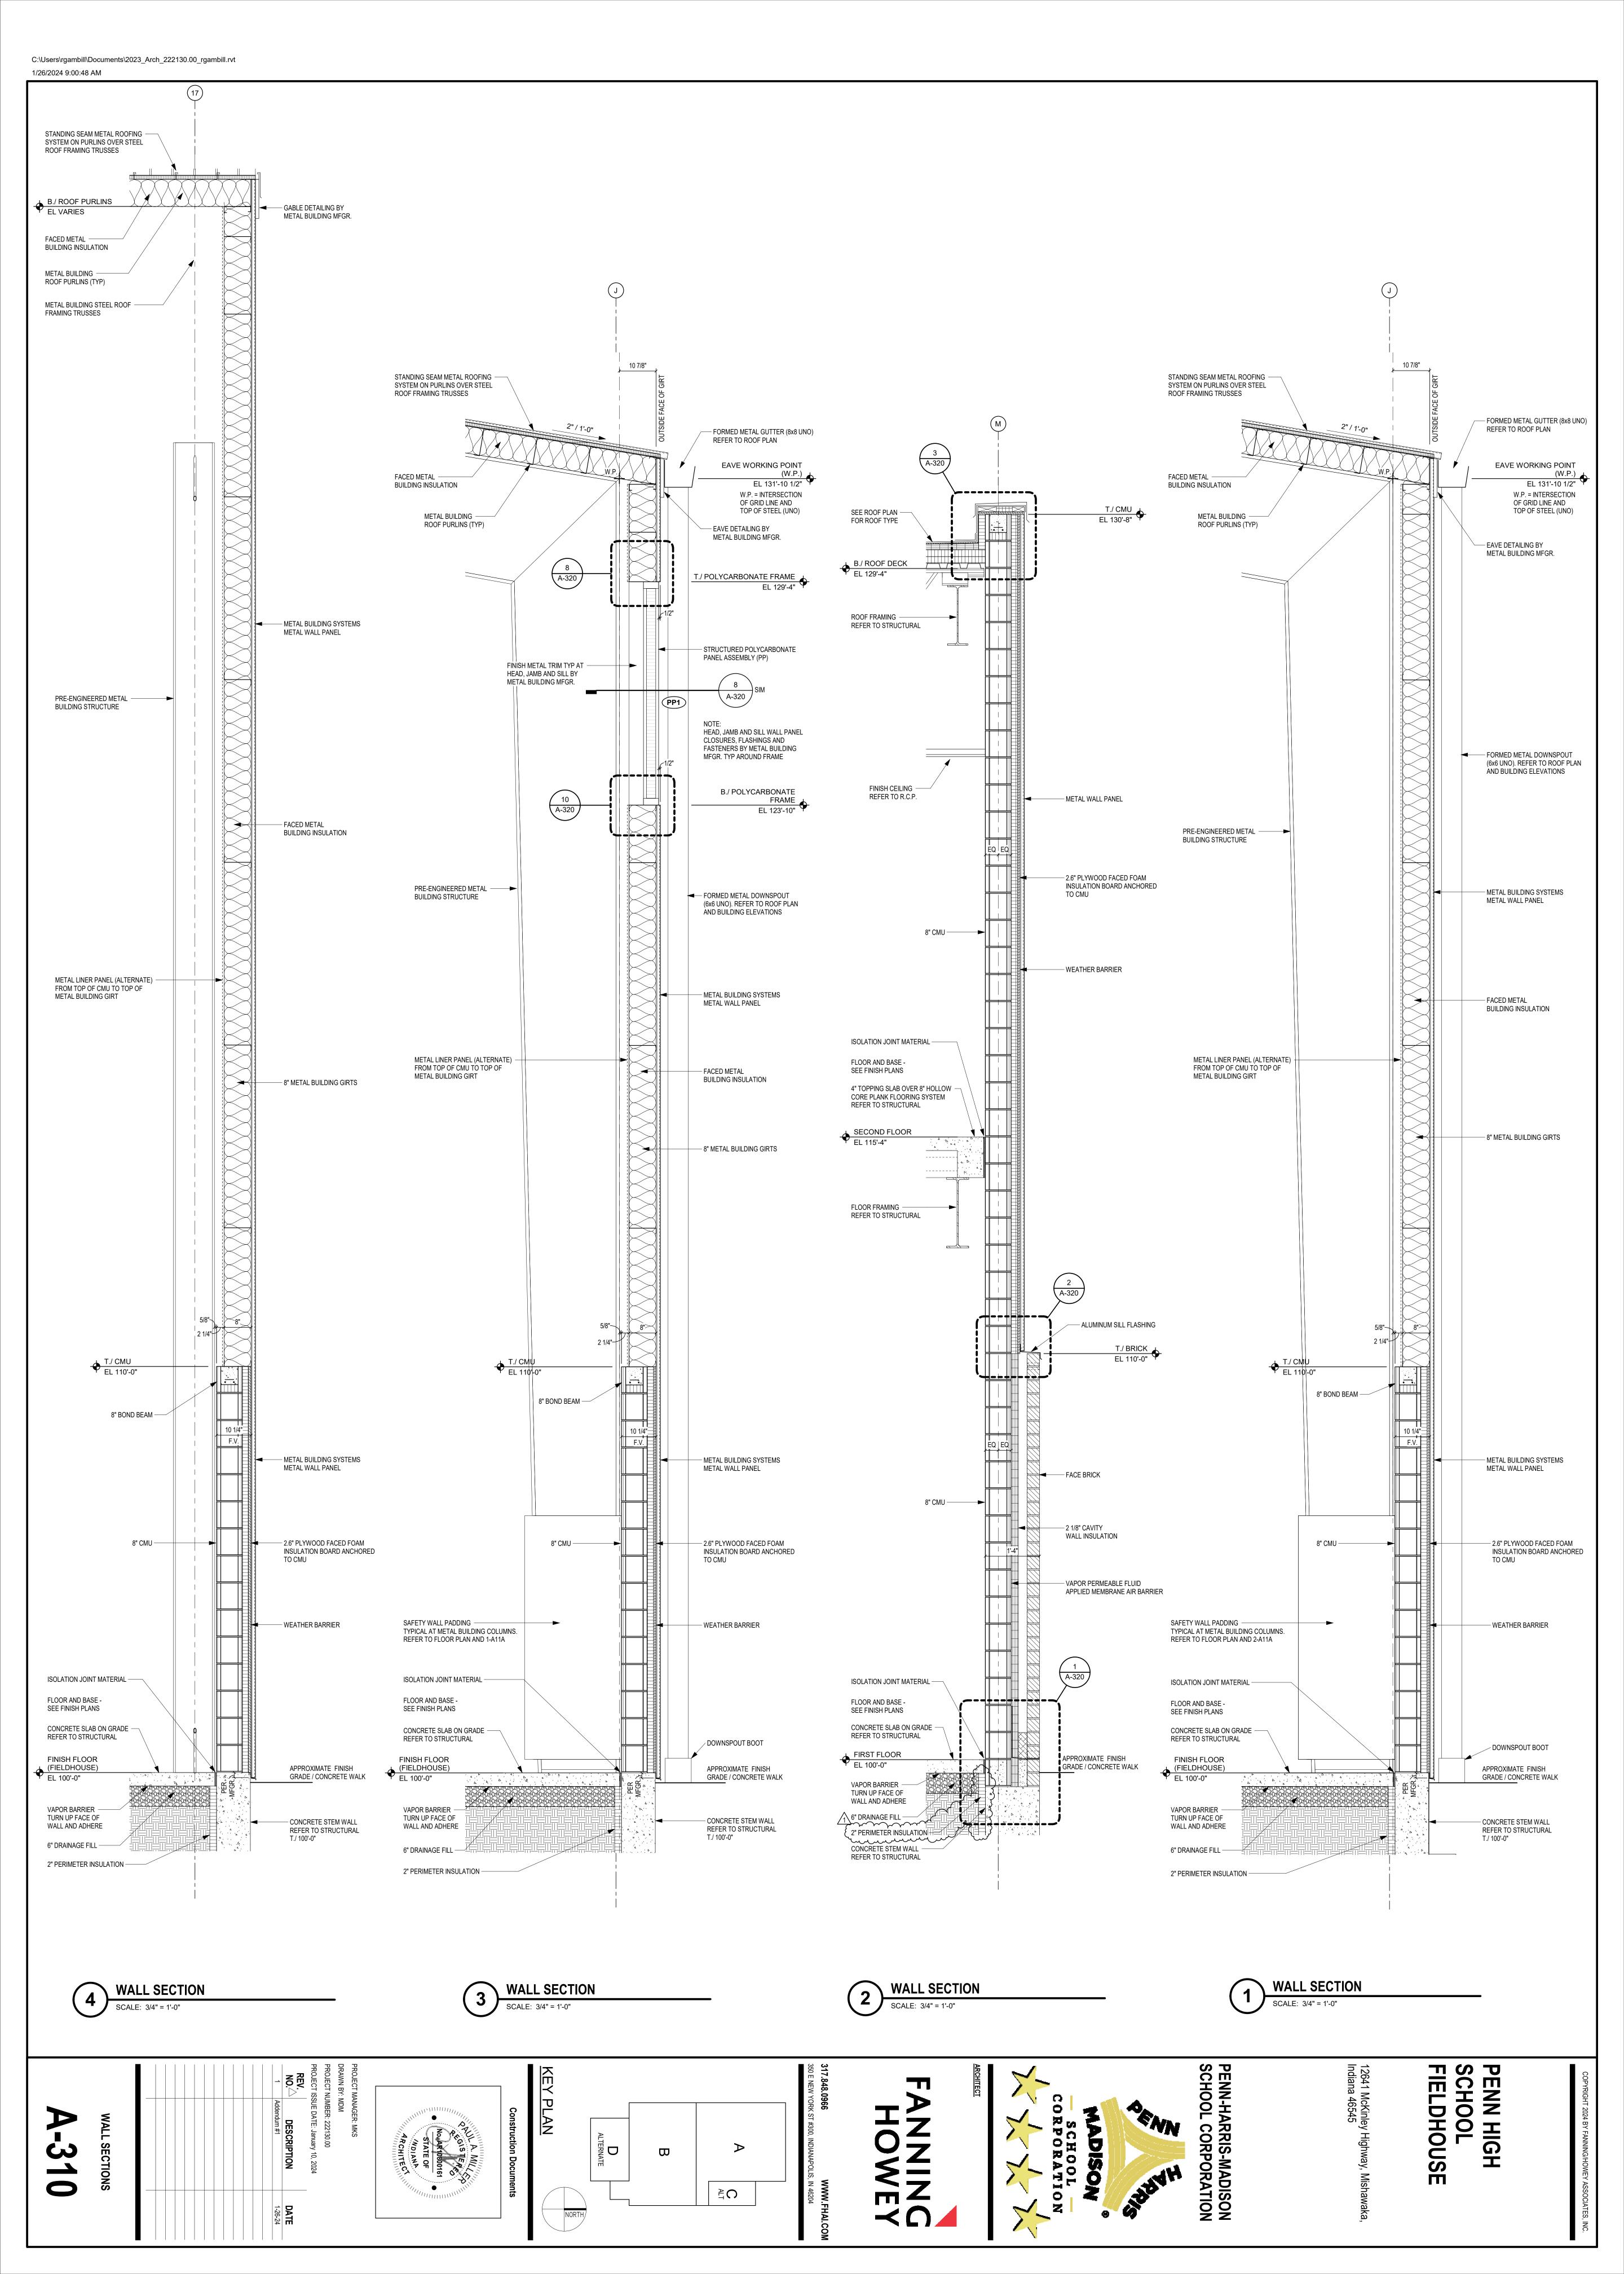

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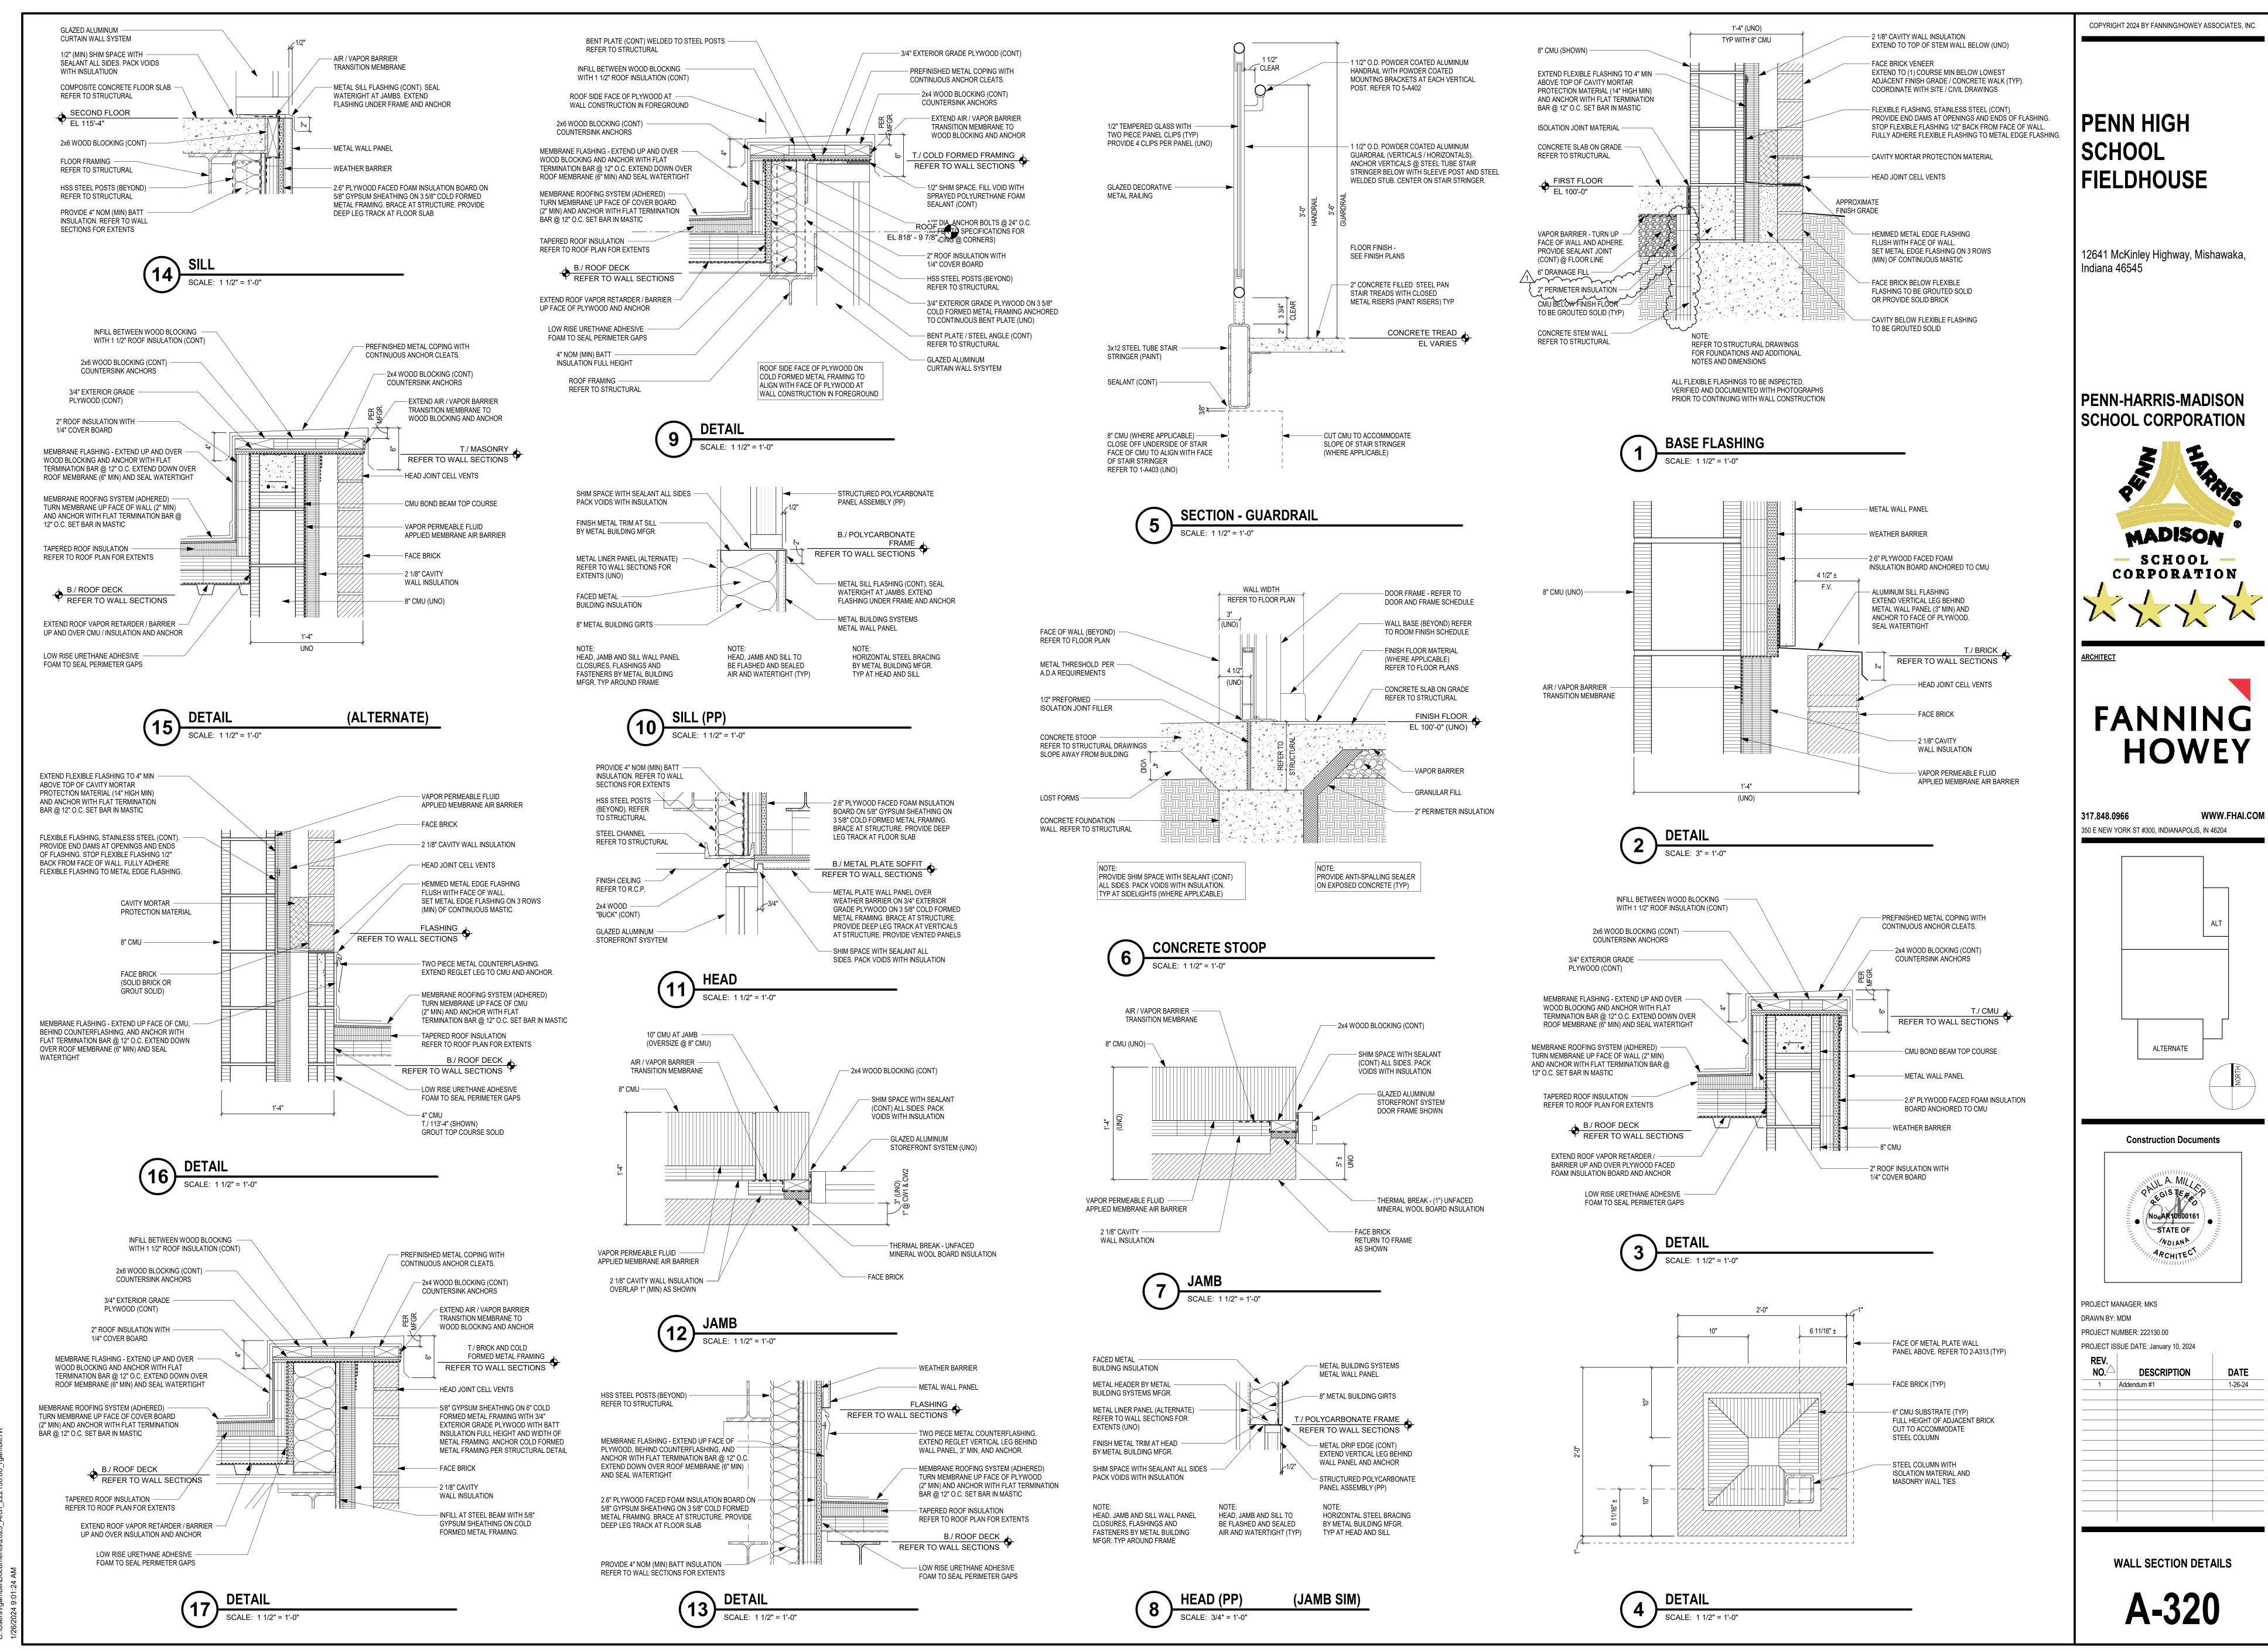


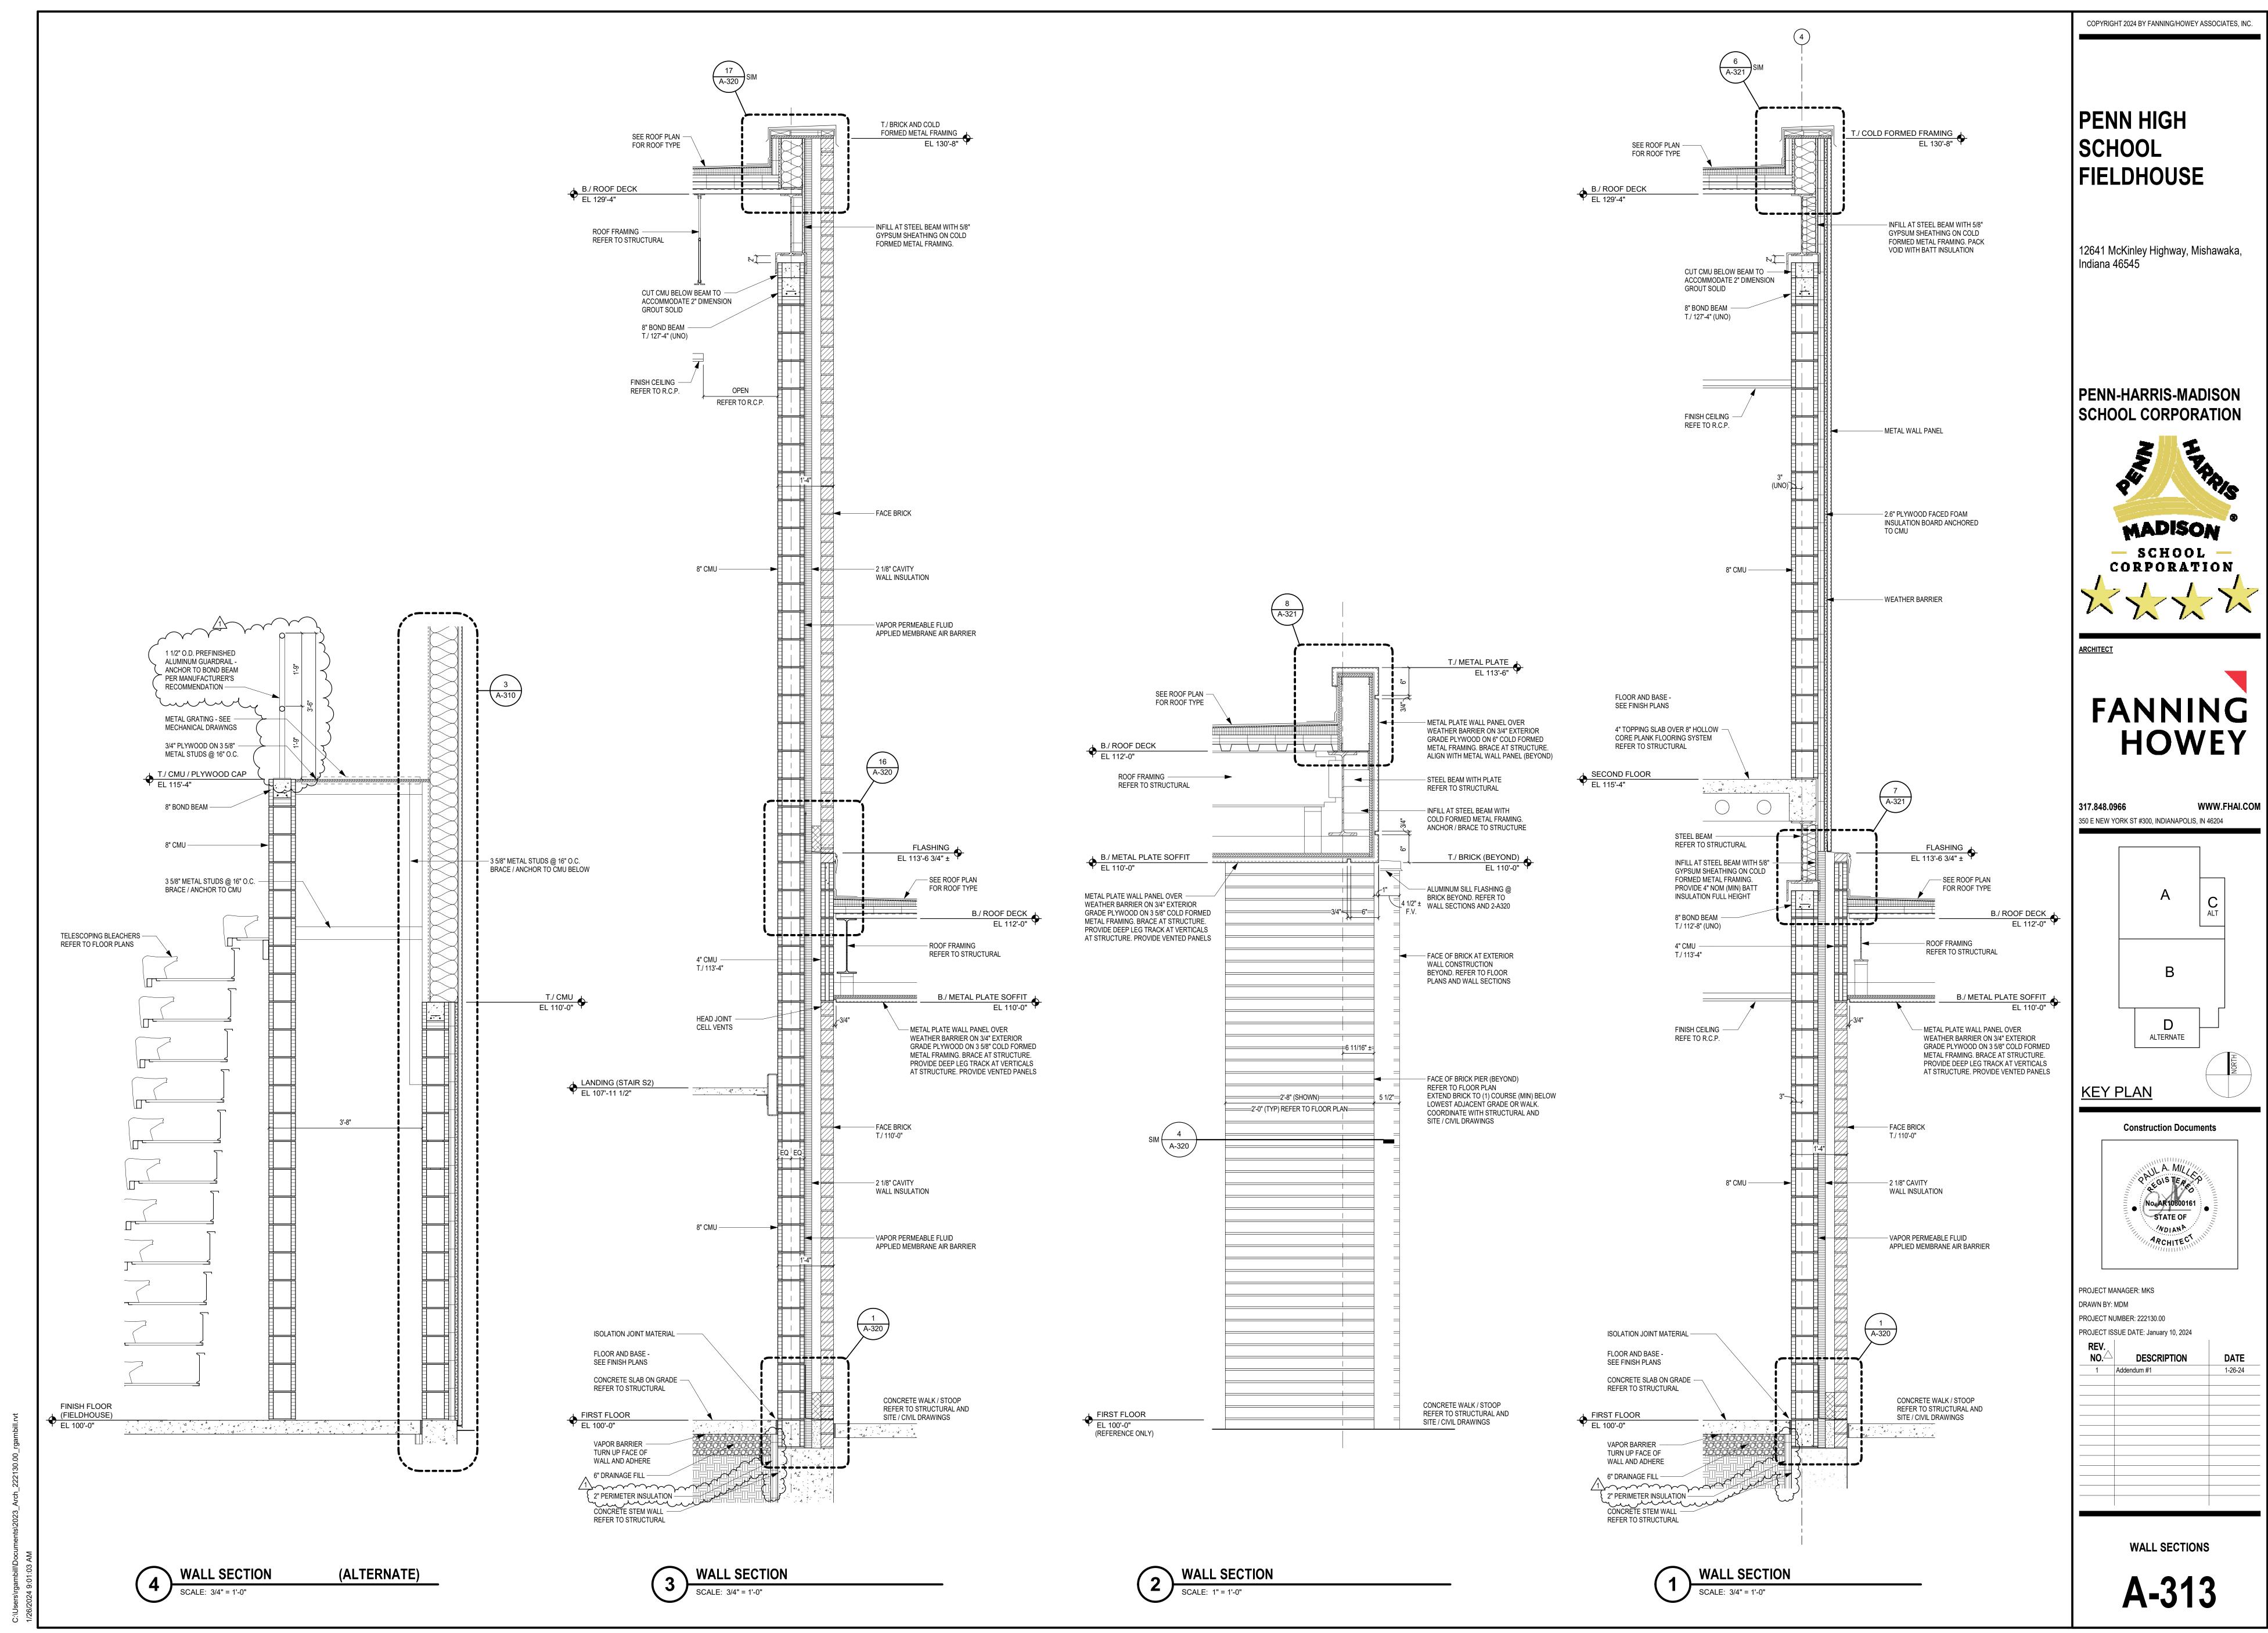

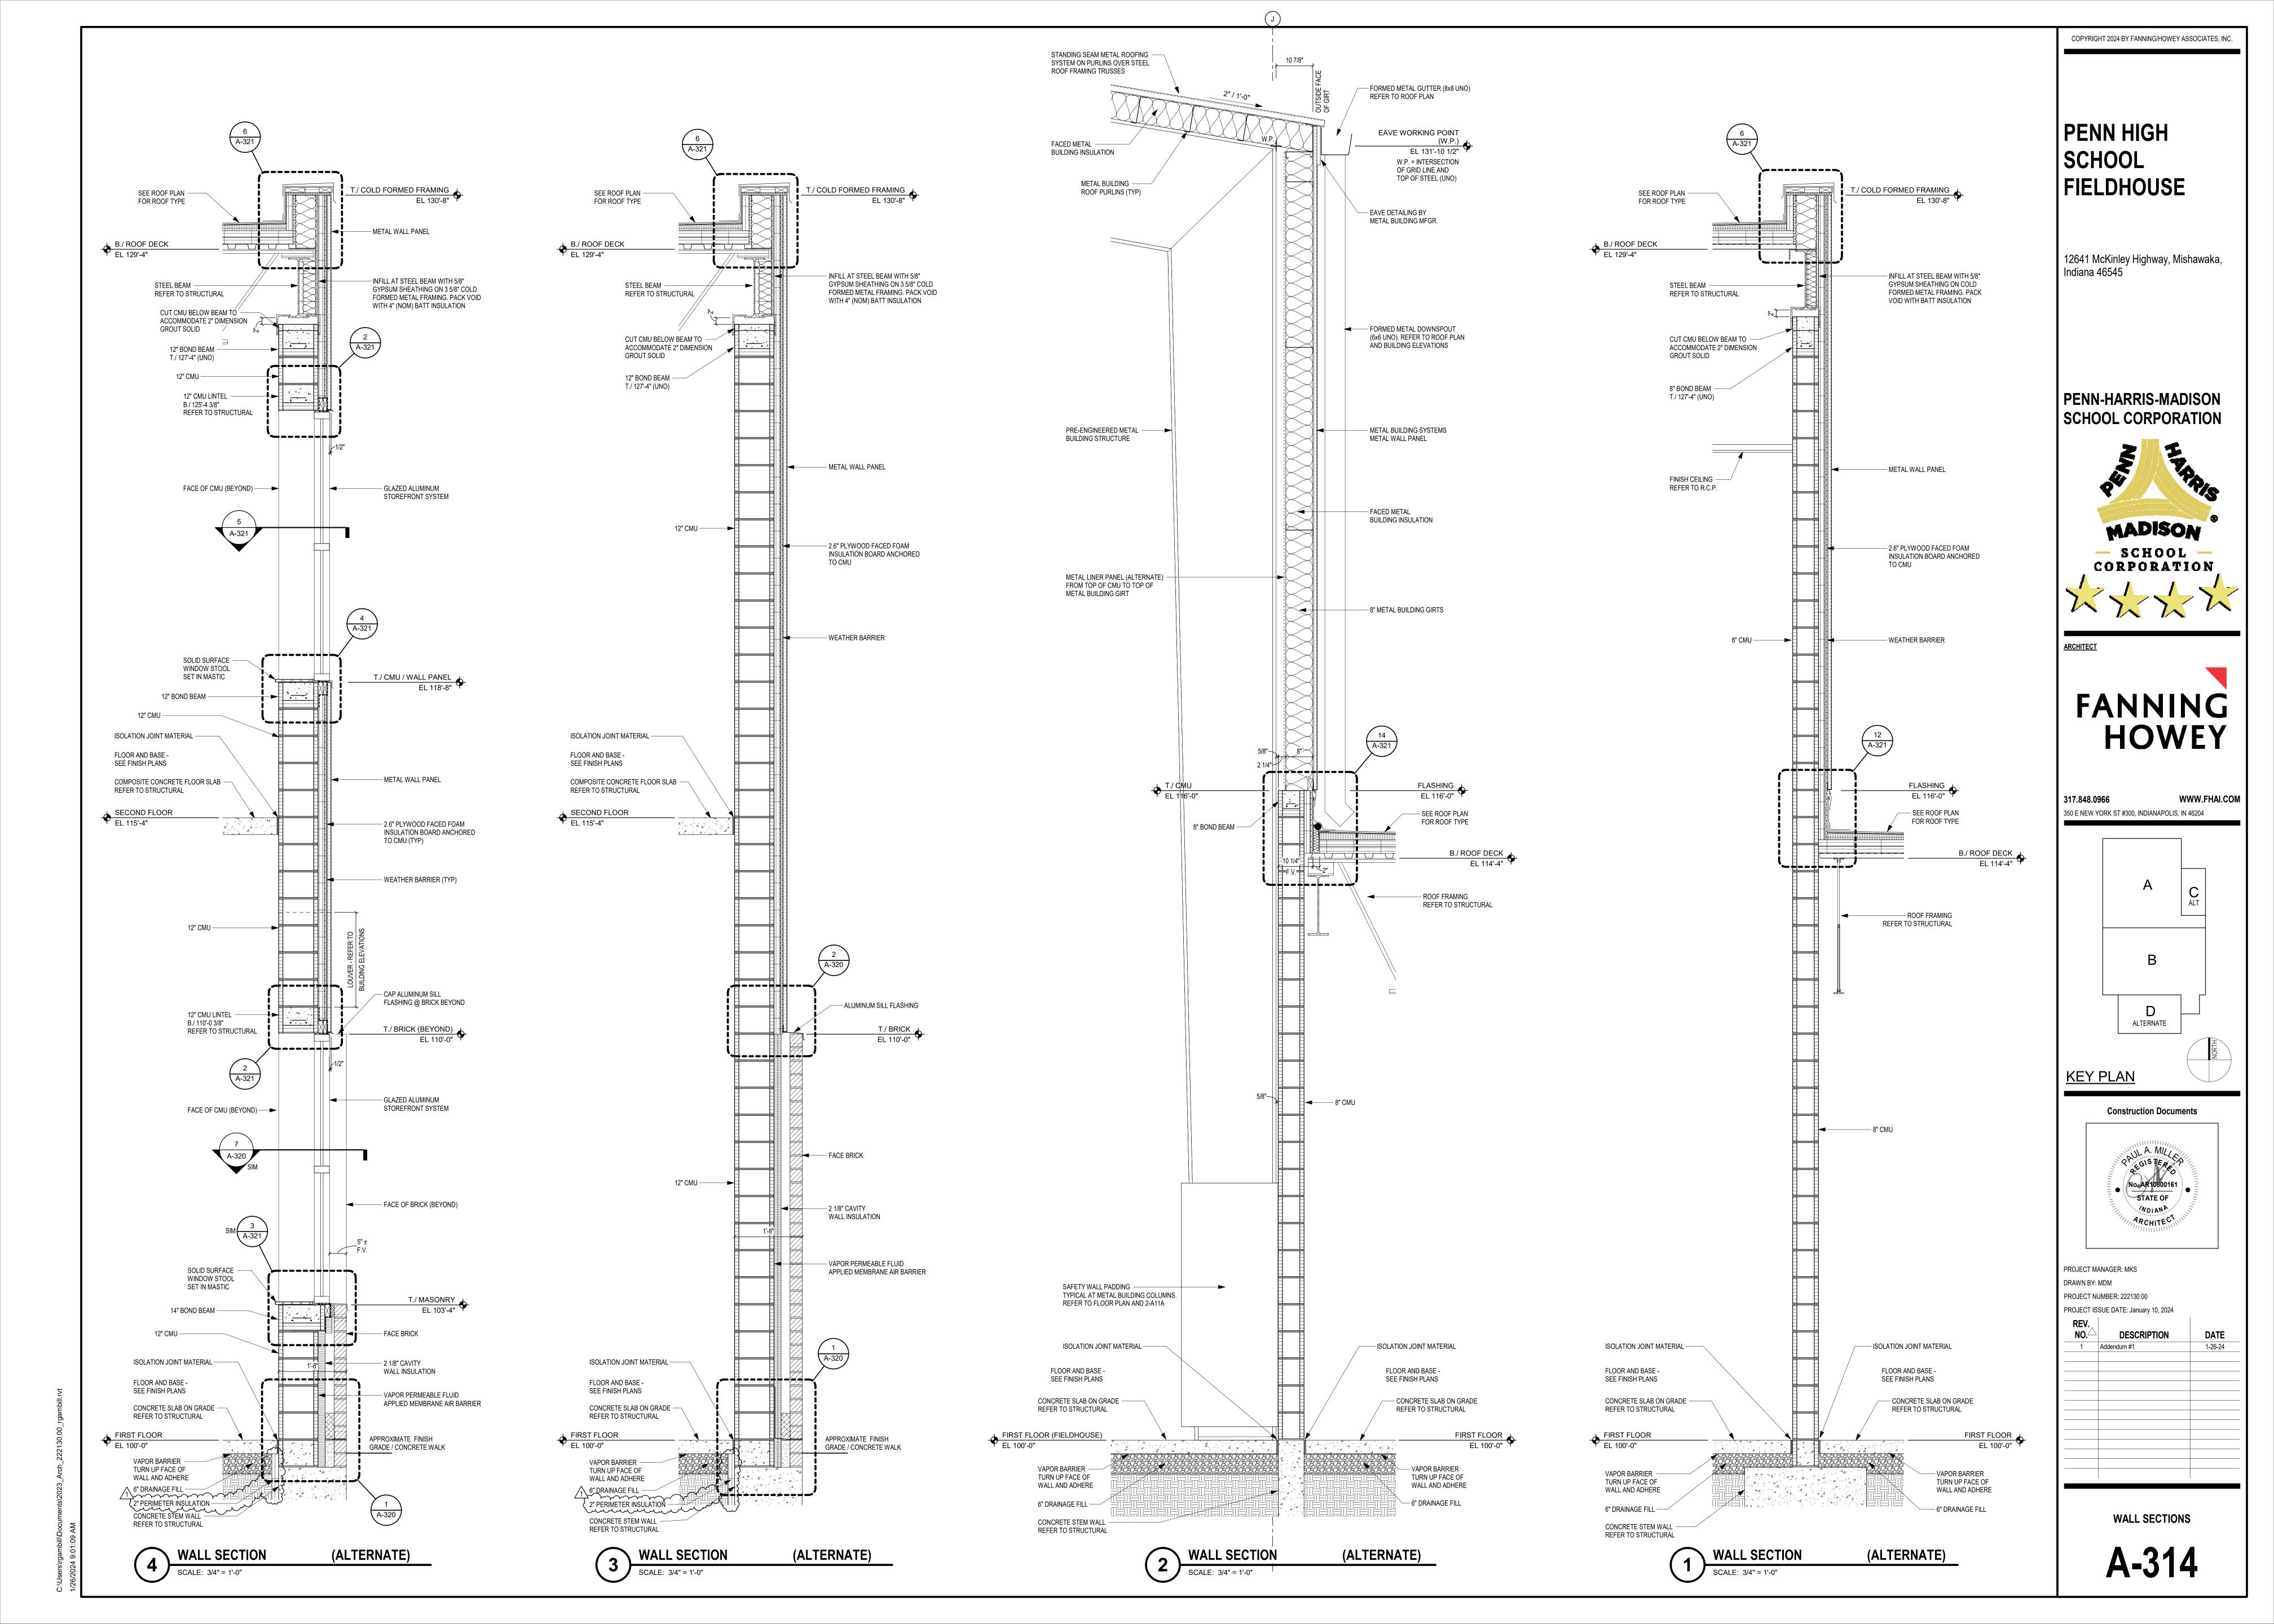

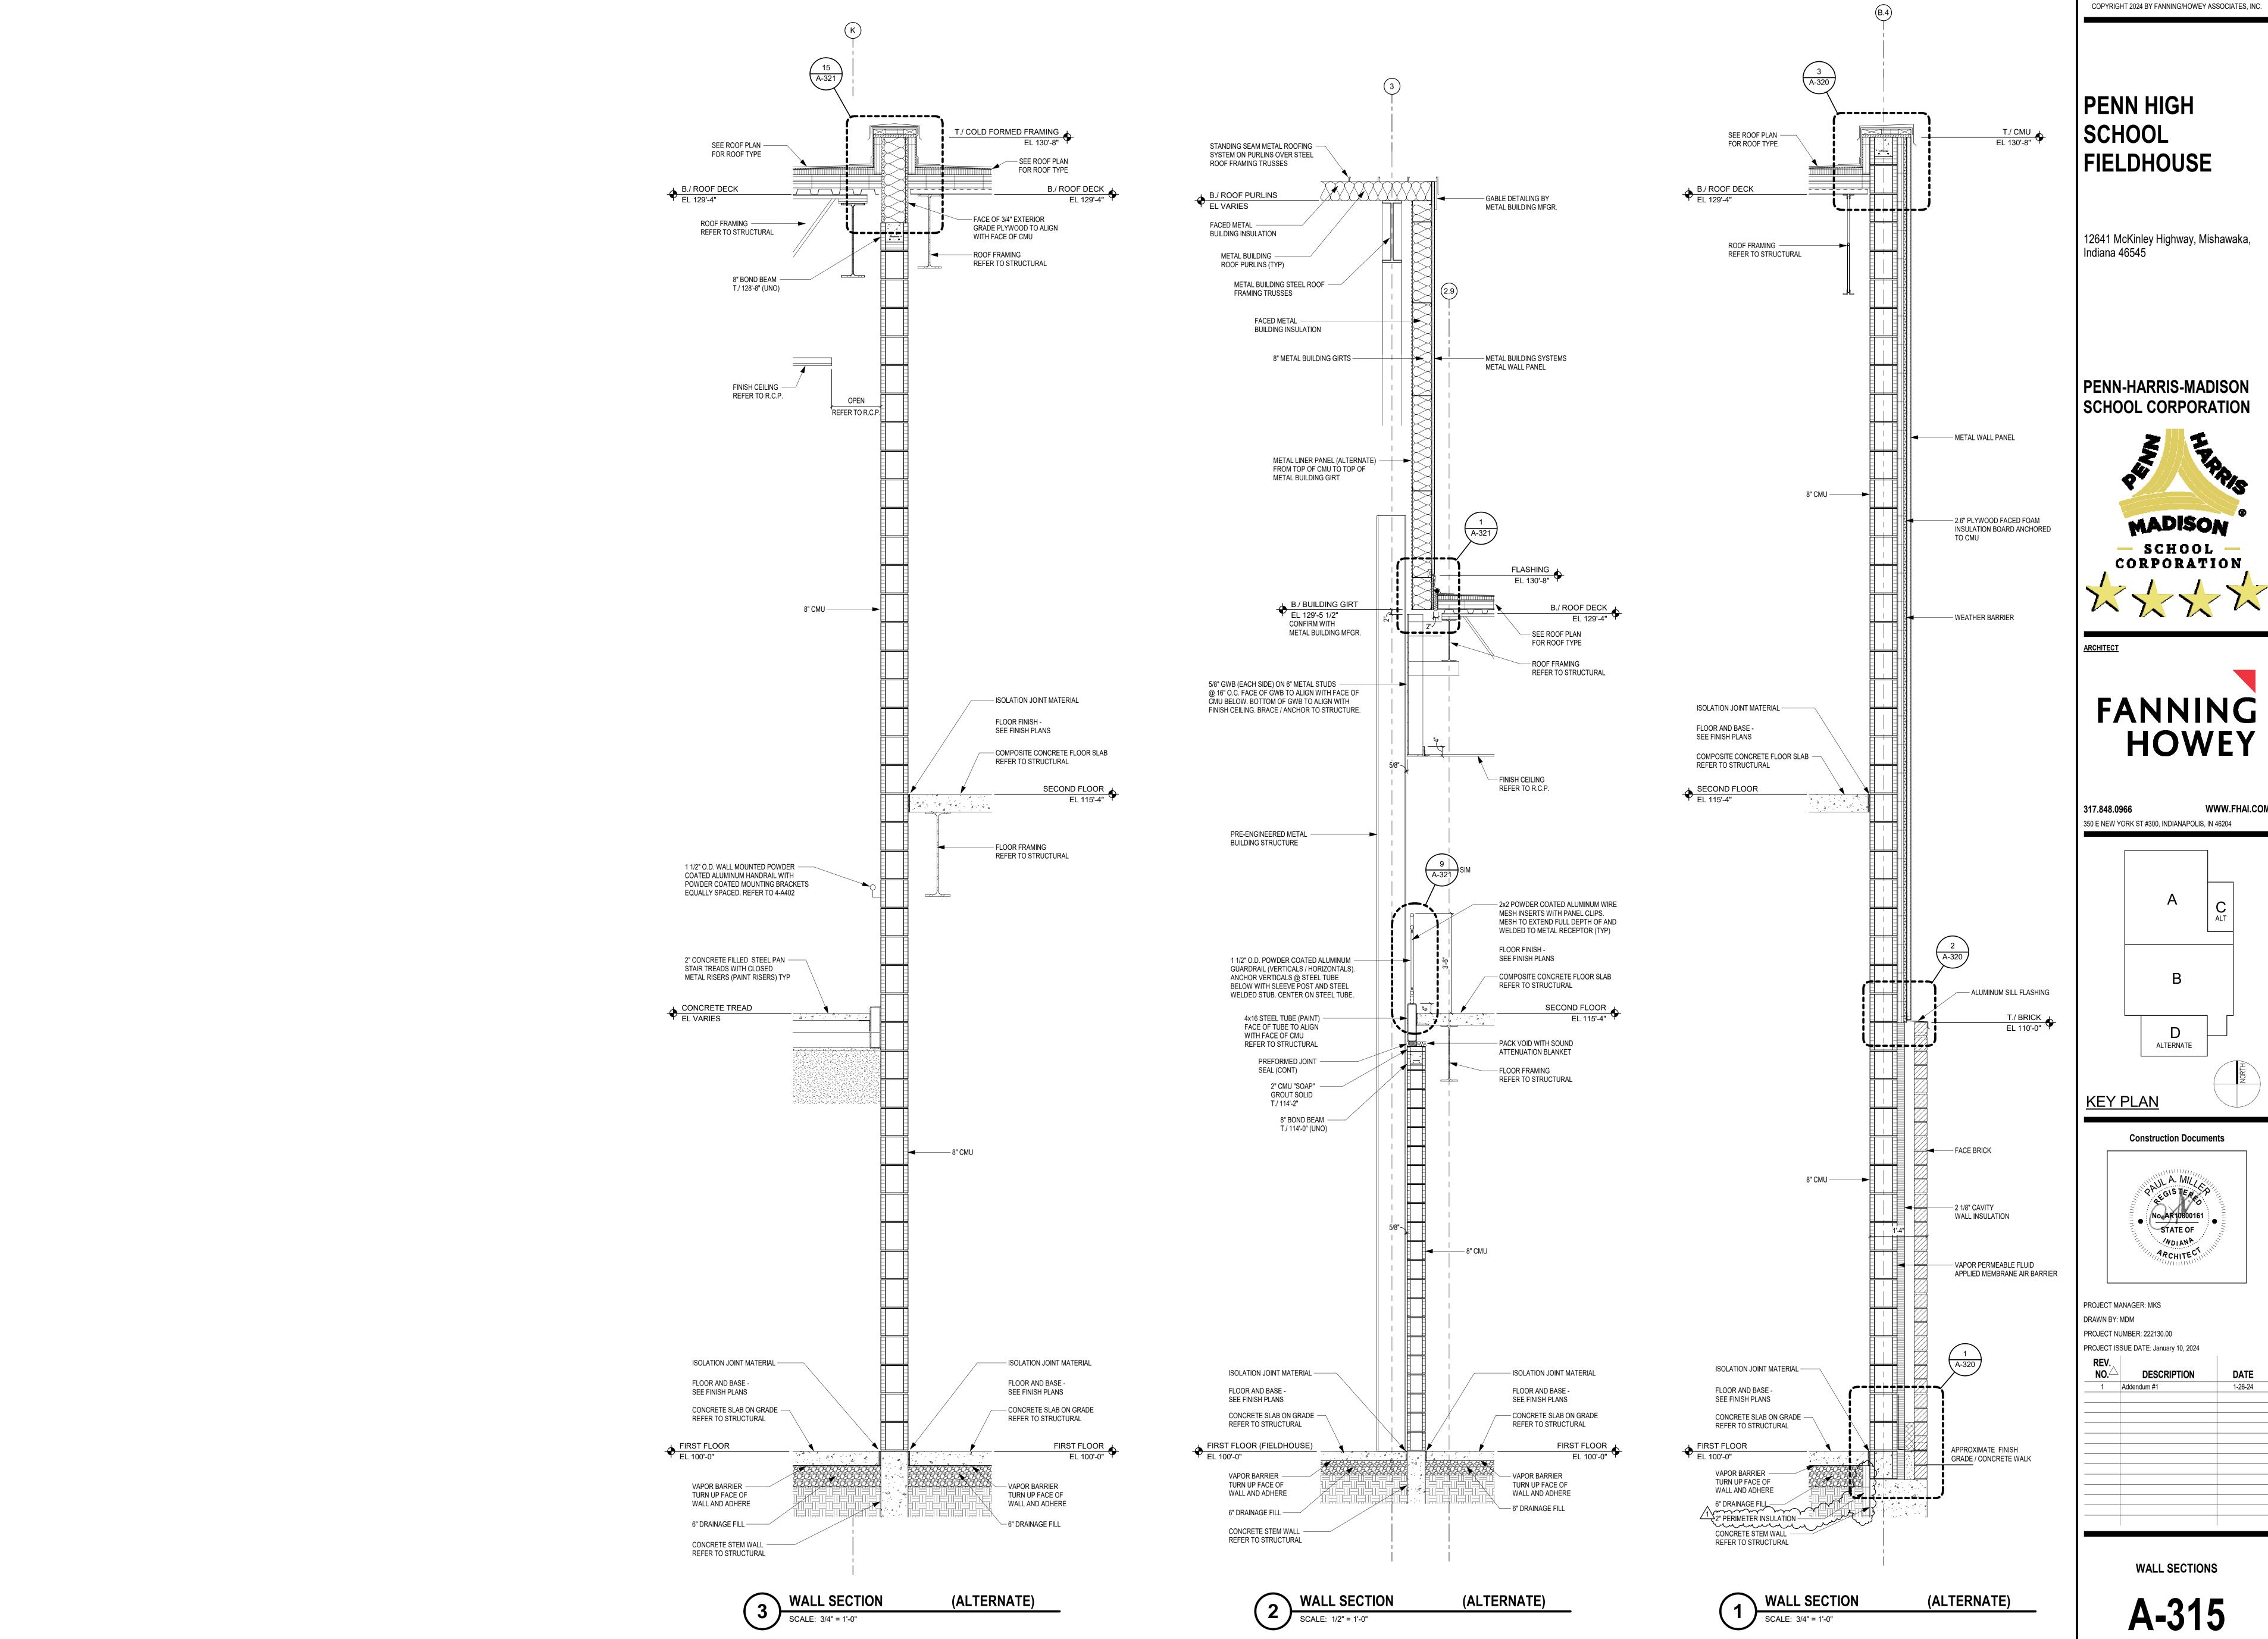
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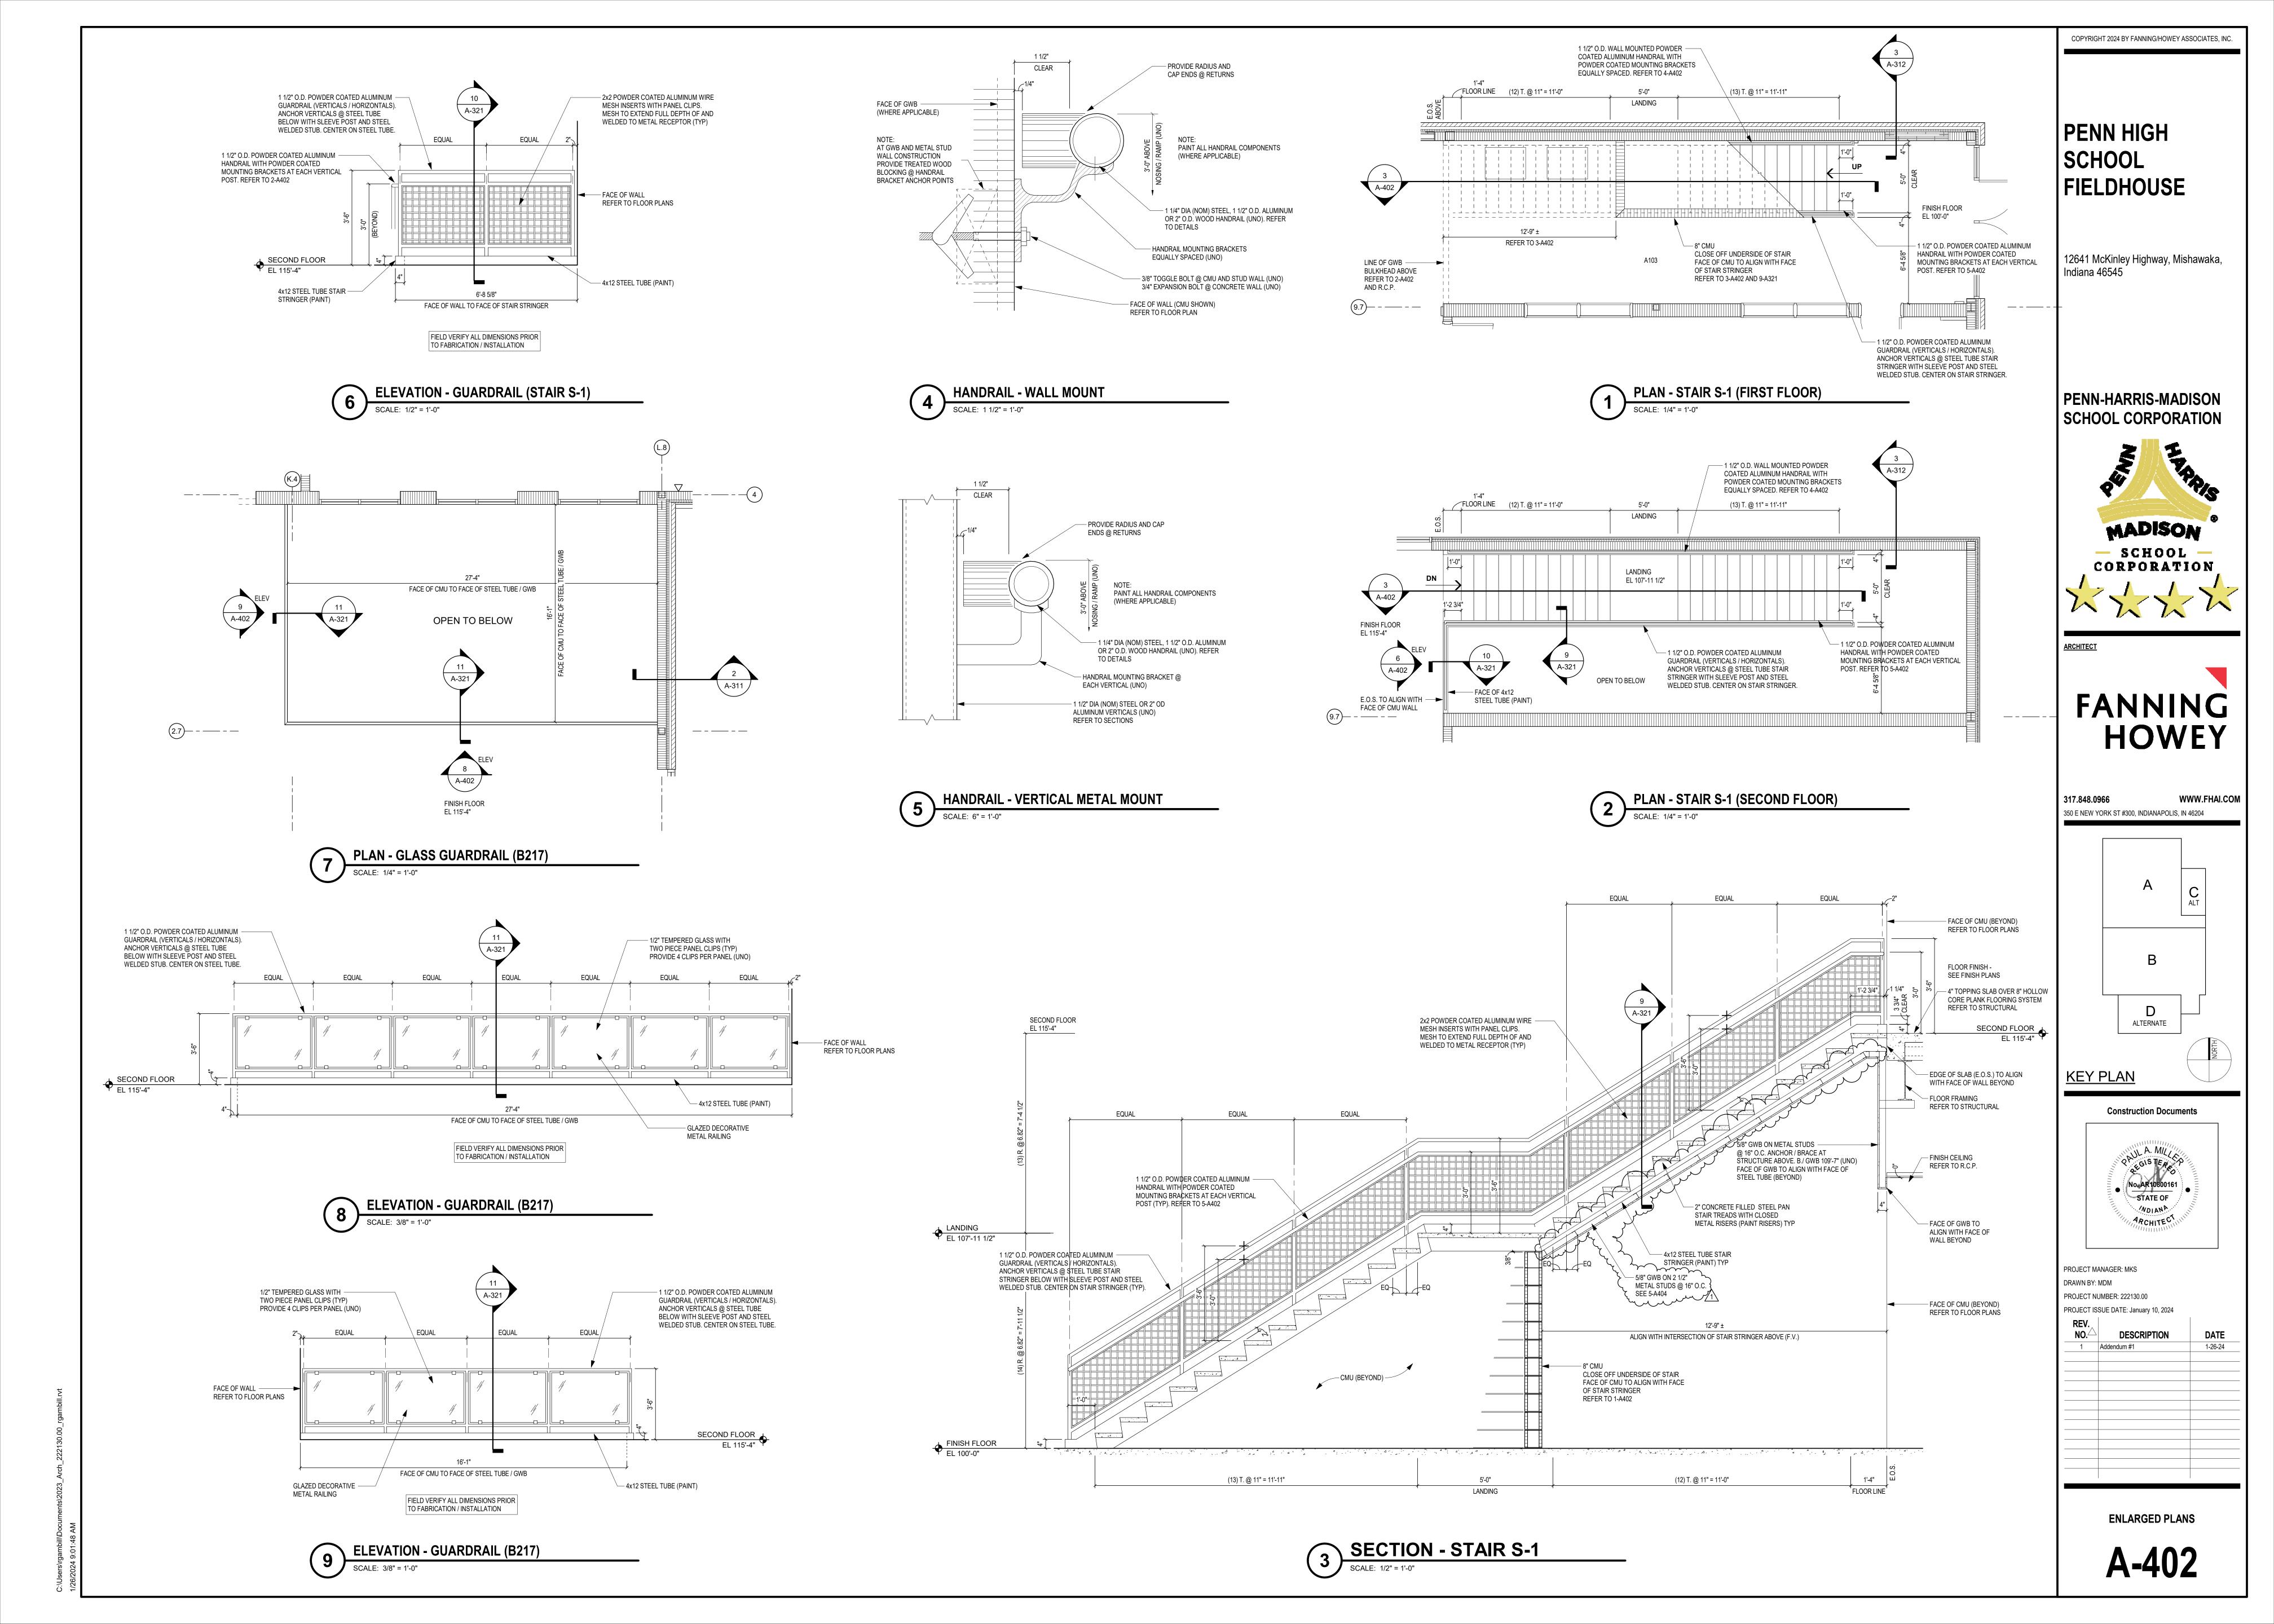
PROJECT ISSUE DATE: January 10, 2024			
REV. NO.	DESCRIPTION	DATE	
1	Addendum #1	1-26-24	





O. V. Jeoge Vrasmbill Door monte

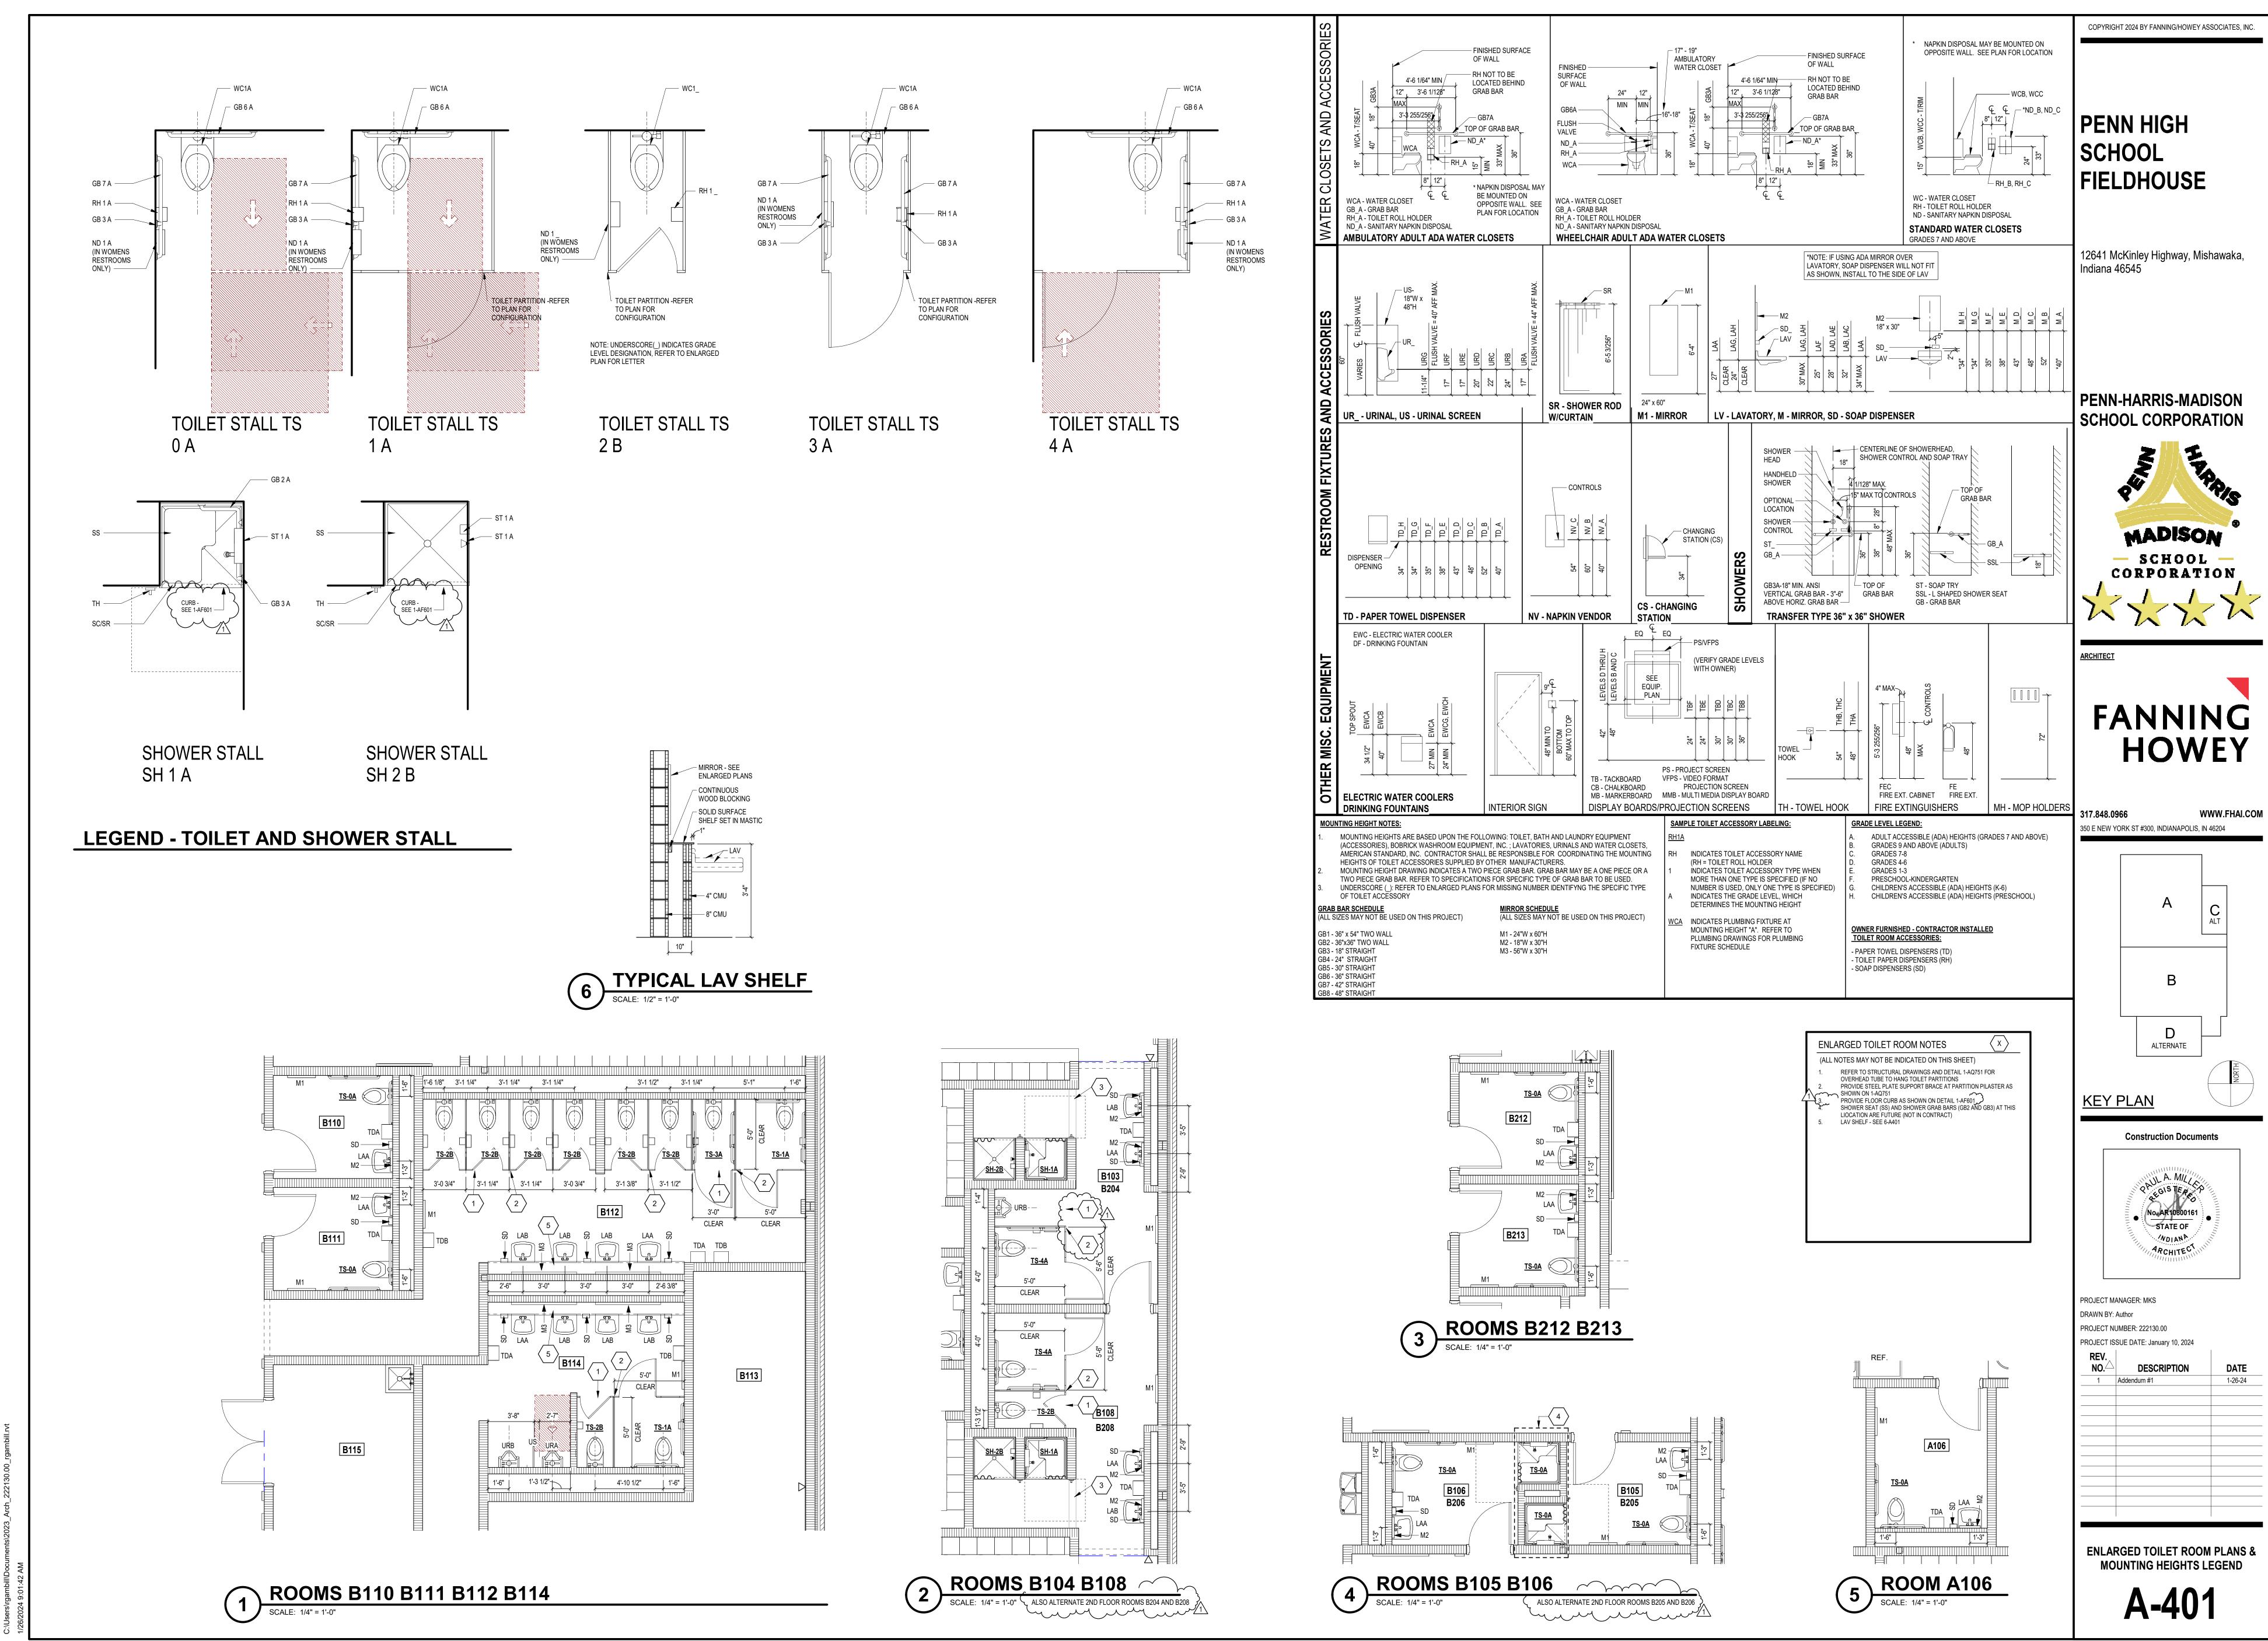


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COLUMN -

SEALANT —

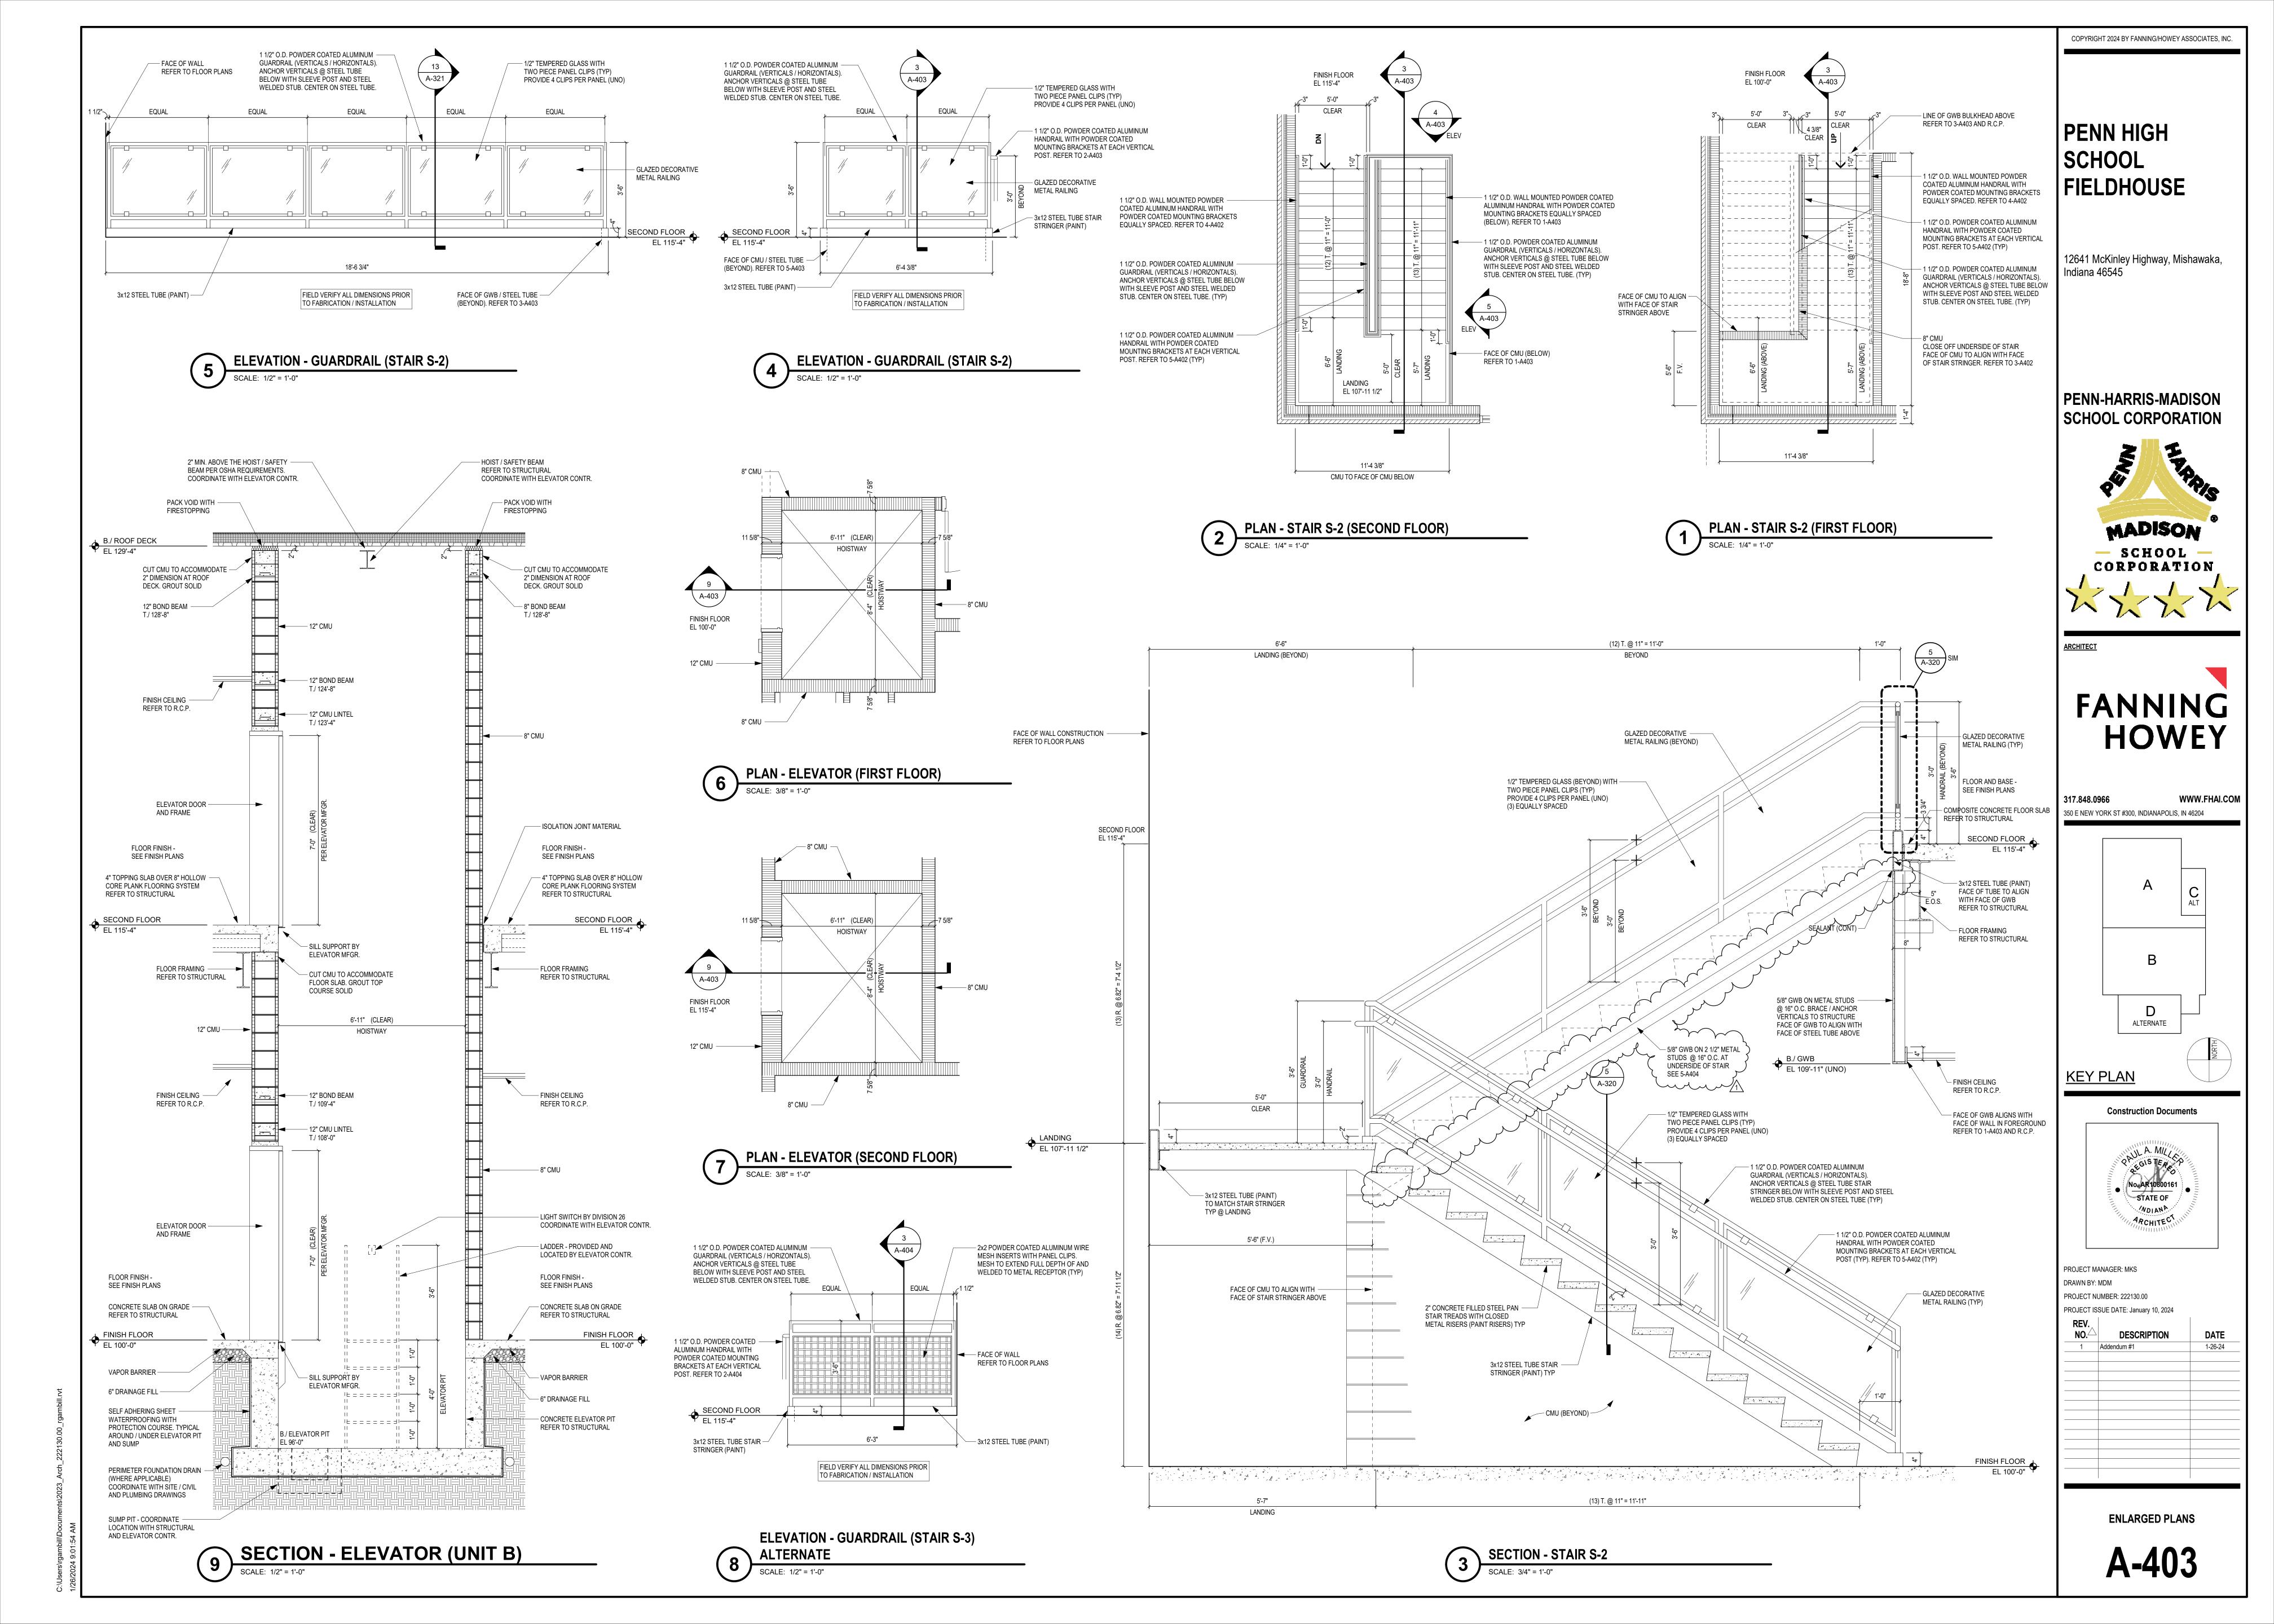FLOOR PLAN DETAILS
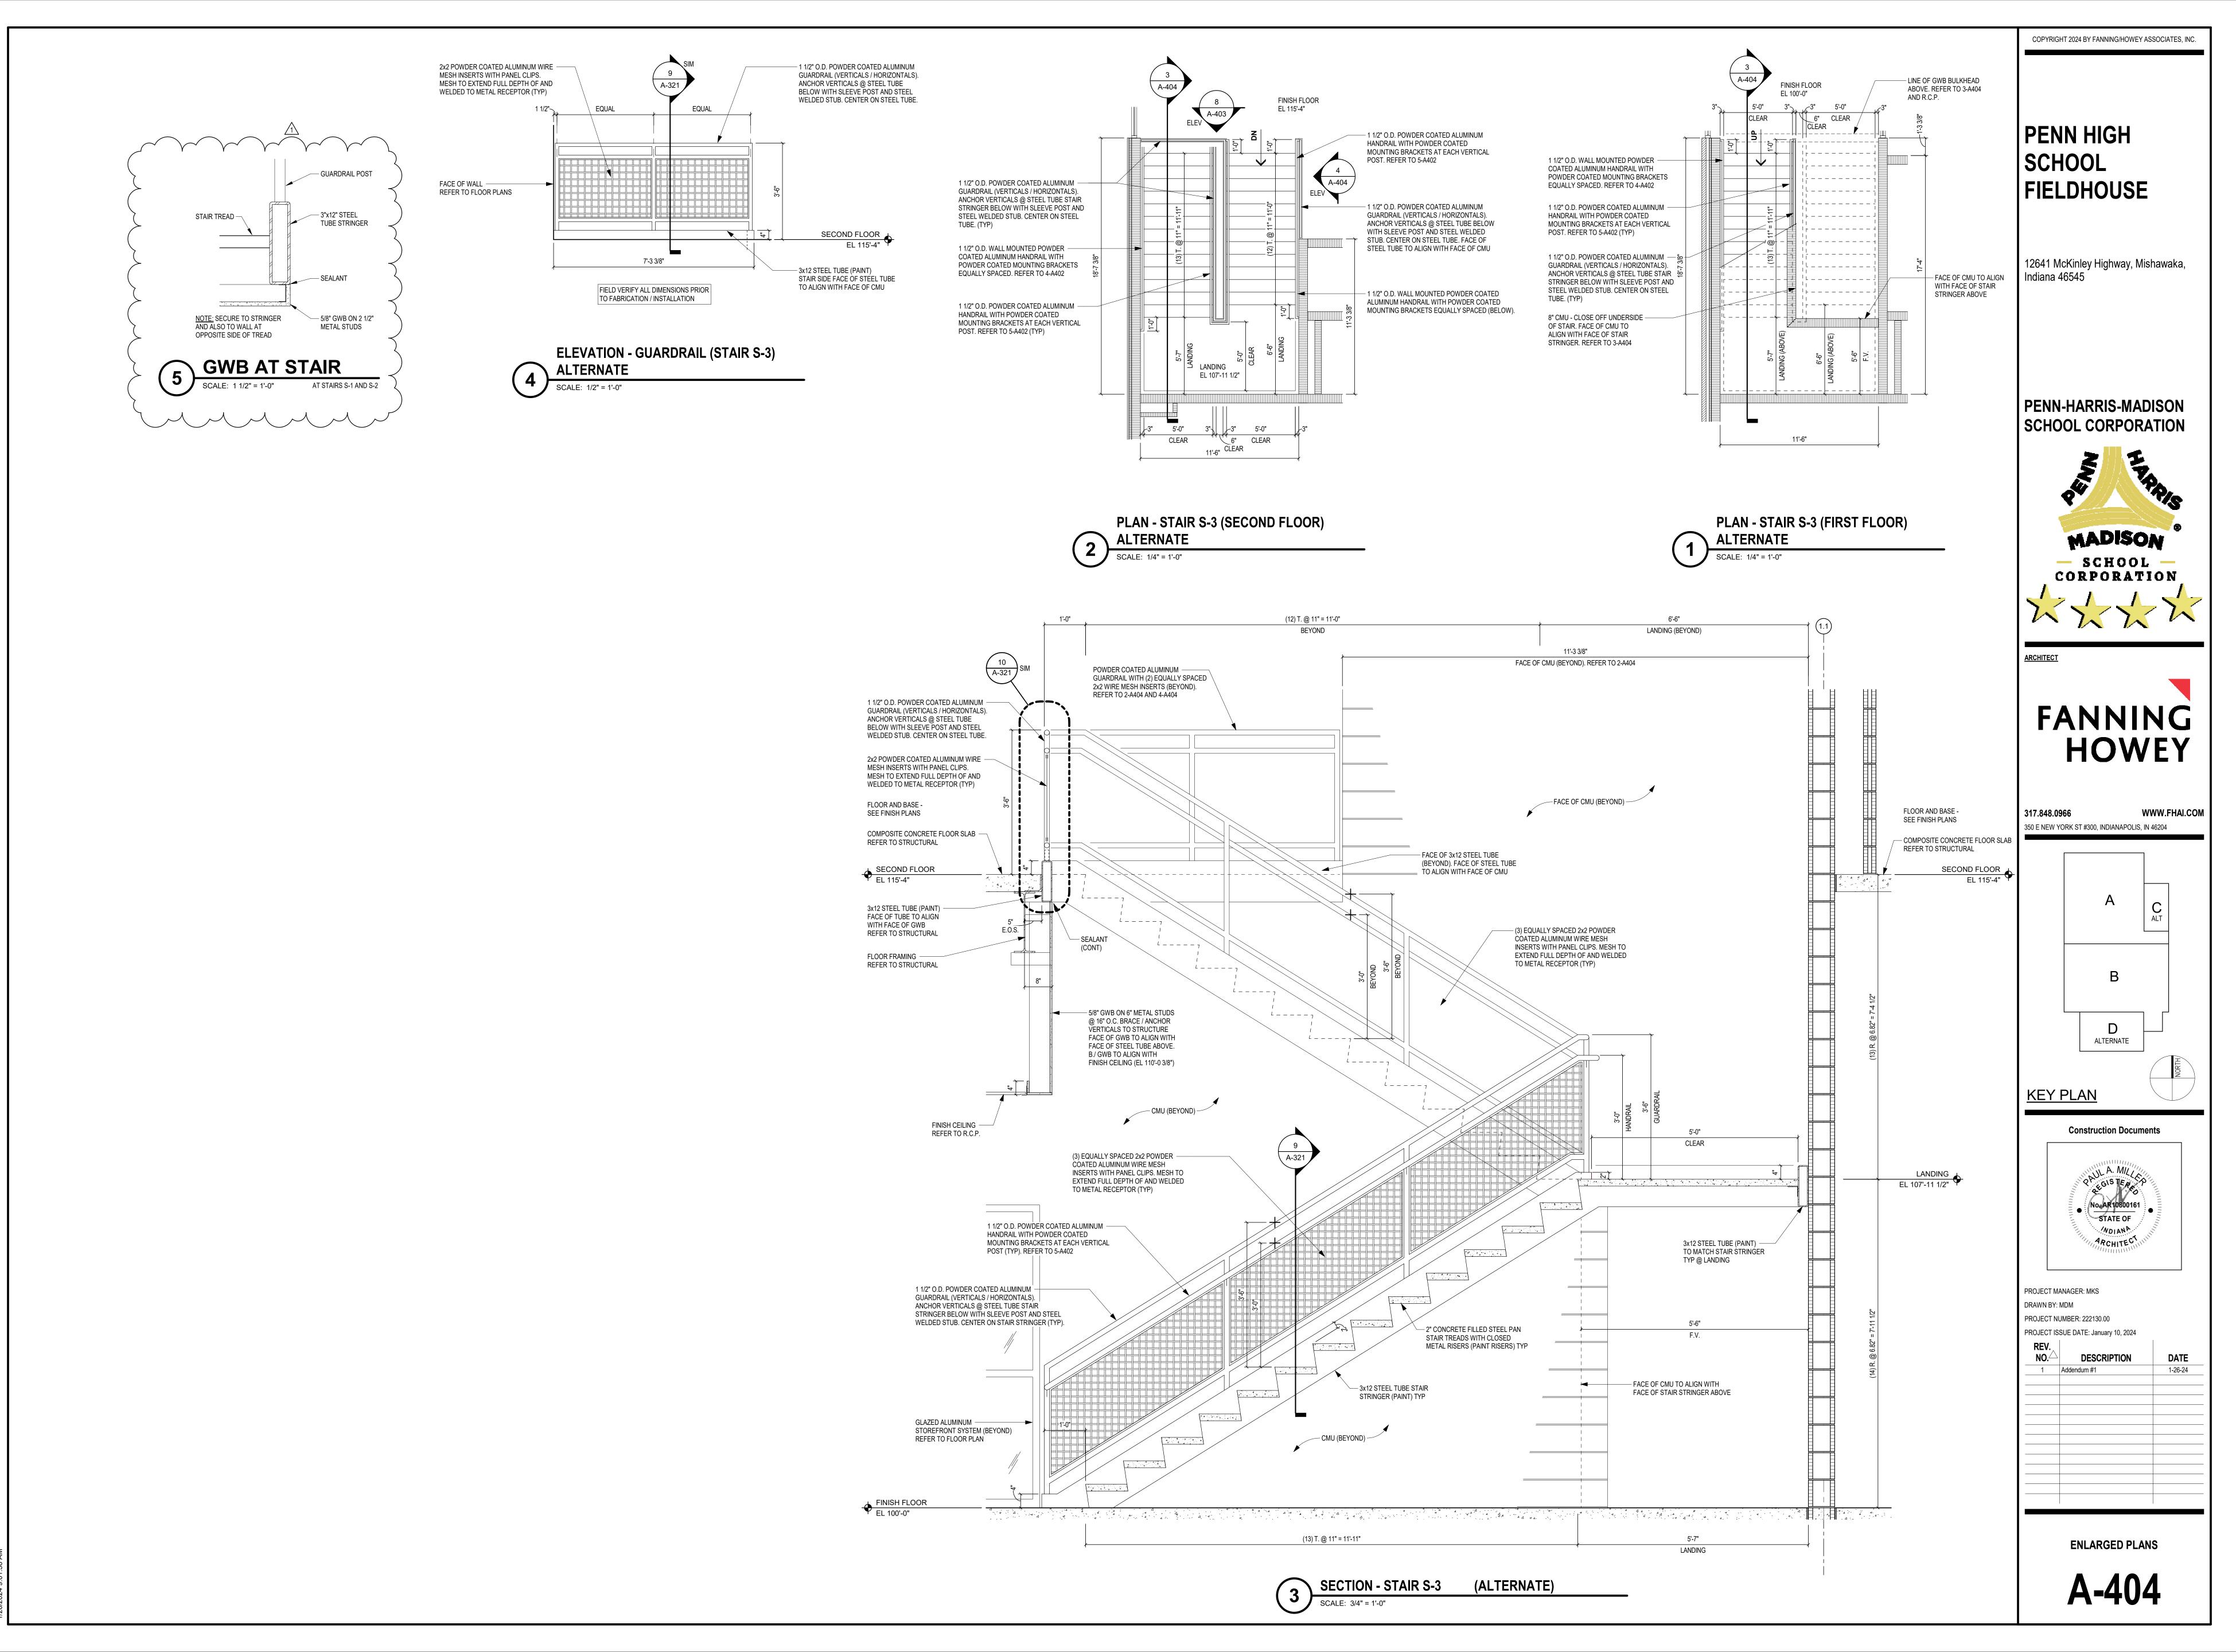
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MADISON

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350 E NEW YORK ST #300, INDIANAPOLIS, IN 46204

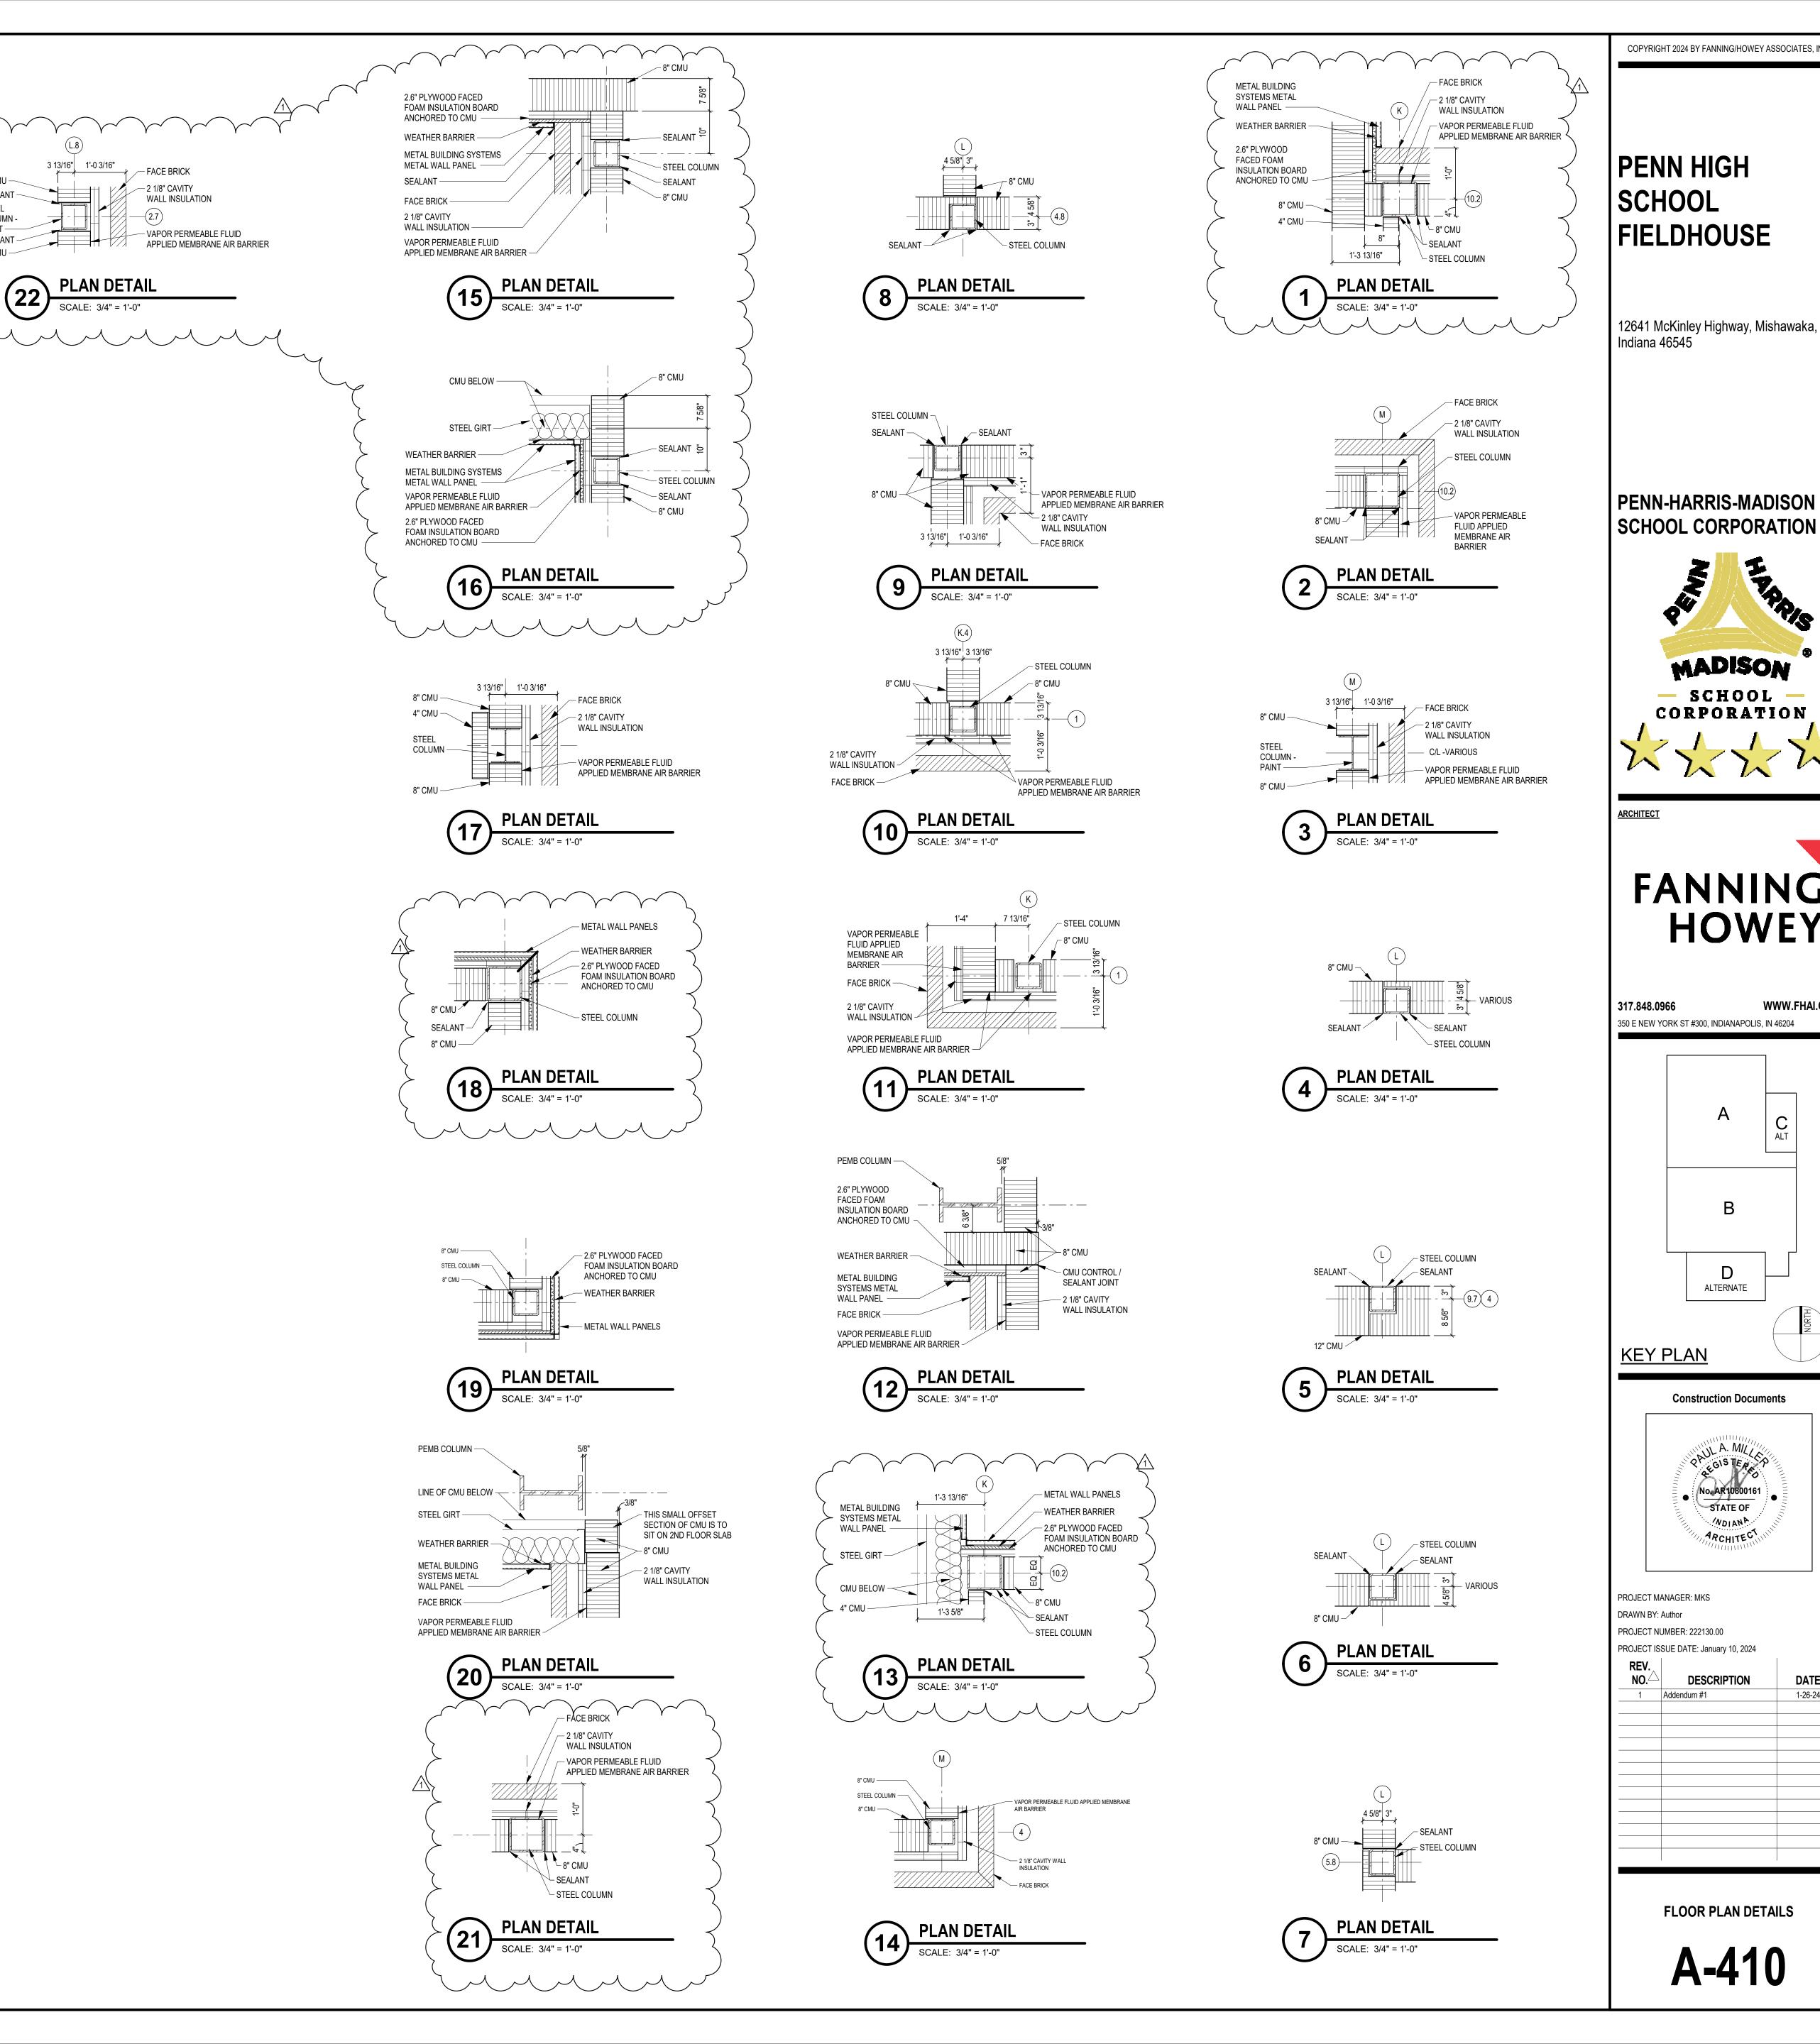ALTERNATE

Construction Documents

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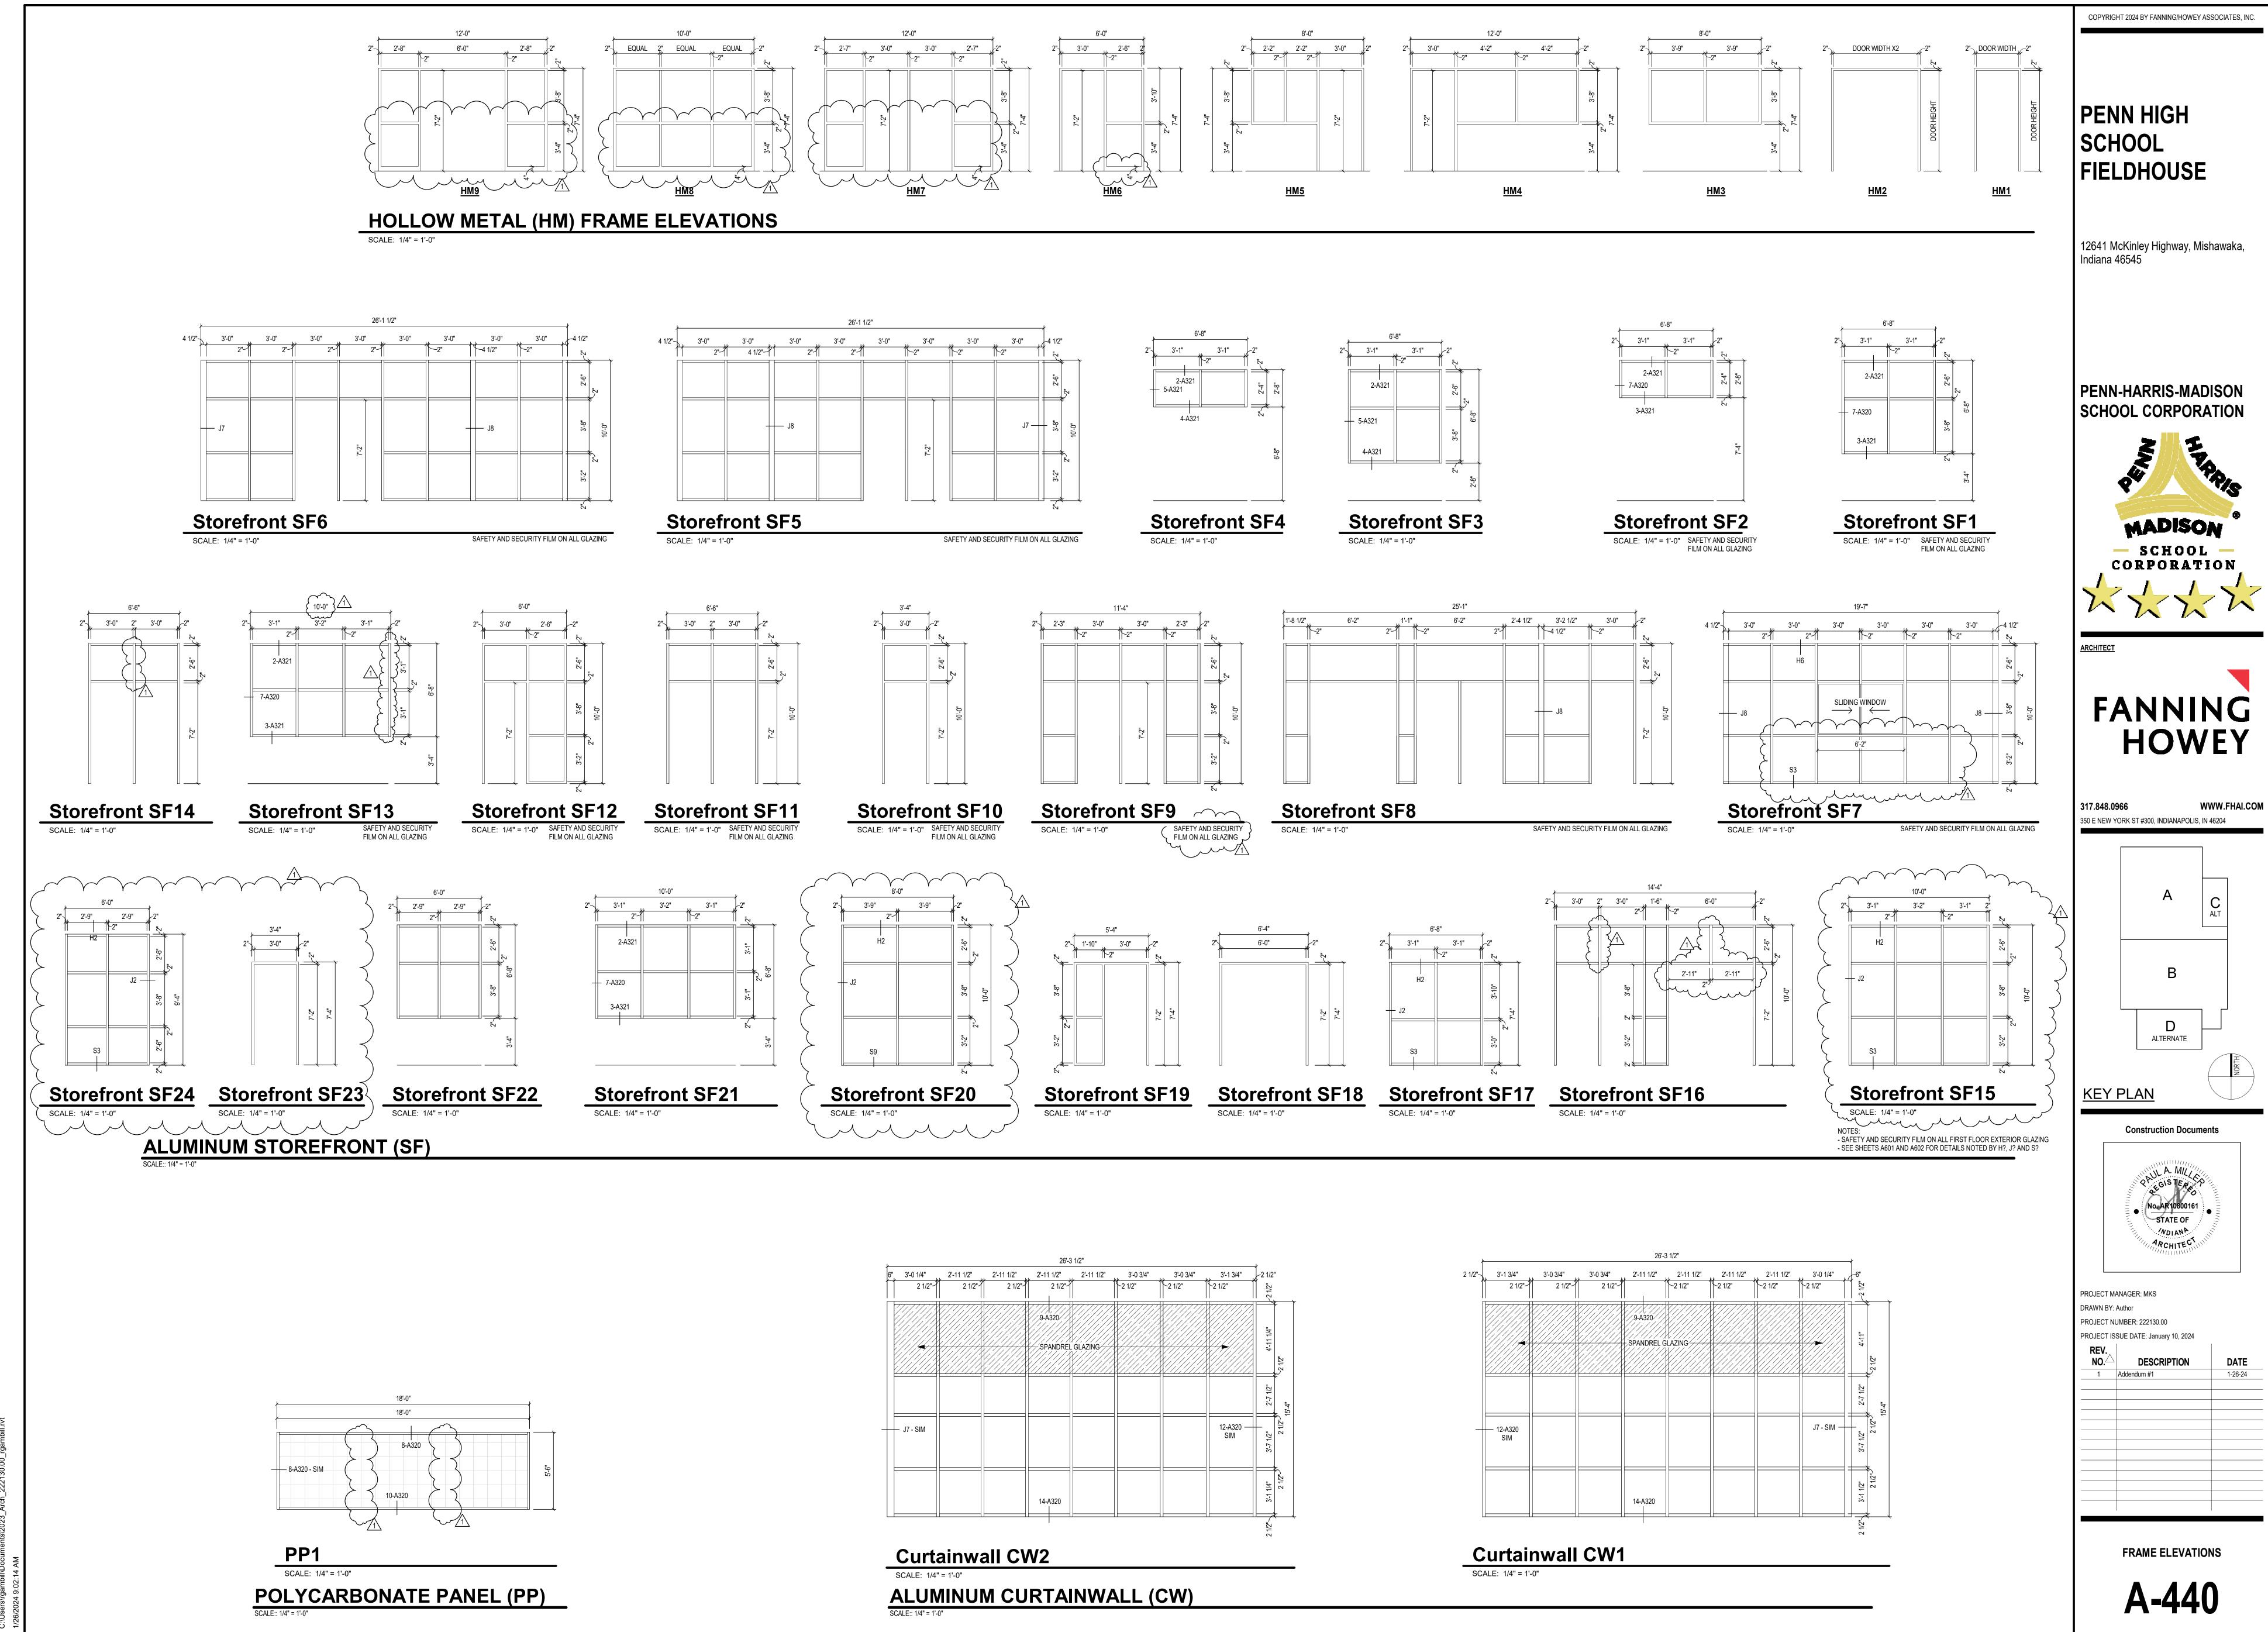
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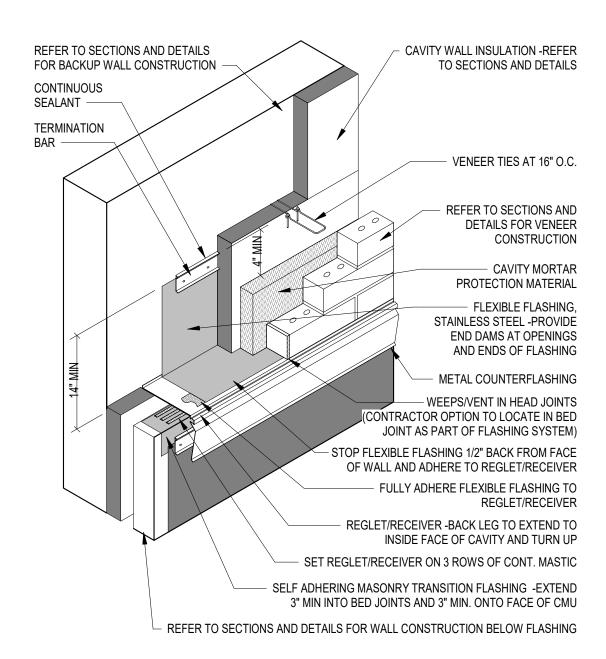
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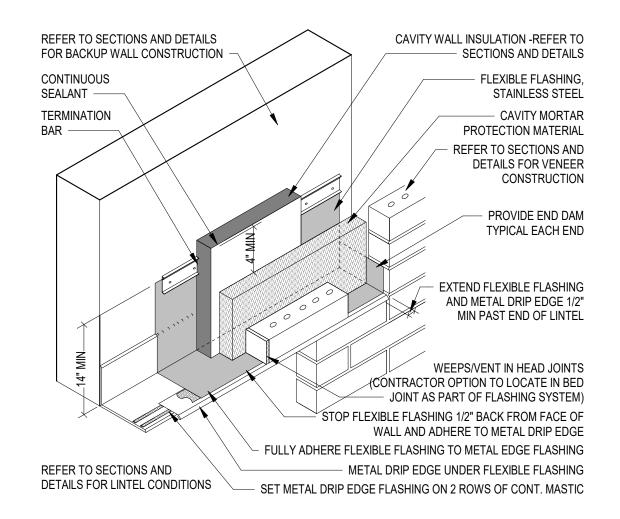
HOWEY

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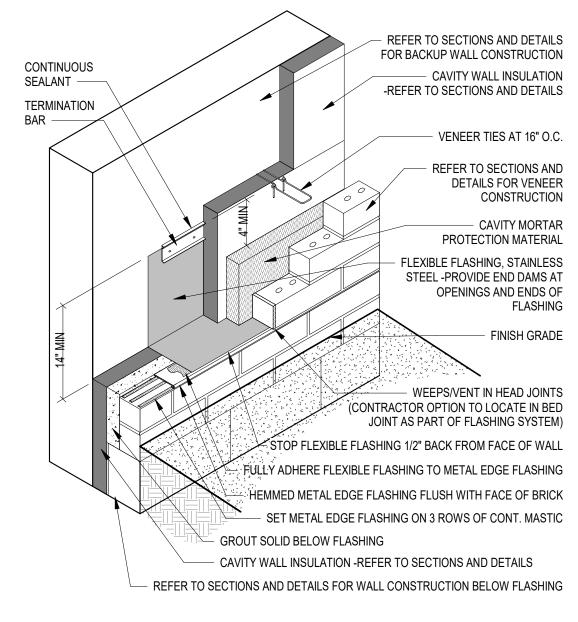




TYPICAL CAVITY WALL FLASHING AT ROOF TO WALL




TYPICAL CAVITY WALL FLASHING ABOVE OPENINGS




TYPICAL CAVITY WALL FLASHING AT BASE OF WALL




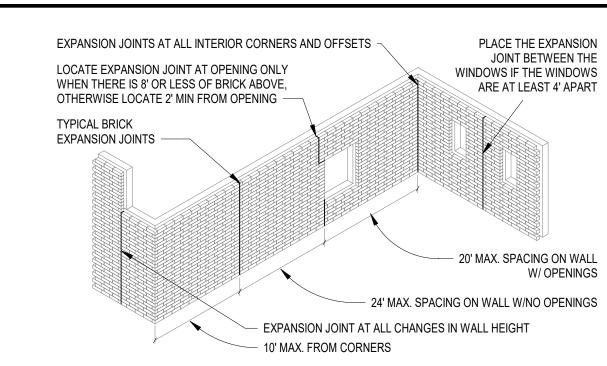

TYPICAL BRICK EXPANSION JOINT (EJ) LOCATIONS

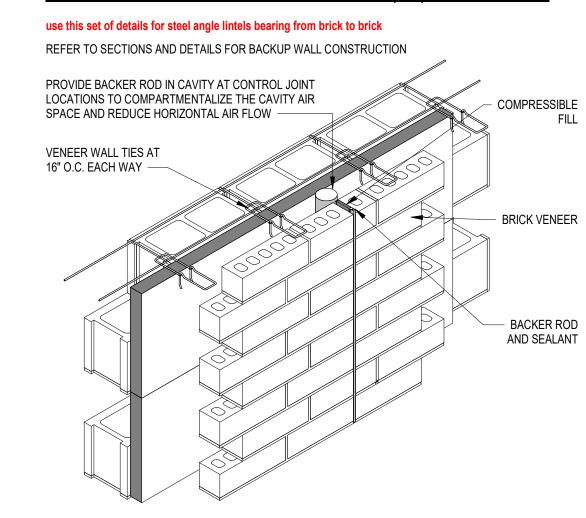


TYPICAL BRICK EXPANSION JOINT DETAIL

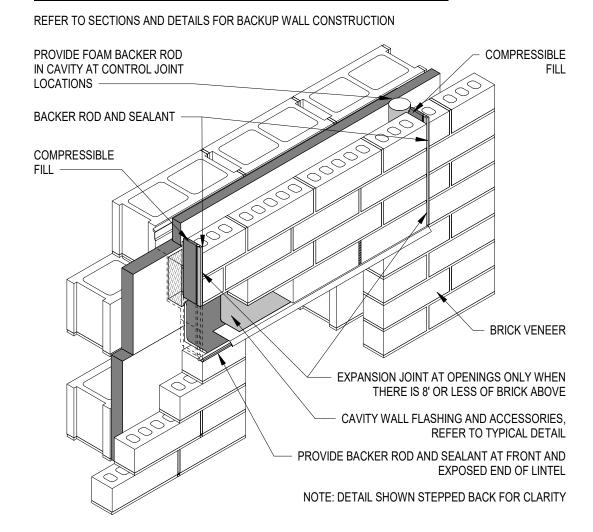

TYPICAL BRICK EXPANSION JOINT AT OPENINGS



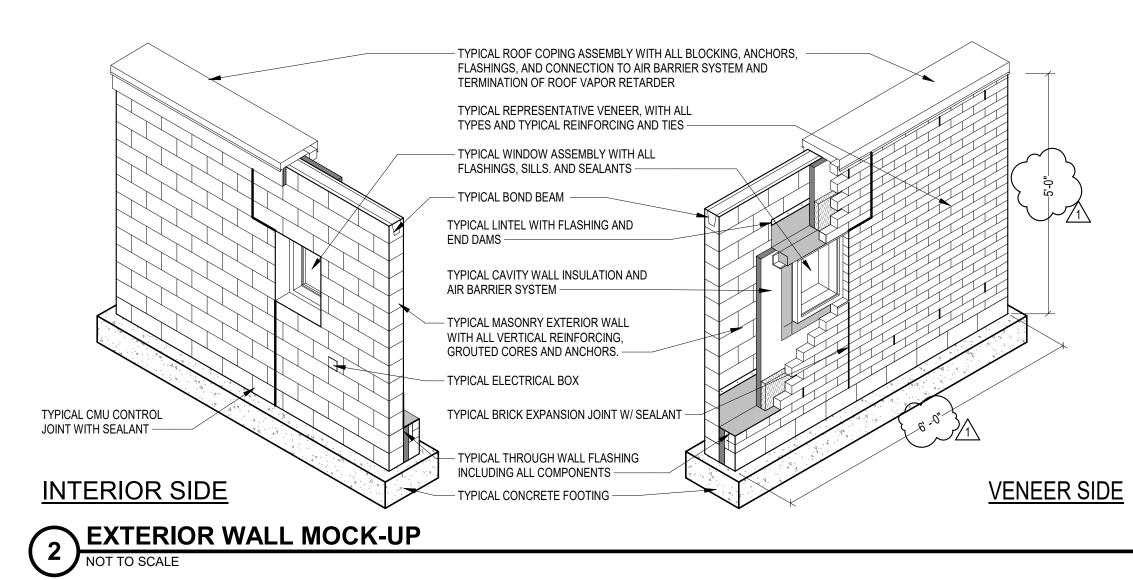

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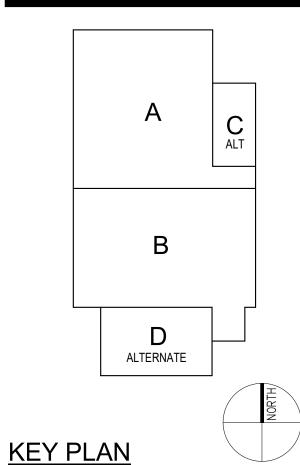
PENN-HARRIS-MADISON




APCHITECT

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Construction Documents



PROJECT MANAGER: MKS
DRAWN BY: Author
PROJECT NUMBER: 222130.00

PROJECT ISSUE DATE: January 10, 2024

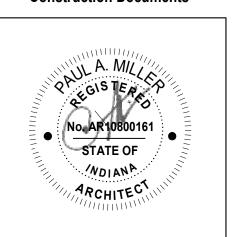
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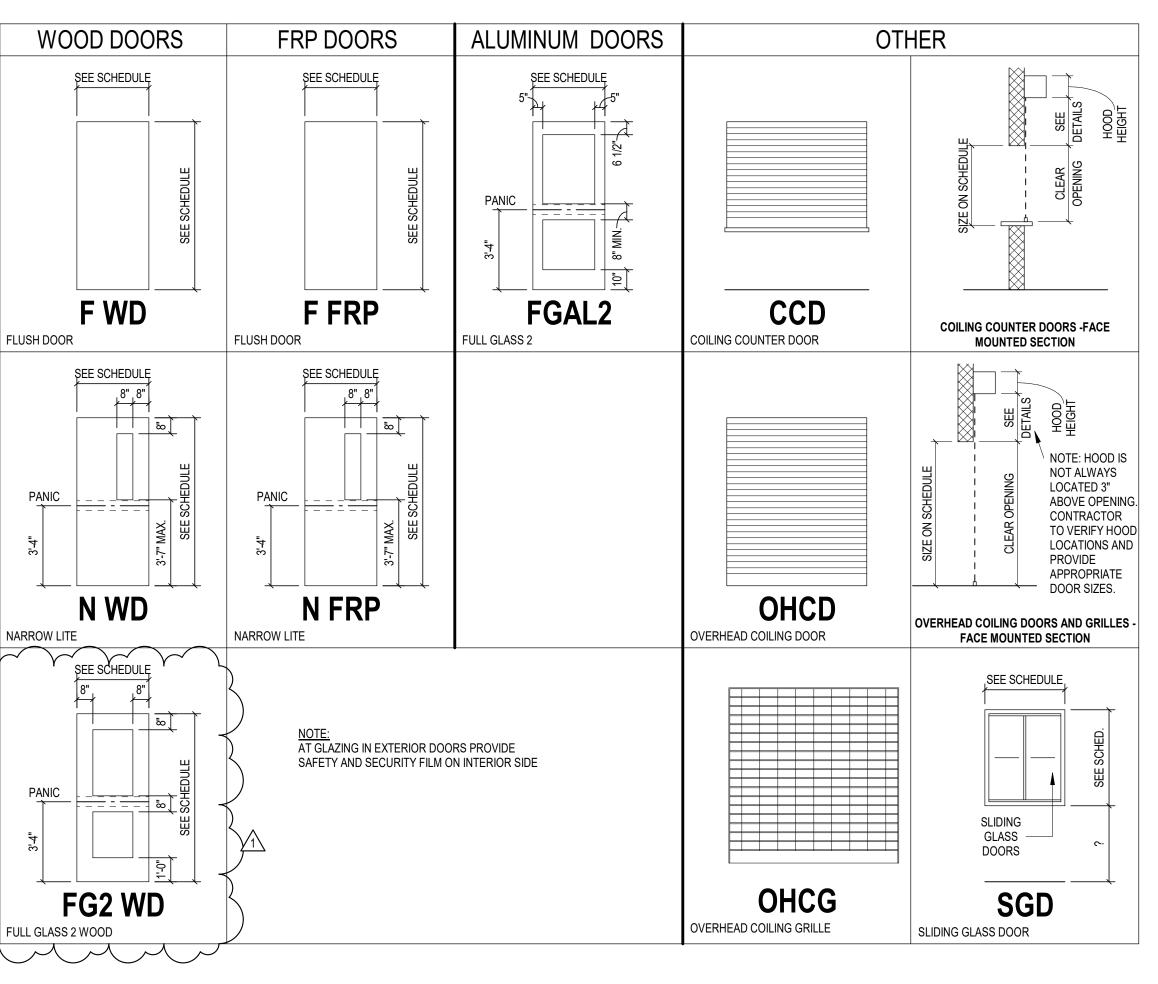
1 Addendum #1


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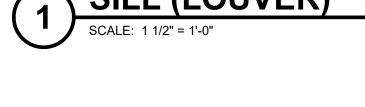
DETAILS

A-501






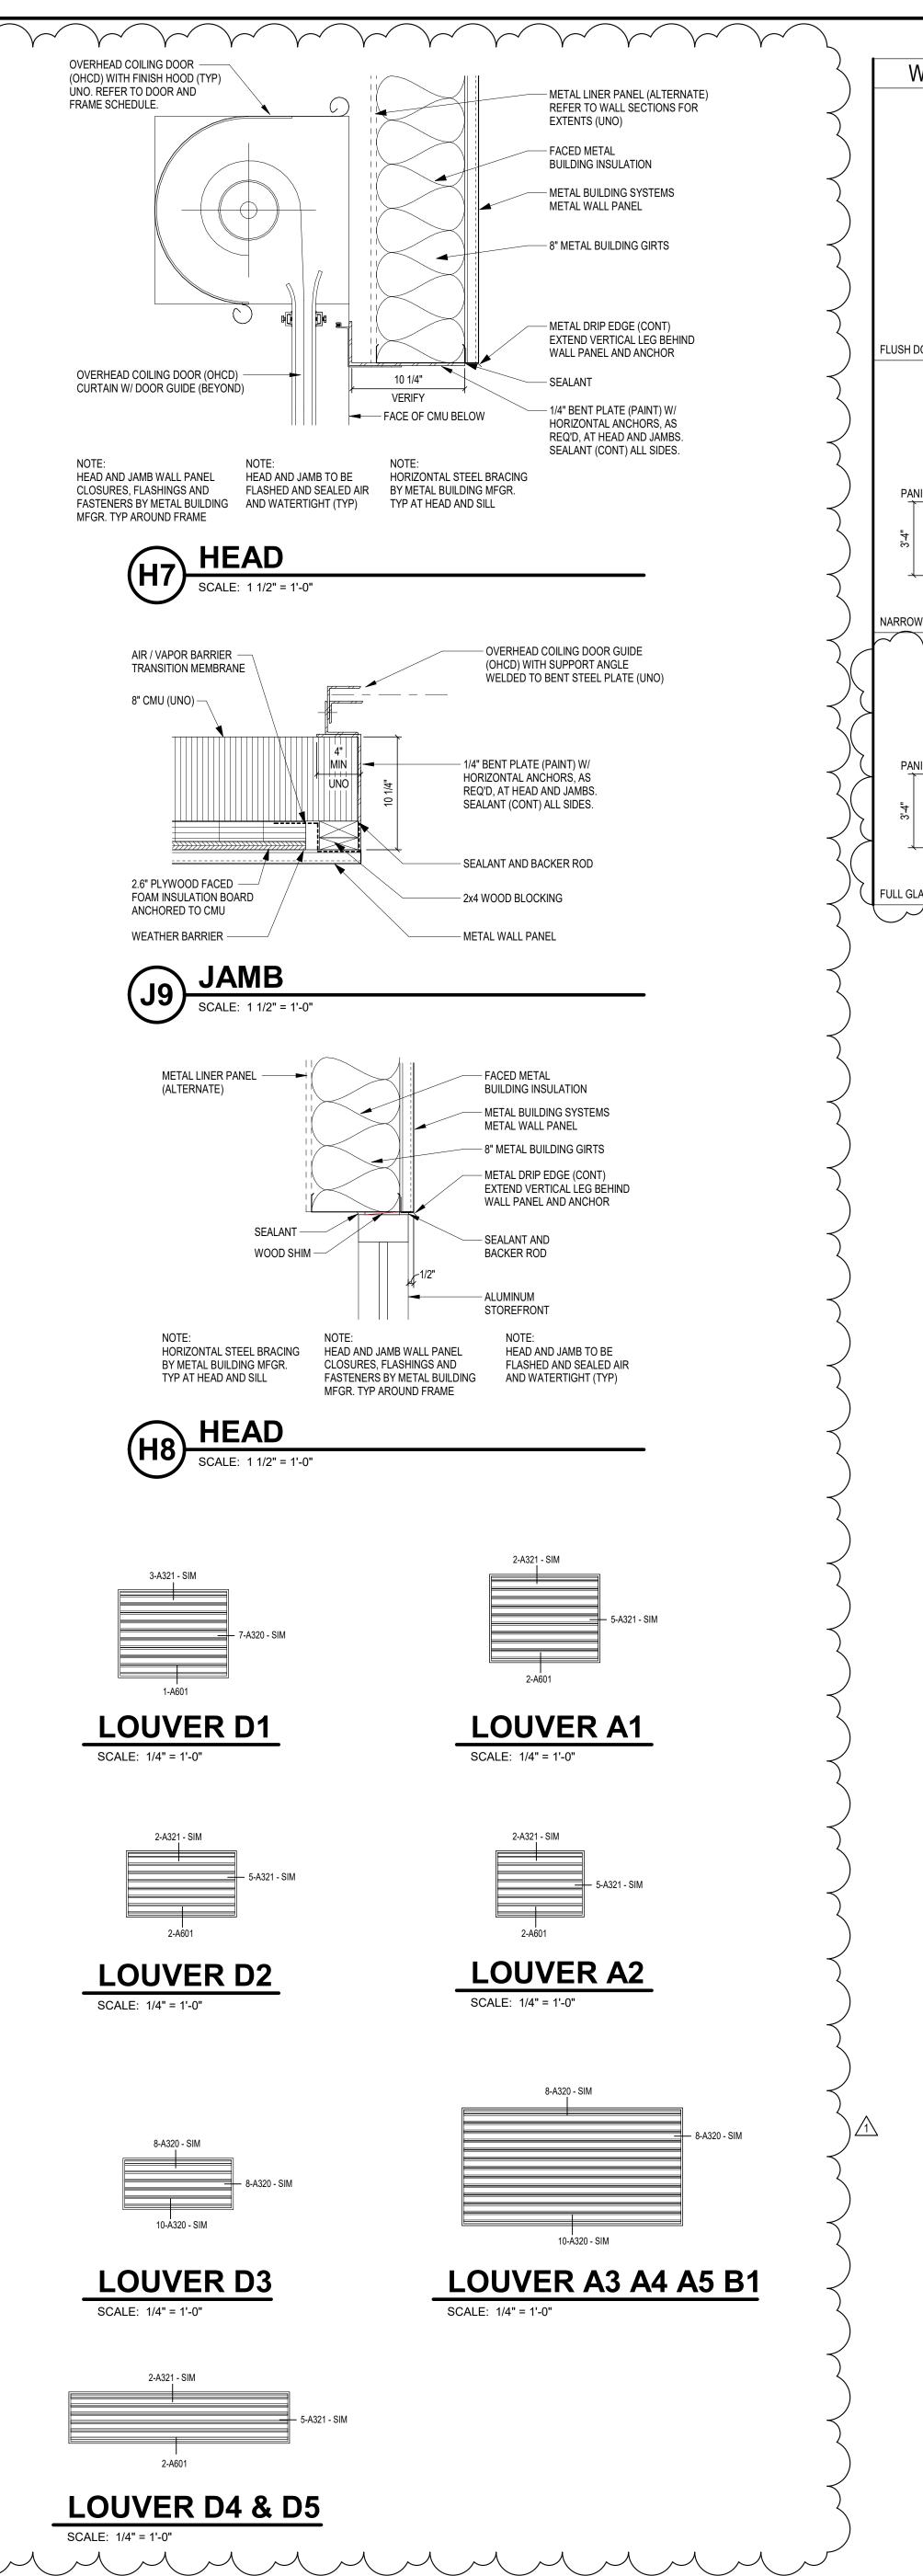

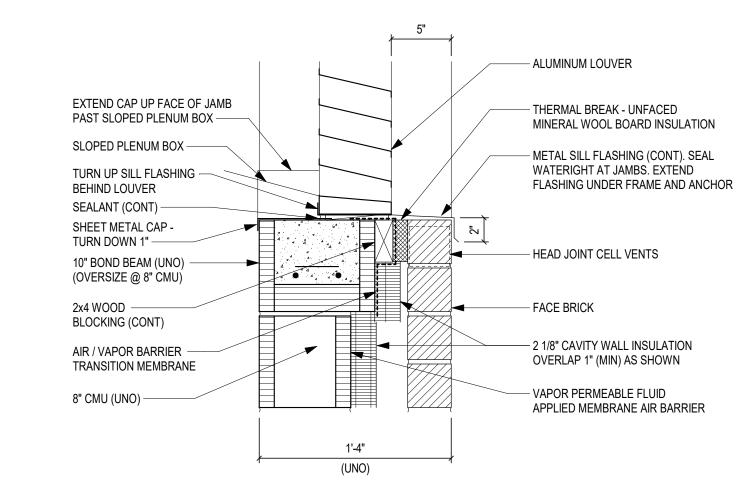

SILL (LOUVER)


SCALE: 1 1/2" = 1'-0"

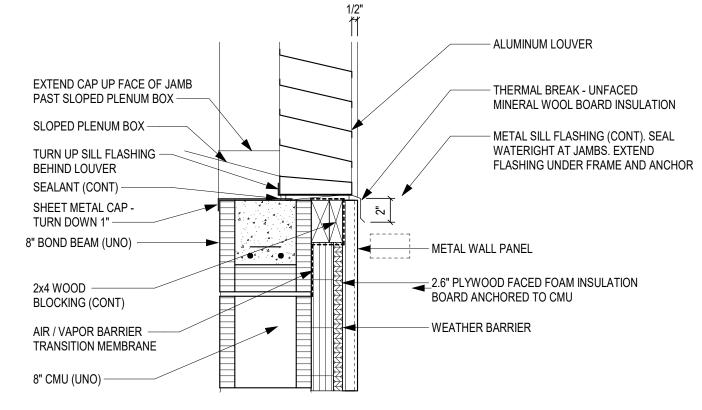



	DOORS	<u> </u>			FR	AME				HAR	DWARE	
DOOR	DOOR SIZE	DOOR	FRAME	FRAME	JAMB	ANIL	DETAILS		FIRE	SET	KEYSID	
MARK	(WxH)	TYPE	MATERIAL	1	DEPTH	HEAD	JAMB	SILL	RATING	NO.	E ROOM	REMARKS
A 1 O 1	40' 0" v 40' 0"	OHCD	1 071			1	<u> </u>	07.00		25	FVT	MOTORIZED / ELECTRONIC ACCESS
A101 A101A	10'-0" x 10'-0" 3'-0" x 7'-2"	F FRP	STL AL	- SF10	2" 4 1/2"	H7 H8	J9 5-A321 2	\$7,\$8 \$5,\$6		35 23	EXT EXT	MOTORIZED / ELECTRONIC ACCESS ELECTRONIC ACCESS
101A 101B	3'-0" x 7'-2"	N FRP	AL	SF11	4 1/2"	H8	5-A321 {	S5,S6		29	EXT	ELECTRONIC ACCESS
101B 101C	3'-0" x 7'-2"	N FRP	AL	SF11	4 1/2"	H8	5-A321 }	S5,S6		30	EXT	
\101D	3'-0" x 7'-2"	N FRP	AL	SF11	4 1/2"	H8	5-A321 }	S5,S6		29	EXT	
101E	3'-0" x 7'-2"	N FRP	AL	SF11	4 1/2"	H8	5-A321 5	S5,S6		30	EXT	
101F	3'-0" x 7'-2"	N FRP	AL	SF11	4 1/2"	H8	5-A321 \(\)	S5,S6	-	29	EXT	
\101G	3'-0" x 7'-2"	N FRP	AL	SF11	4 1/2"	H8	5-A321 \	S5,S6		30	EXT	
4101H	3'-0" x 7'-2"	F FRP	AL	SF10	4 1/2"	→ H8	5-A321 {	S5,S6		30	EXT	
4101J	3'-0" x 7'-2"	F FRP	AL	SF10	4 1/2"	→ H8	5-A321 \	S5,S6		30	EXT	
4101K	3'-0" x 7'-2"	N FRP	AL	SF11	4 1/2"	\ H8	5-A321	S5,S6		29	EXT	
A101L	3'-0" x 7'-2"	N FRP	AL	SF11	4 1/2"	E H8	5-A321 }	S5,S6		23	EXT	ELECTRONIC ACCESS
A102	3'-0" x 7'-2"	FGAL2	AL	SF14	4 1/2"	H2		-		22	A102	ELECTRONIC ACCESS
A102A	3'-0" x 7'-2"	FGAL2	AL	SF14	4 1/2"	~ H2 ~~	~~ J2 ~	-		26	A102	
A103	3'-0" x 7'-2"	FGAL2	AL	SF9	4 1/2"	2/A-321	7-A320 2	1 S5,S6		23	EXT	ELECTRONIC ACCESS
A103A	3'-0" x 7'-2"	FGAL2	AL	SF9	4 1/2"	ξ 2/A-321	7-A320	S5,S6		29	EXT	
A104	3'-0" x 7'-2"	F WD	НМ	HM1	1'-0 3/4"	L HI WW	1	-		10	A103	ELECTRONIC ACCESS
A104A			НМ	HM3	1'-0 3/4"	H1	J1	S1		33	A103	
A104B			НМ	HM3	1'-0 3/4"	H1	J1	S1		33	A103	
\104C	3'-0" x 7'-2"	F WD	HM	HM5	8 3/4"	H1	J1	S1		02	A102	
A105	3'-0" x 7'-2"	F WD	HM	HM1	8 3/4"	H1	J1	-		13	A104	
A106	3'-0" x 7'-2"	F WD	HM	HM1	8 3/4"	H1	J1	-		05	A104	
A107	3'-8" x 7'-2"	F WD	HM	HM1	8 3/4"	H1	J1	-		14	A102	
A202	PR 3'-0" x 7'-2"	F WD	НМ	HM2	8 3/4"	H1	J1	-		19	A201	
B101	£ 10'-0" x 10'-0" },	OHCG	AL	-	2"	H3	J3			35	B101	MOTORIZED
3101A	کر 10'-0" x 10'-0" ک	OHCG	AL	-	2"	H3	J3			35	B101	MOTORIZED
B102	3'-0" x 7'-2"	F WD	НМ	HM1	8 3/4"	H1	J1	-		11	B101	ELECTRONIC ACCESS
B103	3'-0" x 7'-2"	F WD	НМ	HM1	8 3/4"	H1	J1	-		03	B108	KEYSIDE BOTH SIDES
B104	3'-0" x 7'-2"	F WD	НМ	HM1	8 3/4"	H1	J1	-		11	B101	ELECTRONIC ACCESS
B105	3'-0" x 7'-2"	F WD	НМ	HM1	8 3/4"	H1	J1	-		04	B104	
B106	3'-0" x 7'-2"	F WD	НМ	HM1	8 3/4"	H1	J1	-		04	B107	
B107	3'-0" x 7'-2"	F WD	НМ	HM1	8 3/4"	H1	J1	-		11	B101	ELECTRONIC ACCESS
B109	3'-0" x 7'-2"	F WD	НМ	HM1	8 3/4"	H1	J1	-		11	B101	ELECTRONIC ACCESS
B110	3'-0" x 7'-2"	F WD	HM	HM1	8 3/4"	H1	J1	_		05	B101	
B111	3'-0" x 7'-2"	F WD	HM	HM1	8 3/4"	H1	J1	_		05	B101	
B113	3'-0" x 7'-2"	F WD	НМ	HM1	8 3/4"	H1	J1	-		14	B114	
B115	PR 3'-0" x 7'-2"	F WD	НМ	HM2	8 3/4"	H1	J1	-		18	B101	
B116	3'-0" x 7'-2"	F WD	НМ	HM1	8 3/4"	H1	J1	-		14	B114	
B117	3'-0" x 7'-2"	F WD	НМ	HM5	8 3/4"	H1	J1	S1		07	B101	
B117A	6'-0" x 4'-8"	CCD	∧ STL	-	2"	H3	J3	S4		34	B117	MANUAL
B117B	ہے 6'-0" x 4'-8"	~~ CCD ~	STL	-	2"	H3	J3	S4		34	B117	MANUAL
B118	3'-0" x 7'-2"	FG2 WD	3 HM	HM6	1'-0 3/4"	H1	J1	S2		06	B119	
B119	PR 3'-0" x 7'-2"	~ FGAL2 ∽	AL	SF16	4 1/2"	H2	J2	S3		31	B119	
B119A	3'-0" x 7'-2"	FGAL2	AL	SF16	4 1/2"	H2	J2	S3		26	B119	
B119B	3'-0" x 7'-2"	FGAL2	AL	SF16	4 1/2"	H2	J2	S3		22		ELECTRONIC ACCESS ~~~,
B120	3'-0" x 7'-2"	FGAL2	AL	SF5	4 1/2"	11-A320	J4,J7	S5,S6		24	EXT	ELECTRONIC ACCESS, BUZZ-THRU & S
3120A	3'-0" x 7'-2"	FGAL2	AL	SF5	4 1/2"	11-A320	J4,J7	S5,S6		29	EXT	
3120B	3'-0" x 7'-2"	FGAL2	AL	SF6	4 1/2"	11-A320	J4,J7	S5,S6		29	EXT	
3120C	3'-0" x 7'-2"	FGAL2	AL	SF6	4 1/2"	11-A320	رم J4,J7 مر	S5,S6		29	EXT	
3120D	PR 3'-1" x 7'-2"	FGAL2	AL	SF8	4 1/2"	H6	رِدُ J2 SIM,J8 خ	S3		31	B120	
3120E 3120F	3'-0" x 7'-2" 3'-0" x 7'-2"	FGAL2 FGAL2	AL AL	SF8 SF8	4 1/2" 4 1/2"	H6 H6	J2 SIM,J8 } J2 SIM,J8 }	S3 1\ S3		26 20		ELECTRONIC ACCESS, BUZZ-THRU &
D101	21 011 7 71 211	FGAL2	ΔI	SF8	4 1/2"	H6	() ()	CO.		00		AUTO-OPENER TO THE PROPERTY OF
B121 B202	3'-0" x 7'-2" 3'-0" x 7'-2"	F WD	AL HM	HM1	8 3/4"	H6 H1	² J6,J8	S3		09 11		ELECTRONIC ACCESS ELECTRONIC ACCESS
B202 B203	3'-0" x 7'-2" 3'-0" x 7'-2"	F WD	HM HM	HM1	8 3/4"	H1 H1	J1 0	-		03	B201 B208	KEYSIDE BOTH SIDES
	3'-0" x 7'-2" 3'-0" x 7'-2"		HM HM	<u> </u>	8 3/4"		J1	-				
B204 B205	3'-0" x 7'-2" 3'-0" x 7'-2"	F WD	HM HM	HM1 HM1	8 3/4"	H1 H1	J1	-		11	B201	ELECTRONIC ACCESS
		F WD F WD	HM HM	HM1	8 3/4"	H1 H1	J1	-		04 04	B204 B207	
B206	3'-0" x 7'-2"						J1	-				ELECTRONIC ACCESS
B207	3'-0" x 7'-2"	F WD	HM	HM1	8 3/4"	H1	J1	-		11		ELECTRONIC ACCESS
B209	3'-0" x 7'-2"	F WD	HM	HM1	8 3/4"	H1	J1	-		11	B201	ELECTRONIC ACCESS
B210	3'-0" x 7'-2"	N WD	HM	HM1	8 3/4"	H1	J1	-		25	B201	
B211	3'-0" x 7'-2"	F WD	HM	HM1	8 3/4"	H1	J1	-		14	B201	
B212	3'-0" x 7'-2"	F WD	HM	HM1	8 3/4"	H1	J1	-		05	B201	
B213	3'-0" x 7'-2"	F WD	HM	HM1	8 3/4"	H1	J1	-		05	B201	
B214	3'-0" x 7'-2" 3'-0" x 7'-2"	F WD	HM	HM1	8 3/4"	H1	J1	-	00	14	B201	
B215	ייט יע די אייט יע	F WD	HM	HM1	8 3/4"	H1	J1	-	90	15	B201	İ


	DOOR AND FRAME SCHEDULE - ALTERNATES											
	DOORS	3			FR	AME				HAF	RDWARE	
DOOR	DOOR SIZE	DOOR	FRAME	FRAME	JAMB		DETAILS		FIRE	SET	KEYSID	
MARK	(WxH)	TYPE	MATERIAL	ELEVATION	DEPTH	HEAD	JAMB	SILL	RATING	NO.	E ROOM	REMARKS
			•	_							1	
C101	PR 3'-0" x 7'-2"	F WD	HM	HM2	8 3/4"	H1	J1			18	A102	
C101A	3'-0" x 7'-2"	F WD	HM	HM1	8 3/4"	H1	J1			12	A103	
C101B	10'-0" x 8'-0"	∠OHCD ~	$\sim\sim$ STL $\sim\sim$	~ · ~	~~ 2" ~	~~ H5 ~~	~~ J5 ~ ∧	S7,S8		35	EXT	MOTORIZED / ELECTRONIC ACCESS
C101C	ہے "2'-0" x 7'-2 ہے ﴿	F FRP	AL	SF23	4 1/2"	H2	J2 3/1	_		08	C101	
C101D	χ 10'-0" x 10'-0" }	OHCD U	STL U	you - my	2" U	j	المسلم الع	-		35	C101	MOTORIZED / ELECTRONIC ACCESS
D101 Z	1\sum 3'-0" x 7'-2"	FGAL2	AL	SF14 Y	1\ 4 1/2"	H2WB	J2	-		22	B119	ELECTRONIC ACCESS
D101A	3'-0" x 7'-2"	FGAL2	AL	کر SF14 ک	4 1/2"	∠~ H2 ~~	√ J2 √ 1\	_		26	B119	
D101B	PR 3'-0" x 7'-2"	FGAL2	AL	SF18	4 1/2"	ζ, H2	J2 }	-		31	A101	
D102	PR 3'-0" x 7'-2"	F WD	HM	HM2	8 3/4"	س H1 ر 🗻	ر ال ساس	-		16	D101	
D103	PR 3'-0" x 7'-2"	F WD	HM	HM2	8 3/4"	رم H1 مر		_		16	D101	
D104	3'-0" x 7'-2"	N FRP	AL	SF12	4 1/2"	2-A321	7-A320 3	S5,S6		30	EXT	
D104A	3'-0" x 7'-2"	FGAL2	AL	SF19	4 1/2"	ξ H2	J2 ~	S3 \}		27	A101	
D105	PR 3'-0" x 7'-2"	F WD	HM	HM2	8 3/4" ~	H1 CU	J ₁ ww	munum		18	D101	
D202	3'-0" x 7'-2"	N WD	HM	HM7	8 3/4"	H1	J1	S2		21	D201	ELECTRONIC ACCESS
D202A	3'-0" x 7'-2"	N WD	НМ	HM7	ىر 8 3/4" 8	1 H1	J1	S2		28	D201	
D202B			НМ	HM8	8 3/4"	H1	J1	S1		33	D201	
D202C			НМ	HM8	8 3/4"	H1	J1	S1		33	D201	
D202D	PR 3'-0" x 7'-2"	N WD	HM	HM9	8 3/4"	H1	J1	S2		32	D201	
D203	PR 3'-0" x 7'-2"	F WD	НМ	HM2	8 3/4"	H1	J1	-		17	D202	
D204	PR 3'-0" x 7'-2"	F WD	HM	HM2	8 3/4"	H1	J1	-		16	D202	
D205	3'-0" x 7'-2"	N WD	НМ	HM1	8 3/4"	H1	J1	-		01	D202	
D205A	3'-0" x 7'-2"	N WD	HM	HM1	8 3/4"	H1	J1	-		01	D202	
D206	3'-0" x 7'-2"	F WD	НМ	HM1	8 3/4"	H1	J1	-		12	D202	

DOOR GENERAL NOTES
- SAFETY AND SECURITY FILM IS TO BE APPLIED TO ALL GLAZING IN EXTERIOR DOORS AND ALSO INTERIOR DOORS AT VESTIBULE B120

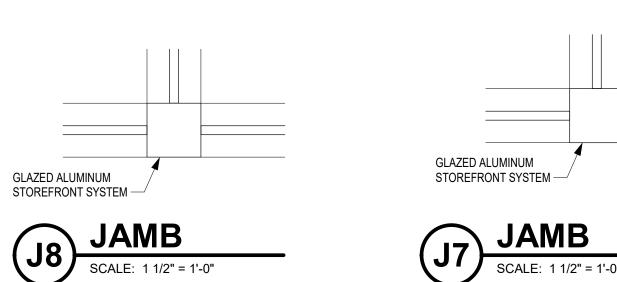


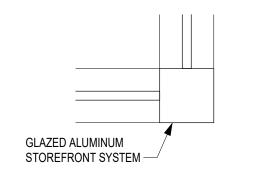

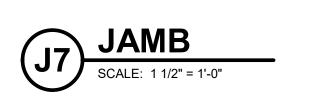

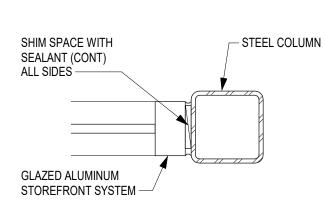



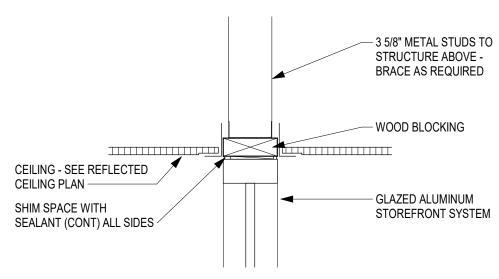

HEAD

SCALE: 1 1/2" = 1'-0"

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PENN-HARRIS-MADISON



FANNING HOWEY

WWW.FHAI.COM 317.848.0966 350 E NEW YORK ST #300, INDIANAPOLIS, IN 46204 ALTERNATE **KEY PLAN**

Construction Documents No. AR 1080016 STATE OF MOIANA ARCHITEC.


PROJECT MANAGER: MKS DRAWN BY: Author PROJECT NUMBER: 222130.00 PROJECT ISSUE DATE: January 10, 2024 NO. DESCRIPTION


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DATE


DOOR AND FRAME SCHEDULE **DOOR TYPES**


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GENERAL FINISH NOTES

ROOM LEGEND UNIT C
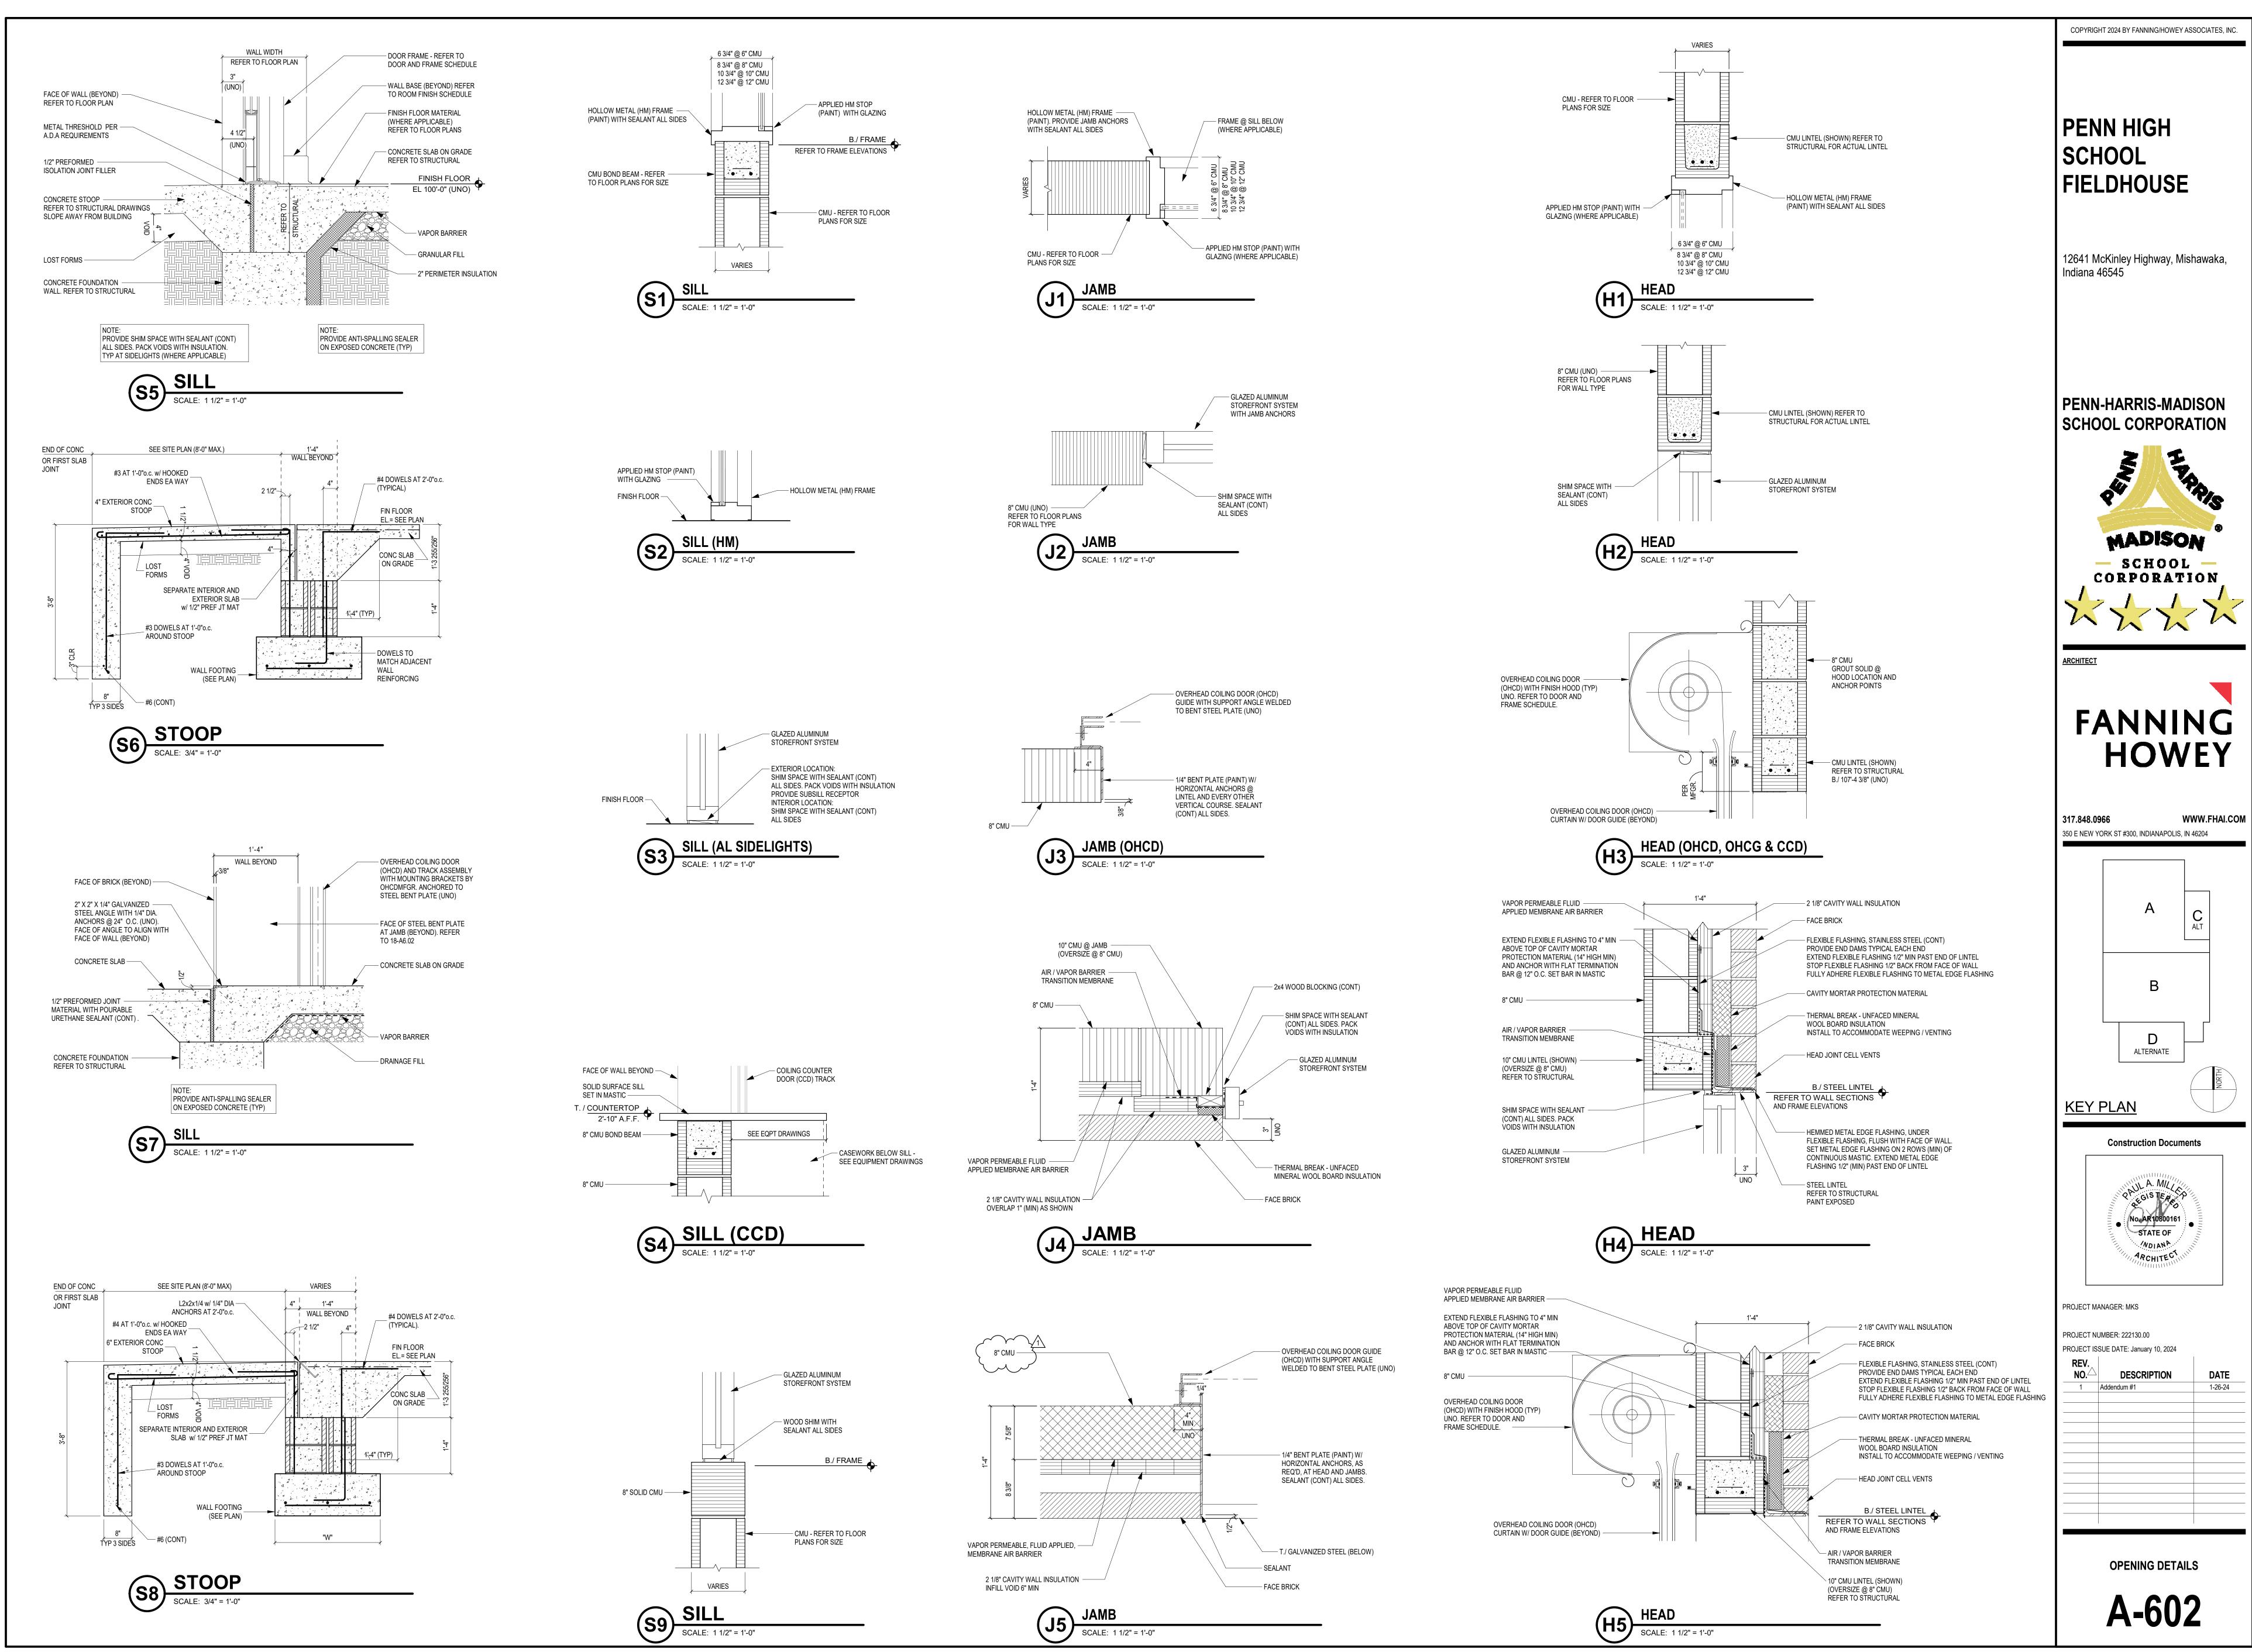
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Construction Documents

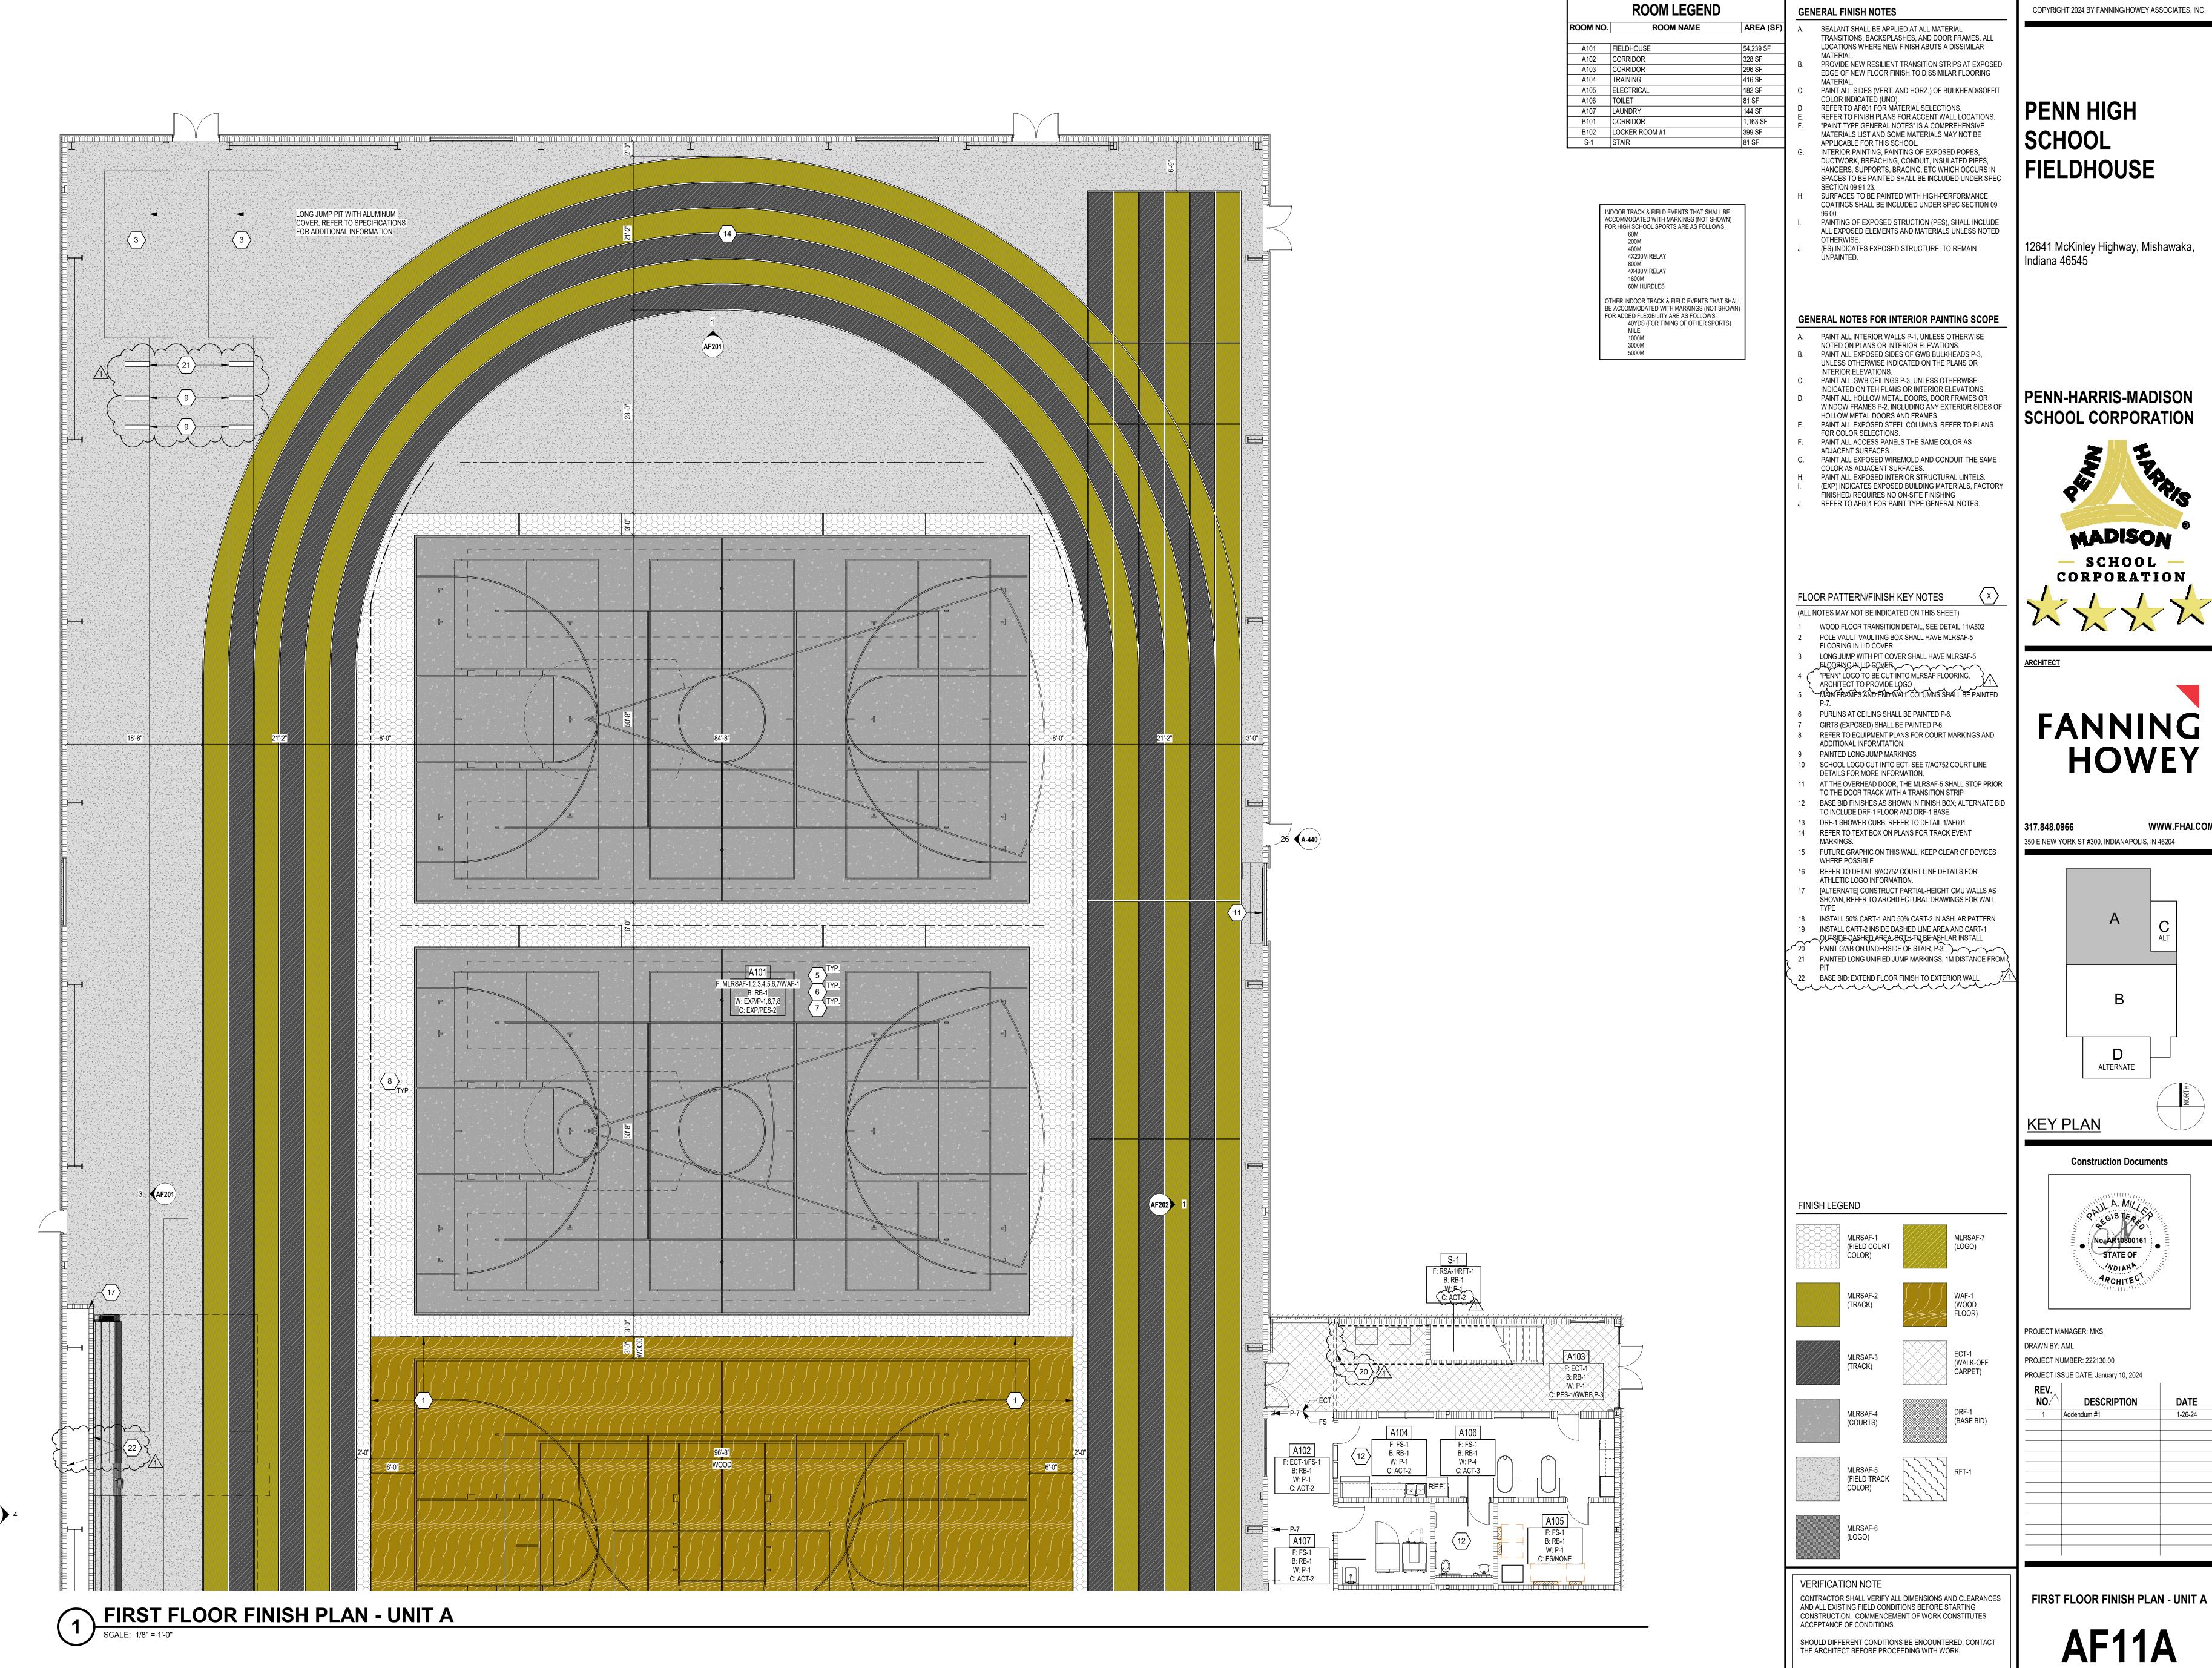No. AR 10800161
STATE OF MOIANA ARCHITEC

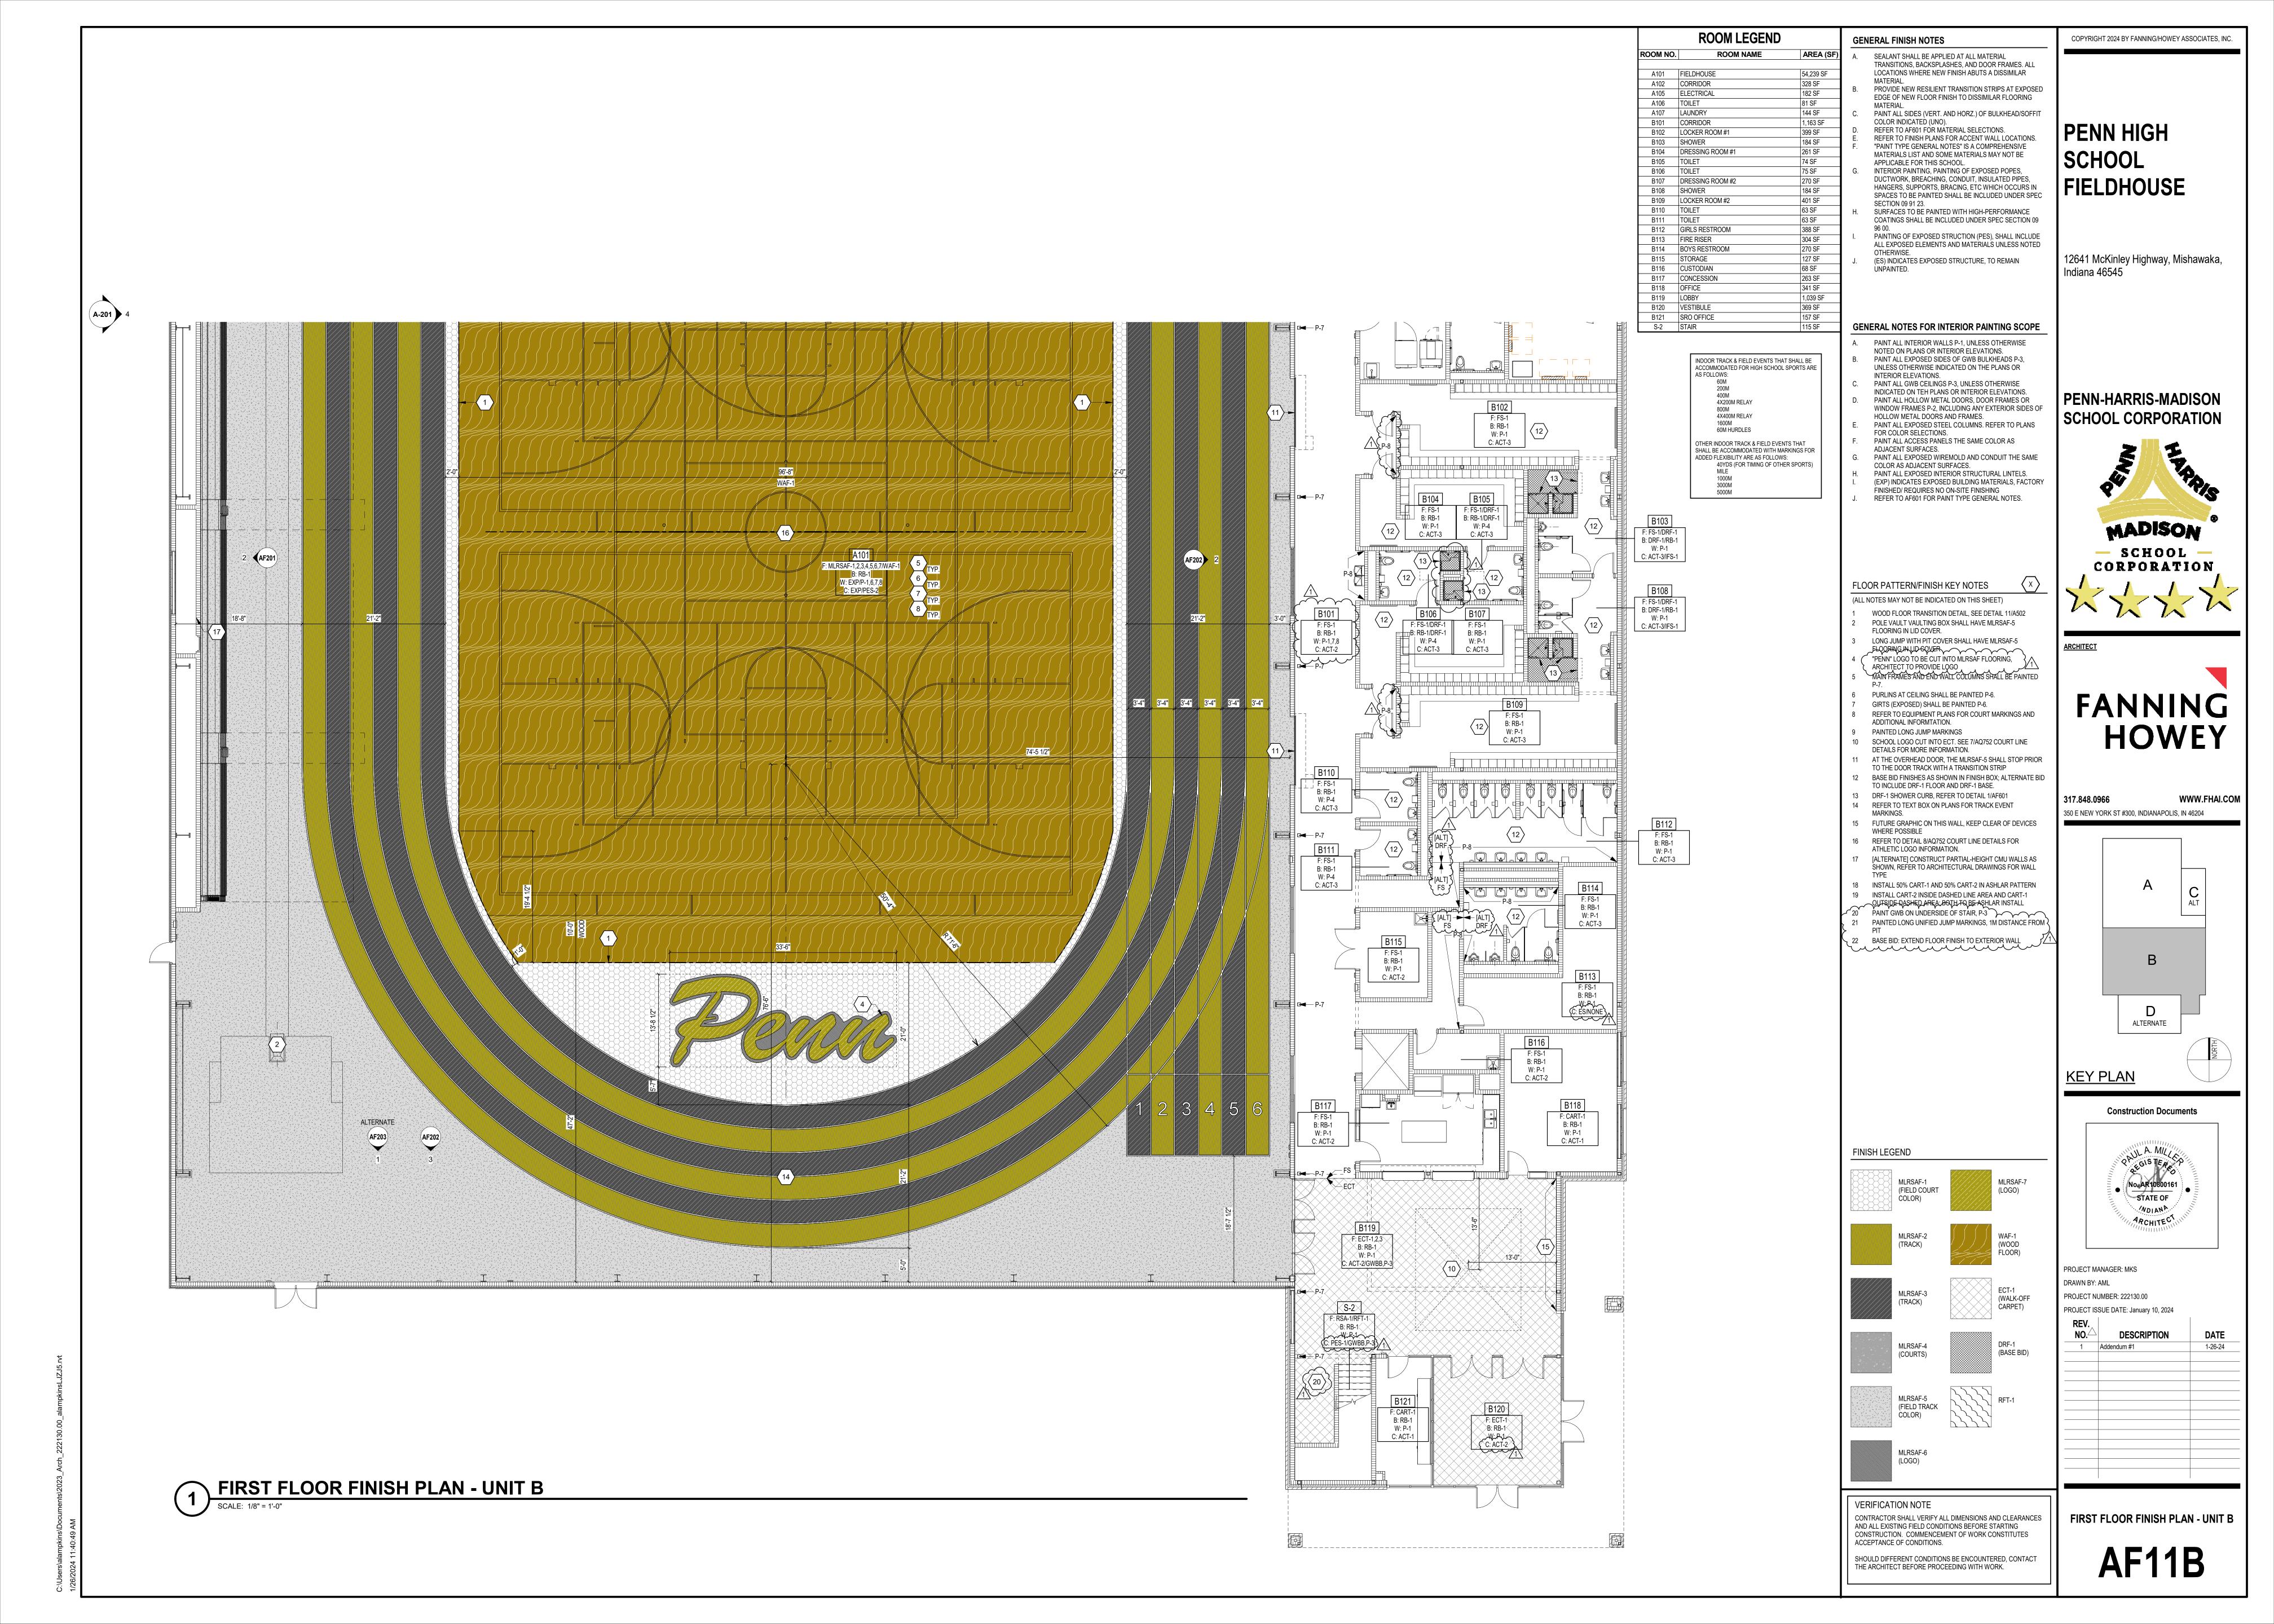
PROJECT NUMBER: 222130.00

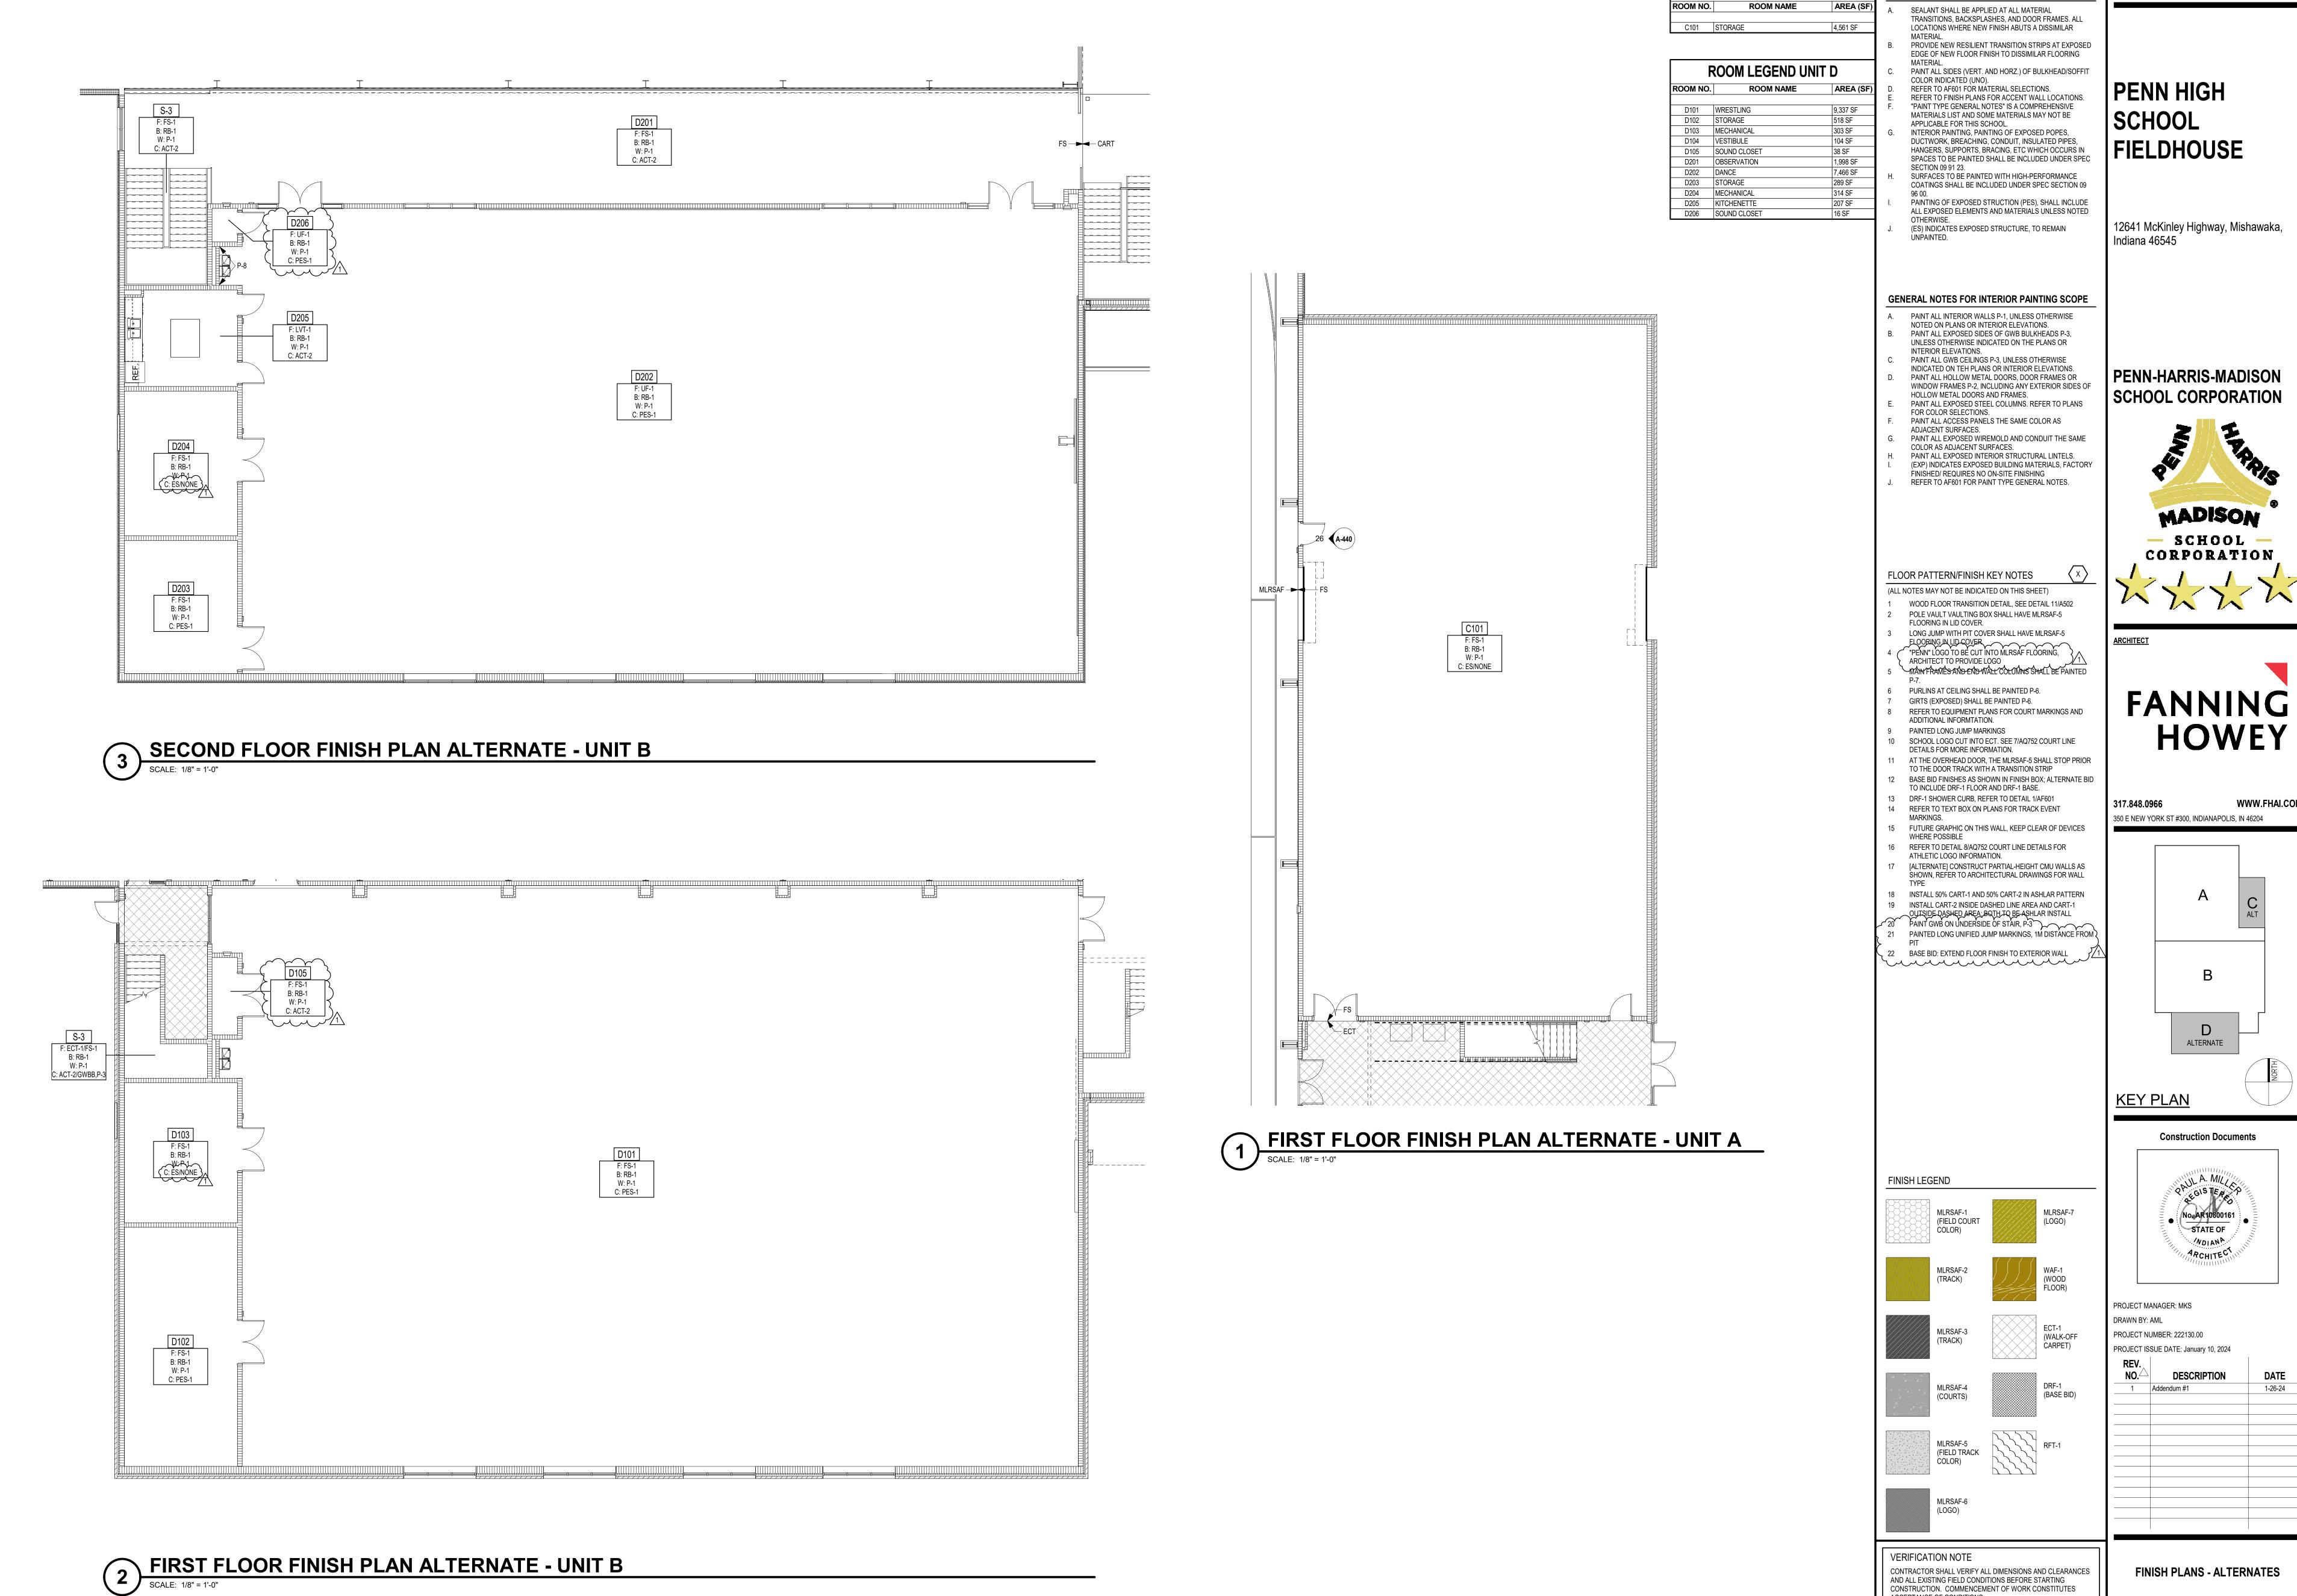AND ALL EXISTING FIELD CONDITIONS BEFORE STARTING CONSTRUCTION. COMMENCEMENT OF WORK CONSTITUTES ACCEPTANCE OF CONDITIONS.


SHOULD DIFFERENT CONDITIONS BE ENCOUNTERED, CONTACT THE ARCHITECT BEFORE PROCEEDING WITH WORK.

FINISH PLANS - ALTERNATES


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INTERIOR ELEVATION NOTES

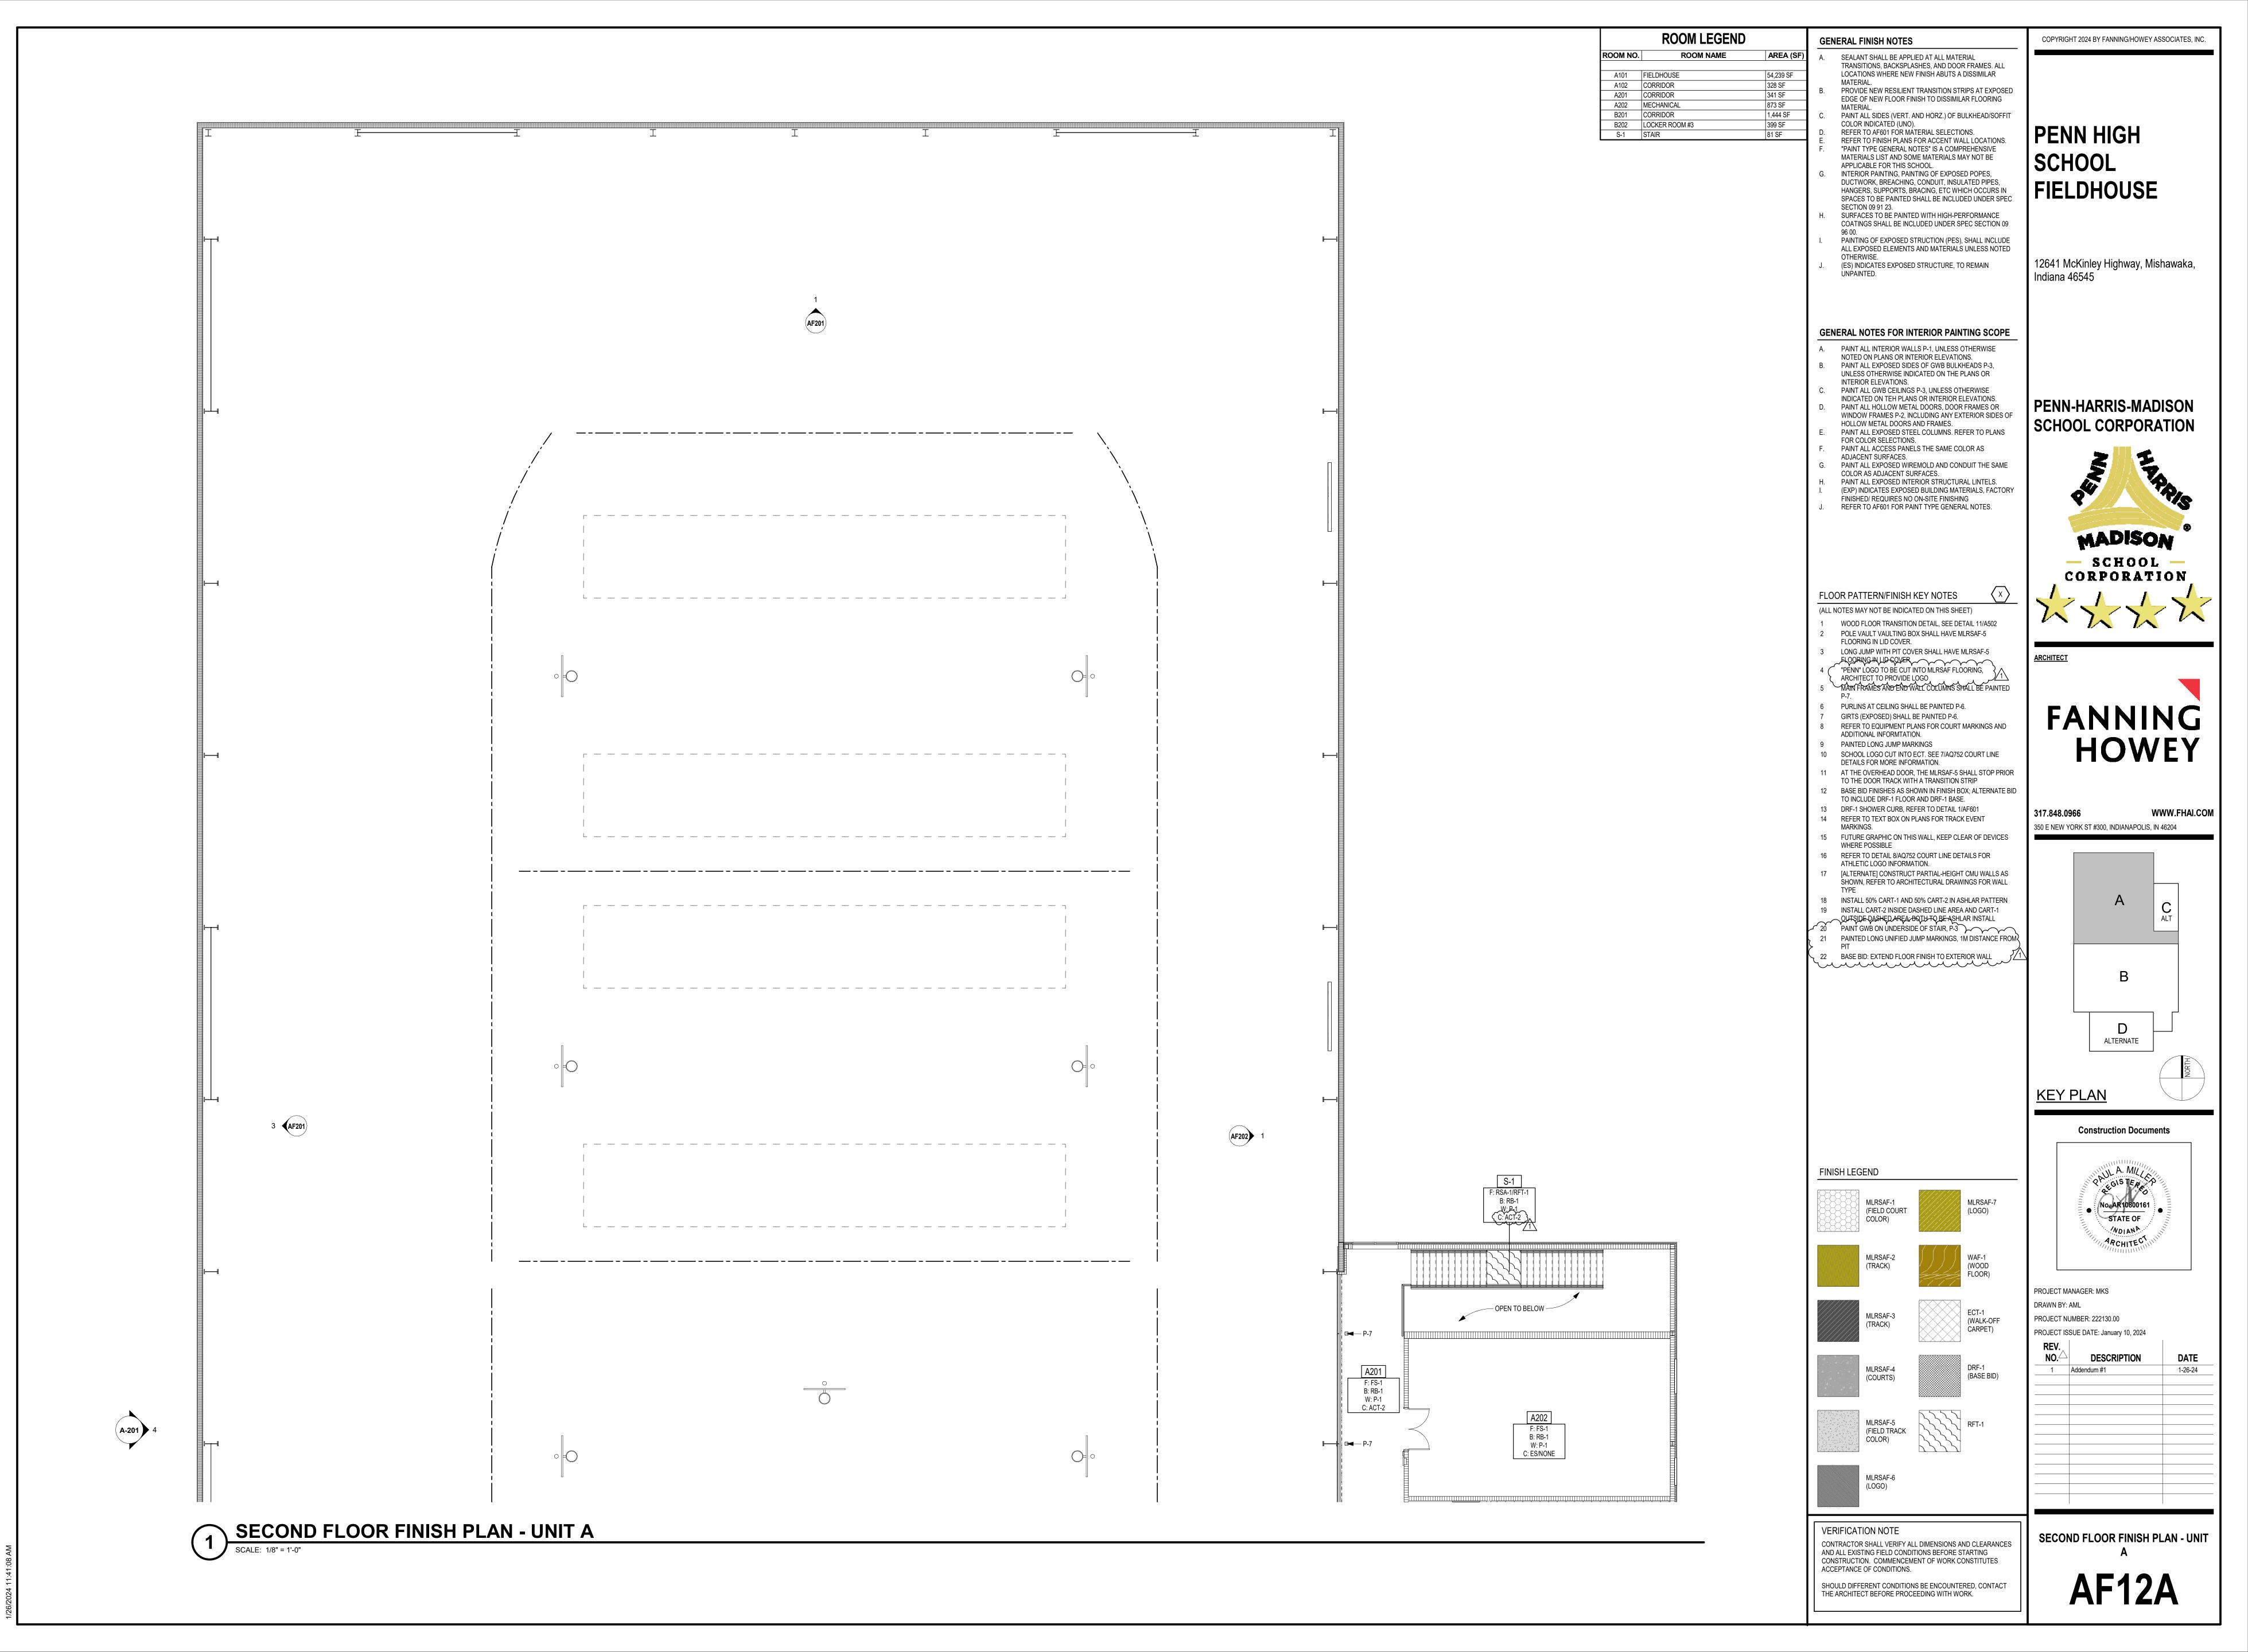(ALL NOTES MAY NOT BE INDICATED ON THIS SHEET)

1 CMU TO BE PAINTED P-8 2 BASE BID TO BE VINYL-FACED BATT INSULATION,

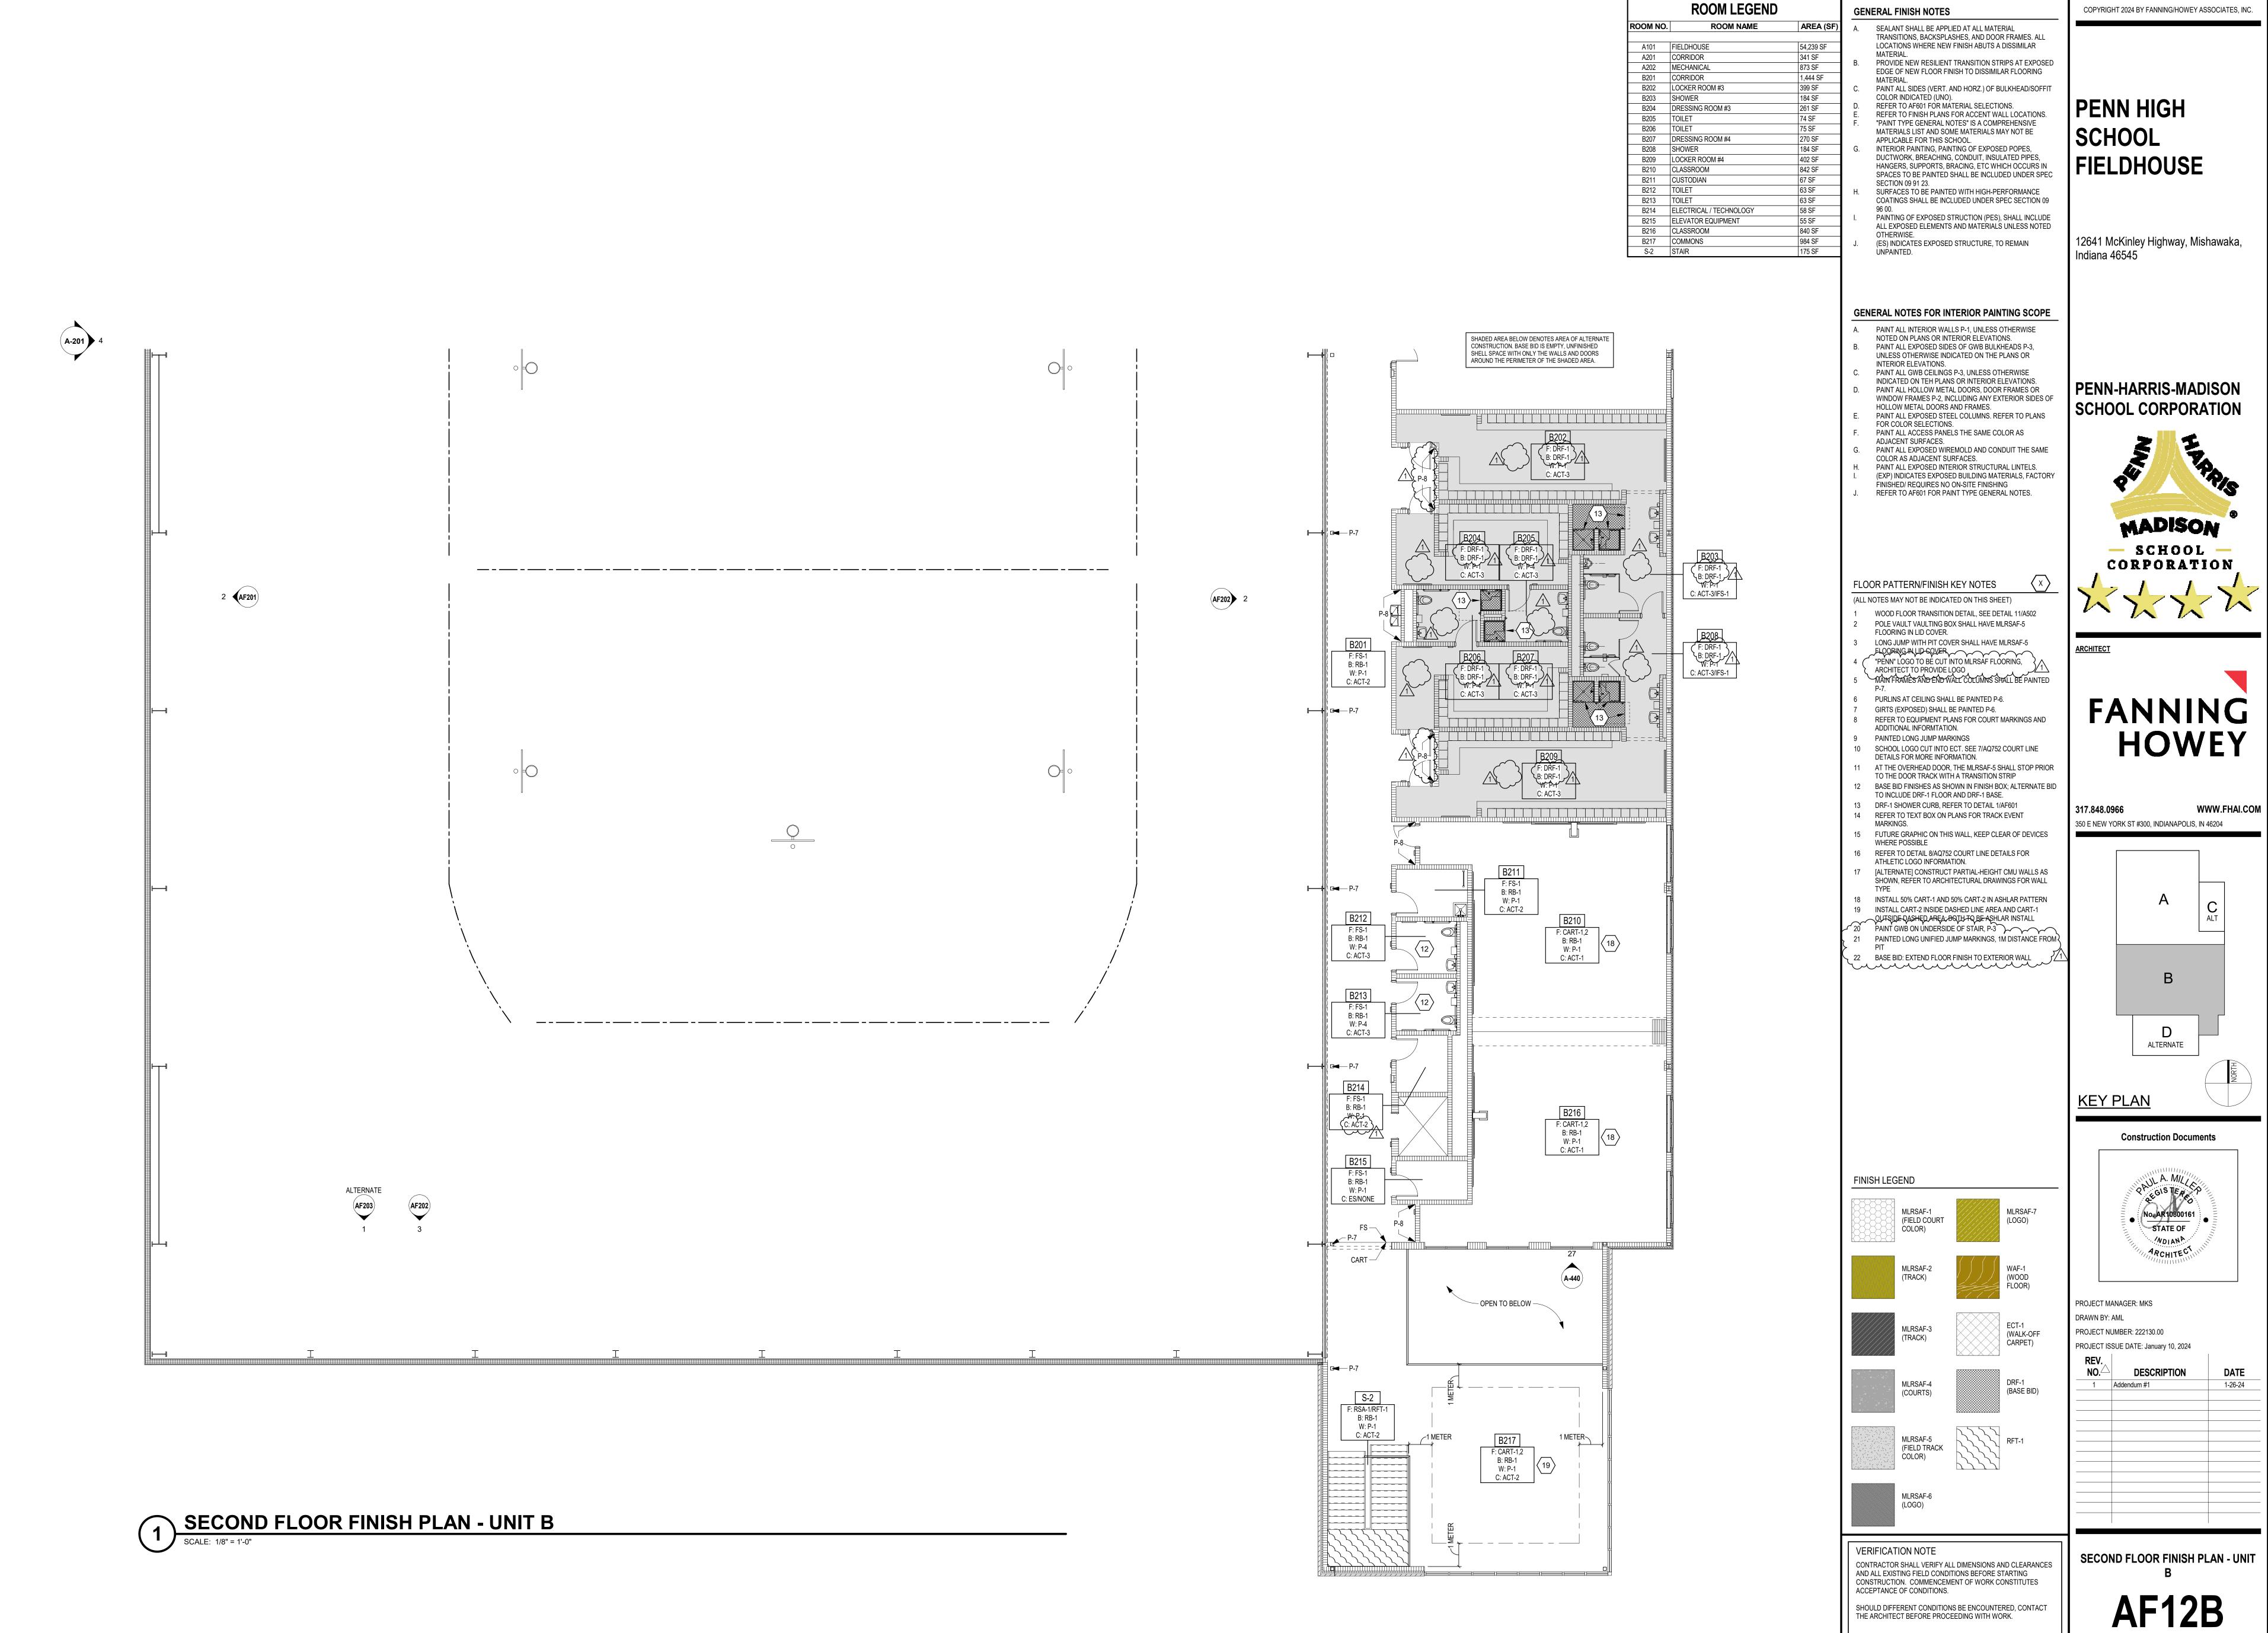ALTERNATE TO BE METAL LINER PANEL. PAINT EXPOSED 3 P-9 ATHLETIC EQUIPMENT, WALL PADDING

4 PAINT EXPOSED METAL BRACING, P-7 5 END COLUMNS, TO BE PAINTED P-7 6 MAIN FRAMES, TO BE PAINTED P-7 7 POLYCARBONATE WINDOW, REFER TO A1 SERIES

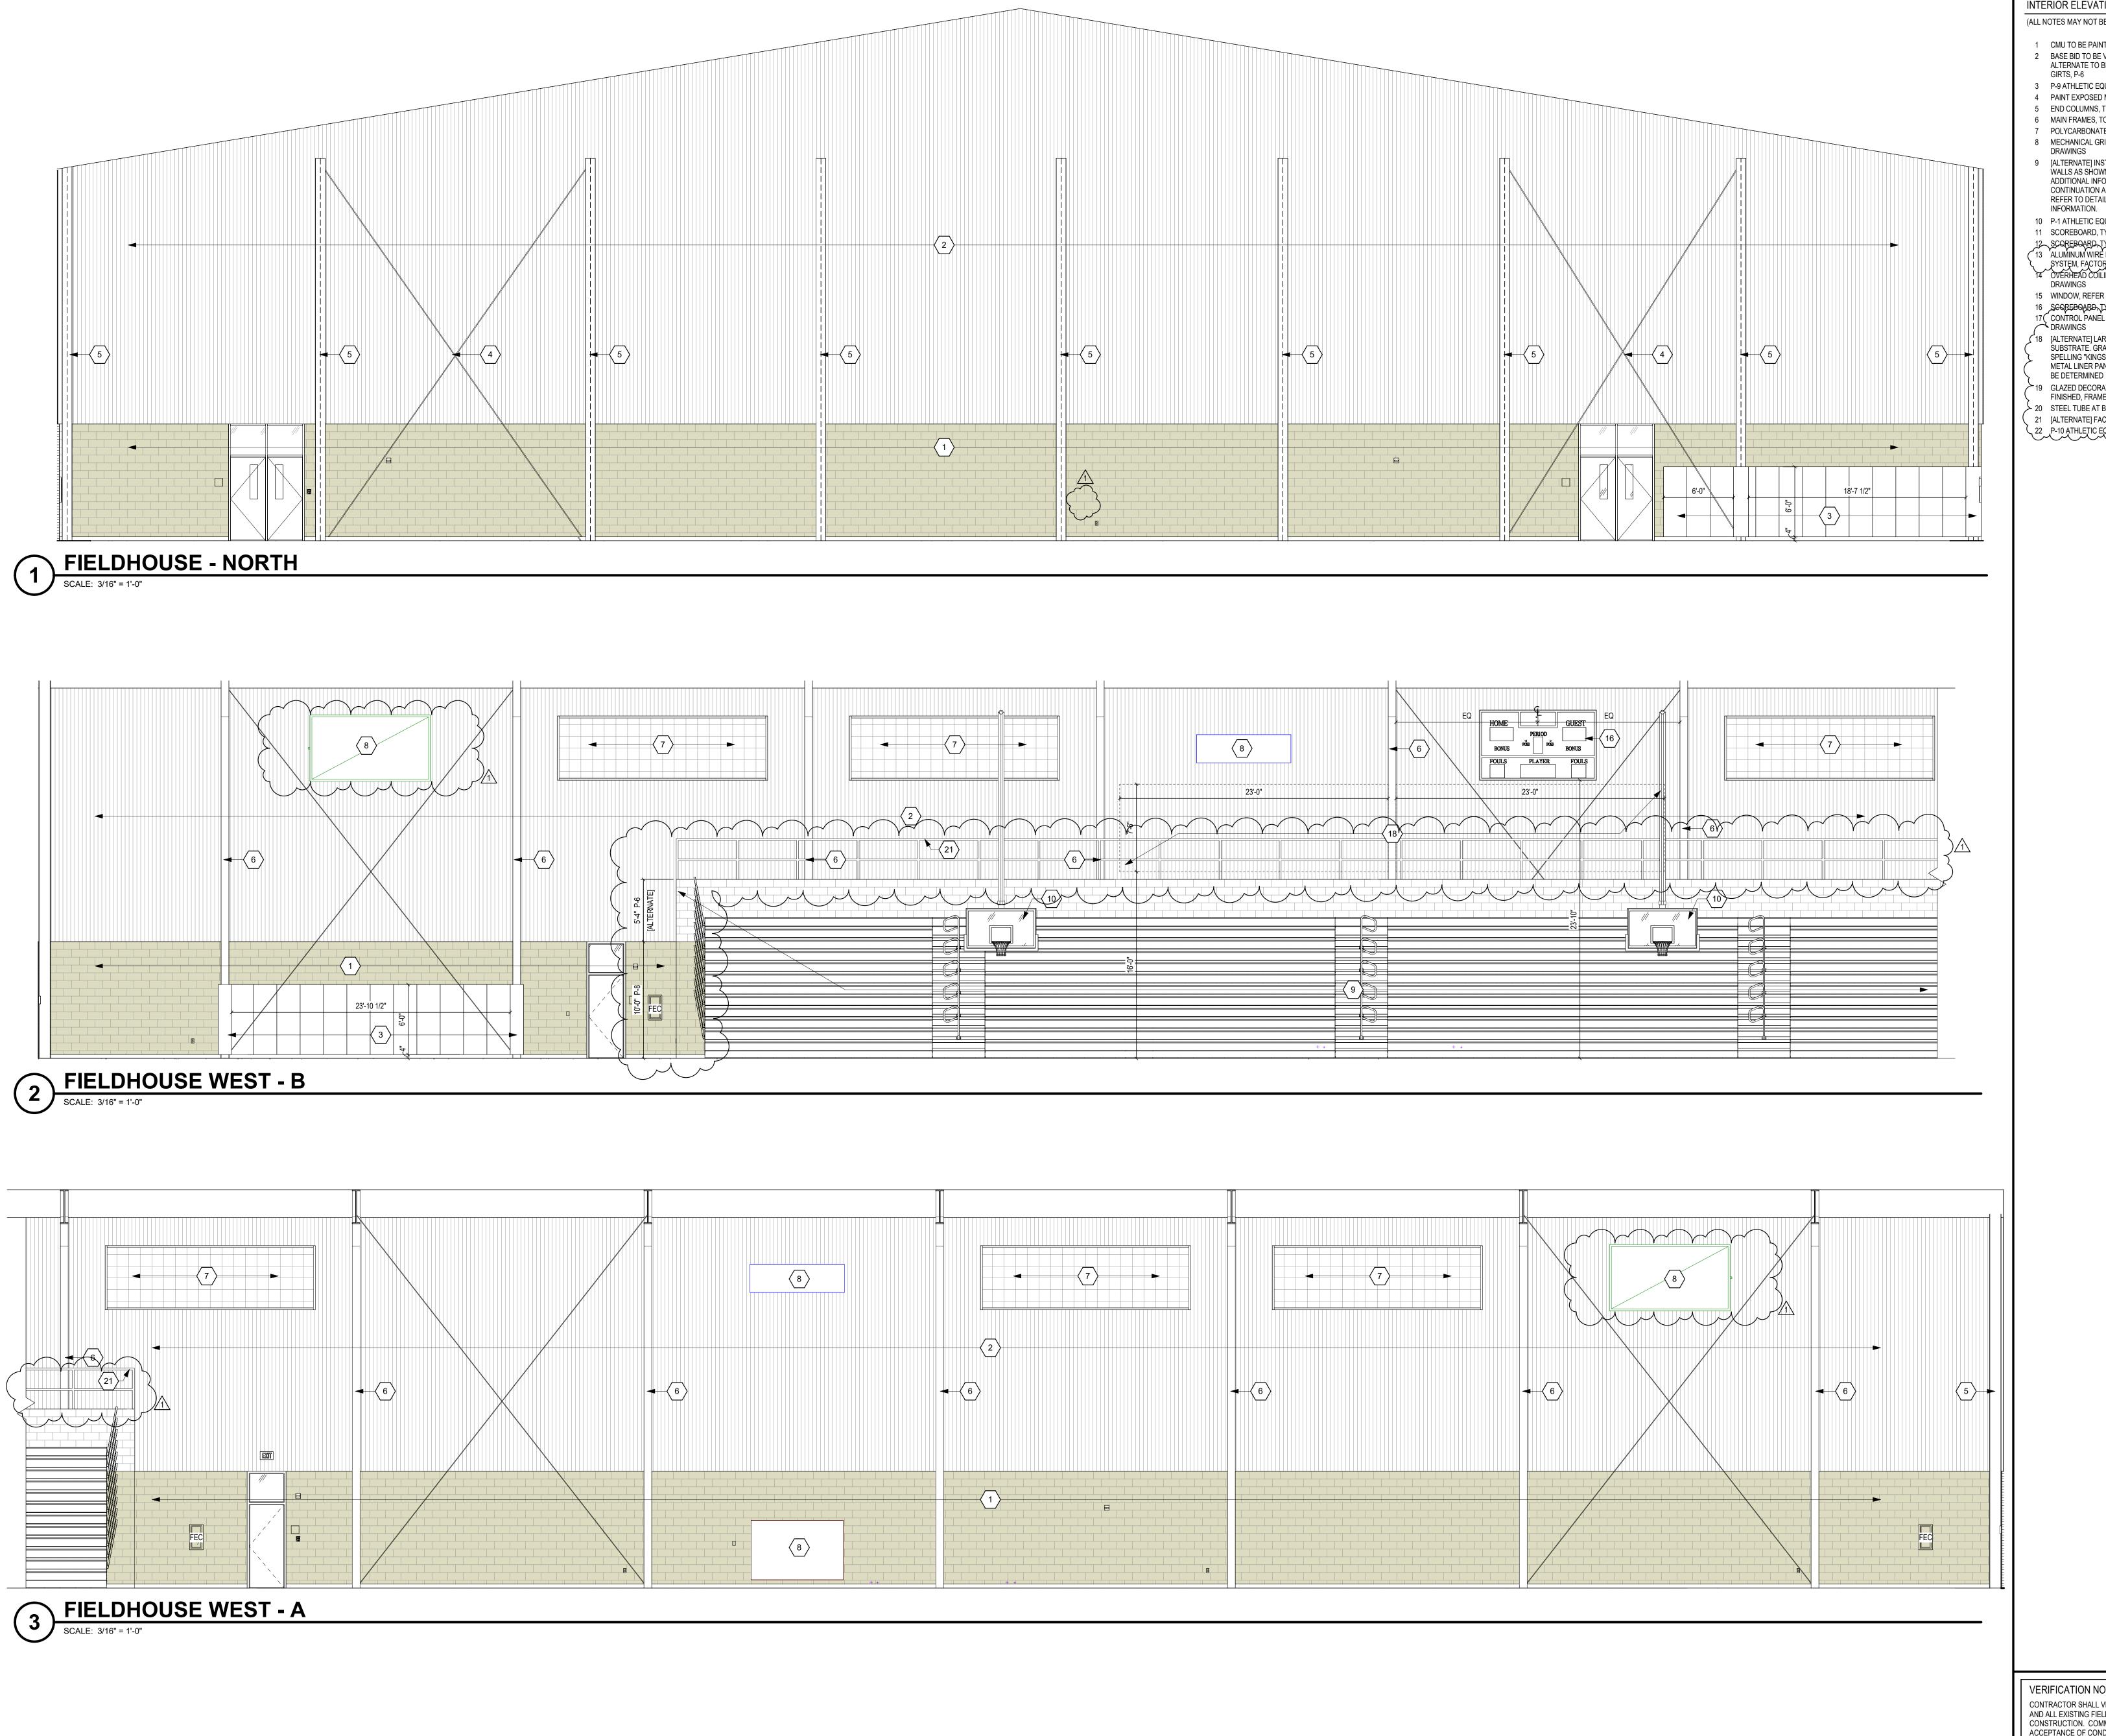8 MECHANICAL GRILLE OR DUCT, REFER TO M SERIES DRAWINGS 9 [ALTERNATE] INSTALL TELESCOPING BLEACHERS AND CMU WALLS AS SHOWN, REFER TO ARCHITECTURAL PLANS FOR ADDITIONAL INFORMATION. BASE BID TO INCLUDE CONTINUATION ADJACENT WALL TYPES AND MAINFRAMES. REFER TO DETAIL 10/AQ751 FOR BLEACHER GRAPHIC

10 P-1 ATHLETIC EQUIPMENT, BASKETBALL GOAL

11 SCOREBOARD, TYPE 1

12 SCOREBOARD, TYPE 2
13 ALUMINUM WIRE MESH DECORATIVE METAL RAILING
SYSTEM, FACTORY FINISHED, MATCH P-7
14 OVERHEAD COILING GRILLE, REFER TO ARCHITECTURAL
DRAWINGS 15 WINDOW, REFER TO ARCHITECTURAL DRAWINGS

16 SCOREBOARD, TYPE 2 MOUNTED TO METAL LINER PANEL.
17 CONTROL PANEL FOR FAN UNITS, REFER TO M SERIES 18 [ALTERNATE] LARGE SCALE GRAPHIC, PAINTED ON WALL

SUBSTRATE. GRAPHIC TO BE 2-COLOR SCRIPT FONT, SPELLING "KINGSMEN". GRAPHIC SHALL BE PART OF THE METAL LINER PANEL ALTERNATE AND FINAL LOCATION IS TO-BE DETERMINED → 19 GLAZED DECORATIVE METAL RAILING SYSTEM, FACTORY

FINISHED, FRAME TO MATCH P-7 ∠ 20 STEEL TUBE AT BOTTOM OF RAILING, PAINT P-7

21 [ALTERNATE] FACTORY-FINISHED ALUMINUM RAILING 22 P-10 ATHLETIC EQUIPMENT, EQUIPMENT CONTROL PANEL

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PENN HIGH

FIELDHOUSE

SCHOOL


Indiana 46545 [°]

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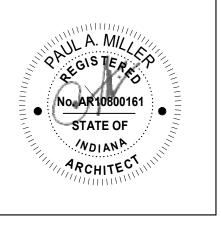


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Construction Documents



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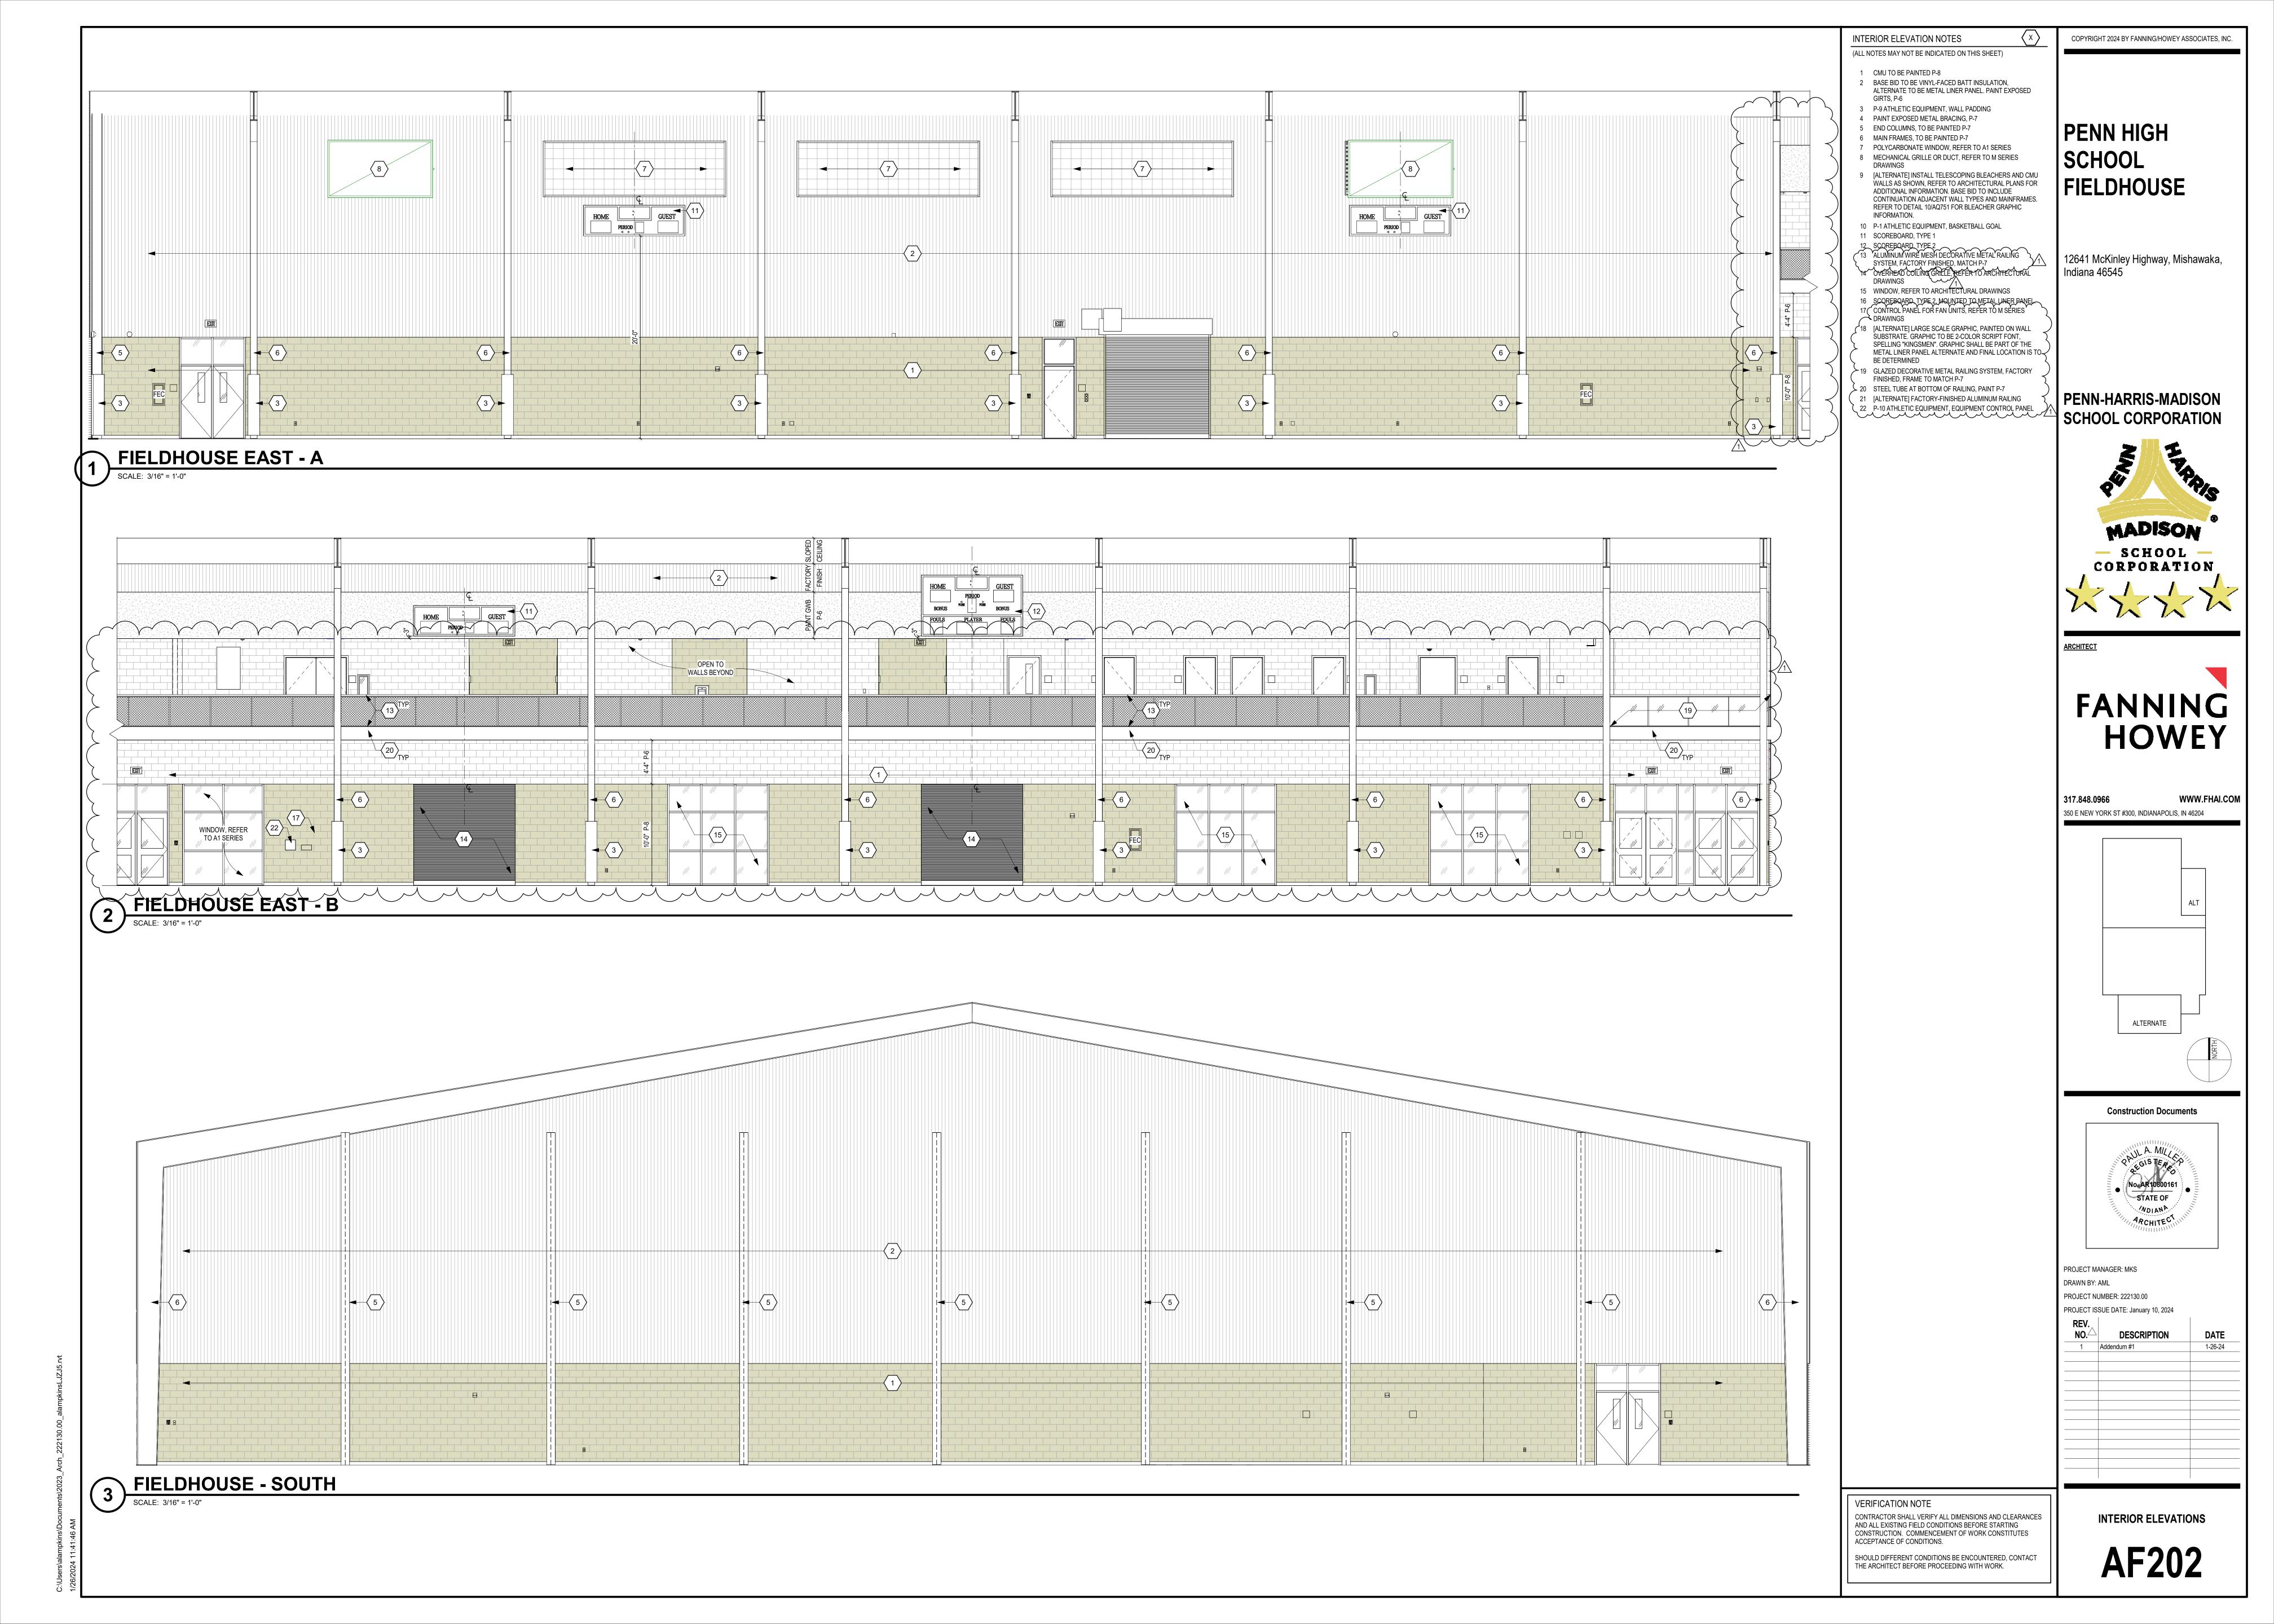
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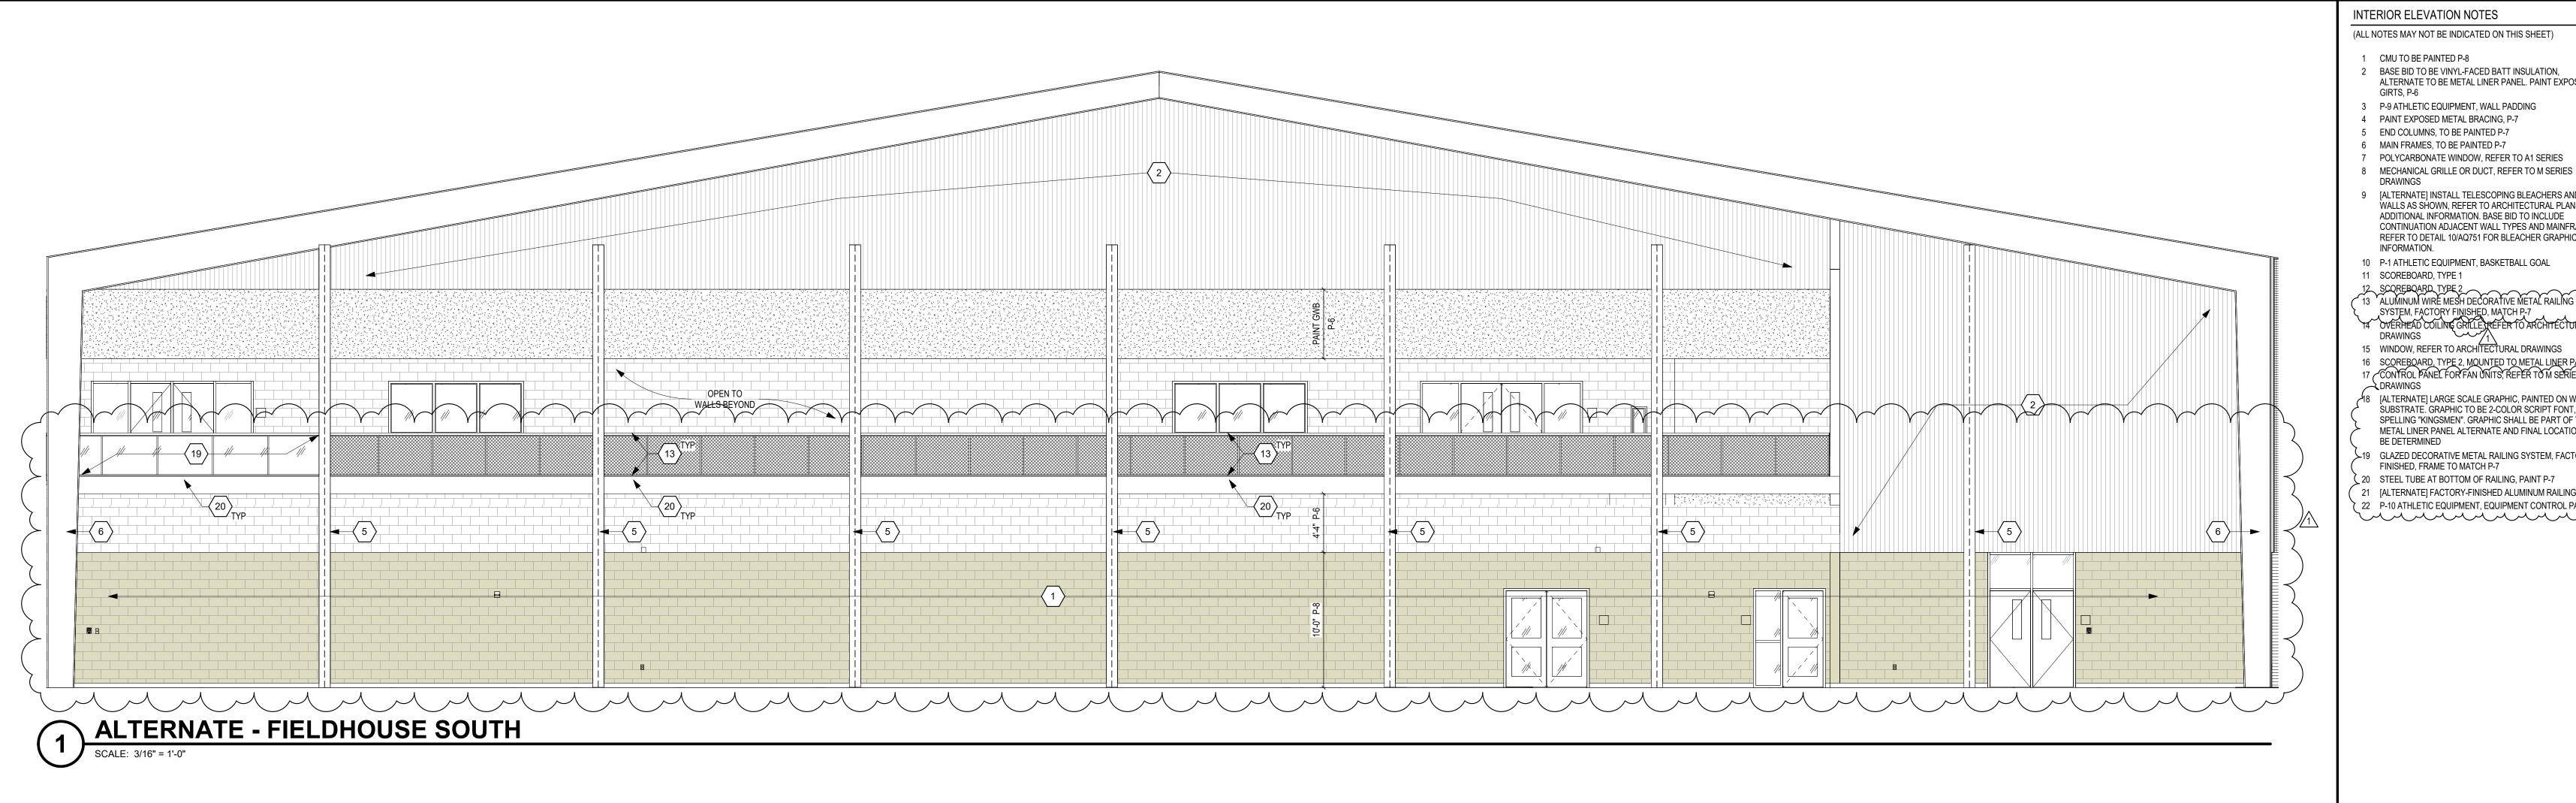
VERIFICATION NOTE

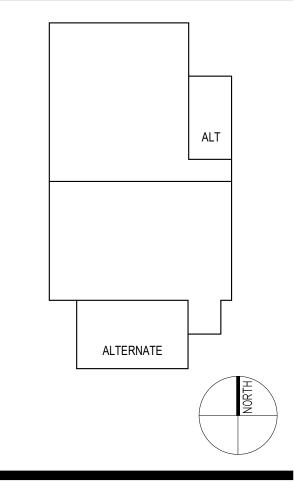CONTRACTOR SHALL VERIFY ALL DIMENSIONS AND CLEARANCES AND ALL EXISTING FIELD CONDITIONS BEFORE STARTING CONSTRUCTION. COMMENCEMENT OF WORK CONSTITUTES ACCEPTANCE OF CONDITIONS.

SHOULD DIFFERENT CONDITIONS BE ENCOUNTERED, CONTACT THE ARCHITECT BEFORE PROCEEDING WITH WORK.

INTERIOR ELEVATIONS





INTERIOR ELEVATION NOTES COPYRIGHT 2024 BY FANNING/HOWEY ASSOCIATES, INC. (ALL NOTES MAY NOT BE INDICATED ON THIS SHEET)

- 1 CMU TO BE PAINTED P-8 2 BASE BID TO BE VINYL-FACED BATT INSULATION, ALTERNATE TO BE METAL LINER PANEL. PAINT EXPOSED
- 3 P-9 ATHLETIC EQUIPMENT, WALL PADDING 4 PAINT EXPOSED METAL BRACING, P-7
- 5 END COLUMNS, TO BE PAINTED P-7 6 MAIN FRAMES, TO BE PAINTED P-7 7 POLYCARBONATE WINDOW, REFER TO A1 SERIES
- 9 [ALTERNATE] INSTALL TELESCOPING BLEACHERS AND CMU WALLS AS SHOWN, REFER TO ARCHITECTURAL PLANS FOR ADDITIONAL INFORMATION. BASE BID TO INCLUDE CONTINUATION ADJACENT WALL TYPES AND MAINFRAMES.
 REFER TO DETAIL 10/AQ751 FOR BLEACHER GRAPHIC
- INFORMATION. 10 P-1 ATHLETIC EQUIPMENT, BASKETBALL GOAL
- 11 SCOREBOARD, TYPE 1
- 12 SCOREBOARD TYPE 2

 13 ALUMINUM WIRE MESH DECORATIVE METAL RAILING
 SYSTEM, FACTORY FINISHED, MATCH P-7

 14 OVERHEAD COILING GRILLE, REFER TO ARCHITECTURAL
 DRAWINGS

 15 WINDOW, REFER TO ARCHITECTURAL DRAWINGS
- 16 SCOREBOARD, TYPE 2, MOUNTED TO METAL LINER PANEL. 17 CONTROL PANEL FOR FAN UNITS, REFER TO M SERIES
- [ALTERNATE] LARGE SCALE GRAPHIC, PAINTED ON WALL SUBSTRATE. GRAPHIC TO BE 2-COLOR SCRIPT FONT, SPELLING "KINGSMEN". GRAPHIC SHALL BE PART OF THE METAL LINER PANEL ALTERNATE AND FINAL LOCATION IS TO BE DETERMINED
- √19 GLAZED DECORATIVE METAL RAILING SYSTEM, FACTORY FINISHED, FRAME TO MATCH P-7 20 STEEL TUBE AT BOTTOM OF RAILING, PAINT P-7
- 21 [ALTERNATE] FACTORY-FINISHED ALUMINUM RAILING 22 P-10 ATHLETIC EQUIPMENT, EQUIPMENT CONTROL PANEL

PENN HIGH SCHOOL FIELDHOUSE


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Construction Documents



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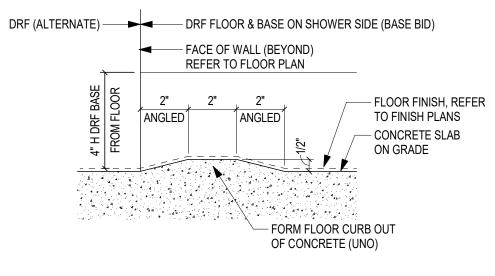
REV. NO.△	DESCRIPTION	DATE
1	Addendum #1	1-26-24

VERIFICATION NOTE

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SHOULD DIFFERENT CONDITIONS BE ENCOUNTERED, CONTACT THE ARCHITECT BEFORE PROCEEDING WITH WORK.

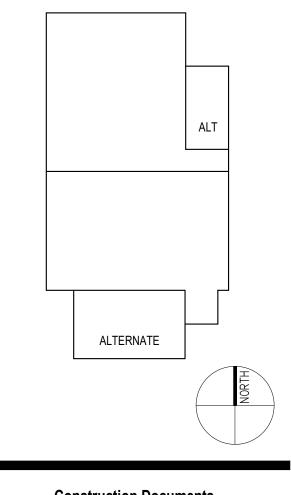INTERIOR ELEVATIONS - ALTERNATE





CEILING FINISHES ACOUSTICAL CEILING TILES MATERIAL ABBREVIATION MATERIAL/MANUFACTURER **COLOR SELECTION** ACT-1 (OFFICE/CLASS) REFER TO SPECIFICATIONS WHITE / 2'X2' ACT-2 (FIELD) REFER TO SPECIFICATIONS WHITE / 2'X2' WHITE / 2'X2' ACT-3 (RESTROOMS) REFER TO SPECIFICATIONS **INTERIOR FINISH SYSTEM COLOR SELECTION** MATERIAL ABBREVIATION MATERIAL/MANUFACTURER REFER TO SPECIFICATIONS TO BE SELECTED (WHITE) PAINTED EXPOSED STRUCTURE MATERIAL ABBREVIATION MATERIAL/MANUFACTURER **COLOR SELECTION** SHERWIN WILLIAMS MATCH P-3 PAINT DECK/ MECHANICAL/ ETC PES-2 (FIELDHOUSE) SHERWIN WILLIAMS PAINT MAIN FRAMES, P-7 PAINT PURLINS, P-6

PAINT TYPE GENERAL NOTES

NOTE: THIS IS A COMPREHENSIVE LIST OF PAINT TYPES, NOT ALL ARE APPLICABLE TO THE PENN FIELDHOUSE PROJECT.

WALLS - HIGH PERFORMANCE COATINGS:

WP1. CONCRETE WALLS: NEW OR EXISTING WALLS SHALL BE PAINTED WITH PAINT CODE #3.113, SATIN WP2. CONCRETE MASONRY UNITS (CMU): NEW OR EXISTING WALLS SHALL BE PAINTED WITH PAINT CODE #4.223, SATIN

WP3. BRICK WALLS: NEW OR EXISTING WALLS SHALL BE PAINTED WITH PAINT CODE #4.112, SATIN WP4. GYPSUM WALLBOARD (GWB): NEW AND EXISTING WALLS SHALL BE PAINTED WITH PAINT CODE #9.212, SATIN

WP5. PLASTER (PLAS): EXISTING WALLS SHALL BE PAINTED WITH PAINT CODE #9.211, SATIN WP6. STRUCTURAL GLAZED FACING TILE (SGFT): EXISTING WALLS SHALL BE PAINTED WITH PAINT CODE #4.223, SATIN. REFER TO

SPECIFICATIONS FOR ADDITIONAL SURFACE PREPARATION. WP7. CERAMIC TILE WALLS (CWT): EXISTING WALL TILE SHALL BE PAINTED WITH PAINT CODE #4.223, SATIN. REFER TO SPECIFICATIONS FOR

ADDITIONAL SURFACE PREPARATION. WP8. ABUSE-RESISTANT ACOUSTICAL TILES (AR-AWT): NEW OR EXISTING PANELS SHALL BE PAINTED WITH PAINT CODE #11.0, DRY FALL,

WALLS - FIELDHOUSE - HIGH PERFORMANCE COATINGS:

WP9. CONCRETE MASONRY UNITS (CMU): NEW OR EXISTING WALLS SHALL BE PAINTED WITH PAINT CODE #4.223, SEMI-GLOSS. REFER TO INTERIOR ELEVATIONS FOR ADDITIONAL INFORMATION INCLUDING PAINT COLORS AND GRAPHICS.

CEILING/STRUCTURE - INTERIOR PAINTING:

CP1. GYPSUM WALLBOARD (GWB): NEW OR EXISTING SOFFITS, CEILINGS, AND BULKHEADS SHALL BE PAINTED WITH PAINT CODE #9.21, FLAT. CP2. PLASTER (PLAS): EXISTING CEILINGS SHALL BE PAINTED WITH PAINT CODE #9.31, EGGSHELL.

CP3. EXPOSED STEEL (FERROUS) STRUCTURE: EXPOSED STRUCTURE SHALL BE PAINTED WITH PAINT CODE #5.11, DRY FALL. CP4. GALVANIZED METAL (EXCLUDING STRUCTURE): EXPOSED DECK SHALL BE PAINTED WITH PAINT CODE #5.31, DRY FALL.

CP5. GALVANIZED METAL STRUCTURE: EXPOSED METAL DECK SHALL BE PAINTED WITH PAINT CODE #5.31, DRY FALL. CP6. ABUSE-RESISTANT ACOUSTICAL PANELS (AR-AWT): NEW OR EXISTING PANELS SHALL BE PAINTED WITH PAINT CODE #11.0, DRY FALL.

MISC. MATERIALS - INTERIOR PAINTING:

MP1. METAL, EXISTING: SURFACES THAT HAVE BEEN PREVIOUSLY PAINTED, SUCH AS HOLLOW METAL, EXPOSED STEEL, SHALL BE PAINTED WITH PAINT CODE #5.12, SEMI-GLOSS.

MP2. WOOD TRIM (WD) WITH EXISTING STAIN: SHALL BE PAINTED WITH PAINT CODE #6.31, SEMI-GLOSS, WHERE INDICATED ON PLANS. MP3. PIPE AND DUCT COVERINGS: EXPOSED NEW AND EXISTING COVERINGS SHALL BE PAINTED WITH PAINT CODE #11.0, DRY FALL.

MISC. MATERIALS - EXTERIOR HIGH-PERFORMANCE COATINGS:

MP4. METAL AND STEEL: EXPOSED EXISTING SURFACES SHALL BE PAINTED WITH PAINT CODE #5.111, SEMI-GLOSS WHERE INDICATED ON

MP5. GALVANIZED METAL: EXPOSED EXISTING SURFACES SHALL BE PAINTED WITH PAINT CODE #5.311, SEMI-GLOSS, WHERE INDICATED ON

LIST OF FINISHES

REFER TO AF DWG. SHEETS

FLOOR MATERIALS

CARPET TILE MATERIAL/MANUFACTURER **COLOR SELECTION** MATERIAL ABBREVIATION INTERFACE / RISING SIGNS / SPANDREL SELENIUM 107153 / 25CM X 1M CART-2 INTERFACE / RISING SIGNS / SPANDREL GOLD 107159 / 25CM X 1M

ALL CARPET BACKING TO HAVE A MOISTURE RESISTANT BARRIER. INSTALLATION METHOD TO BE ASHLAR.

DICATING DIDECTION & LAVOUT OF CARRET THE DRIOD TO INSTALLATION FOR ARREDOVAL

SUBMIT INSTALLATION D	RAWINGS INDICATING DIRECTION & LAYOU	T OF CARPET TILE PRIOR TO INSTALLATION FOR APPROV
DECORATIVE RESINOUS	FLOORING	
MATERIAL ABBREVIATION	MATERIAL/MANUFACTURER	COLOR SELECTION
DRF-1	REFER TO SPECIFICATIONS	MATCH SHERWIN WILLIAMS "ORIENTAL SPICE"
ENTRANCE CARPET TILE	<u> </u>	
MATERIAL ABBREVIATION	MATERIAL/MANUFACTURER	COLOR SELECTION
ECT-1 (FIELD)	FLOR / INDUSTRIOUS	BLACK 21-1552-03 MARIGOLD 21-1552-10

IRON 21-1552-02

FLOOR SEALER

ECT-3 (GRAPHIC - OUTLINE)

MATERIAL ABBREVIATION MATERIAL/MANUFACTURER **COLOR SELECTION** CLEAR REFER TO SPECIFICATIONS

FLOR / INDUSTRIOUS

MATERIAL ABBREVIATION

LUXURY VINYL TILE [ALTERNATE]

MATERIAL/MANUFACTURER **COLOR SELECTION** INTERFACE / TEXTURED STONES WARM POLISHED CEMENT A00303 / 50CM X 50CM }

MULTI-LAYER RUBBER ATHLETIC FLOORING

COLOR SELECTION MATERIAL ABBREVIATION MATERIAL/MANUFACTURER L70 LIGHT GREY / 10MM MLRSAF-1 MONDO / ADVANCE PRO MLRSAF-2 (TRACK) MONDO / SUPER X 720 K35 COGNAC P58 / 10MM ANTHRACITE P105 / 10MM MLRSAF-3 (TRACK) MONDO / SUPER X 720 K35 MLRSAF-4 (COURTS) L92 DARK MAPLE / 10MM MONDO / ADVANCE PRO MLRSAF-5 MONDO / SUPER X 720 K35 MEDIUM GREY P31 / 10MM MLRSAF-6 (LOGO) MONDO / ADVANCE PRO L08 BLACK / 10MM MLRSAF-7 (LOGO) MONDO / ADVANCE PRO L54 GOLD / 10MM

RESILIENT STAIR ACCESSORIES

MATERIAL ABBREVIATION MATERIAL/MANUFACTURER **COLOR SELECTION** ROPPE / VANTAGE RUBBER STAIR TREAD BLACK 100 TREAD WITH RAISED CIRCULAR DESIGN Y W/O RISER #98 AND ABRASIVE STRIP OCEAN GRAY ABRASIVE STRIP

RUBBER FLOOR TILE

MATERIAL/MANUFACTURER COLOR SELECTION MATERIAL ABBREVIATION ROPPE / VANTAGE TILE BLACK 100 / #996 RAISED CIRCULAR PATTERN / 5 50CM X 50XM

URETHANE FLOORING [ALTERNATE]

MATERIAL ABBREVIATION MATERIAL/MANUFACTURER **COLOR SELECTION** TO BE SELECTED REFER TO SPECIFICATIONS

WOOD ATHLETIC FLOORING

COLOR SELECTION MATERIAL ABBREVIATION MATERIAL/MANUFACTURER REFER TO SPECIFICATIONS TO BE SELECTED

BASE MATERIALS

DECORATIVE RESINOUS BASE INTEGRAL BASE MATERIAL/MANUFACTURER **COLOR SELECTION** MATERIAL ABBREVIATION REFER TO SPECIFICATIONS MATCH SHERWIN WILLIAMS "ORIENTAL SPICE" **RESILIENT BASE** COVE BASE MATERIAL ABBREVIATION MATERIAL/MANUFACTURER **COLOR SELECTION** JOHNSONITE/TARKETT BLACK 40

WALL FINISHES

PAINT

MATERIAL ABBREVIATION MATERIAL/MANUFACTURER **COLOR SELECTION** P-1 (FIELD) SHERWIN WILLIAMS AGREEABLE GREY SW7029 P-2 (DOOR FRAMES) SHERWIN WILLIAMS TRICORN BLACK SW6258 P-3 (CEILINGS) SHERWIN WILLIAMS TO BE SELECTED P-4 (RESTROOMS) TO BE SELECTED SHERWIN WILLIAMS P-5 (BENCH SEAT) SHERWIN WILLIAMS TO BE SELECTED TO BE SELECTED (MATCH LINER PANEL) P-6 (EXPOSED GIRTS & PURLINS) SHERWIN WILLIAMS P-7 (MAIN FRAMES/COLUMNS) SHERWIN WILLIAMS TRICORN BLACK SW6258 SHERWIN WILLIAMS TO BE SELECTED (PHM GOLD)

MISCELLANEOUS FINISHES

INTERIOR WOOD DOORS/ INTERIOR WOOD TRIM

 STAIN ALL WOOD DOORS, WOOD TRIM, ETC. COLOR TO BE SELECTED. WOOD SPECIES TO BE PLAIN SLICED RED OAK. PROVIDE WOOD STAIN SAMPLES FOR VERIFICATION.

RESILIENT MOLDING ACCESSORIES

COLOR SELECTION BLACK 40 JOHNSONITE/TARKETT

| PENN HIGH SCHOOL FIELDHOUSE

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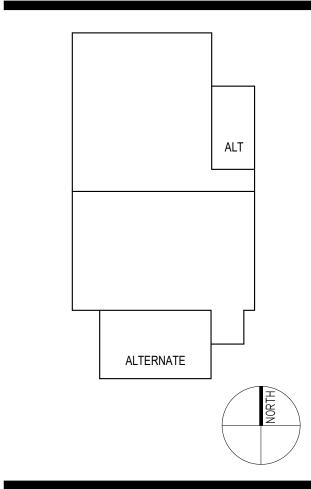
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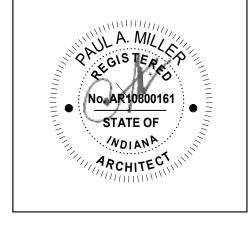




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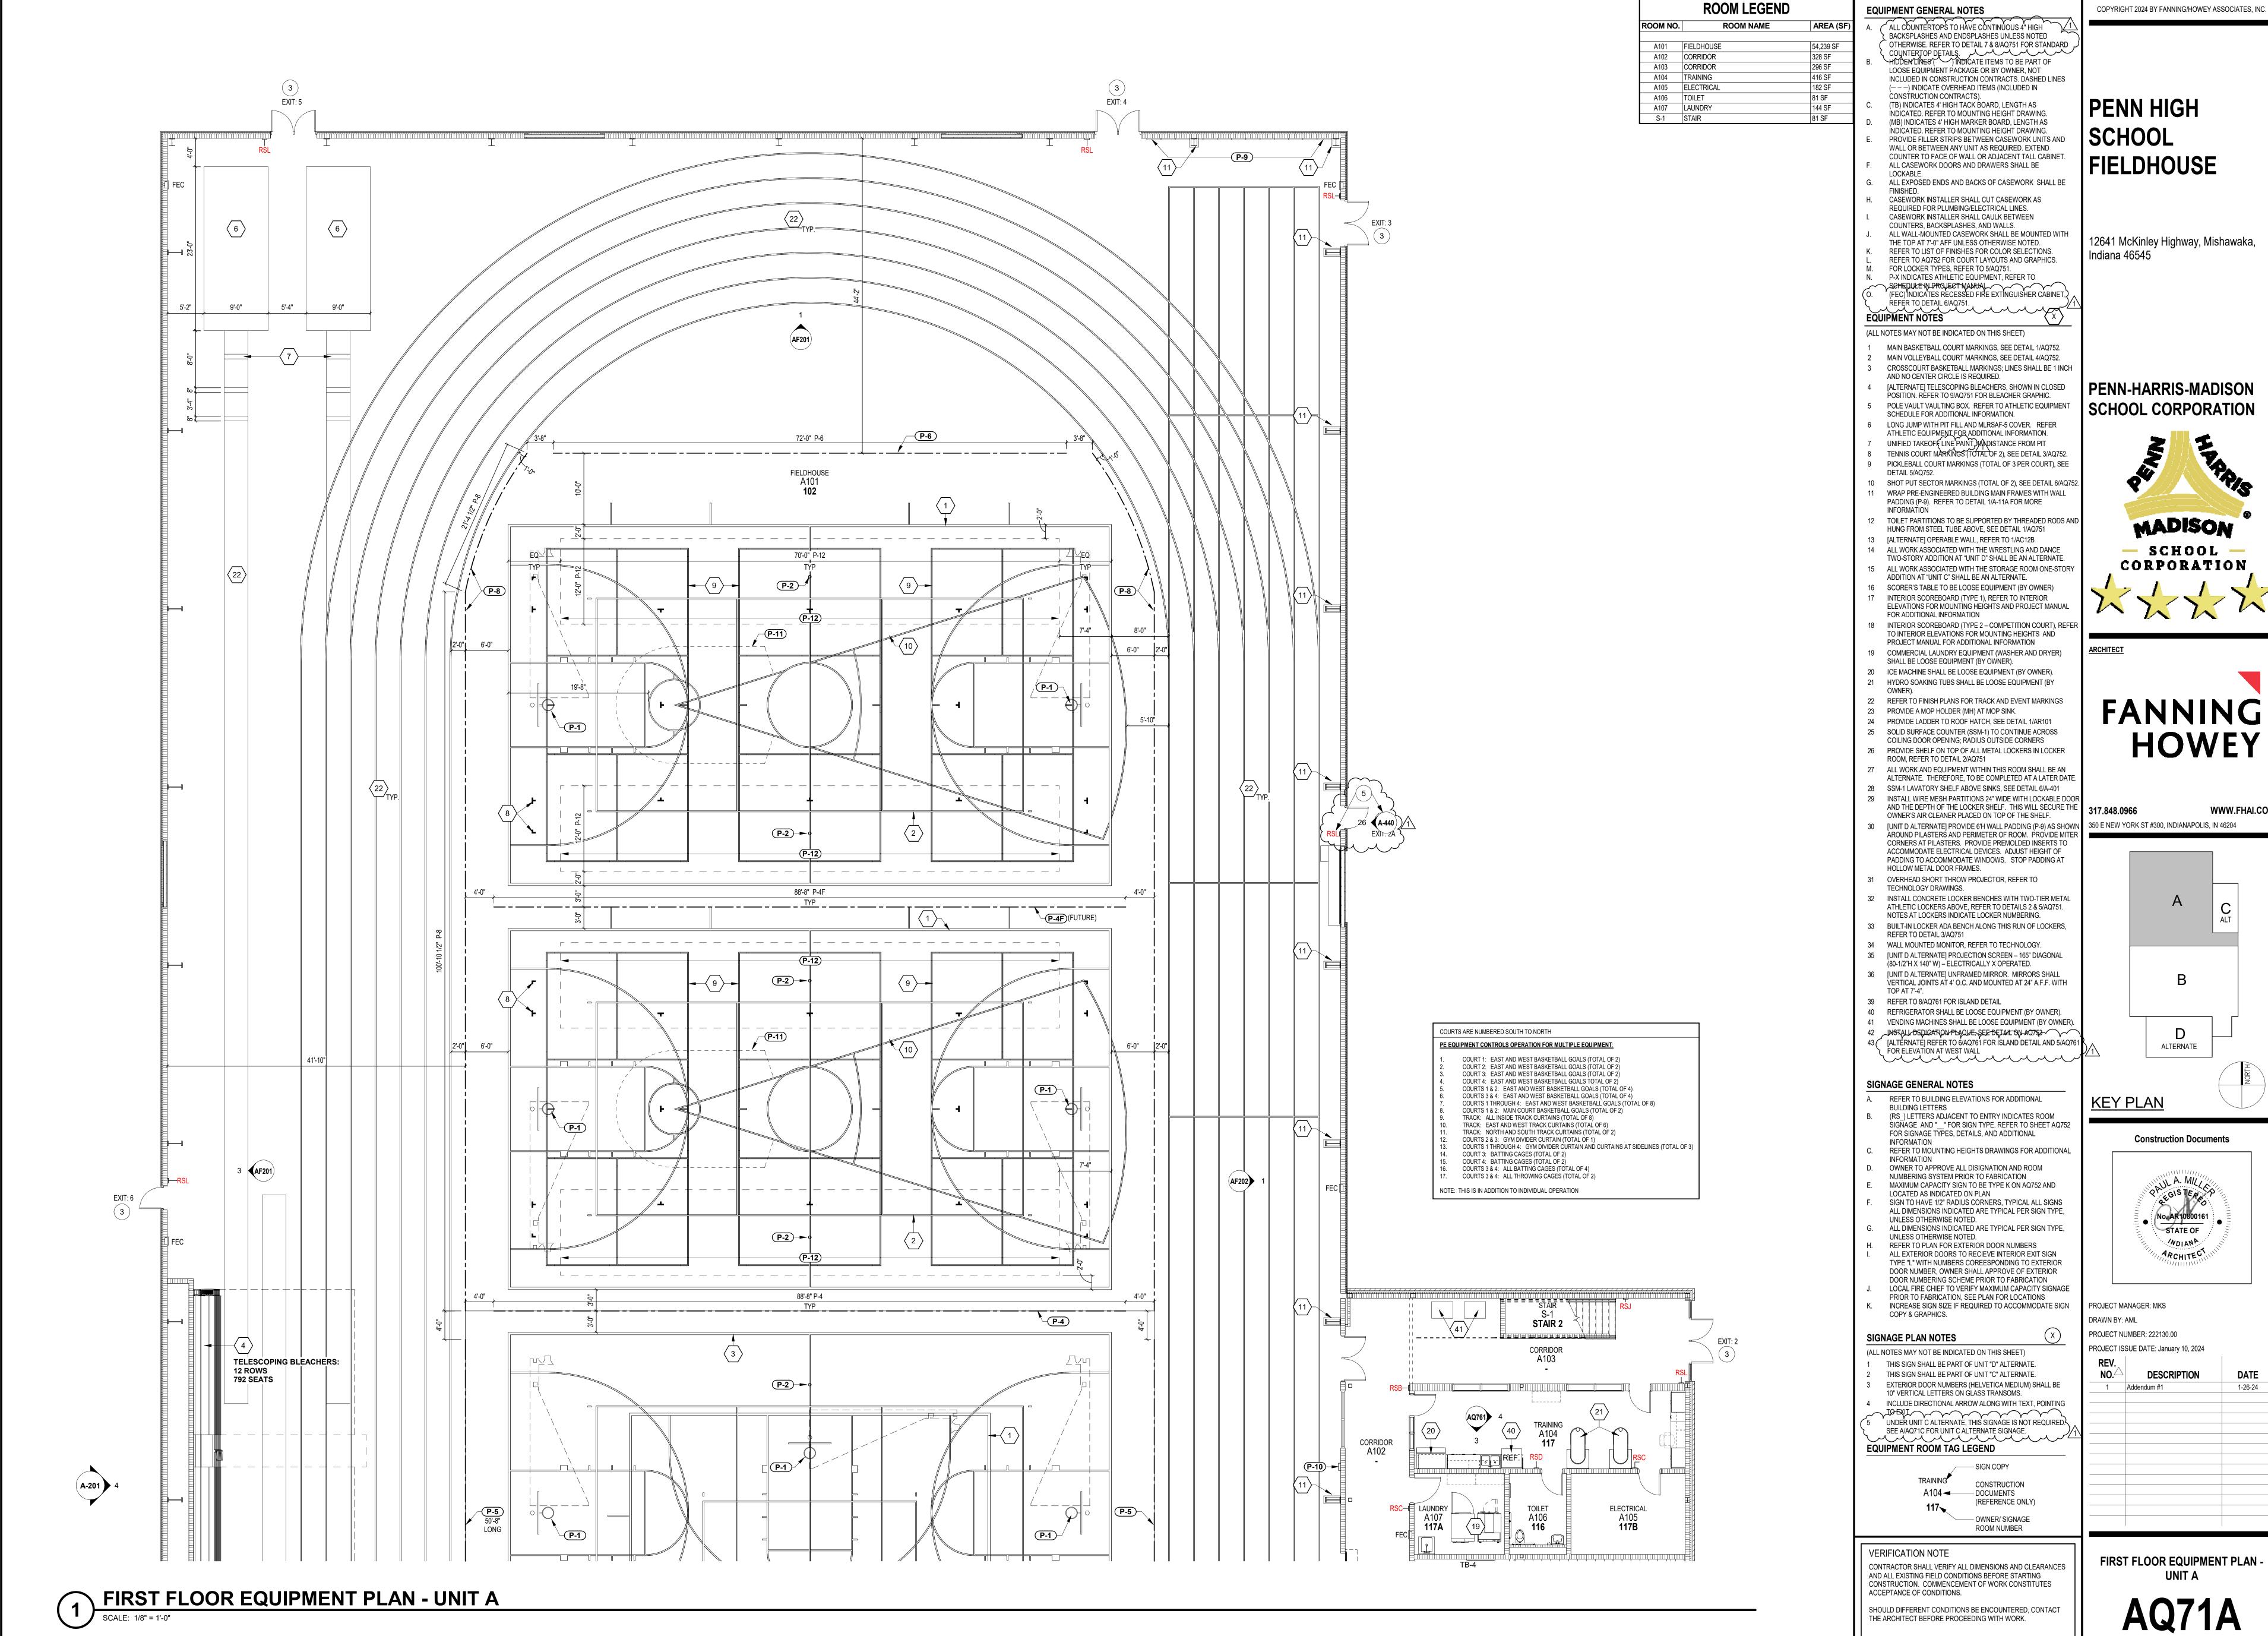
Construction Documents



PROJECT MANAGER: MKS DRAWN BY: AML PROJECT NUMBER: 222130.00 PROJECT ISSUE DATE: January 10, 2024

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1	Addendum #1	1-26-24


LIST OF FINISHES





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1	Addendum #1	1-26-24
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EQUIPMENT GENERAL NOTES

ALL COUNTERTOPS TO HAVE CONTINUOUS 4" HIGH BACKSPLASHES AND ENDSPLASHES UNLESS NOTED OTHERWISE. REFER TO DETAIL 7 & 8/AQ751 FOR STANDARD COUNTERTOP DETAILS.
HIDDEN LINES () INDICATE ITEMS TO BE PART OF LOOSE EQUIPMENT PACKAGE OR BY OWNER, NOT INCLUDED IN CONSTRUCTION CONTRACTS. DASHED LINES

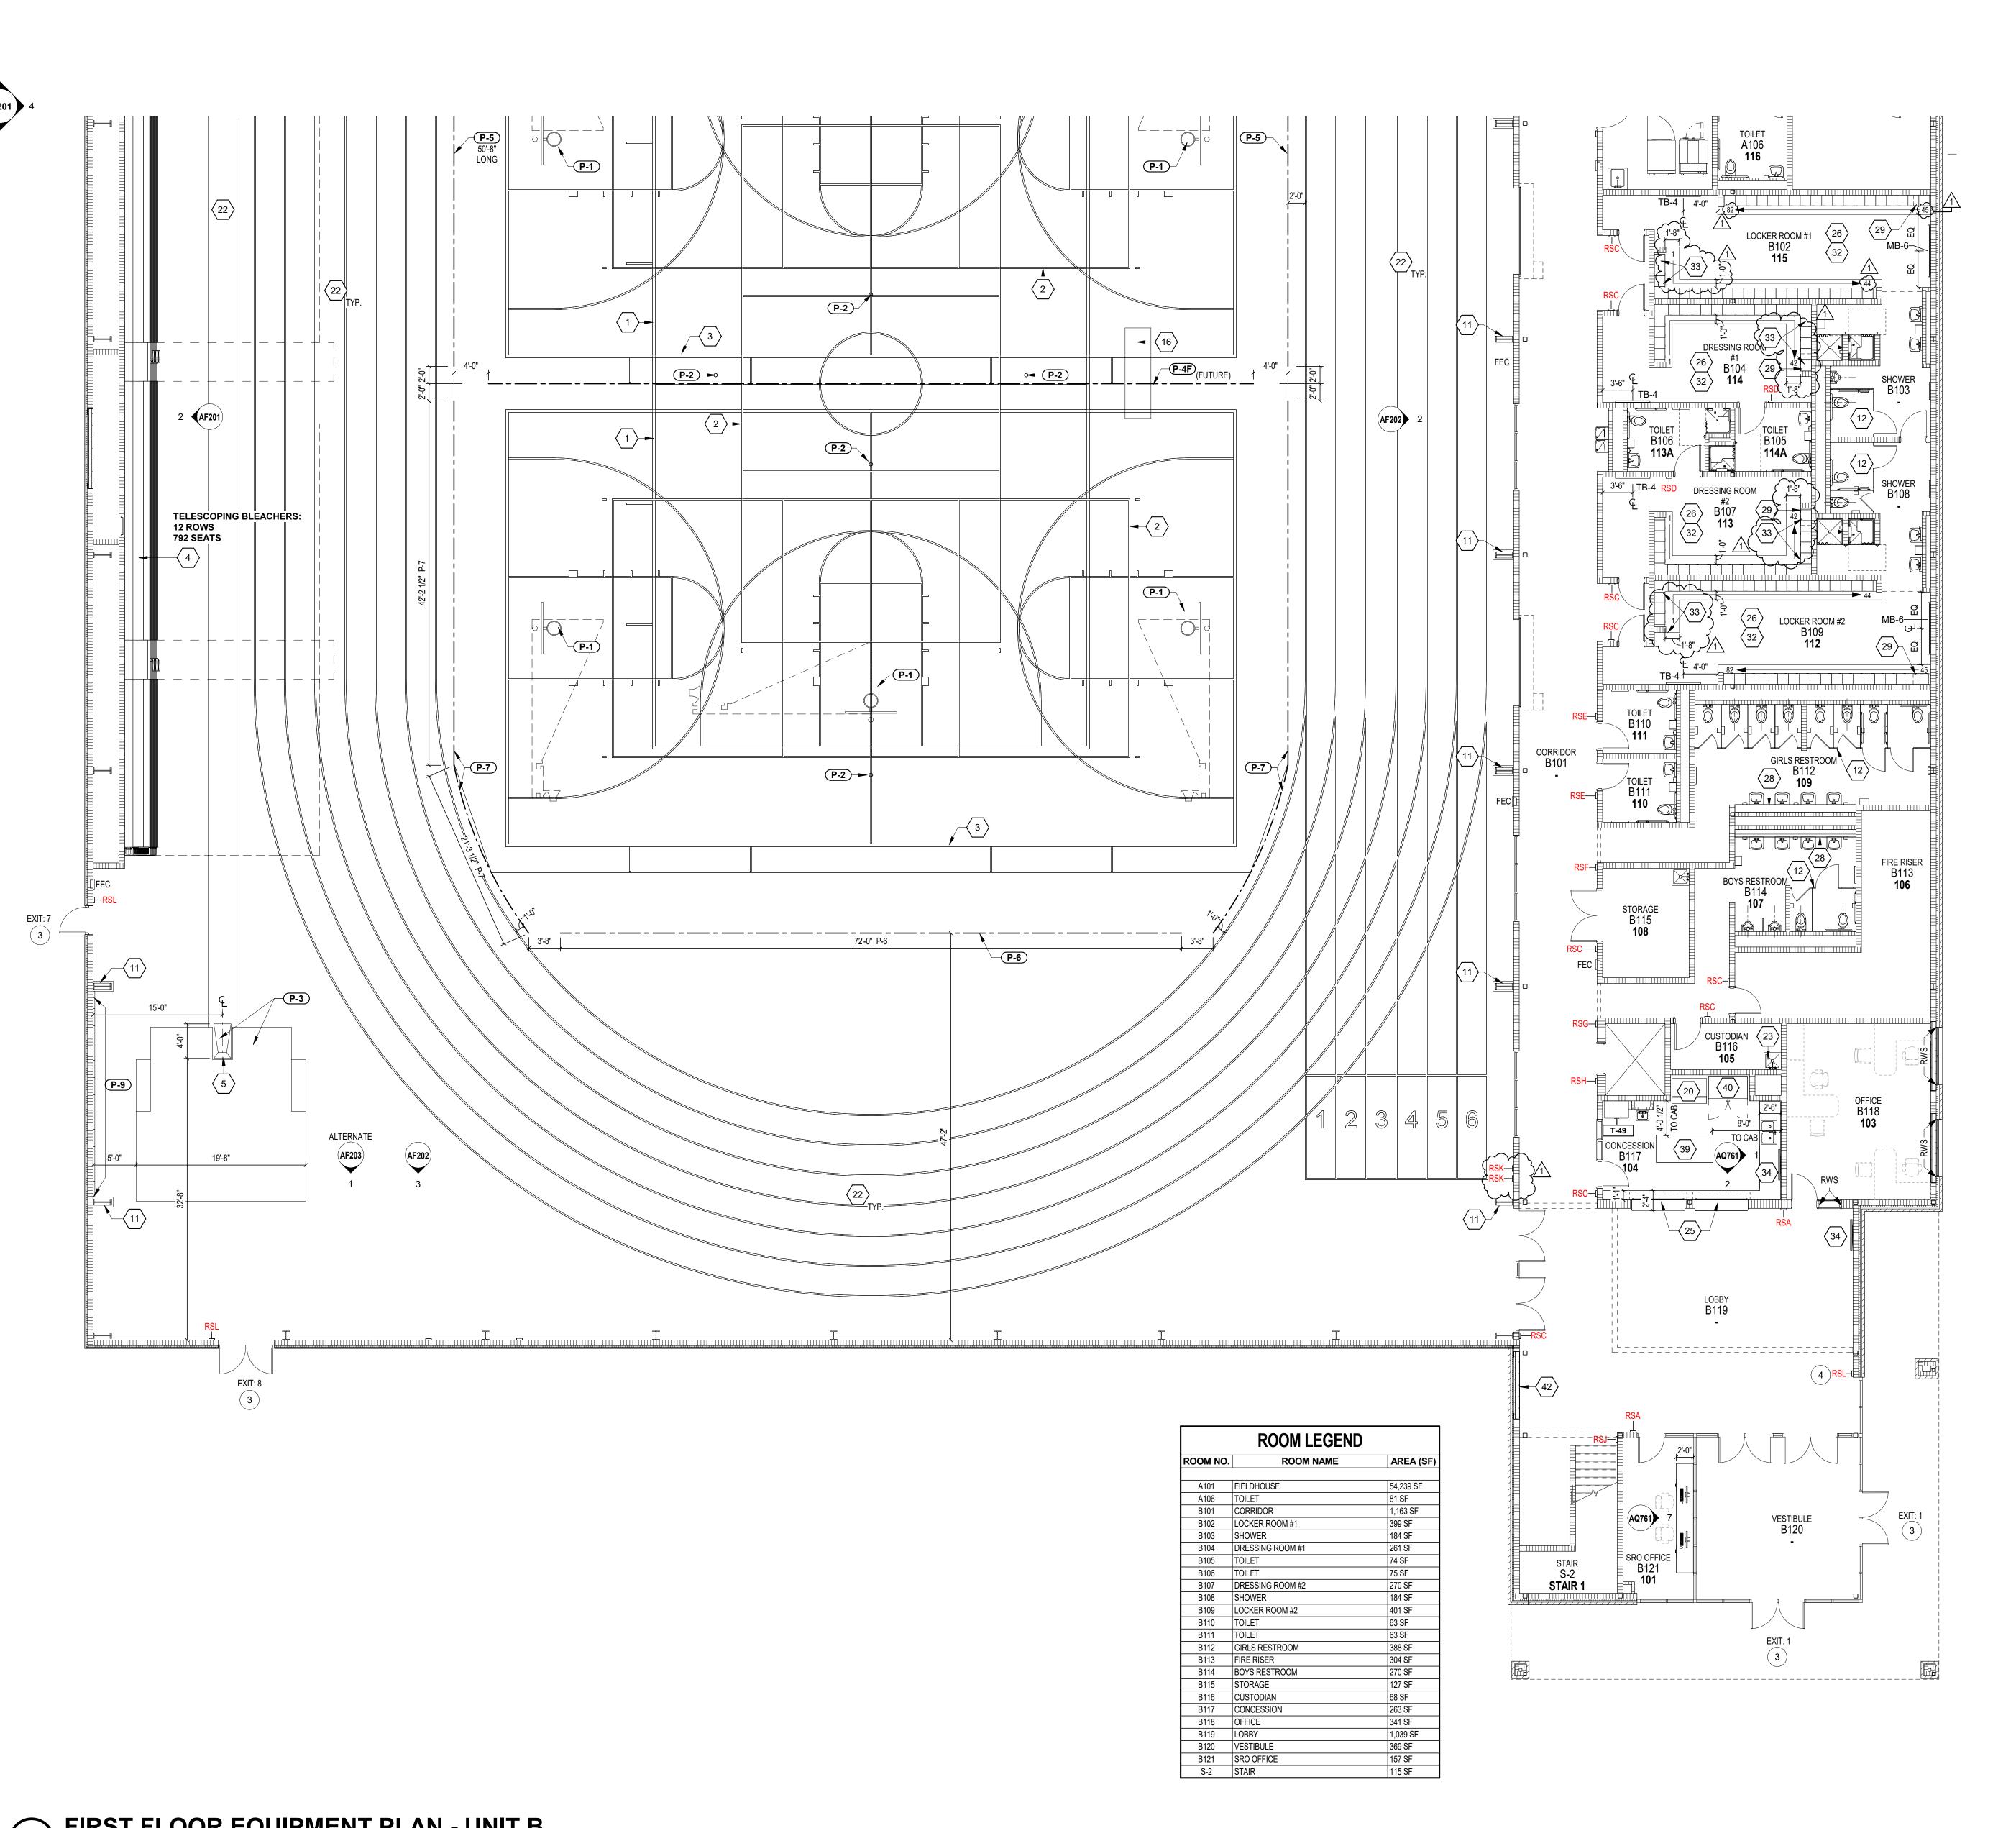(---) INDICATE OVERHEAD ITEMS (INCLUDED IN CONSTRUCTION CONTRACTS). (TB) INDICATES 4' HIGH TACK BOARD, LENGTH AS INDICATED. REFER TO MOUNTING HEIGHT DRAWING.

(MB) INDICATES 4' HIGH MARKER BOARD, LENGTH AS INDICATED. REFER TO MOUNTING HEIGHT DRAWING. PROVIDE FILLER STRIPS BETWEEN CASEWORK UNITS AND WALL OR BETWEEN ANY UNIT AS REQUIRED. EXTEND COUNTER TO FACE OF WALL OR ADJACENT TALL CABINET

ALL CASEWORK DOORS AND DRAWERS SHALL BE LOCKABLE. ALL EXPOSED ENDS AND BACKS OF CASEWORK SHALL BE

CASEWORK INSTALLER SHALL CUT CASEWORK AS REQUIRED FOR PLUMBING/ELECTRICAL LINES. CASEWORK INSTALLER SHALL CAULK BETWEEN

COUNTERS, BACKSPLASHES, AND WALLS. ALL WALL-MOUNTED CASEWORK SHALL BE MOUNTED WITH THE TOP AT 7'-0" AFF UNLESS OTHERWISE NOTED. REFER TO LIST OF FINISHES FOR COLOR SELECTIONS.

REFER TO AQ752 FOR COURT LAYOUTS AND GRAPHICS. FOR LOCKER TYPES, REFER TO 5/AQ751. N. P-X INDICATES ATHLETIC EQUIPMENT, REFER TO O. (FEC) INDICATES RECESSED FIRE EXTINGUISHER CABINET,

REFER TO DETAIL 6/AQ751.

EQUIPMENT NOTES (ALL NOTES MAY NOT BE INDICATED ON THIS SHEET)

MAIN BASKETBALL COURT MARKINGS, SEE DETAIL 1/AQ752. MAIN VOLLEYBALL COURT MARKINGS, SEE DETAIL 4/AQ752. CROSSCOURT BASKETBALL MARKINGS; LINES SHALL BE 1 INCH

AND NO CENTER CIRCLE IS REQUIRED. [ALTERNATE] TELESCOPING BLEACHERS, SHOWN IN CLOSED POSITION. REFER TO 9/AQ751 FOR BLEACHER GRAPHIC. POLE VAULT VAULTING BOX. REFER TO ATHLETIC EQUIPMENT SCHEDULE FOR ADDITIONAL INFORMATION.

LONG JUMP WITH PIT FILL AND MLRSAF-5 COVER. REFER ATHLETIC EQUIPMENT FOR ADDITIONAL INFORMATION.
UNIFIED TAKEOFE LINE PAINT, MADISTANCE FROM PIT 8 TENNIS COURT MARKINGS (TOTAL OF 2), SEE DETAIL 3/AQ752.

PICKLEBALL COURT MARKINGS (TOTAL OF 3 PER COURT), SEE DETAIL 5/AQ752. 10 SHOT PUT SECTOR MARKINGS (TOTAL OF 2), SEE DETAIL 6/AQ75. 11 WRAP PRE-ENGINEERED BUILDING MAIN FRAMES WITH WALL PADDING (P-9). REFER TO DETAIL 1/A-11A FOR MORE

INFORMATION 12 TOILET PARTITIONS TO BE SUPPORTED BY THREADED RODS AND HUNG FROM STEEL TUBE ABOVE, SEE DETAIL 1/AQ751

13 [ALTERNATE] OPERABLE WALL, REFER TO 1/AC12B 14 ALL WORK ASSOCIATED WITH THE WRESTLING AND DANCE TWO-STORY ADDITION AT "UNIT D" SHALL BE AN ALTERNATE.

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ELEVATIONS FOR MOUNTING HEIGHTS AND PROJECT MANUAL

FOR ADDITIONAL INFORMATION 18 INTERIOR SCOREBOARD (TYPE 2 – COMPETITION COURT), REFE TO INTERIOR ELEVATIONS FOR MOUNTING HEIGHTS AND PROJECT MANUAL FOR ADDITIONAL INFORMATION 19 COMMERCIAL LAUNDRY EQUIPMENT (WASHER AND DRYER)

SHALL BE LOOSE EQUIPMENT (BY OWNER). 20 ICE MACHINE SHALL BE LOOSE EQUIPMENT (BY OWNER). 1 HYDRO SOAKING TUBS SHALL BE LOOSE EQUIPMENT (BY 22 REFER TO FINISH PLANS FOR TRACK AND EVENT MARKINGS

23 PROVIDE A MOP HOLDER (MH) AT MOP SINK.

24 PROVIDE LADDER TO ROOF HATCH, SEE DETAIL 1/AR101 25 SOLID SURFACE COUNTER (SSM-1) TO CONTINUE ACROSS COILING DOOR OPENING; RADIUS OUTSIDE CORNERS

26 PROVIDE SHELF ON TOP OF ALL METAL LOCKERS IN LOCKER ROOM, REFER TO DETAIL 2/AQ751 27 ALL WORK AND EQUIPMENT WITHIN THIS ROOM SHALL BE AN

ALTERNATE. THEREFORE, TO BE COMPLETED AT A LATER DATE 28 SSM-1 LAVATORY SHELF ABOVE SINKS, SEE DETAIL 6/A-401 29 INSTALL WIRE MESH PARTITIONS 24" WIDE WITH LOCKABLE DOC AND THE DEPTH OF THE LOCKER SHELF. THIS WILL SECURE THE

OWNER'S AIR CLEANER PLACED ON TOP OF THE SHELF. 30 [UNIT D ALTERNATE] PROVIDE 6'H WALL PADDING (P-9) AS SHOWN 350 E NEW YORK ST #300, INDIANAPOLIS, IN 46204 AROUND PILASTERS AND PERIMETER OF ROOM. PROVIDE MITER CORNERS AT PILASTERS. PROVIDE PREMOLDED INSERTS TO ACCOMMODATE ELECTRICAL DEVICES. ADJUST HEIGHT OF PADDING TO ACCOMMODATE WINDOWS. STOP PADDING AT HOLLOW METAL DOOR FRAMES.

31 OVERHEAD SHORT THROW PROJECTOR, REFER TO TECHNOLOGY DRAWINGS. 32 INSTALL CONCRETE LOCKER BENCHES WITH TWO-TIER METAL

ATHLETIC LOCKERS ABOVE, REFER TO DETAILS 2 & 5/AQ751. NOTES AT LOCKERS INDICATE LOCKER NUMBERING. 33 BUILT-IN LOCKER ADA BENCH ALONG THIS RUN OF LOCKERS, REFER TO DETAIL 3/AQ751

34 WALL MOUNTED MONITOR, REFER TO TECHNOLOGY. 35 [UNIT D ALTERNATE] PROJECTION SCREEN – 165" DIAGONAL (80-1/2"H X 140" W) – ELECTRICALLY X OPERATED. 36 [UNIT D ALTERNATE] UNFRAMED MIRROR. MIRRORS SHALL

VERTICAL JOINTS AT 4' O.C. AND MOUNTED AT 24" A.F.F. WITH TOP AT 7'-4". 39 REFER TO 8/AQ761 FOR ISLAND DETAIL

40 REFRIGERATOR SHALL BE LOOSE EQUIPMENT (BY OWNER). 41 VENDING MACHINES SHALL BE LOOSE EQUIPMENT (BY OWNER)

42 INSTALL DEDICATION PLAQUE, SEE DETAIL ON A0753-43 [ALTERNATE] REFER TO 6/AQ761 FOR ISLAND DETAIL AND 5/AQ761 FOR ELEVATION AT WEST WALL

SIGNAGE GENERAL NOTES

REFER TO BUILDING ELEVATIONS FOR ADDITIONAL **BUILDING LETTERS** (RS) LETTERS ADJACENT TO ENTRY INDICATES ROOM SIGNAGE AND "__" FOR SIGN TYPE. REFER TO SHEET AQ752

FOR SIGNAGE TYPES, DETAILS, AND ADDITIONAL INFORMATION REFER TO MOUNTING HEIGHTS DRAWINGS FOR ADDITIONAL INFORMATION

OWNER TO APPROVE ALL DISIGNATION AND ROOM NUMBERING SYSTEM PRIOR TO FABRICATION MAXIMUM CAPACITY SIGN TO BE TYPE K ON AQ752 AND LOCATED AS INDICATED ON PLAN SIGN TO HAVE 1/2" RADIUS CORNERS, TYPICAL ALL SIGNS ALL DIMENSIONS INDICATED ARE TYPICAL PER SIGN TYPE, UNLESS OTHERWISE NOTED. ALL DIMENSIONS INDICATED ARE TYPICAL PER SIGN TYPE, UNLESS OTHERWISE NOTED. REFER TO PLAN FOR EXTERIOR DOOR NUMBERS

ALL EXTERIOR DOORS TO RECIEVE INTERIOR EXIT SIGN TYPE "L" WITH NUMBERS COREESPONDING TO EXTERIOR DOOR NUMBER, OWNER SHALL APPROVE OF EXTERIOR DOOR NUMBERING SCHEME PRIOR TO FABRICATION LOCAL FIRE CHIEF TO VERIFY MAXIMUM CAPACITY SIGNAGE PRIOR TO FABRICATION. SEE PLAN FOR LOCATIONS INCREASE SIGN SIZE IF REQUIRED TO ACCOMMODATE SIGN COPY & GRAPHICS.

SIGNAGE PLAN NOTES

(ALL NOTES MAY NOT BE INDICATED ON THIS SHEET) THIS SIGN SHALL BE PART OF UNIT "D" ALTERNATE

THIS SIGN SHALL BE PART OF UNIT "C" ALTERNATE. EXTERIOR DOOR NUMBERS (HELVETICA MEDIUM) SHALL BE 10" VERTICAL LETTERS ON GLASS TRANSOMS. INCLUDE DIRECTIONAL ARROW ALONG WITH TEXT, POINTING 5 UNDER UNIT C ALTERNATE, THIS SIGNAGE IS NOT REQUIRED.

SEE A/AQ71C FOR UNIT C ALTERNATE SIGNAGE.

EQUIPMENT ROOM TAG LEGEND

CONSTRUCTION A104**⊸** — DOCUMENTS (REFERENCE ONLY) - OWNER/ SIGNAGE **ROOM NUMBER**

VERIFICATION NOTE

CONTRACTOR SHALL VERIFY ALL DIMENSIONS AND CLEARANCES AND ALL EXISTING FIELD CONDITIONS BEFORE STARTING CONSTRUCTION. COMMENCEMENT OF WORK CONSTITUTES ACCEPTANCE OF CONDITIONS.

SHOULD DIFFERENT CONDITIONS BE ENCOUNTERED, CONTACT THE ARCHITECT BEFORE PROCEEDING WITH WORK.

PENN HIGH SCHOOL FIELDHOUSE

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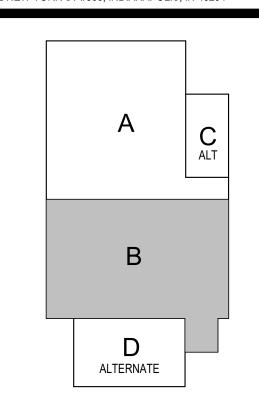
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KEY PLAN

Construction Documents




PROJECT MANAGER: MKS DRAWN BY: AML

PROJECT NUMBER: 222130.00 PROJECT ISSUE DATE: January 10, 2024

1 Addendum #1	DATE
	1-26-2
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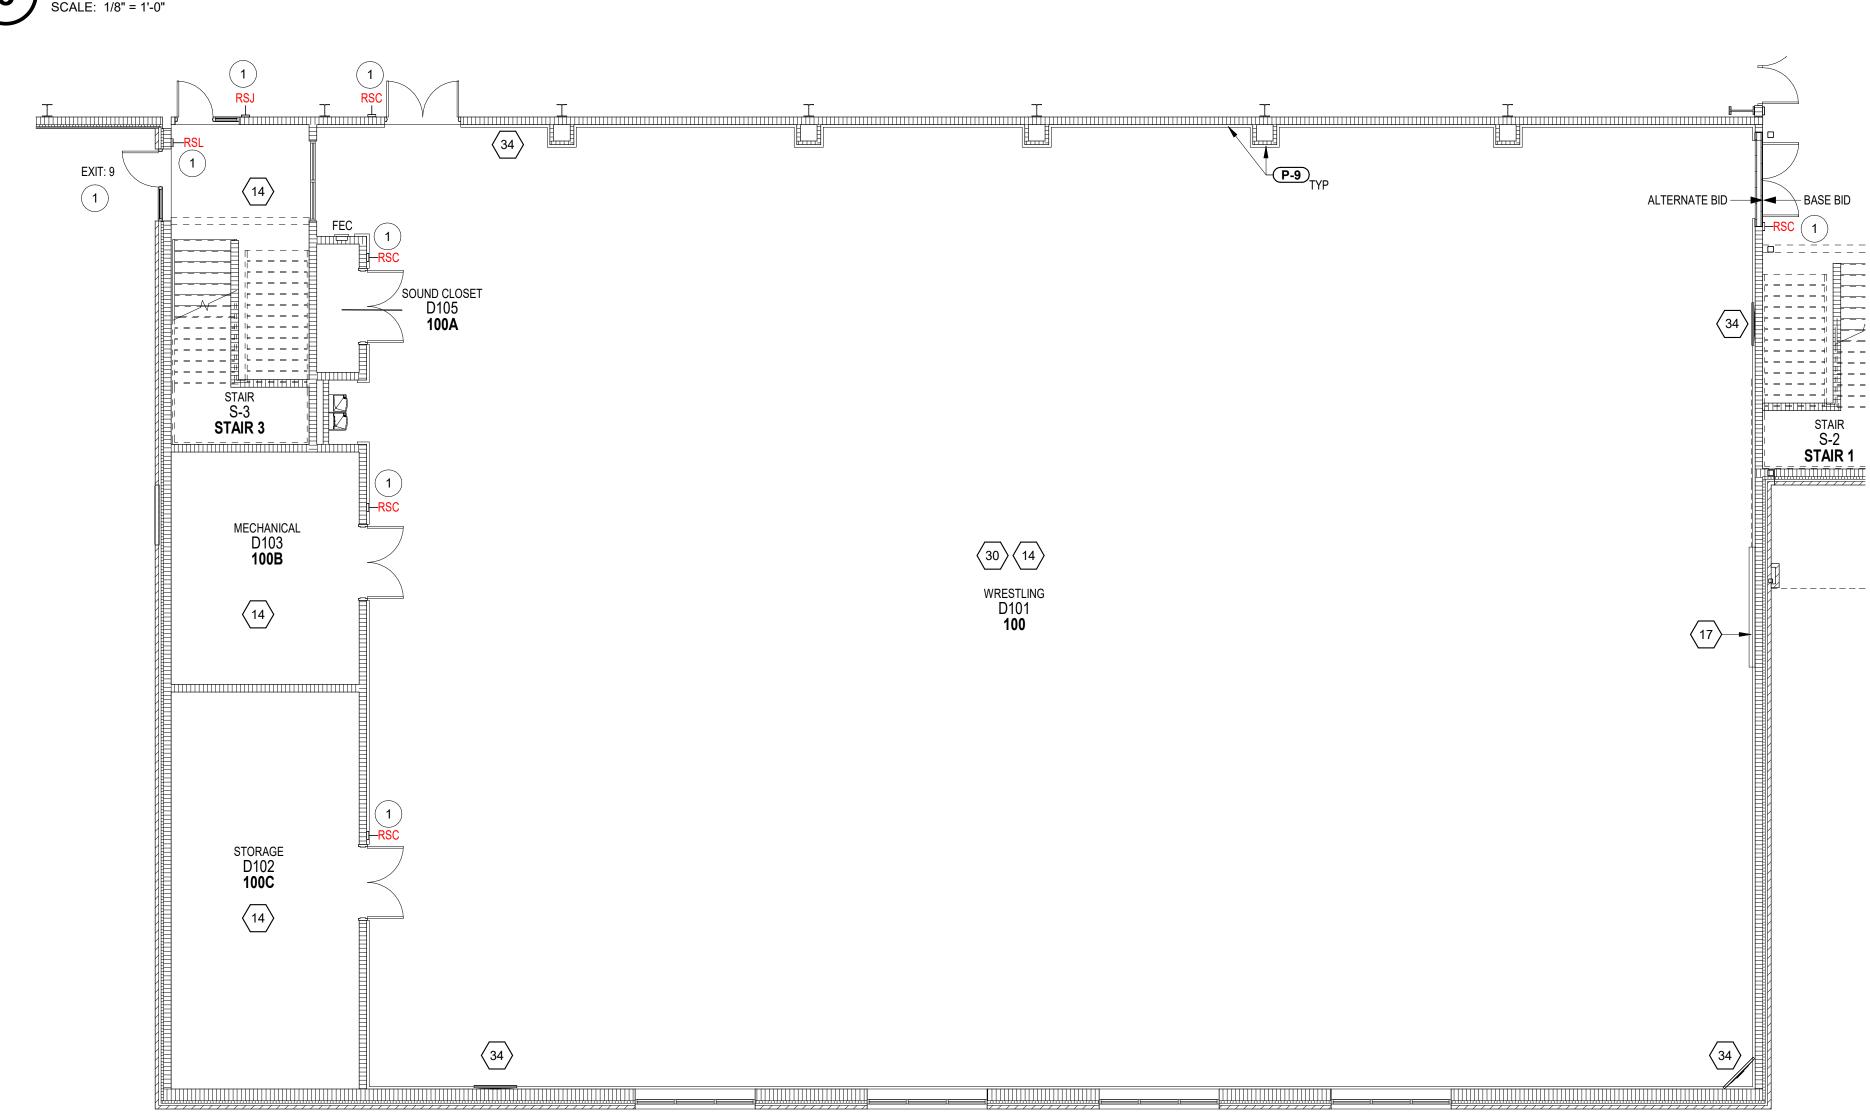
FIRST FLOOR EQUIPMENT PLAN -**UNIT B**

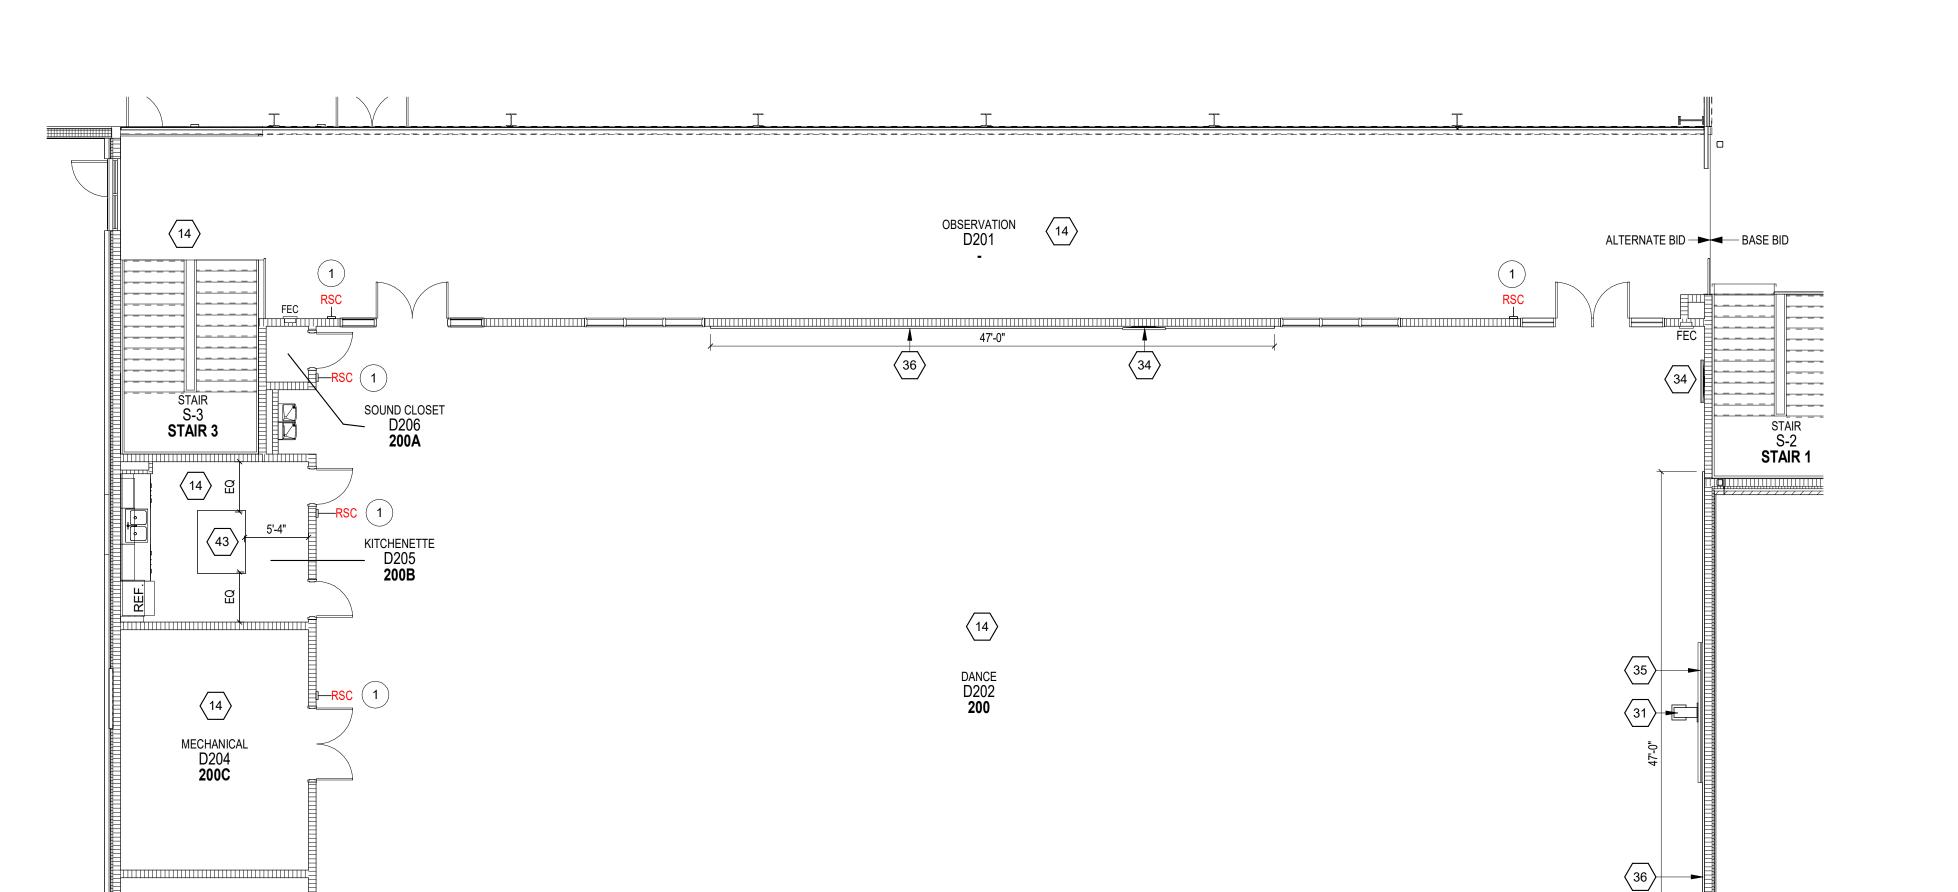

SECOND FLOOR EQUIPMENT PLAN ALTERNATES - UNIT D


SCALE: 1/8" = 1'-0"


STORAGE D203 **200D**



FIRST FLOOR EQUIPMENT PLAN ALTERNATE - UNIT D

SCALE: 1/8" = 1'-0"

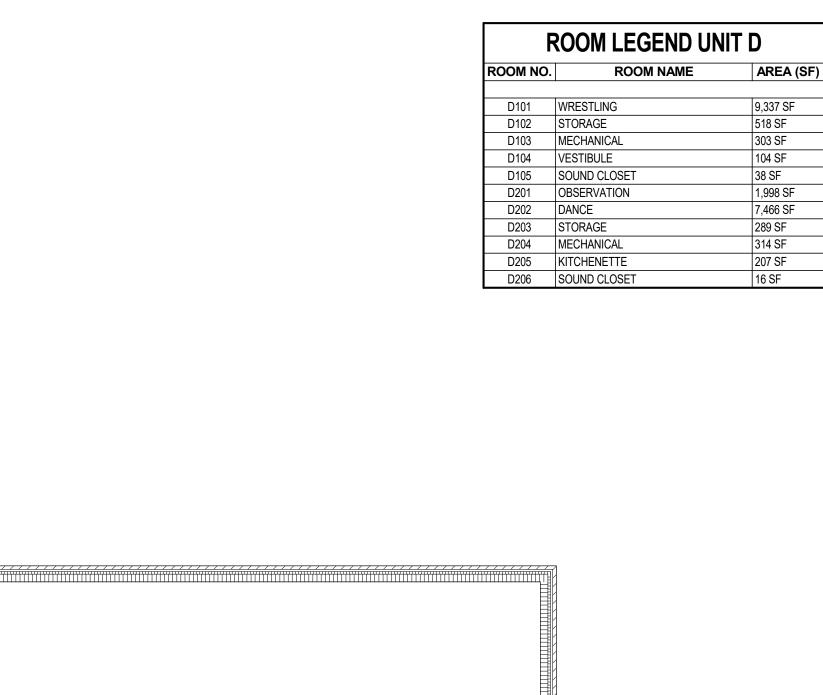

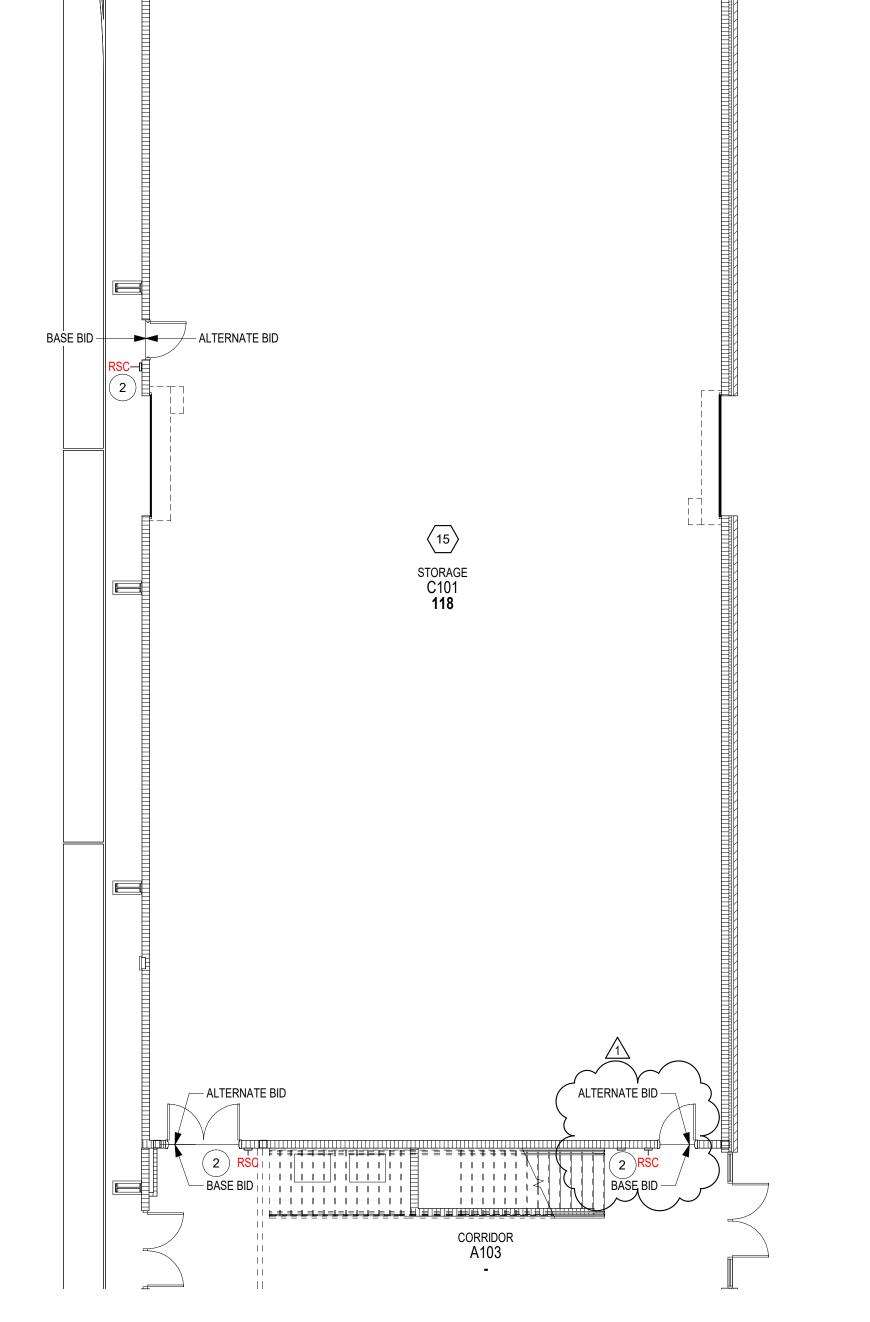

FIRST FLOOR EQUIPMENT PLAN ALTERNATE - UNIT C

SCALE: 1/8" = 1'-0"

EQUIPMENT GENERAL NOTES

ROOM LEGEND UNIT C ALL COUNTERTOPS TO HAVE CONTINUOUS 4" HIGH ROOM NAME BACKSPLASHES AND ENDSPLASHES UNLESS NOTED OTHERWISE. REFER TO DETAIL 7 & 8/AQ751 FOR STANDARD C101 STORAGE 4,561 SF COUNTERTOP DETAILS. HIDDEN'LINES () INDICATE ITEMS TO BE PART OF

> INDICATED. REFER TO MOUNTING HEIGHT DRAWING. (MB) INDICATES 4' HIGH MARKER BOARD, LENGTH AS INDICATED, REFER TO MOUNTING HEIGHT DRAWING. PROVIDE FILLER STRIPS BETWEEN CASEWORK UNITS AND WALL OR BETWEEN ANY UNIT AS REQUIRED. EXTEND COUNTER TO FACE OF WALL OR ADJACENT TALL CABINET ALL CASEWORK DOORS AND DRAWERS SHALL BE LOCKABLE.

CONSTRUCTION CONTRACTS).

ALL EXPOSED ENDS AND BACKS OF CASEWORK SHALL BE CASEWORK INSTALLER SHALL CUT CASEWORK AS REQUIRED FOR PLUMBING/ELECTRICAL LINES. CASEWORK INSTALLER SHALL CAULK BETWEEN

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(TB) INDICATES 4' HIGH TACK BOARD, LENGTH AS

INCLUDED IN CONSTRUCTION CONTRACTS. DASHED LINES (---) INDICATE OVERHEAD ITEMS (INCLUDED IN

COUNTERS, BACKSPLASHES, AND WALLS. ALL WALL-MOUNTED CASEWORK SHALL BE MOUNTED WITH THE TOP AT 7'-0" AFF UNLESS OTHERWISE NOTED. REFER TO LIST OF FINISHES FOR COLOR SELECTIONS. REFER TO AQ752 FOR COURT LAYOUTS AND GRAPHICS.

FOR LOCKER TYPES, REFER TO 5/AQ751. N. P-X INDICATES ATHLETIC EQUIPMENT, REFER TO O. (FEC) INDICATES RECESSED FIRE EXTINGUISHER CABINET, REFER TO DETAIL 6/AQ751.

EQUIPMENT NOTES (ALL NOTES MAY NOT BE INDICATED ON THIS SHEET)

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POSITION. REFER TO 9/AQ751 FOR BLEACHER GRAPHIC.

TENNIS COURT MARKINGS (TOTAL OF 2), SEE DETAIL 3/AQ752. PICKLEBALL COURT MARKINGS (TOTAL OF 3 PER COURT), SEE DETAIL 5/AQ752. 10 SHOT PUT SECTOR MARKINGS (TOTAL OF 2), SEE DETAIL 6/AQ75

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26 PROVIDE SHELF ON TOP OF ALL METAL LOCKERS IN LOCKER ROOM, REFER TO DETAIL 2/AQ751 27 ALL WORK AND EQUIPMENT WITHIN THIS ROOM SHALL BE AN ALTERNATE. THEREFORE, TO BE COMPLETED AT A LATER DATE 28 SSM-1 LAVATORY SHELF ABOVE SINKS, SEE DETAIL 6/A-401

29 INSTALL WIRE MESH PARTITIONS 24" WIDE WITH LOCKABLE DOOR AND THE DEPTH OF THE LOCKER SHELF. THIS WILL SECURE THE 317.848.0966 OWNER'S AIR CLEANER PLACED ON TOP OF THE SHELF. 30 [UNIT D ALTERNATE] PROVIDE 6'H WALL PADDING (P-9) AS SHOWN AROUND PILASTERS AND PERIMETER OF ROOM. PROVIDE MITER CORNERS AT PILASTERS. PROVIDE PREMOLDED INSERTS TO

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32 INSTALL CONCRETE LOCKER BENCHES WITH TWO-TIER METAL ATHLETIC LOCKERS ABOVE, REFER TO DETAILS 2 & 5/AQ751. NOTES AT LOCKERS INDICATE LOCKER NUMBERING. 33 BUILT-IN LOCKER ADA BENCH ALONG THIS RUN OF LOCKERS, REFER TO DETAIL 3/AQ751

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SIGNAGE GENERAL NOTES

FOR ELEVATION AT WEST WALL

REFER TO BUILDING ELEVATIONS FOR ADDITIONAL **BUILDING LETTERS** (RS) LETTERS ADJACENT TO ENTRY INDICATES ROOM SIGNAGE AND "__" FOR SIGN TYPE. REFER TO SHEET AQ752 FOR SIGNAGE TYPES, DETAILS, AND ADDITIONAL

REFER TO MOUNTING HEIGHTS DRAWINGS FOR ADDITIONAL INFORMATION OWNER TO APPROVE ALL DISIGNATION AND ROOM

NUMBERING SYSTEM PRIOR TO FABRICATION MAXIMUM CAPACITY SIGN TO BE TYPE K ON AQ752 AND LOCATED AS INDICATED ON PLAN SIGN TO HAVE 1/2" RADIUS CORNERS, TYPICAL ALL SIGNS ALL DIMENSIONS INDICATED ARE TYPICAL PER SIGN TYPE,

UNLESS OTHERWISE NOTED. ALL DIMENSIONS INDICATED ARE TYPICAL PER SIGN TYPE, UNLESS OTHERWISE NOTED. REFER TO PLAN FOR EXTERIOR DOOR NUMBERS ALL EXTERIOR DOORS TO RECIEVE INTERIOR EXIT SIGN TYPE "L" WITH NUMBERS COREESPONDING TO EXTERIOR

DOOR NUMBER, OWNER SHALL APPROVE OF EXTERIOR DOOR NUMBERING SCHEME PRIOR TO FABRICATION LOCAL FIRE CHIEF TO VERIFY MAXIMUM CAPACITY SIGNAGE PRIOR TO FABRICATION. SEE PLAN FOR LOCATIONS INCREASE SIGN SIZE IF REQUIRED TO ACCOMMODATE SIGN COPY & GRAPHICS.

SIGNAGE PLAN NOTES

(ALL NOTES MAY NOT BE INDICATED ON THIS SHEET) THIS SIGN SHALL BE PART OF UNIT "D" ALTERNATE. THIS SIGN SHALL BE PART OF UNIT "C" ALTERNATE. 3 EXTERIOR DOOR NUMBERS (HELVETICA MEDIUM) SHALL BE 10" VERTICAL LETTERS ON GLASS TRANSOMS.

4 INCLUDE DIRECTIONAL ARROW ALONG WITH TEXT, POINTING 5 UNDER UNIT C ALTERNATE, THIS SIGNAGE IS NOT REQUIRED! SEE A/AQ71C FOR UNIT C ALTERNATE SIGNAGE. EQUIPMENT ROOM TAG LEGEND

A104 ─ DOCUMENTS (REFERENCE ONLY) - OWNER/ SIGNAGE **ROOM NUMBER**

VERIFICATION NOTE

CONTRACTOR SHALL VERIFY ALL DIMENSIONS AND CLEARANCES AND ALL EXISTING FIELD CONDITIONS BEFORE STARTING CONSTRUCTION. COMMENCEMENT OF WORK CONSTITUTES ACCEPTANCE OF CONDITIONS.

SHOULD DIFFERENT CONDITIONS BE ENCOUNTERED, CONTACT THE ARCHITECT BEFORE PROCEEDING WITH WORK.

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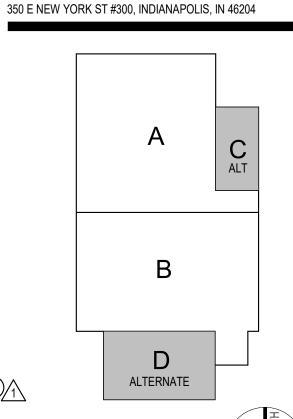
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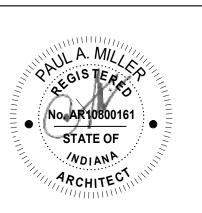
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KEY PLAN


Construction Documents



PROJECT MANAGER: MKS DRAWN BY: AML PROJECT NUMBER: 222130.00

PROJECT ISSUE DATE: January 10, 2024 NO. DESCRIPTION

EQUIPMENT PLANS - ALTERNATES

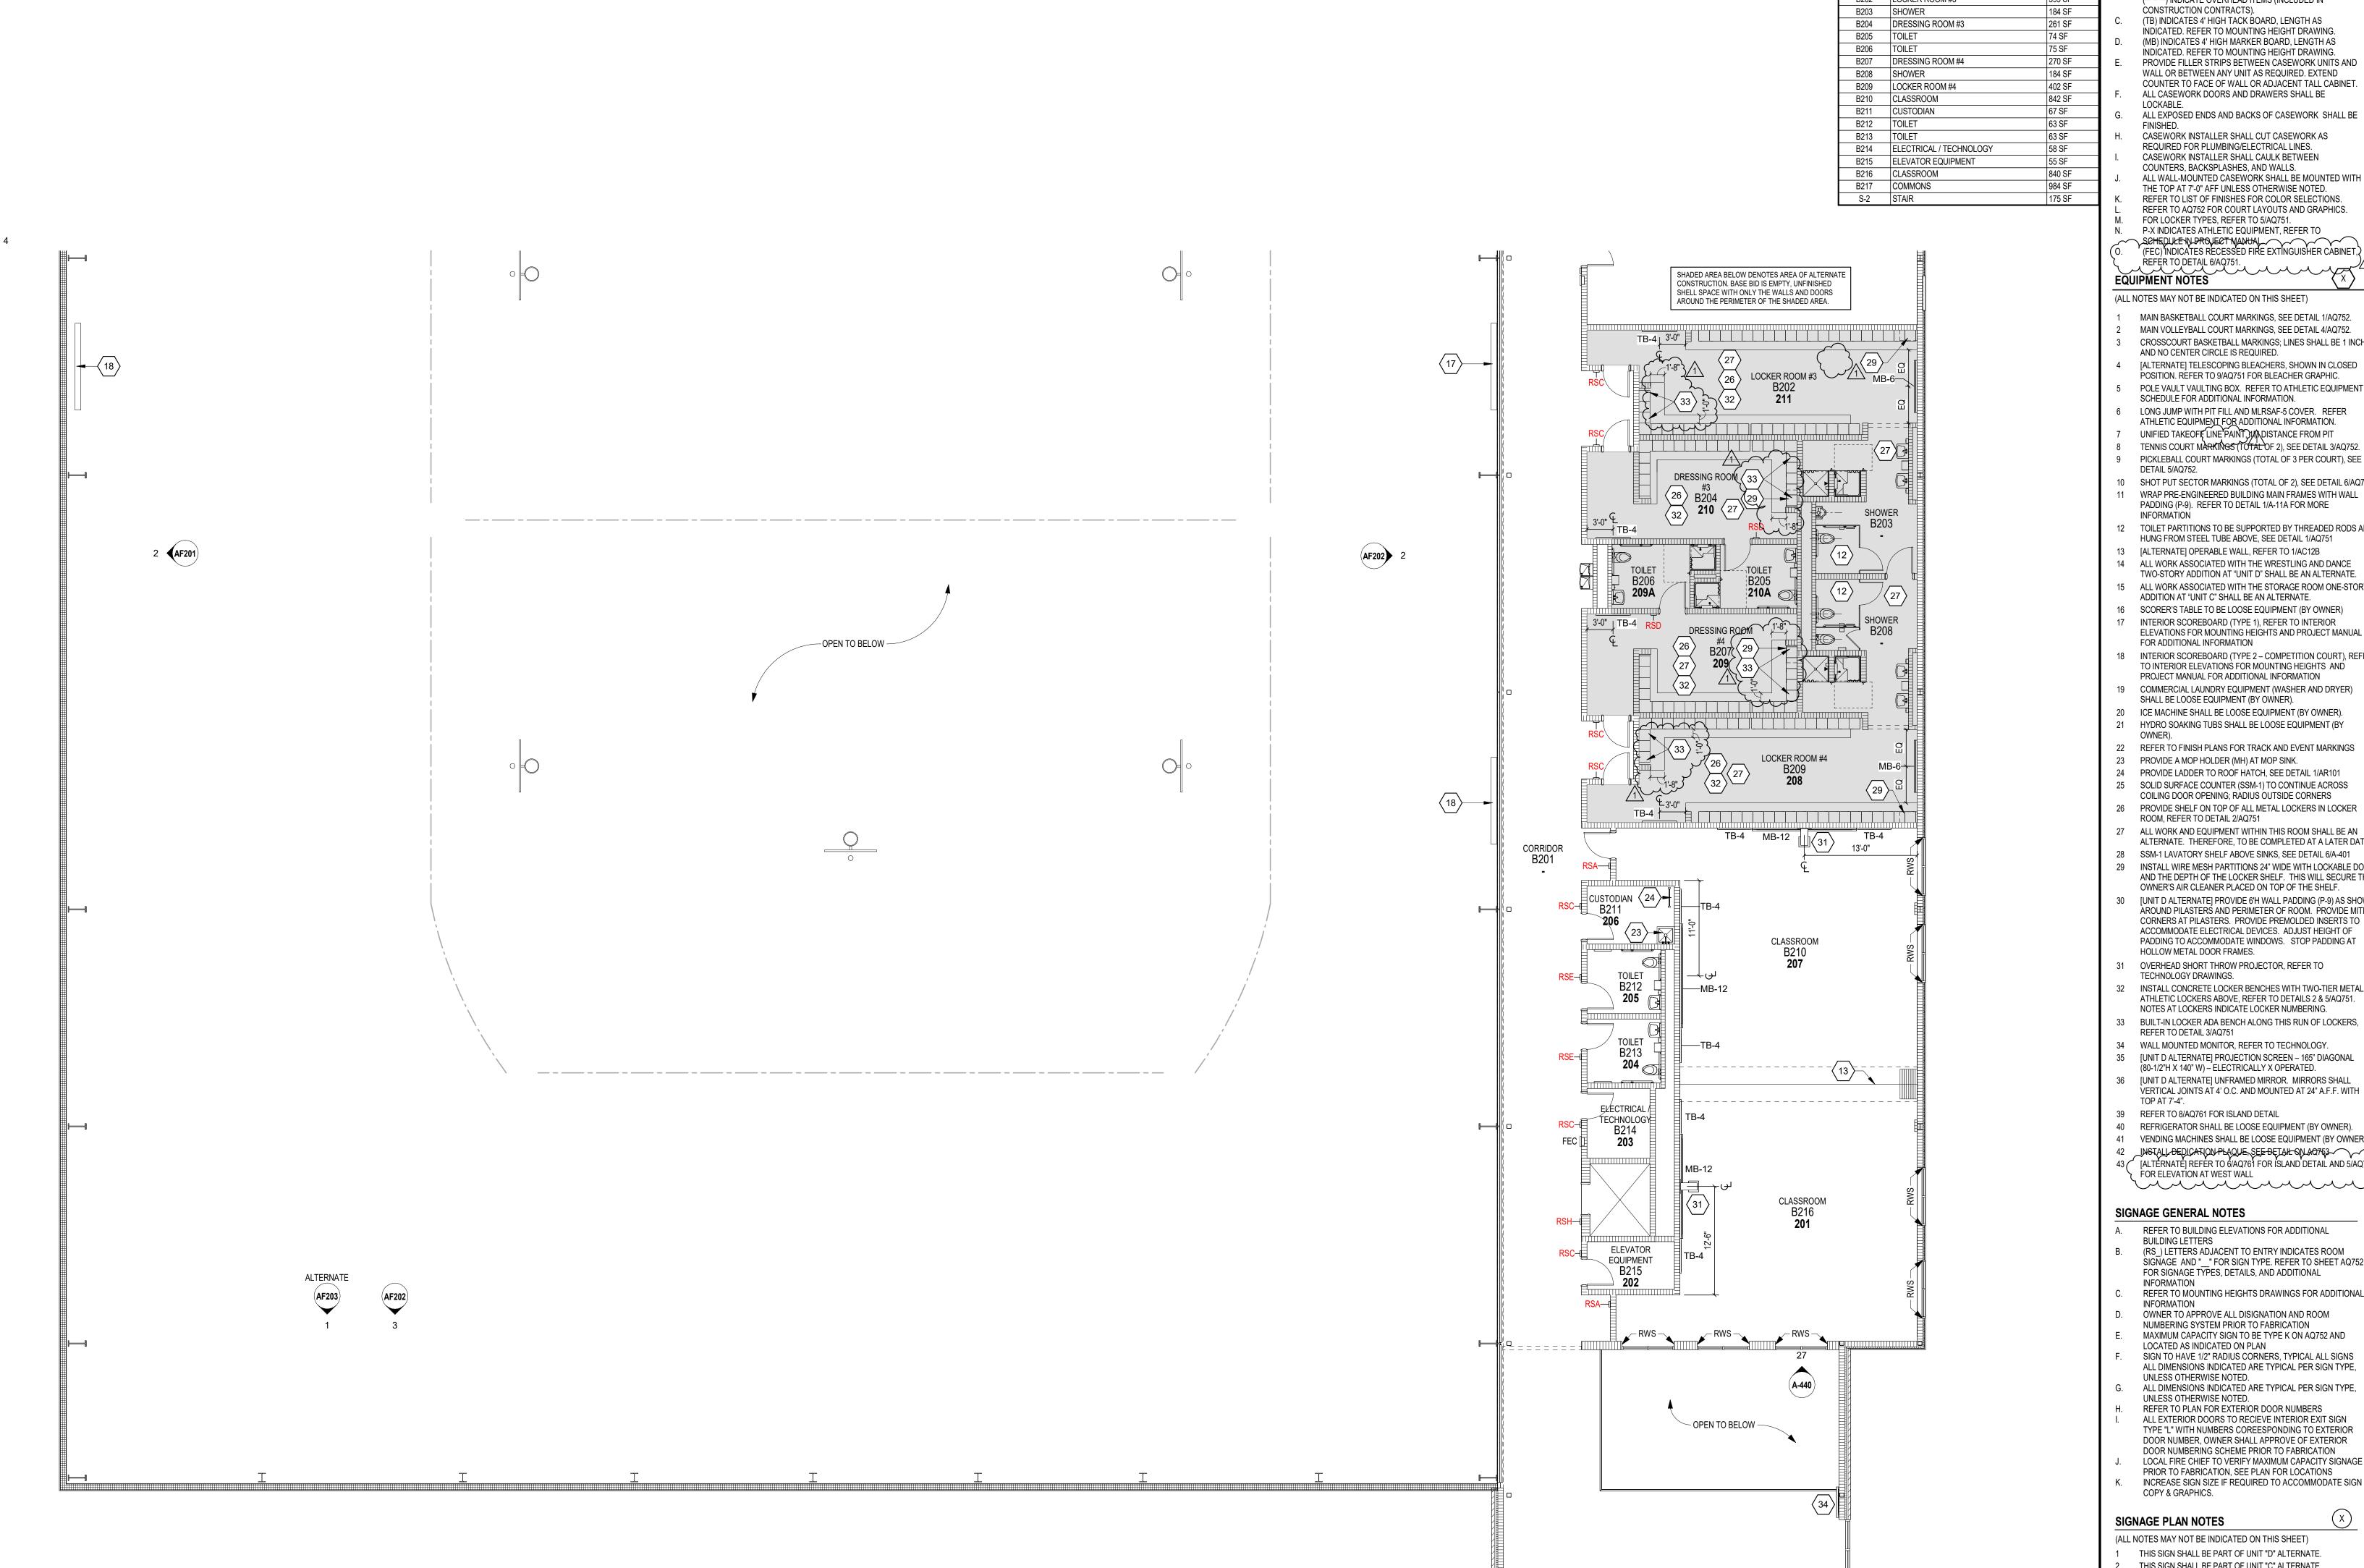

EQUIPMENT GENERAL NOTES

ROOM LEGEND

ROOM NAME

ROOM NO.

A101 | FIELDHOUSE

A201 CORRIDOR A202 MECHANICAL

CORRIDOR

B202 LOCKER ROOM #3

ALL COUNTERTOPS TO HAVE CONTINUOUS 4" HIGH AREA (SF BACKSPLASHES AND ENDSPLASHES UNLESS NOTED OTHERWISE. REFER TO DETAIL 7 & 8/AQ751 FOR STANDARD COUNTERTOP DETAILS. HIDDEN'LINES () INDICATE ITEMS TO BE PART OF LOOSE EQUIPMENT PACKAGE OR BY OWNER, NOT INCLUDED IN CONSTRUCTION CONTRACTS. DASHED LINES

(---) INDICATE OVERHEAD ITEMS (INCLUDED IN CONSTRUCTION CONTRACTS). (TB) INDICATES 4' HIGH TACK BOARD, LENGTH AS INDICATED. REFER TO MOUNTING HEIGHT DRAWING. (MB) INDICATES 4' HIGH MARKER BOARD, LENGTH AS INDICATED. REFER TO MOUNTING HEIGHT DRAWING. WALL OR BETWEEN ANY UNIT AS REQUIRED. EXTEND

PROVIDE FILLER STRIPS BETWEEN CASEWORK UNITS AND COUNTER TO FACE OF WALL OR ADJACENT TALL CABINET ALL CASEWORK DOORS AND DRAWERS SHALL BE LOCKABLE.

ALL EXPOSED ENDS AND BACKS OF CASEWORK SHALL BE CASEWORK INSTALLER SHALL CUT CASEWORK AS REQUIRED FOR PLUMBING/ELECTRICAL LINES. CASEWORK INSTALLER SHALL CAULK BETWEEN COUNTERS, BACKSPLASHES, AND WALLS.

ALL WALL-MOUNTED CASEWORK SHALL BE MOUNTED WITH THE TOP AT 7'-0" AFF UNLESS OTHERWISE NOTED. REFER TO LIST OF FINISHES FOR COLOR SELECTIONS. REFER TO AQ752 FOR COURT LAYOUTS AND GRAPHICS. FOR LOCKER TYPES, REFER TO 5/AQ751. P-X INDICATES ATHLETIC EQUIPMENT, REFER TO

O. (FEC) INDICATES RECESSED FIRE EXTINGUISHER CABINET, REFER TO DETAIL 6/AQ751. **EQUIPMENT NOTES**

(ALL NOTES MAY NOT BE INDICATED ON THIS SHEET) MAIN BASKETBALL COURT MARKINGS, SEE DETAIL 1/AQ752. MAIN VOLLEYBALL COURT MARKINGS, SEE DETAIL 4/AQ752.

CROSSCOURT BASKETBALL MARKINGS; LINES SHALL BE 1 INCH AND NO CENTER CIRCLE IS REQUIRED. [ALTERNATE] TELESCOPING BLEACHERS, SHOWN IN CLOSED POSITION. REFER TO 9/AQ751 FOR BLEACHER GRAPHIC. POLE VAULT VAULTING BOX. REFER TO ATHLETIC EQUIPMENT SCHEDULE FOR ADDITIONAL INFORMATION.

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ALTERNATE. THEREFORE, TO BE COMPLETED AT A LATER DATE 28 SSM-1 LAVATORY SHELF ABOVE SINKS, SEE DETAIL 6/A-401 29 INSTALL WIRE MESH PARTITIONS 24" WIDE WITH LOCKABLE DOOR AND THE DEPTH OF THE LOCKER SHELF. THIS WILL SECURE THE OWNER'S AIR CLEANER PLACED ON TOP OF THE SHELF.

AROUND PILASTERS AND PERIMETER OF ROOM. PROVIDE MITER CORNERS AT PILASTERS. PROVIDE PREMOLDED INSERTS TO ACCOMMODATE ELECTRICAL DEVICES. ADJUST HEIGHT OF PADDING TO ACCOMMODATE WINDOWS. STOP PADDING AT HOLLOW METAL DOOR FRAMES.

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NOTES AT LOCKERS INDICATE LOCKER NUMBERING. 33 BUILT-IN LOCKER ADA BENCH ALONG THIS RUN OF LOCKERS, REFER TO DETAIL 3/AQ751 34 WALL MOUNTED MONITOR, REFER TO TECHNOLOGY. 35 [UNIT D ALTERNATE] PROJECTION SCREEN – 165" DIAGONAL

(80-1/2"H X 140" W) – ELECTRICALLY X OPERATED. 36 [UNIT D ALTERNATE] UNFRAMED MIRROR. MIRRORS SHALL VERTICAL JOINTS AT 4' O.C. AND MOUNTED AT 24" A.F.F. WITH TOP AT 7'-4".

39 REFER TO 8/AQ761 FOR ISLAND DETAIL 40 REFRIGERATOR SHALL BE LOOSE EQUIPMENT (BY OWNER).

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SIGNAGE GENERAL NOTES

REFER TO BUILDING ELEVATIONS FOR ADDITIONAL **BUILDING LETTERS** B. (RS_) LETTERS ADJACENT TO ENTRY INDICATES ROOM SIGNAGE AND "__" FOR SIGN TYPE. REFER TO SHEET AQ752 FOR SIGNAGE TYPES, DETAILS, AND ADDITIONAL

INFORMATION REFER TO MOUNTING HEIGHTS DRAWINGS FOR ADDITIONAL INFORMATION OWNER TO APPROVE ALL DISIGNATION AND ROOM NUMBERING SYSTEM PRIOR TO FABRICATION MAXIMUM CAPACITY SIGN TO BE TYPE K ON AQ752 AND LOCATED AS INDICATED ON PLAN

SIGN TO HAVE 1/2" RADIUS CORNERS, TYPICAL ALL SIGNS ALL DIMENSIONS INDICATED ARE TYPICAL PER SIGN TYPE, UNLESS OTHERWISE NOTED. ALL DIMENSIONS INDICATED ARE TYPICAL PER SIGN TYPE, UNLESS OTHERWISE NOTED. REFER TO PLAN FOR EXTERIOR DOOR NUMBERS

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SIGNAGE PLAN NOTES

COMMONS B217

_ _ _ -|-|

STAIR S-2

STAIR 1

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EQUIPMENT ROOM TAG LEGEND CONSTRUCTION — DOCUMENTS - OWNER/ SIGNAGE

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ROOM NUMBER

FIELDHOUSE

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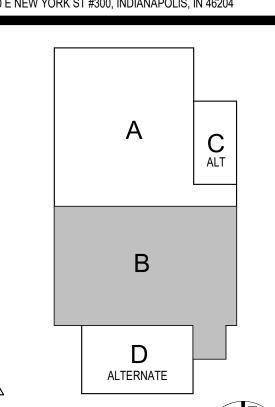
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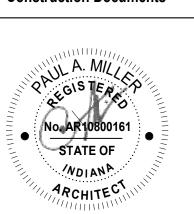


WWW.FHAI.COM 30 [UNIT D ALTERNATE] PROVIDE 6'H WALL PADDING (P-9) AS SHOWN 350 E NEW YORK ST #300, INDIANAPOLIS, IN 46204



KEY PLAN

Construction Documents



PROJECT MANAGER: MKS


DRAWN BY: AML PROJECT NUMBER: 222130.00 PROJECT ISSUE DATE: January 10, 2024

	NO.	DESCRIPTION	DATE
	1	Addendum #1	1-26-24
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SECOND FLOOR EQUIPMENT PLAN -UNIT B

SECOND FLOOR EQUIPMENT PLAN - UNIT B

SCALE: 1/8" = 1'-0"

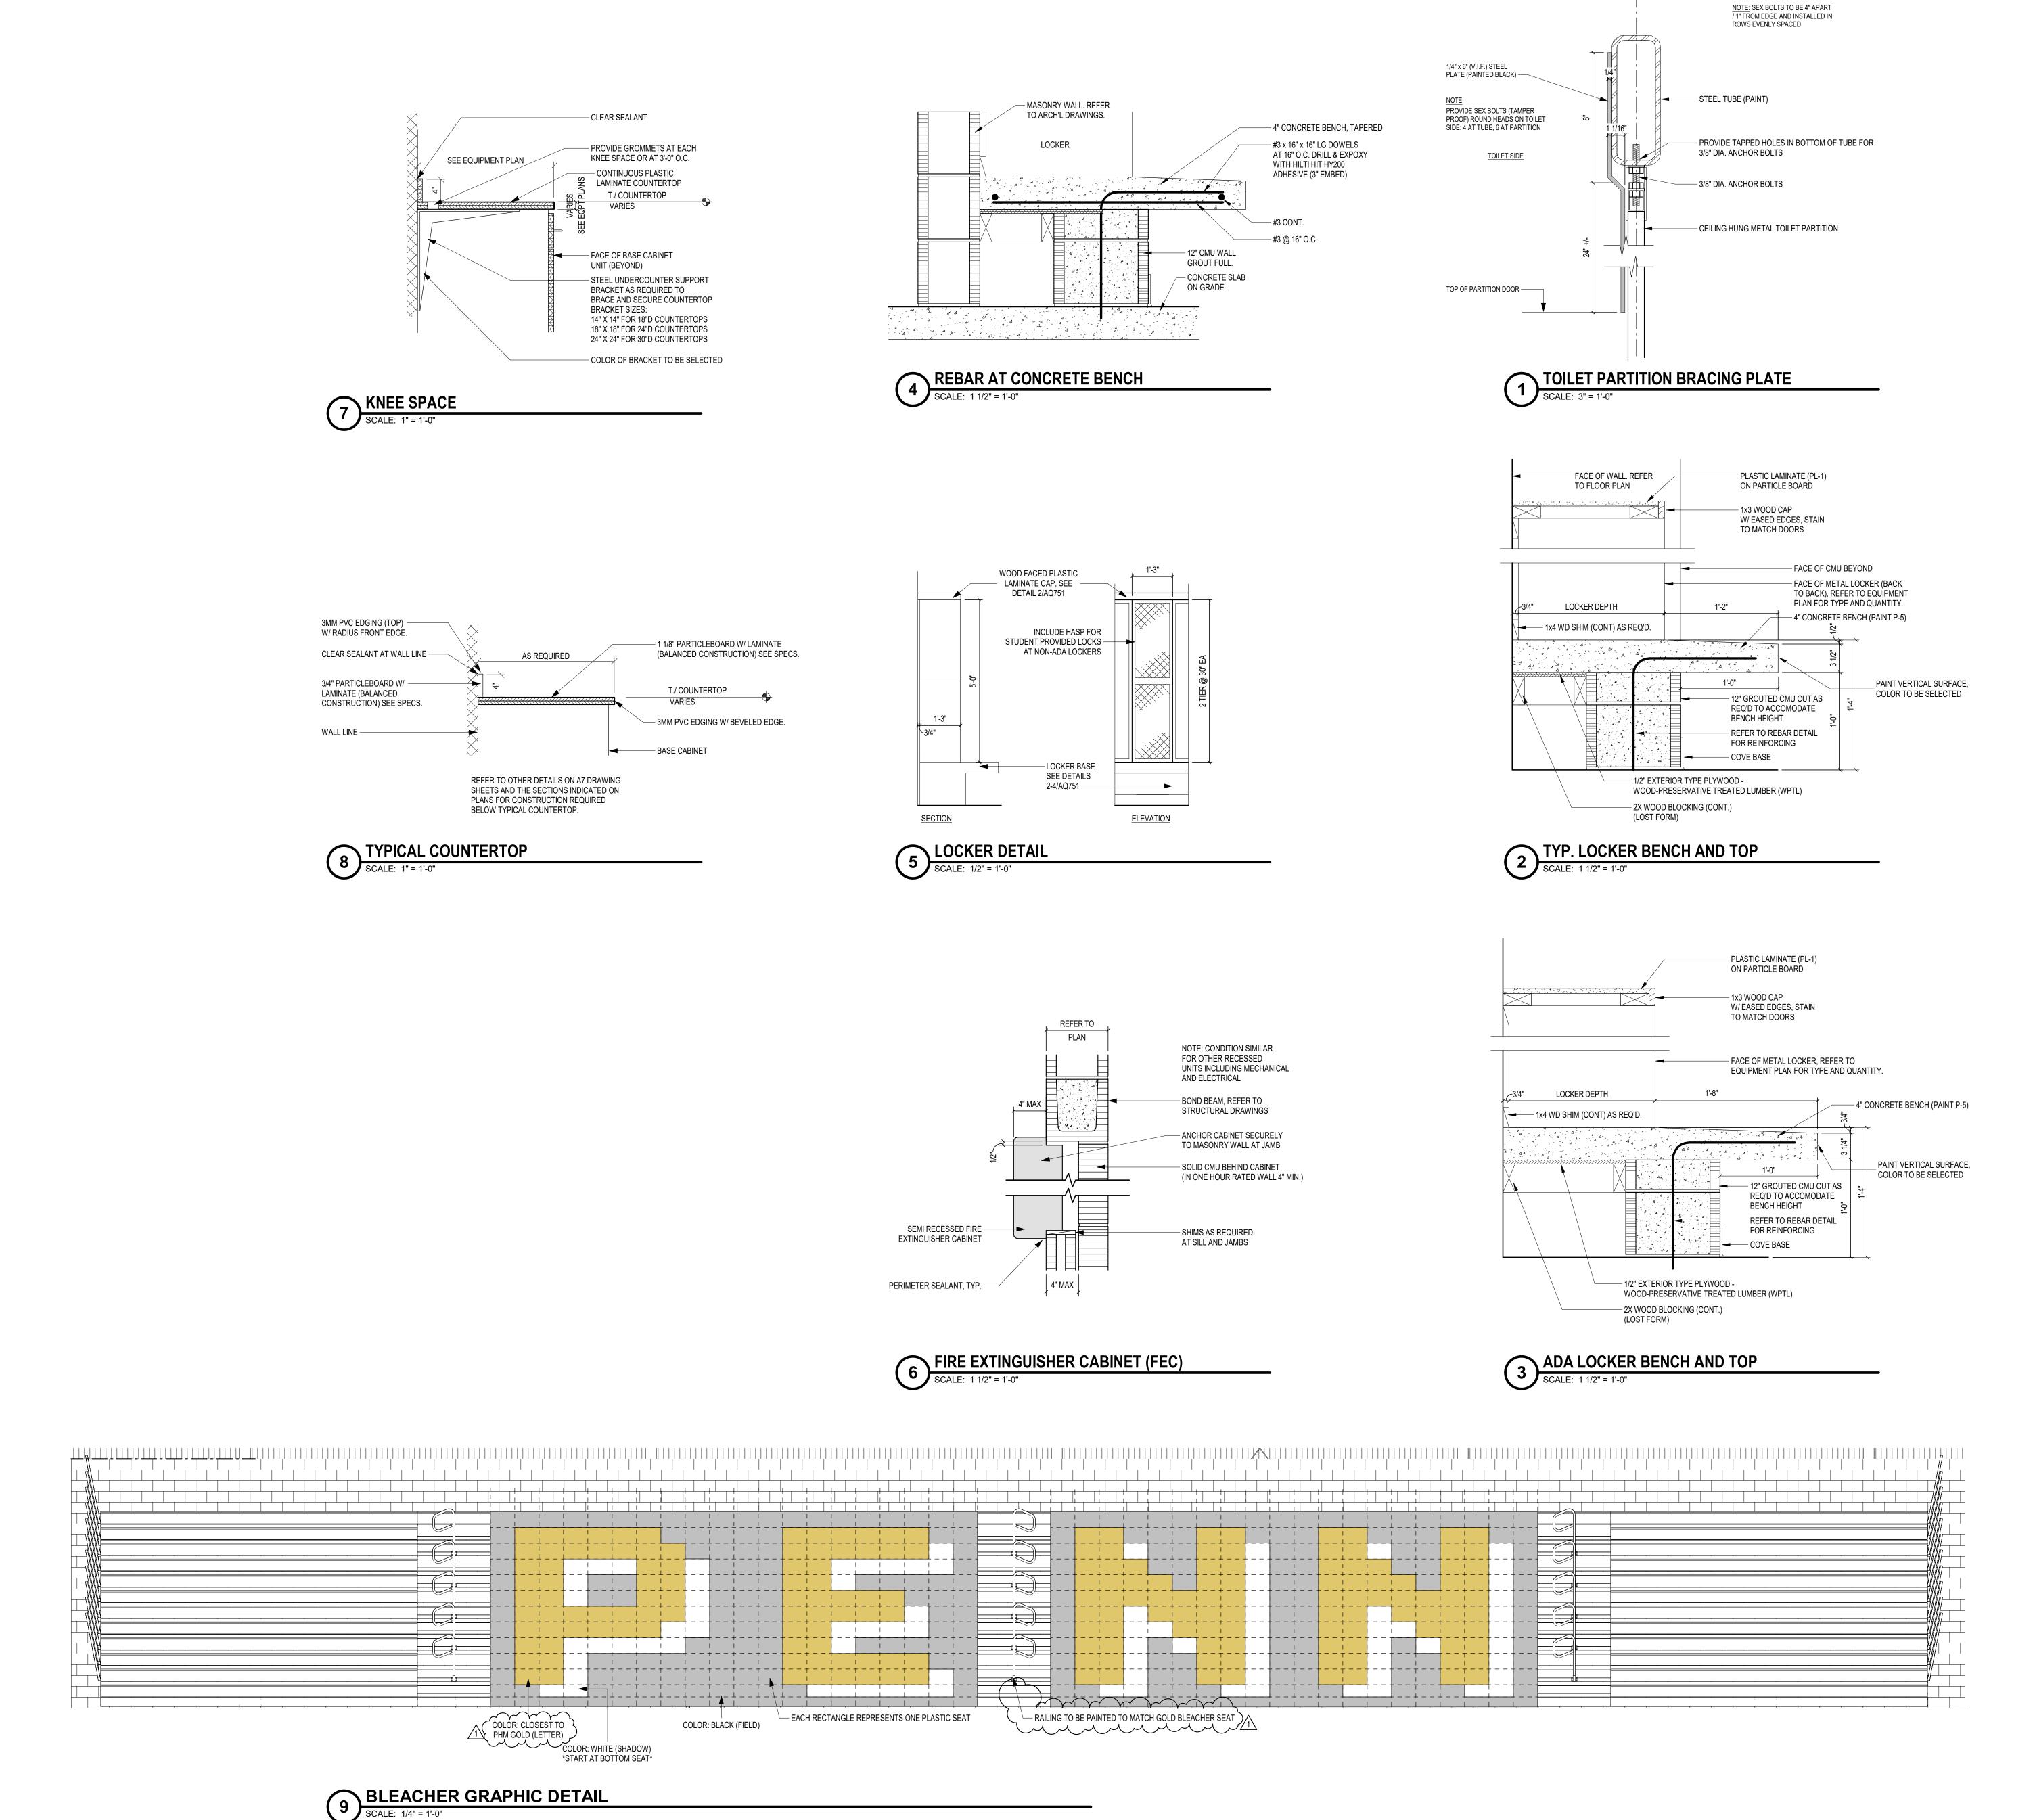


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PENN HIGH SCHOOL FIELDHOUSE

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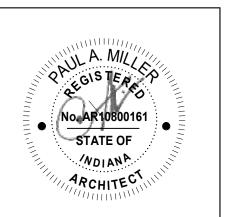
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ALTERNATE

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PROJECT MANAGER: MKS

DRAWN BY: CLP

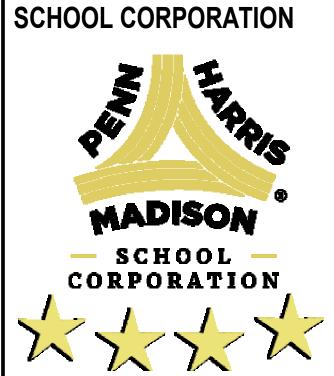PROJECT NUMBER: 222130.00


PROJECT ISSUE DATE: January 10, 2024

KEY PLAN

REV. NO.△	DESCRIPTION	DATE
1	Addendum #1	1-26-24

EQUIPMENT DETAILS

AQ751

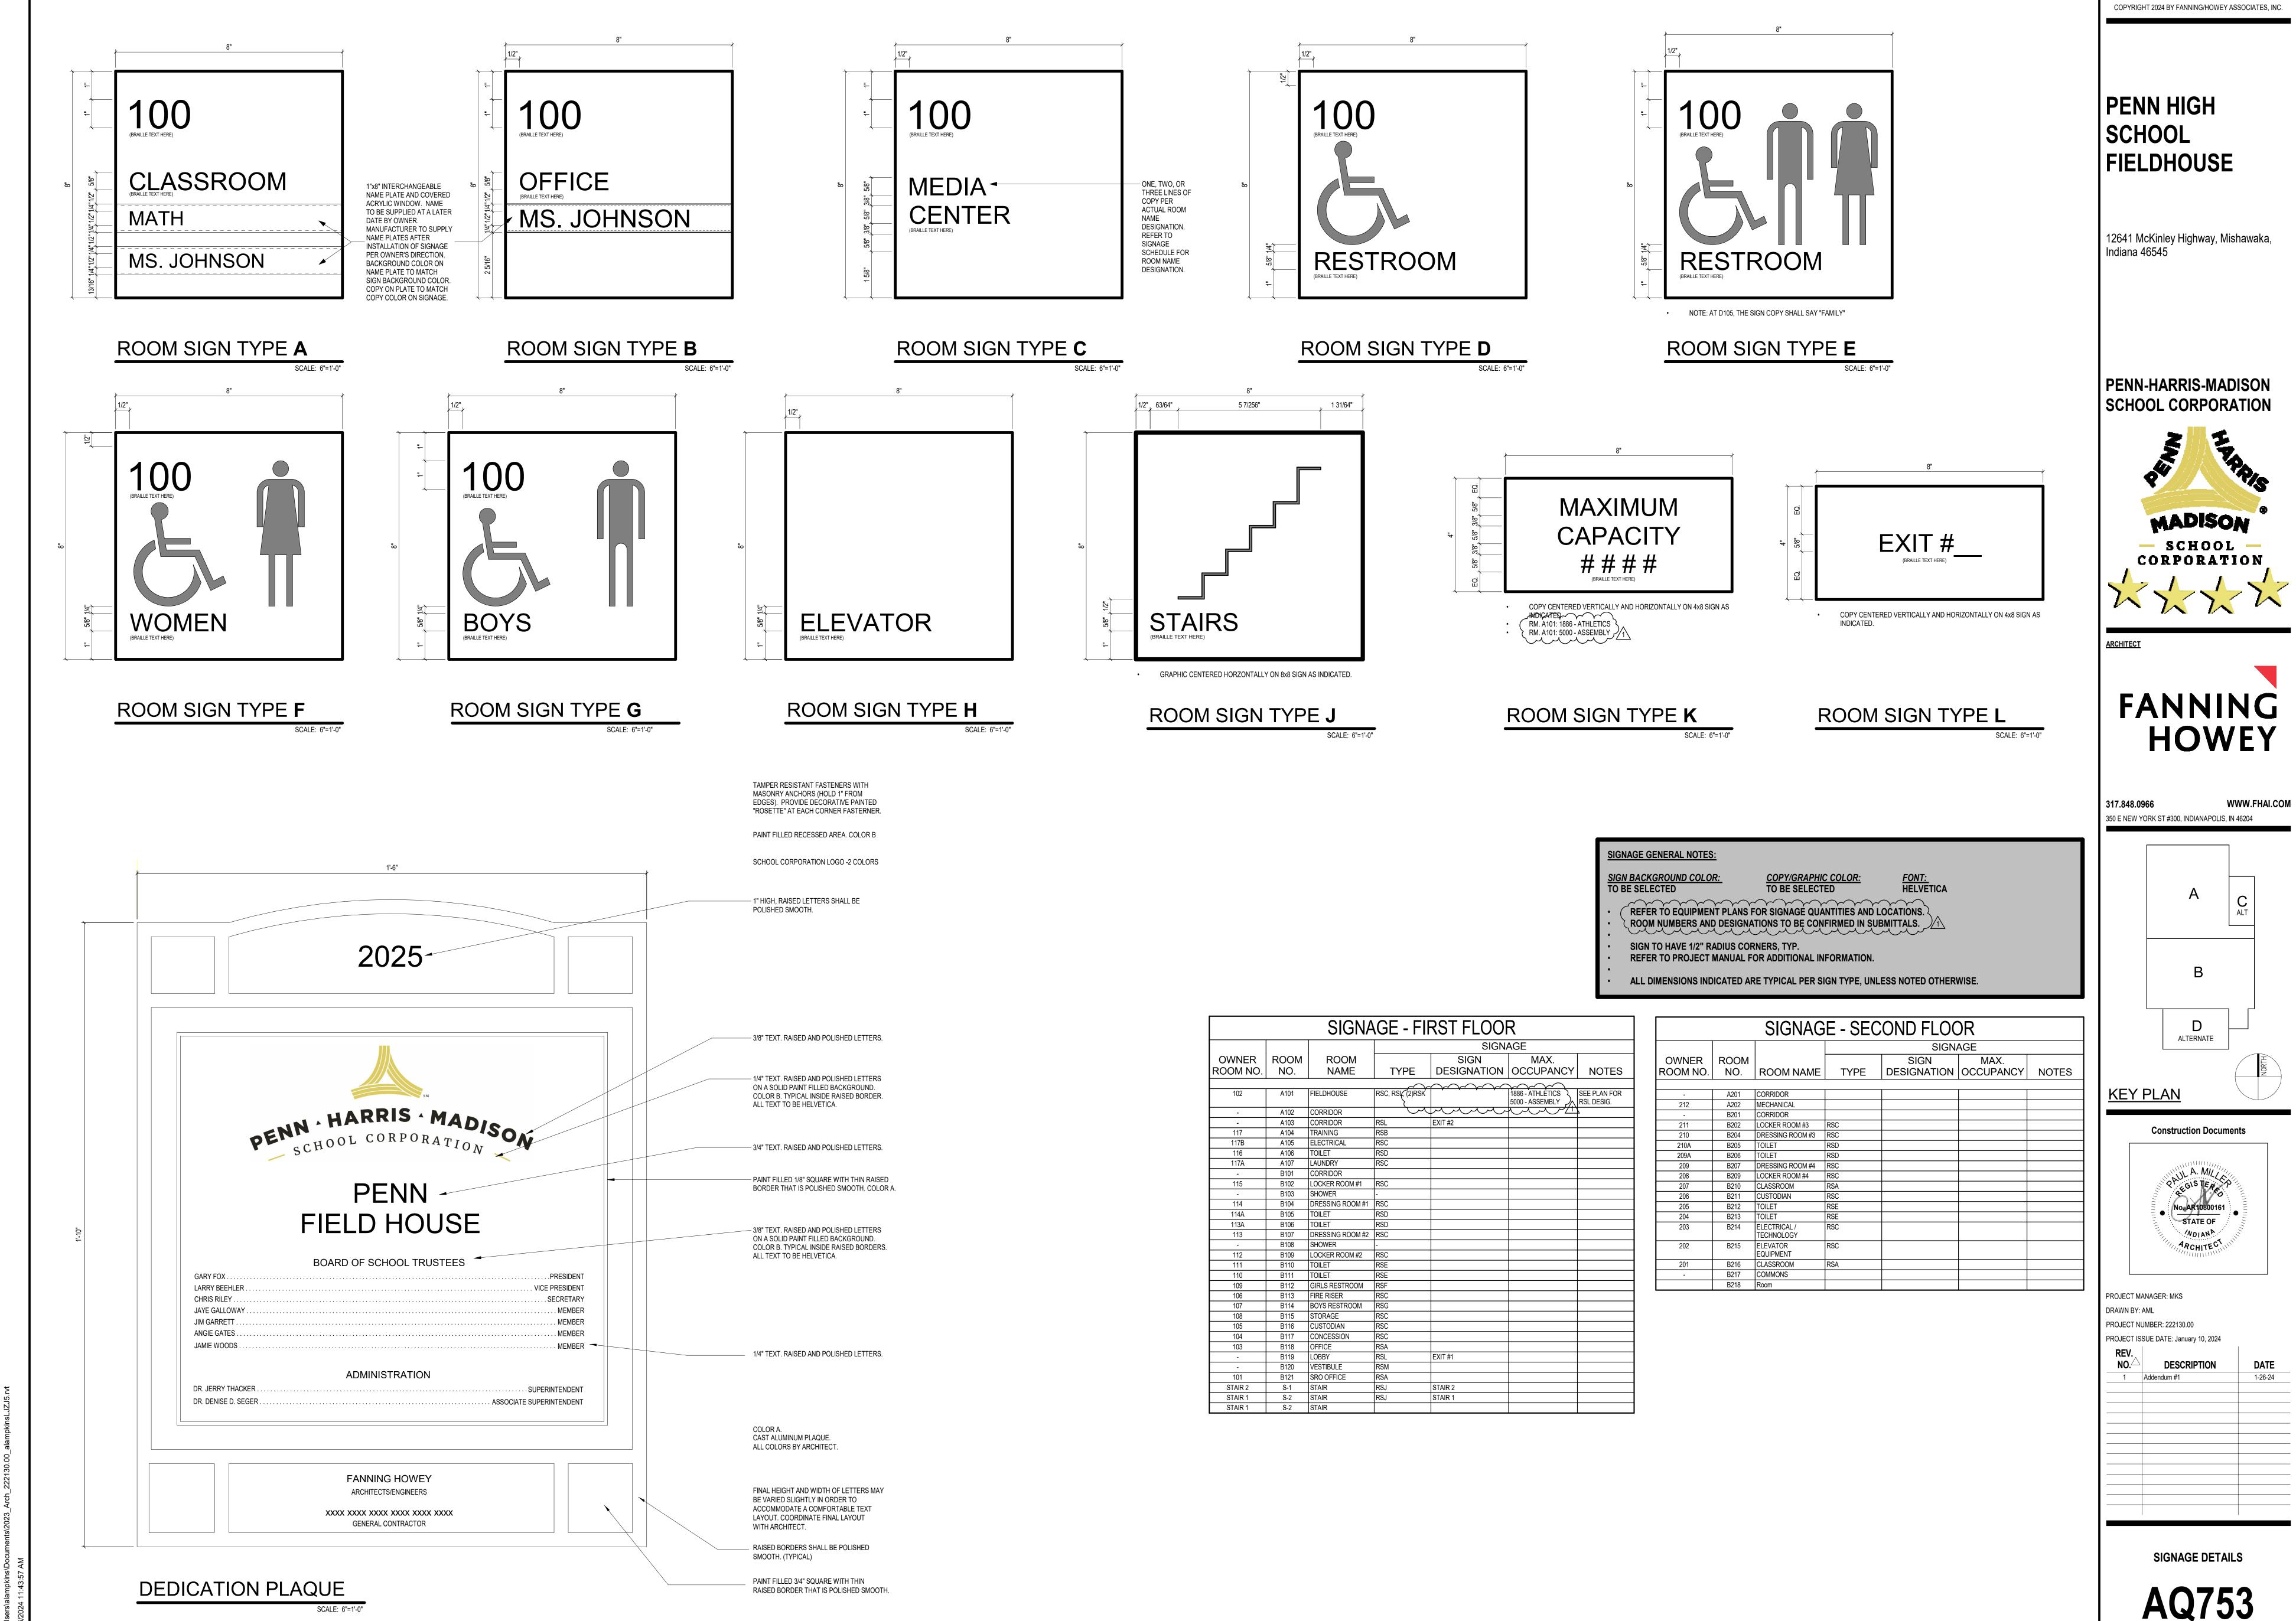


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	ROOM LEGEND	
ROOM NO.	ROOM NAME	AREA (SF)
A101	FIELDHOUSE	54239 SF
A102	CORRIDOR	328 SF
A105	ELECTRICAL	182 SF
A106	TOILET	81 SF
A107	LAUNDRY	144 SF
B101	CORRIDOR	1163 SF
B102	LOCKER ROOM #1	399 SF
B103	SHOWER	184 SF
B104	DRESSING ROOM #1	261 SF

	ROOM LEGEND	
ROOM NO.	ROOM NAME	AREA (SF)
B105	TOILET	74 SF
B106	TOILET	75 SF
B107	DRESSING ROOM #2	270 SF
B108	SHOWER	184 SF
B109	LOCKER ROOM #2	401 SF
B110	TOILET	63 SF
B111	TOILET	63 SF
B112	GIRLS RESTROOM	388 SF
B113	FIRE RISER	304 SF

ROOM		AR
NO.	ROOM NAME	(S
B114	BOYS RESTROOM	270 S
B115	STORAGE	127 S
B116	CUSTODIAN	68 SF
B117	CONCESSION	263 S
B118	OFFICE	341 S
B119	LOBBY	1039
B120	VESTIBULE	369 S
B121	SRO OFFICE	159 S
S-2	STAIR	115 S

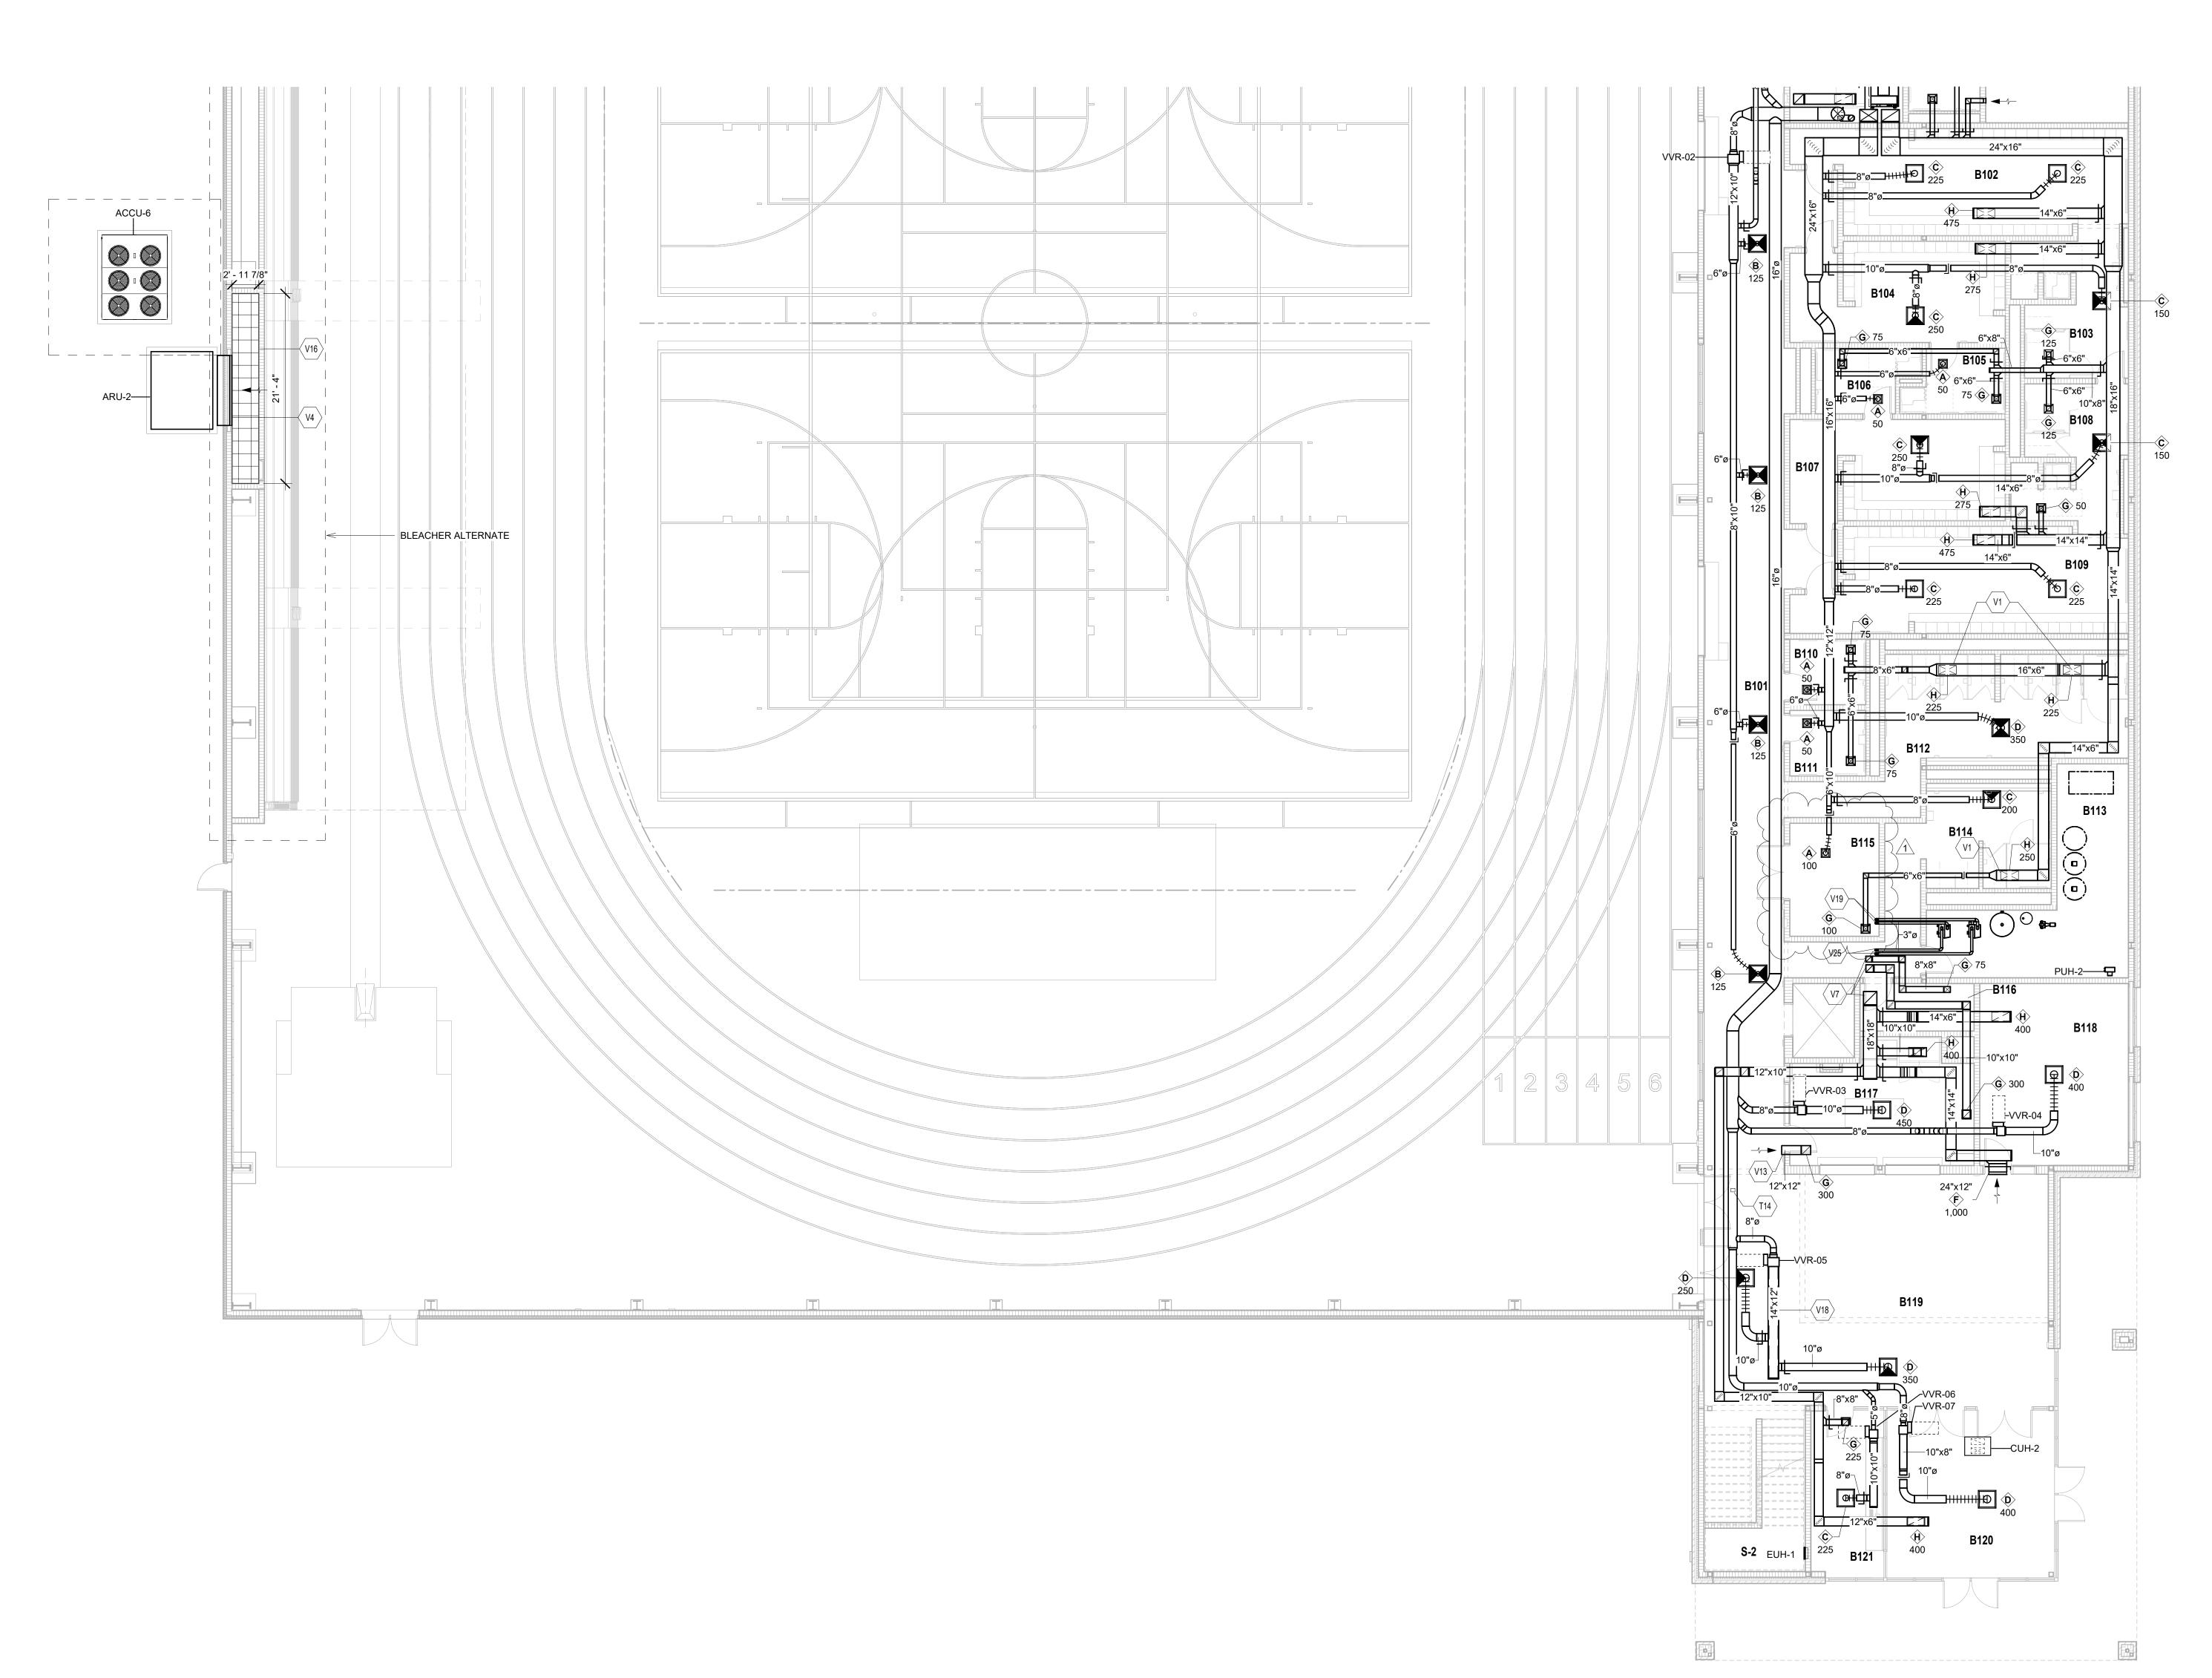

VENTILATION PLAN GENERAL NOTES

- A. ALL DUCTWORK, PIPING AND VALVES SHALL BE
 - UNLESS OTHERWISE NOTED.
- ARRANGE DUCTWORK, PIPING, ETC. TO ALLOW FOR EASY CLEAR OF ANY OBSTRUCTIONS.
- WALLS IN ACCORDANCE WITH MECHANICAL CODE AND
- MATERIAL HAVING SAME FIRE RATING AS THE WALL AND/OR FLOOR.
- MECHANICAL CONTRACTOR IS RESPONSIBLE FOR HIS RESPECTIVE WORK FOR REPAIRING AND PATCHING TO MATCH EXISTING SURFACES, SIDEWALKS, STREETS, FLOORS, WALLS, ROOFS, CEILING AND PAVEMENT.
- ALL RECTANGULAR SHEET METAL DUCT SIZES SHOWN ARE INSIDE FREE AREA DIMENSIONS. ALL ROUND DUCT SIZES SHOWN ARE INSIDE DIAMETERS.
- FROM SIZES SHOWN ON PLAN. L. ALL RETURN/EXHAUST AIR DUCT ABOVE IN ACCORDANCE WITH SMACNA REQUIREMENTS.

VENTILATION PLAN NOTES

- (ALL NOTES MAY NOT BE INDICATED ON THIS SHEET) T14 APPROXIMATE LOCATION OF DUCT STATIC PRESSURE SENSOR. SENSOR PROVIDED BY THE TEMPERATURE CONTROL CONTRACTOR AND INSTALLED BY THE MECHANICAL CONTRACTOR. COORDINATE EXACT
- PROVIDE VOLUME DAMPER IN VERTICAL DUCTWORK TO AIR V4 SUPPLY AIR DIFFUSERS AND RETURN AIR GRILLE PROVIDED BY AIR ROTATION UNIT MANUFACTURER. CONTRACTOR

SHALL PROVIDE INTERCONNECTING DUCTWORK BETWEEN

LOCATION WITH ALL TRADES.

- △DIFFUSER/GRILLE AND AIR ROTATION UNIT. PAINT DIFFUSER AND GRILLE PROVIDED BY MANUFACTURER. COORDINATE FINAL COLOR WITH ARCHITECT. DUCT ROUTED UP TO FLOOR ABOVE. COORDINATE WITH
- STRUCTURAL, IN AREA. V13 AIR TRANSFER WALK OPENING LOCATED ABOVE THE CEILING. COORDINATE EXACT LOCATION WITH ALL TRADES. END OF DUCT OPEN TO SPACE.
- V16 ALTERNATE: CONTRACTOR SHALL PROVIDE McNICHOLS BAR GRATING STANDARD DUTY WELDED, GALVANIZED STEEL HOT DIPPED 1" x 1/8" RECTENGULAR BAR ABOVE OPENING CHASE (OR EQUAL). SUPPORT WEIGHT OF GRATE AS REQUIRED. COORDINATE WITH ARCHITECTURAL &
- V18 DUCTWORK PROVIDED WITH INTERNAL LINED INSULATION. REFER TO SPECIFICATIONS. V19 PROVIDE AND INSTALL 3" EXHAUST VENT WITH A MINIMUM 1/4 INCH PER FOOT PITCH UPWARDS PER MANUFACTURERS REQUIREMENTS (FOR EACH WATER HEATER). COORDINATE FINAL VENT DIAMETER WITH APPROVED SUBMITTALS.
 EXHAUST VENT MUST BE 3 FEET ABOVE THE COMBUSTION AIR INLET, AND 2 FEET ABOVE ANY HIGHER PORTION OF
- REQUIRED. TERMINATE DUCT WITH SUPPORT COLLAR, ROOF FLASHING, AND VELOCITY CONE. V25 PROVIDE AND INSTALL 3" COMBUSTION AIR INLET PER MANUFACTURER REQUIREMENTS (FOR EACH WATER HEATER). COORDINATE FINAL VENT DIAMETER WITH APPROVED SUBMITTALS. ROUTE COMBUSTION AIR DUCT UP THROUGH FLOOR ABOVE, TRANSITION DUCTWORK IN CHASE AS REQUIRED. TERMINATE COMBUSTION AIR INLET WITH GOOSENECK. REFER TO DETAIL. PIPE SIZE AND

INSTALLATION PER MANUFACTURERS REQUIREMENTS.

THE BUILDING WITHIN 10 FEET. ROUTE FLUE UP THROUGH

FLOOR ABOVE, TRANSITION DUCTWORK IN CHASE AS

- CONCEALED ABOVE THE CEILING AND WITHIN WALLS,
- B. REFER TO THE SPECIFICATIONS FOR REQUIREMENTS RELATED TO EQUIPMENT QUALITY, CONSTRUCTION AND FINISH OF MATERIALS.
- ACCESS TO COILS, VALVES, DAMPERS AND CONTROLS. KEEP AREAS ADJACENT TO ACCESS PANELS FREE AND SEAL DUCT PENETRATIONS THROUGH THE FLOOR AND/OR
- SCHOOL SMACNA REQUIREMENTS. SEAL DUCT PENETRATIONS THROUGH FIRE RATED FLOORS AND/OR WALLS WITH A **FIELDHOUSE**
- PROVIDE BALANCING DAMPER AT EACH DUCT BRANCH,
- SERVING DIFFUSER, GRILLE AND REGISTER. INSTALL WALL THERMOSTATS, TEMPERATURE SENSORS, HUMIDISTATS, ETC. 44" ABOVE THE FINISH FLOOR IN ACCORDANCE WITH ADA REQUIREMENTS. COORDINATE ALL REQUIRED WALL, ROOF AND FLOOR OPENINGS (BOTH DIMENSIONS AND LOCATIONS) WITH ALL
- OTHER TRADES. COORDINATE MECHANICAL SYSTEM INSTALLATION WITH STRUCTURE, FIRE PROTECTION AND LIGHTING LAYOUT. PROVIDE ALL NECESSARY TRANSITIONS TO EQUIPMENT
- LOCKERS/SHOWER AREAS SHALL BE MADE OF ALUMINUM

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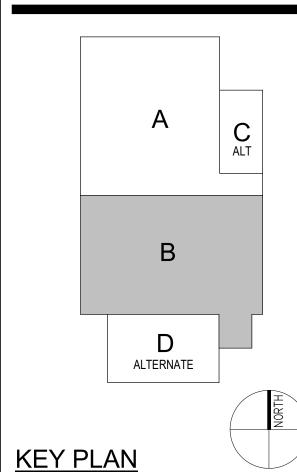
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PROJECT MANAGER: MKS DRAWN BY: DJA PROJECT NUMBER: 222130.00 PROJECT ISSUE DATE: January 10, 2024

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1	Addendum #1	1-26-24

VERIFICATION NOTE


CONTRACTOR SHALL VERIFY ALL DIMENSIONS AND CLEARANCES AND ALL EXISTING FIELD CONDITIONS BEFORE STARTING CONSTRUCTION. COMMENCEMENT OF WORK CONSTITUTES ACCEPTANCE OF CONDITIONS.

SHOULD DIFFERENT CONDITIONS BE ENCOUNTERED, CONTACT THE ARCHITECT BEFORE PROCEEDING WITH WORK.

FIRST FLOOR VENTILATION PLAN -**UNIT B**

MV102

UNIT B - FIRST FLOOR VENTILATION PLAN

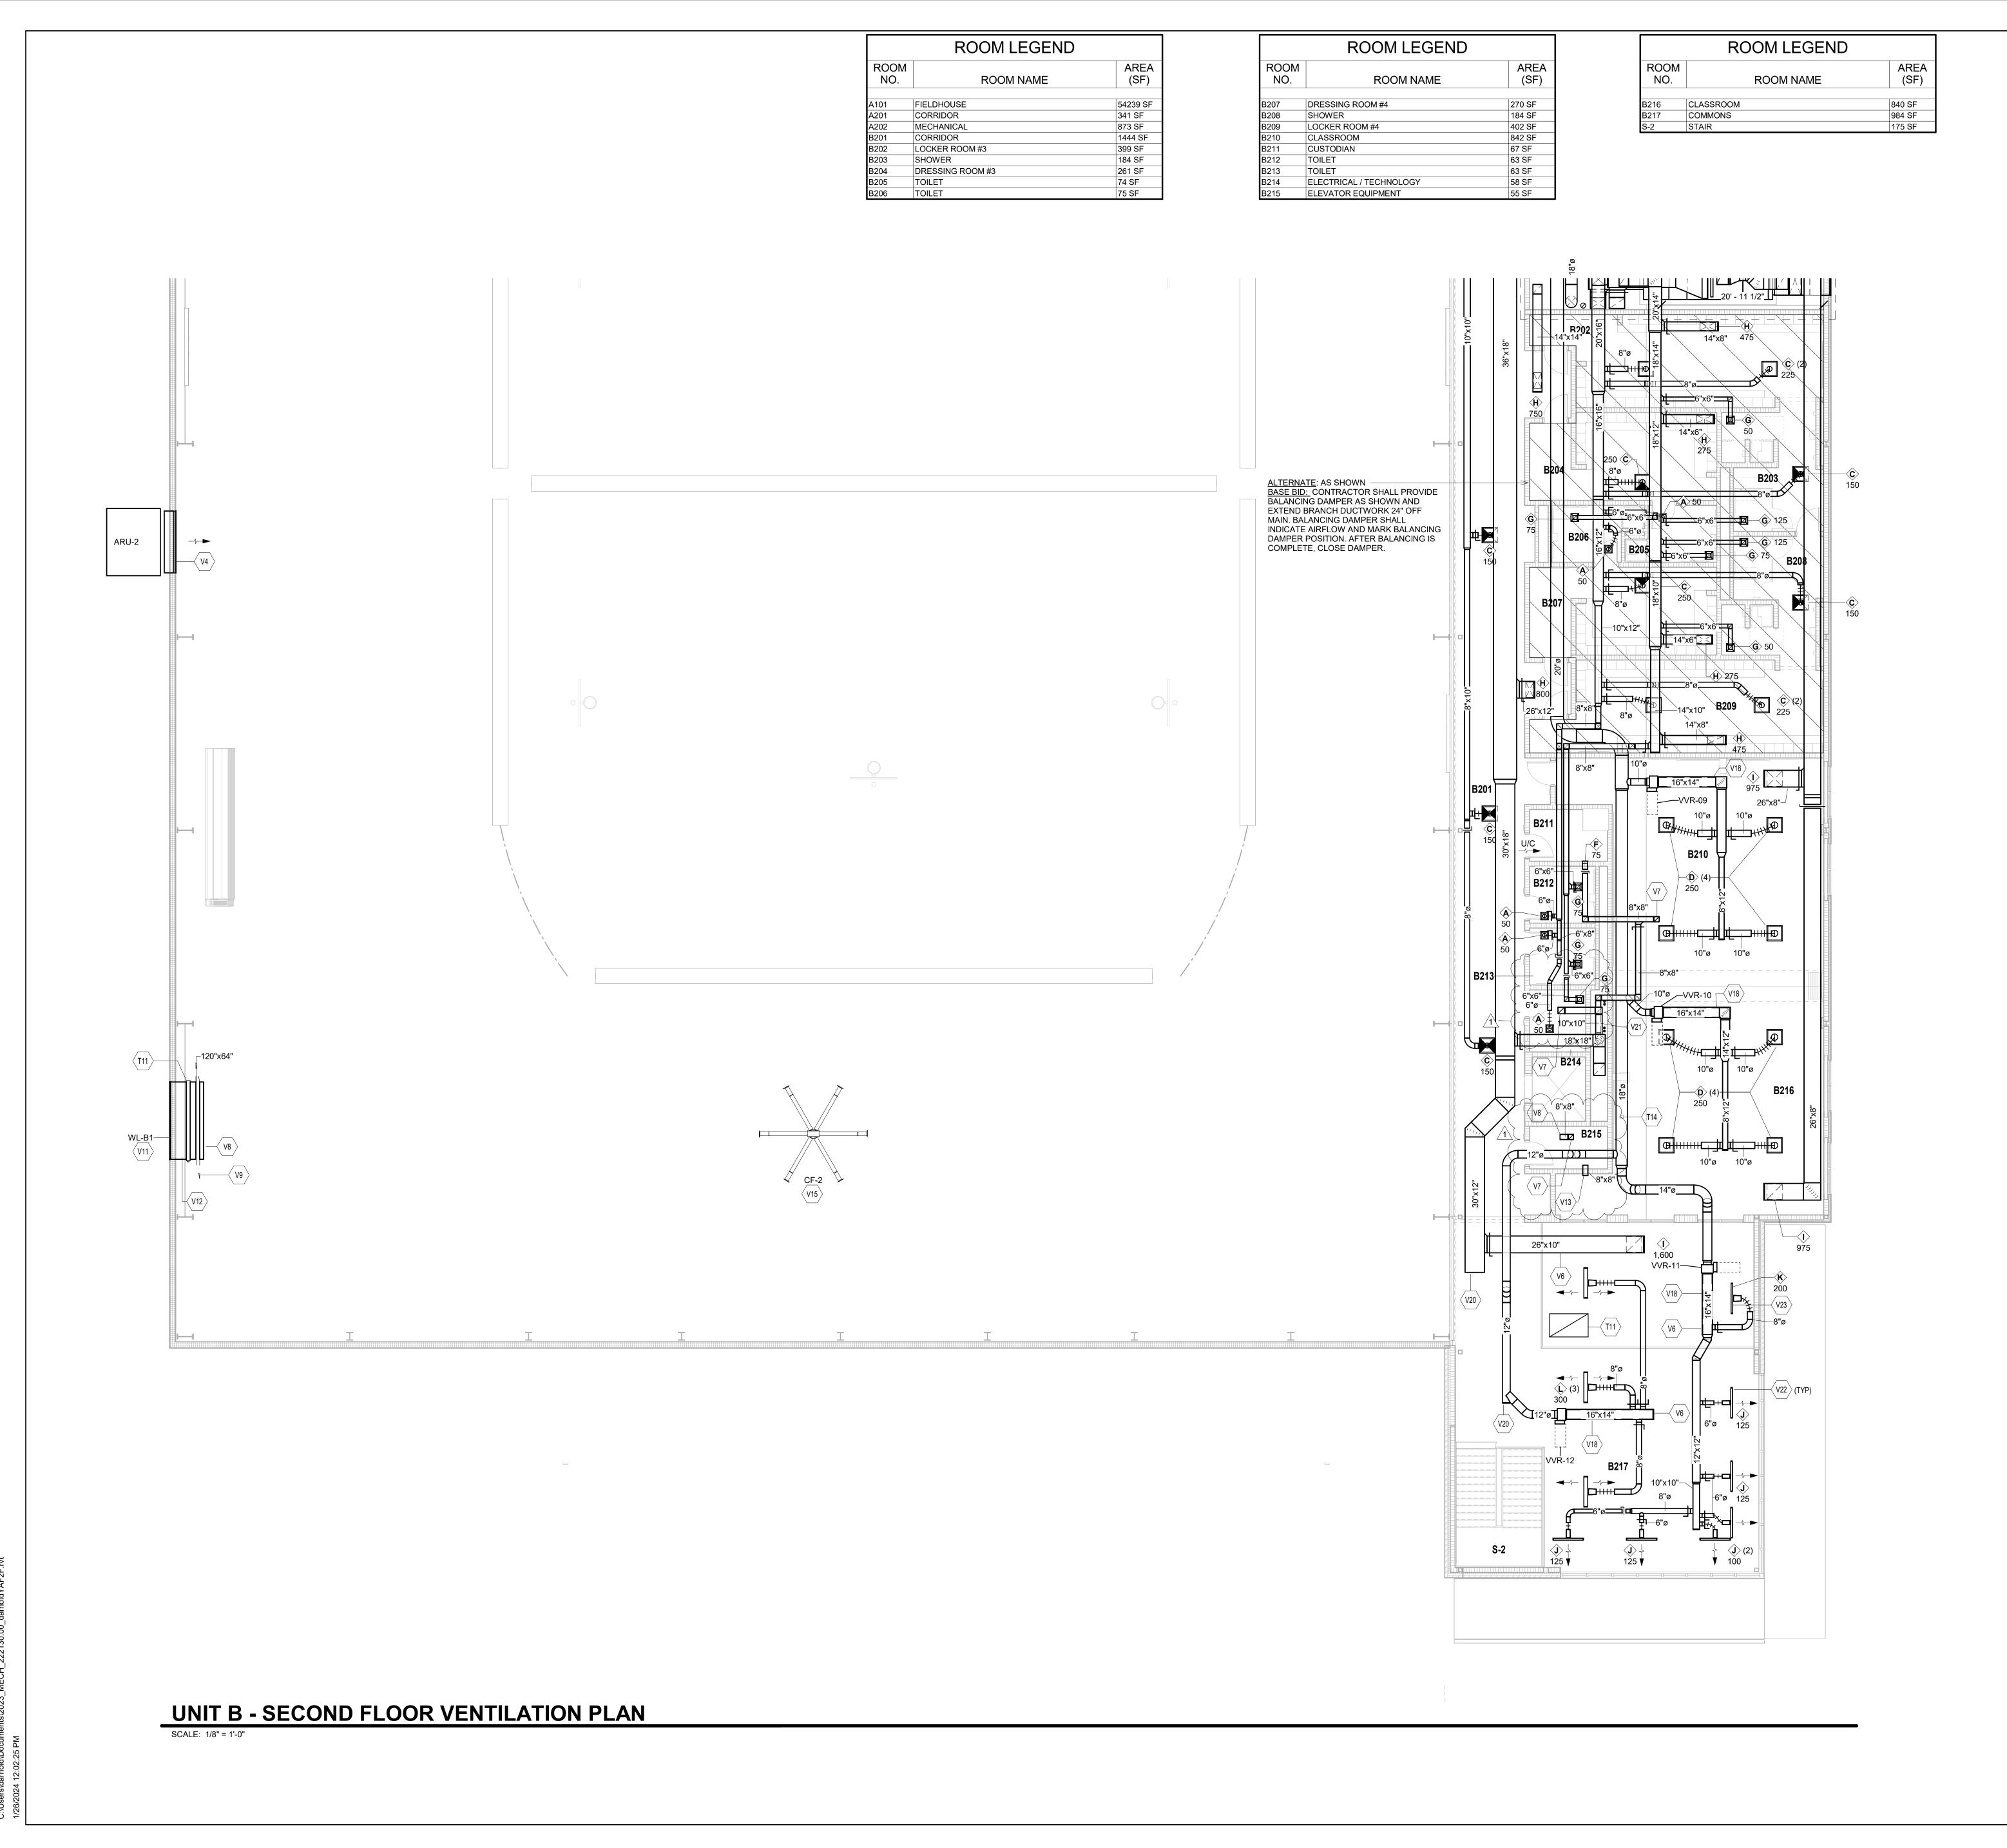

VENTILATION PLAN GENERAL NOTES

- A. ALL DUCTWORK, PIPING AND VALVES SHALL BE CONCEALED ABOVE THE CEILING AND WITHIN WALLS,
 - UNLESS OTHERWISE NOTED.
 - FINISH OF MATERIALS. ARRANGE DUCTWORK, PIPING, ETC. TO ALLOW FOR EASY ACCESS TO COILS, VALVES, DAMPERS AND CONTROLS.
 - KEEP AREAS ADJACENT TO ACCESS PANELS FREE AND CLEAR OF ANY OBSTRUCTIONS. SEAL DUCT PENETRATIONS THROUGH THE FLOOR AND/OR WALLS IN ACCORDANCE WITH MECHANICAL CODE AND SMACNA REQUIREMENTS. SEAL DUCT PENETRATIONS
 - MATERIAL HAVING SAME FIRE RATING AS THE WALL AND/OR FLOOR. MECHANICAL CONTRACTOR IS RESPONSIBLE FOR HIS
 - FLOORS, WALLS, ROOFS, CEILING AND PAVEMENT. F. ALL RECTANGULAR SHEET METAL DUCT SIZES SHOWN ARE
 - ALL RETURN/EXHAUST AIR DUCT ABOVE

VENTILATION PLAN NOTES (ALL NOTES MAY NOT BE INDICATED ON THIS SHEET)

- T11 RELIEF CONTROL DAMPER PROVIDED BY THE TEMPERATURE CONTROL CONTRACTOR AND INSTALLED BY THE MECHANICAL CONTRACTOR, CALIBRATED AND SET TO MAINTAIN A SLIGHT POSITIVE PRESSURE WITHIN THE SPACE. TEST AND CALIBRATE RELIEF CONTROL DAMPER PRIOR TO CONSTRUCTION SUBSTANTIAL COMPLETION.
- T14 APPROXIMATE LOCATION OF DUCT STATIC PRESSURE SENSOR. SENSOR PROVIDED BY THE TEMPERATURE CONTROL CONTRACTOR AND INSTALLED BY THE MECHANICAL CONTRACTOR. COORDINATE EXACT LOCATION WITH ALL TRADES.

V4 SUPPLY AIR DIFFUSERS AND RETURN AIR GRILLE PROVIDED

- BY AIR ROTATION UNIT MANUFACTURER. CONTRACTOR SHALL PROVIDE INTERCONNECTING DUCTWORK BETWEEN DIFFUSER/GRILLE AND AIR ROTATION UNIT. PAINT DIFFUSER AND GRILLE PROVIDED BY MANUFACTURER. COORDINATE FINAL COLOR WITH ARCHITECT. V6 PAINT DUCTWORK TO COLOR SELECTED BY THE
- ARCHITECT/ENGINEER. CLEAN AND PREPARE DUCTWORK TO ENSURE PAINT ADHERES TO DUCTWORK. V7 DUCT ROUTED UP TO FLOOR ABOVE. COORDINATE WITH
- STRUCTURAL IN AREA. END OF DUCT OPENING/TO SPACE/OPENING TO BE PROTECTED WITH BIRDSCREEN. V9 BAROMETRIC RELIEF DAMPER. CALIBRATED AND SET TO MAINTAIN A SLIGHT POSITIVE PRESSURE WITHIN THE
- CONSTRUCTION SUBSTANTIAL COMPLETION. V11 INSULATED SHEET METAL PLENUM MOUNTED BEHIND WALL LOUVER. TRANSITION BOTTOM OF DUCT AT A SLOPE DOWNWARD TO WALL LOUVER. SEAL ALL SEAMS AND EDGES WATER TIGHT. WRAP PLENUM WITH INSULATION. REFER TO DETAIL.
- SEALED WATER TIGHT. DRIP PAN TO EXTEND A MINIMUM OF 8" BEYOND DUCTWORK.

SPACE. TEST AND CALIBRATE RELIEF DAMPER PRIOR TO

V13 AIR TRANSFER WALL OPENING LOCATED ABOVE THE CEILING. COORDINATE EXACT LOCATION WITH ALL TRADES. END OF DUCT OPEN TO SPACE.

V12 INSTALL DRIP PAN UNDER WALL LOUVER. PAN SHALL BE

- V15 COORDINATE THE INSTALLATION OF THE HVLS FANS WITH ALL TRADES. PROPER CLEARANCES SHALL BE ADHERED TO. REFER TO MANUFACTURER'S REQUIREMENTS FOR REQUIRED CLEARANCES. THE FAN SHALL BE SUPPORTED AND BRACED FROM STRUCTURED STEEL MEMBERS. SUPPORT AND/OR BRACING FROM THE LIGHT GAUGE ROOF PURLINS IS PROHIBITED.
- V18 DUCTWORK PROVIDED WITH INTERNAL LINED INSULATION. REFER TO SPECIFICATIONS.
- V20 CAP DUCT AIR TIGHT FOR FUTURE ADDITION. V21 TRANSITIION DUCTWORK IN AREA WITHIN CHASE. V22 LINEAR DIFFUSER SHALL BE IN THE POSITION TO PROVIDE
- AIRFLOW IN THE HORIZONTAL DIRECTION. V23 LINEAR DIFFUSER SHALL BE IN THE POSITION TO PROVIDE AIRFLOW IN THE DOWNWARD DIRECTION.

- B. REFER TO THE SPECIFICATIONS FOR REQUIREMENTS RELATED TO EQUIPMENT QUALITY, CONSTRUCTION AND
- THROUGH FIRE RATED FLOORS AND/OR WALLS WITH A
- RESPECTIVE WORK FOR REPAIRING AND PATCHING TO MATCH EXISTING SURFACES, SIDEWALKS, STREETS,
- INSIDE FREE AREA DIMENSIONS. ALL ROUND DUCT SIZES SHOWN ARE INSIDE DIAMETERS. PROVIDE BALANCING DAMPER AT EACH DUCT BRANCH, SERVING DIFFUSER, GRILLE AND REGISTER.
- INSTALL WALL THERMOSTATS, TEMPERATURE SENSORS, HUMIDISTATS, ETC. 44" ABOVE THE FINISH FLOOR IN ACCORDANCE WITH ADA REQUIREMENTS. COORDINATE ALL REQUIRED WALL, ROOF AND FLOOR OPENINGS (BOTH DIMENSIONS AND LOCATIONS) WITH ALL OTHER TRADES.
- COORDINATE MECHANICAL SYSTEM INSTALLATION WITH STRUCTURE, FIRE PROTECTION AND LIGHTING LAYOUT. PROVIDE ALL NECESSARY TRANSITIONS TO EQUIPMENT FROM SIZES SHOWN ON PLAN.
- LOCKERS/SHOWER AREAS SHALL BE MADE OF ALUMINUM IN ACCORDANCE WITH SMACNA REQUIREMENTS.

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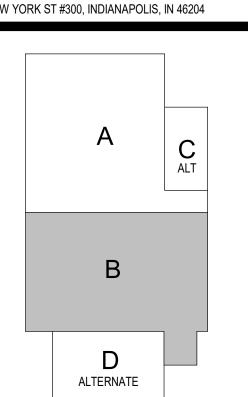
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KEY PLAN

Construction Documents



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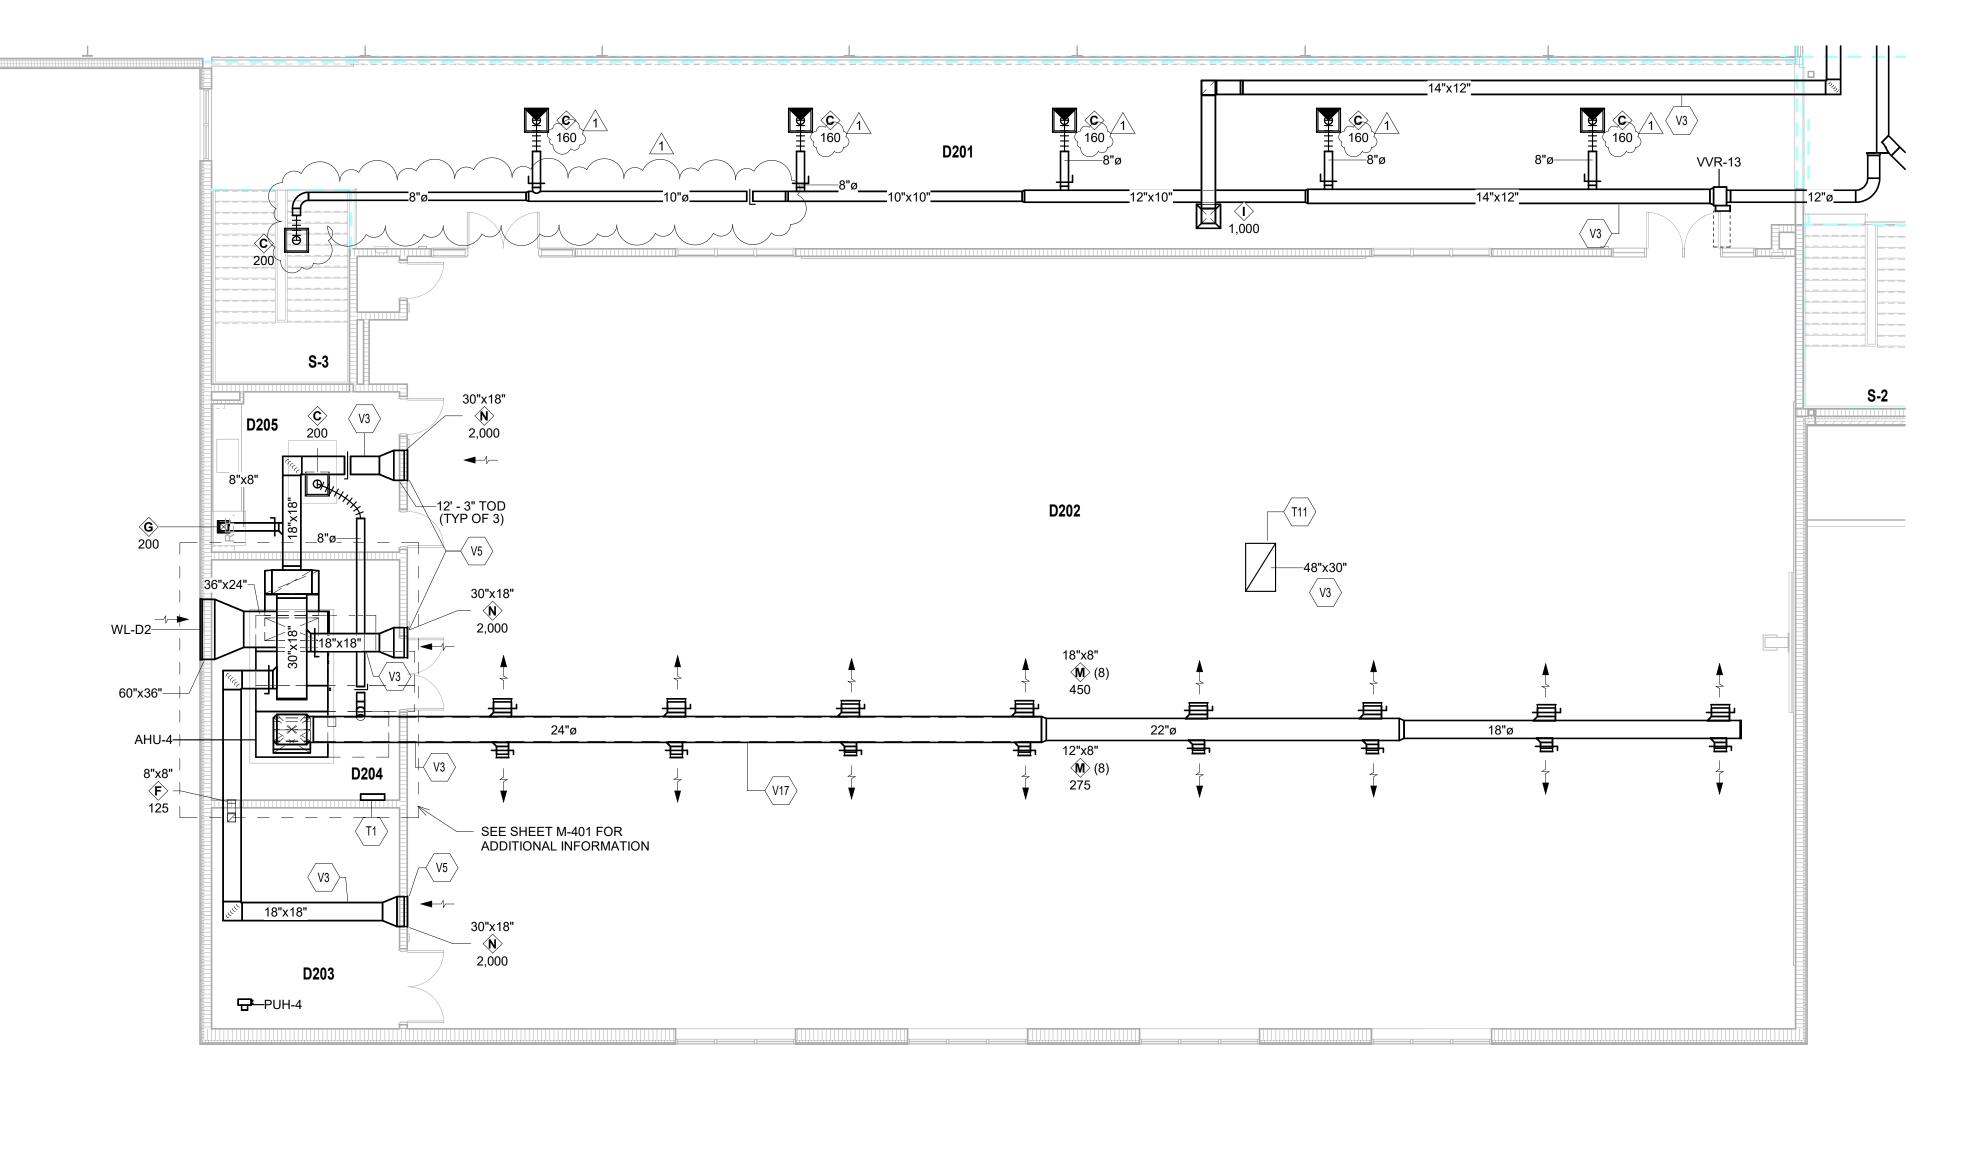
VERIFICATION NOTE

CONTRACTOR SHALL VERIFY ALL DIMENSIONS AND CLEARANCES AND ALL EXISTING FIELD CONDITIONS BEFORE STARTING CONSTRUCTION. COMMENCEMENT OF WORK CONSTITUTES ACCEPTANCE OF CONDITIONS.

SHOULD DIFFERENT CONDITIONS BE ENCOUNTERED, CONTACT THE ARCHITECT BEFORE PROCEEDING WITH WORK.

SECOND FLOOR VENTILATION PLAN - UNIT B


MV202



___120"x28"

₩L-D4 ₩ (V11)

UNIT D - FIRST FLOOR VENTILATION PLAN - ALTERNATE

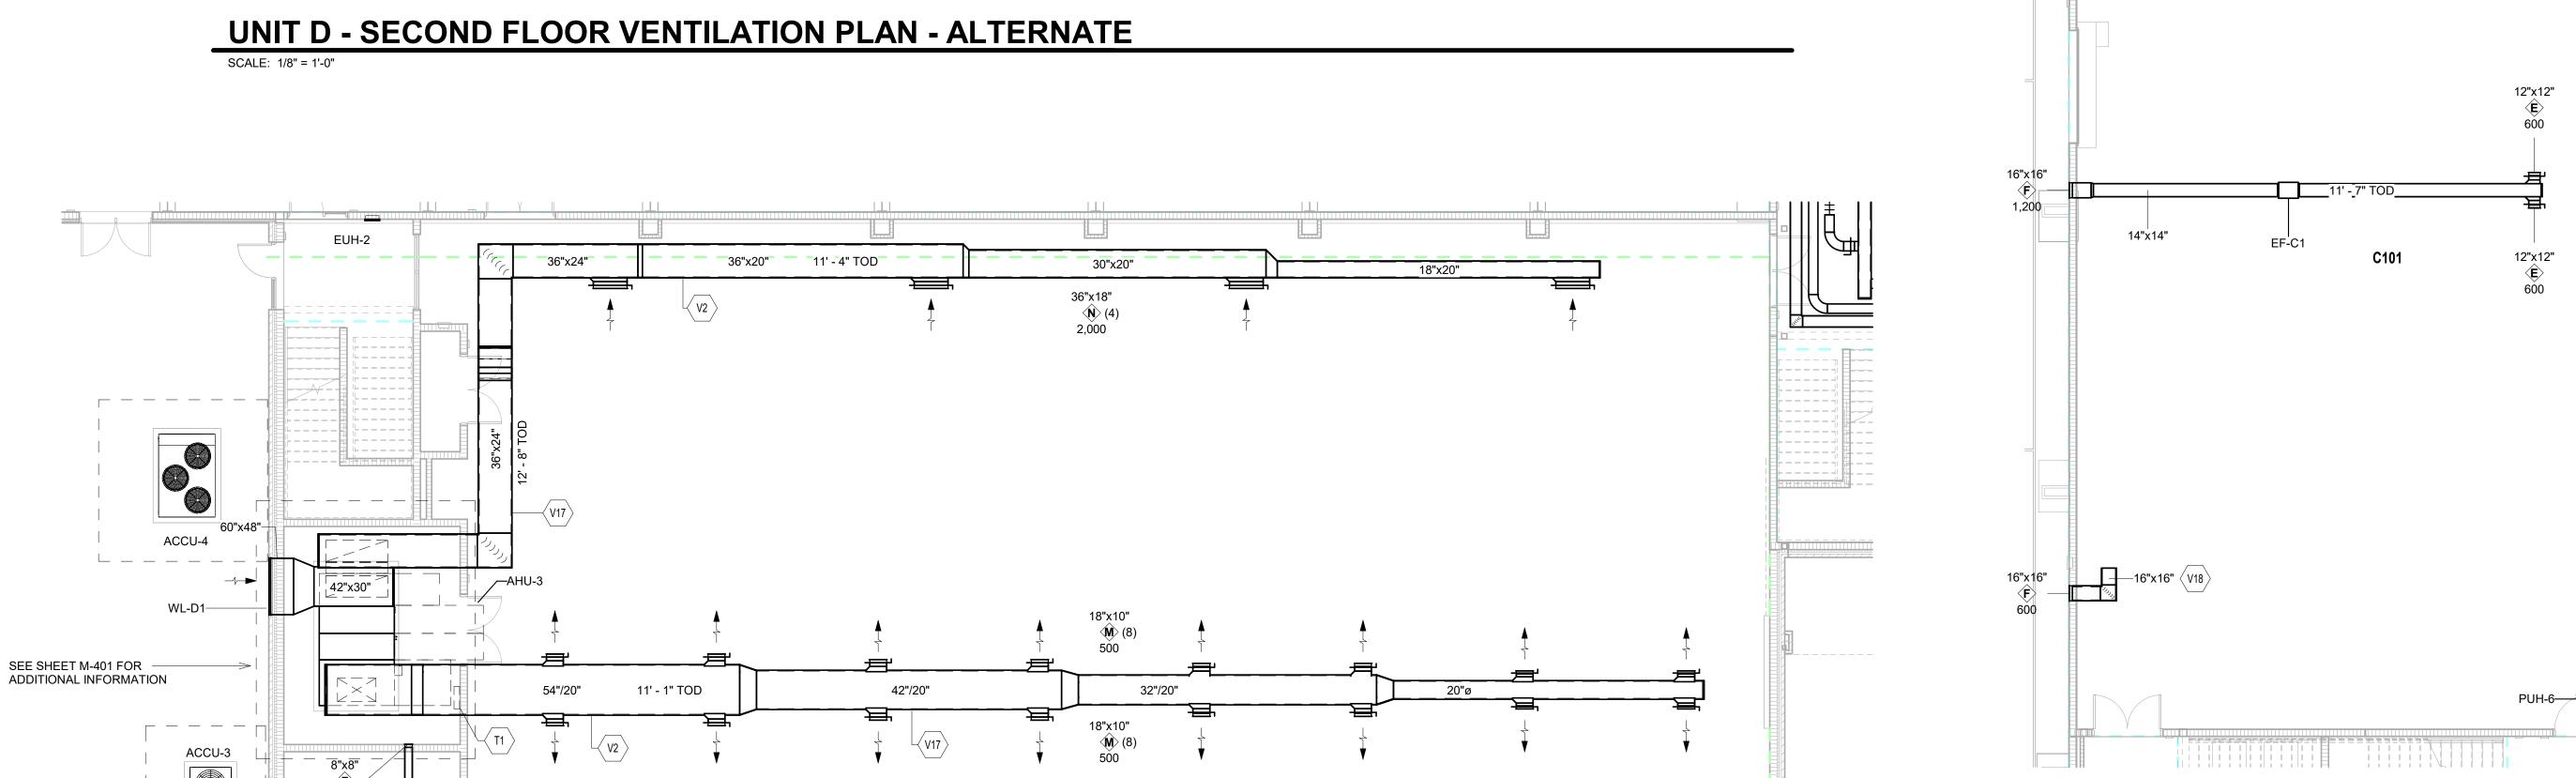



ROOM LEGEND - ALTERNATE

ROOM NAME

(SF)

518 SF

303 SF

104 SF

38 SF

289 SF

314 SF

16 SF

119 SF

187 SF

ROOM

NO.

STORAGE

WRESTLING

MECHANICAL

SOUND CLOSET

OBSERVATION

VESTIBULE

DANCE

STAIR

STAIR

STORAGE

MECHANICAL

KITCHENETTE SOUND CLOSET

STORAGE

VENTILATION PLAN GENERAL NOTES

- A. ALL DUCTWORK, PIPING AND VALVES SHALL BE CONCEALED ABOVE THE CEILING AND WITHIN WALLS,
- UNLESS OTHERWISE NOTED. B. REFER TO THE SPECIFICATIONS FOR REQUIREMENTS RELATED TO EQUIPMENT QUALITY, CONSTRUCTION AND FINISH OF MATERIALS.
- ARRANGE DUCTWORK, PIPING, ETC. TO ALLOW FOR EASY ACCESS TO COILS, VALVES, DAMPERS AND CONTROLS. KEEP AREAS ADJACENT TO ACCESS PANELS FREE AND CLEAR OF ANY OBSTRUCTIONS. SEAL DUCT PENETRATIONS THROUGH THE FLOOR AND/OR WALLS IN ACCORDANCE WITH MECHANICAL CODE AND
- SMACNA REQUIREMENTS. SEAL DUCT PENETRATIONS THROUGH FIRE RATED FLOORS AND/OR WALLS WITH A MATERIAL HAVING SAME FIRE RATING AS THE WALL AND/OR FLOOR.
- MECHANICAL CONTRACTOR IS RESPONSIBLE FOR HIS RESPECTIVE WORK FOR REPAIRING AND PATCHING TO MATCH EXISTING SURFACES, SIDEWALKS, STREETS, FLOORS, WALLS, ROOFS, CEILING AND PAVEMENT.
- ALL RECTANGULAR SHEET METAL DUCT SIZES SHOWN ARE INSIDE FREE AREA DIMENSIONS. ALL ROUND DUCT SIZES SHOWN ARE INSIDE DIAMETERS. PROVIDE BALANCING DAMPER AT EACH DUCT BRANCH, SERVING DIFFUSER, GRILLE AND REGISTER.
- INSTALL WALL THERMOSTATS, TEMPERATURE SENSORS, HUMIDISTATS, ETC. 44" ABOVE THE FINISH FLOOR IN ACCORDANCE WITH ADA REQUIREMENTS. COORDINATE ALL REQUIRED WALL, ROOF AND FLOOR OPENINGS (BOTH DIMENSIONS AND LOCATIONS) WITH ALL
- COORDINATE MECHANICAL SYSTEM INSTALLATION WITH STRUCTURE, FIRE PROTECTION AND LIGHTING LAYOUT. PROVIDE ALL NECESSARY TRANSITIONS TO EQUIPMENT
- FROM SIZES SHOWN ON PLAN. ALL RETURN/EXHAUST AIR DUCT ABOVE LOCKERS/SHOWER AREAS SHALL BE MADE OF ALUMINUM IN ACCORDANCE WITH SMACNA REQUIREMENTS.

(ALL NOTES MAY NOT BE INDICATED ON THIS SHEET) T1 APPROXIMATE LOCATION OF TEMPERATURE CONTROL PANEL. COORDINATE EXACT LOCATION WITH ALL TRADES. T11 RELIEF CONTROL DAMPER PROVIDED BY THE TEMPERATURE CONTROL CONTRACTOR AND INSTALLED BY

VENTILATION PLAN NOTES

- THE MECHANICAL CONTRACTOR, CALIBRATED AND SET TO MAINTAIN A SLIGHT POSITIVE PRESSURE WITHIN THE SPACE. TEST AND CALIBRATE RELIEF CONTROL DAMPER PRIOR TO CONSTRUCTION SUBSTANTIAL COMPLETION. INSTALL DUCTWORK AS HIGH AS POSSIBLE. HOLD TIGHT TO STRUCTURE/ STRUCTUREA

 ROUTE DUCTWORK BETWEEN/THROUGH STRUCTURAL
- STEEL. COORDINATE EXACT LOCATION WITH STRUCTURAL CONTRACTOR AND ALL OTHER TRADES. V5 COORDINATE FINAL DIFFUSER/GRILLE COLOR WITH V7 DUCT ROUTED UP TO FLOOR ABOVE. COORDINATE WITH
- V8 END OF DUCT OPENING TO SPACE. OPENING TO BE PROTECTED WITH BIRDSCREEN. V9 BAROMETRIC RELIEF DAMPER. CALIBRATED AND SET TO MAINTAIN A SLIGHT POSITIVE PRESSURE WITHIN THE
- SPACE. TEST AND CALIBRATE RELIEF DAMPER PRIOR TO CONSTRUCTION SUBSTANTIAL COMPLETION. V11 INSULATED SHEET METAL PLENUM MOUNTED BEHIND WALL LOUVER. TRANSITION BOTTOM OF DUCT AT A SLOPE DOWNWARD TO WALL LOUVER. SEAL ALL SEAMS AND EDGES WATER TIGHT. WRAP PLENUM WITH INSULATION. REFER TO DETAIL.
- V12 INSTALL DRIP PAN UNDER WALL LOUVER. PAN SHALL BE SEALED WATER TIGHT. DRIP PAN TO EXTEND A MINIMUM OF
- 8" BEYOND DUCTWORK. V14 WRAP EXHAUST FAN DUCTWORK WITH INSULATION FROM WALL LOUVER TO EXHAUST FAN.
- EXPOSED DUCTWORK AND ASSOCIATED AIR DEVICES TO COLOR SELECTED BY THE ARCHITECT. COORDINATE WITH
- V18 DUCTWORK PROVIDED WITH INTERNAL LINED INSULATION. REFER TO SPECIFICATIONS.

STRUCTURAL IN AREA.

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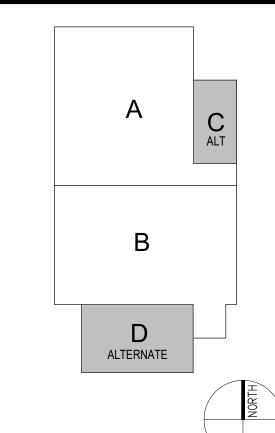
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KEY PLAN


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VERIFICATION NOTE

CONTRACTOR SHALL VERIFY ALL DIMENSIONS AND CLEARANCES AND ALL EXISTING FIELD CONDITIONS BEFORE STARTING CONSTRUCTION. COMMENCEMENT OF WORK CONSTITUTES ACCEPTANCE OF CONDITIONS.

SHOULD DIFFERENT CONDITIONS BE ENCOUNTERED, CONTACT THE ARCHITECT BEFORE PROCEEDING WITH WORK.

VENTILATION PLAN - UNIT C & D (ALTERNATE)

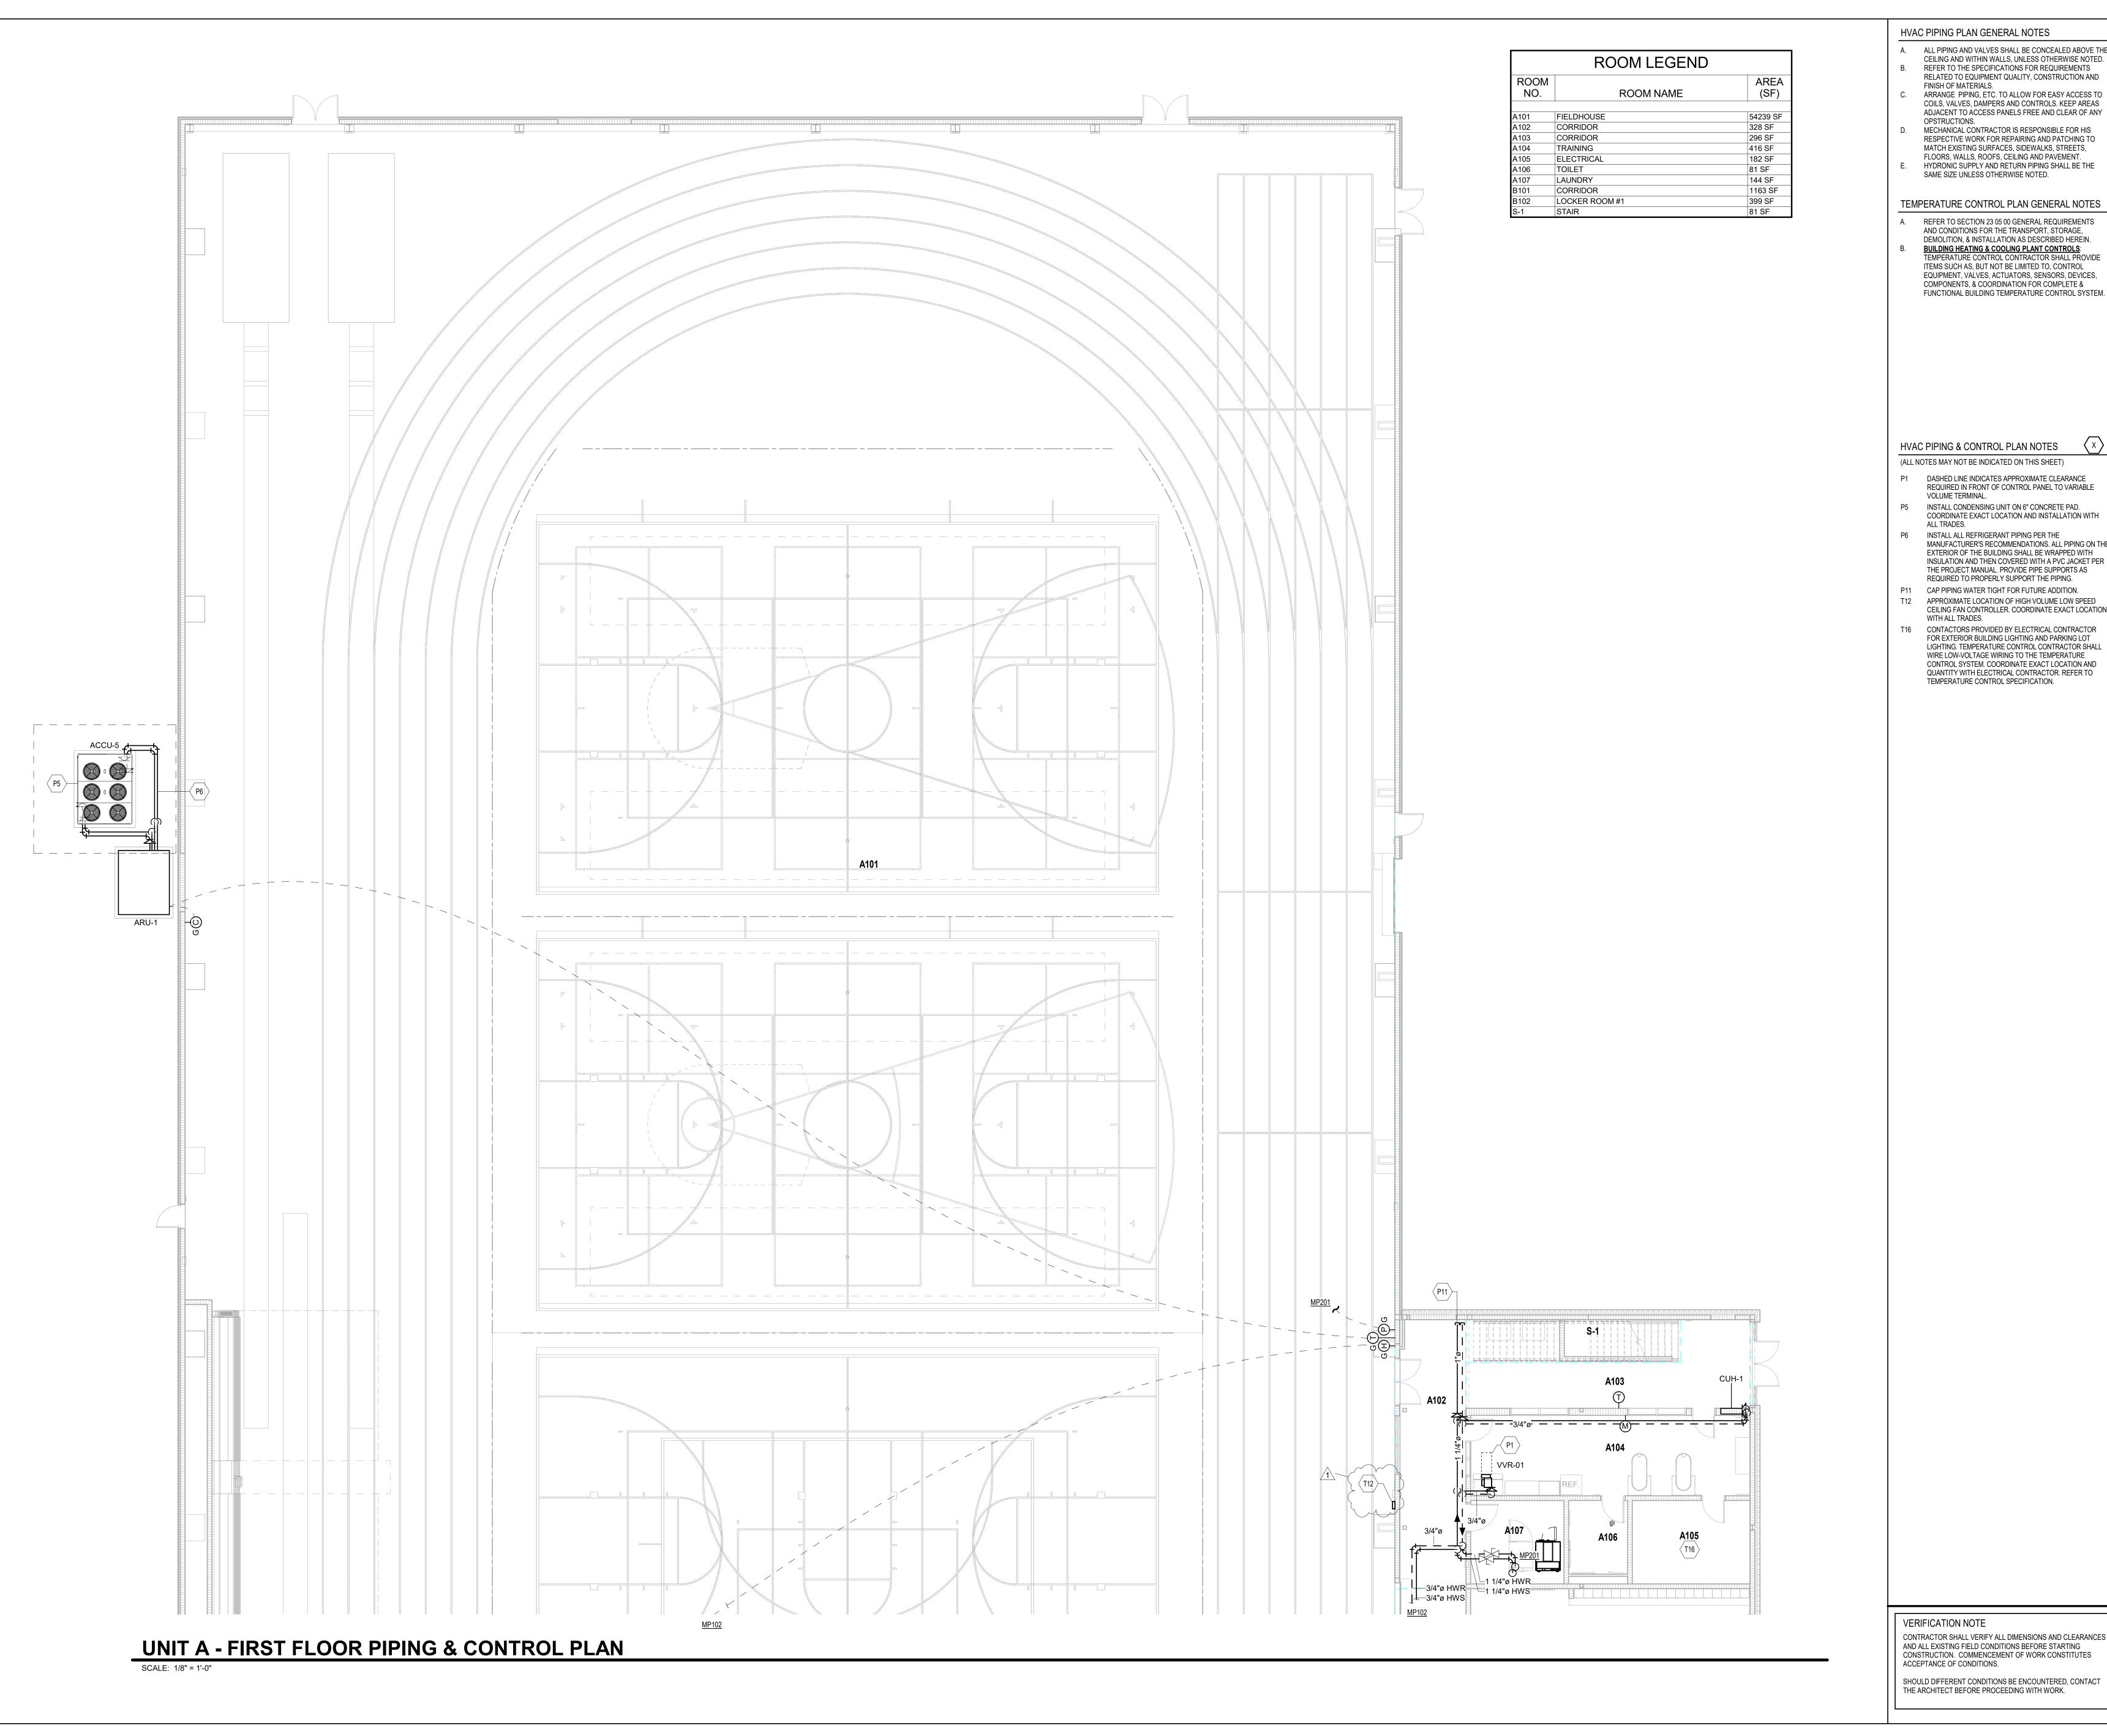

HVAC PIPING PLAN GENERAL NOTES

A. ALL PIPING AND VALVES SHALL BE CONCEALED ABOVE THE CEILING AND WITHIN WALLS, UNLESS OTHERWISE NOTED.

- REFER TO THE SPECIFICATIONS FOR REQUIREMENTS RELATED TO EQUIPMENT QUALITY, CONSTRUCTION AND
- FINISH OF MATERIALS. ARRANGE PIPING, ETC. TO ALLOW FOR EASY ACCESS TO
- ADJACENT TO ACCESS PANELS FREE AND CLEAR OF ANY OPSTRUCTIONS. MECHANICAL CONTRACTOR IS RESPONSIBLE FOR HIS RESPECTIVE WORK FOR REPAIRING AND PATCHING TO MATCH EXISTING SURFACES, SIDEWALKS, STREETS,
- FLOORS, WALLS, ROOFS, CEILING AND PAVEMENT. E. HYDRONIC SUPPLY AND RETURN PIPING SHALL BE THE SAME SIZE UNLESS OTHERWISE NOTED.

TEMPERATURE CONTROL PLAN GENERAL NOTES

A. REFER TO SECTION 23 05 00 GENERAL REQUIREMENTS AND CONDITIONS FOR THE TRANSPORT, STORAGE, DEMOLITION, & INSTALLATION AS DESCRIBED HEREIN. **BUILDING HEATING & COOLING PLANT CONTROLS**: TEMPERATURE CONTROL CONTRACTOR SHALL PROVIDE ITEMS SUCH AS, BUT NOT BE LIMITED TO, CONTROL

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SCHOOL

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HVAC PIPING & CONTROL PLAN NOTES (ALL NOTES MAY NOT BE INDICATED ON THIS SHEET)


- P1 DASHED LINE INDICATES APPROXIMATE CLEARANCE REQUIRED IN FRONT OF CONTROL PANEL TO VARIABLE
- VOLUME TERMINAL. P5 INSTALL CONDENSING UNIT ON 6" CONCRETE PAD. COORDINATE EXACT LOCATION AND INSTALLATION WITH
- P6 INSTALL ALL REFRIGERANT PIPING PER THE MANUFACTURER'S RECOMMENDATIONS. ALL PIPING ON THE EXTERIOR OF THE BUILDING SHALL BE WRAPPED WITH INSULATION AND THEN COVERED WITH A PVC JACKET PER
- P11 CAP PIPING WATER TIGHT FOR FUTURE ADDITION. T12 APPROXIMATE LOCATION OF HIGH VOLUME LOW SPEED CEILING FAN CONTROLLER. COORDINATE EXACT LOCATION WITH ALL TRADES.
- T16 CONTACTORS PROVIDED BY ELECTRICAL CONTRACTOR FOR EXTERIOR BUILDING LIGHTING AND PARKING LOT LIGHTING. TEMPERATURE CONTROL CONTRACTOR SHALL WIRE LOW-VOLTAGE WIRING TO THE TEMPERATURE CONTROL SYSTEM. COORDINATE EXACT LOCATION AND QUANTITY WITH ELECTRICAL CONTRACTOR. REFER TO TEMPERATURE CONTROL SPECIFICATION.

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ARCHITECT


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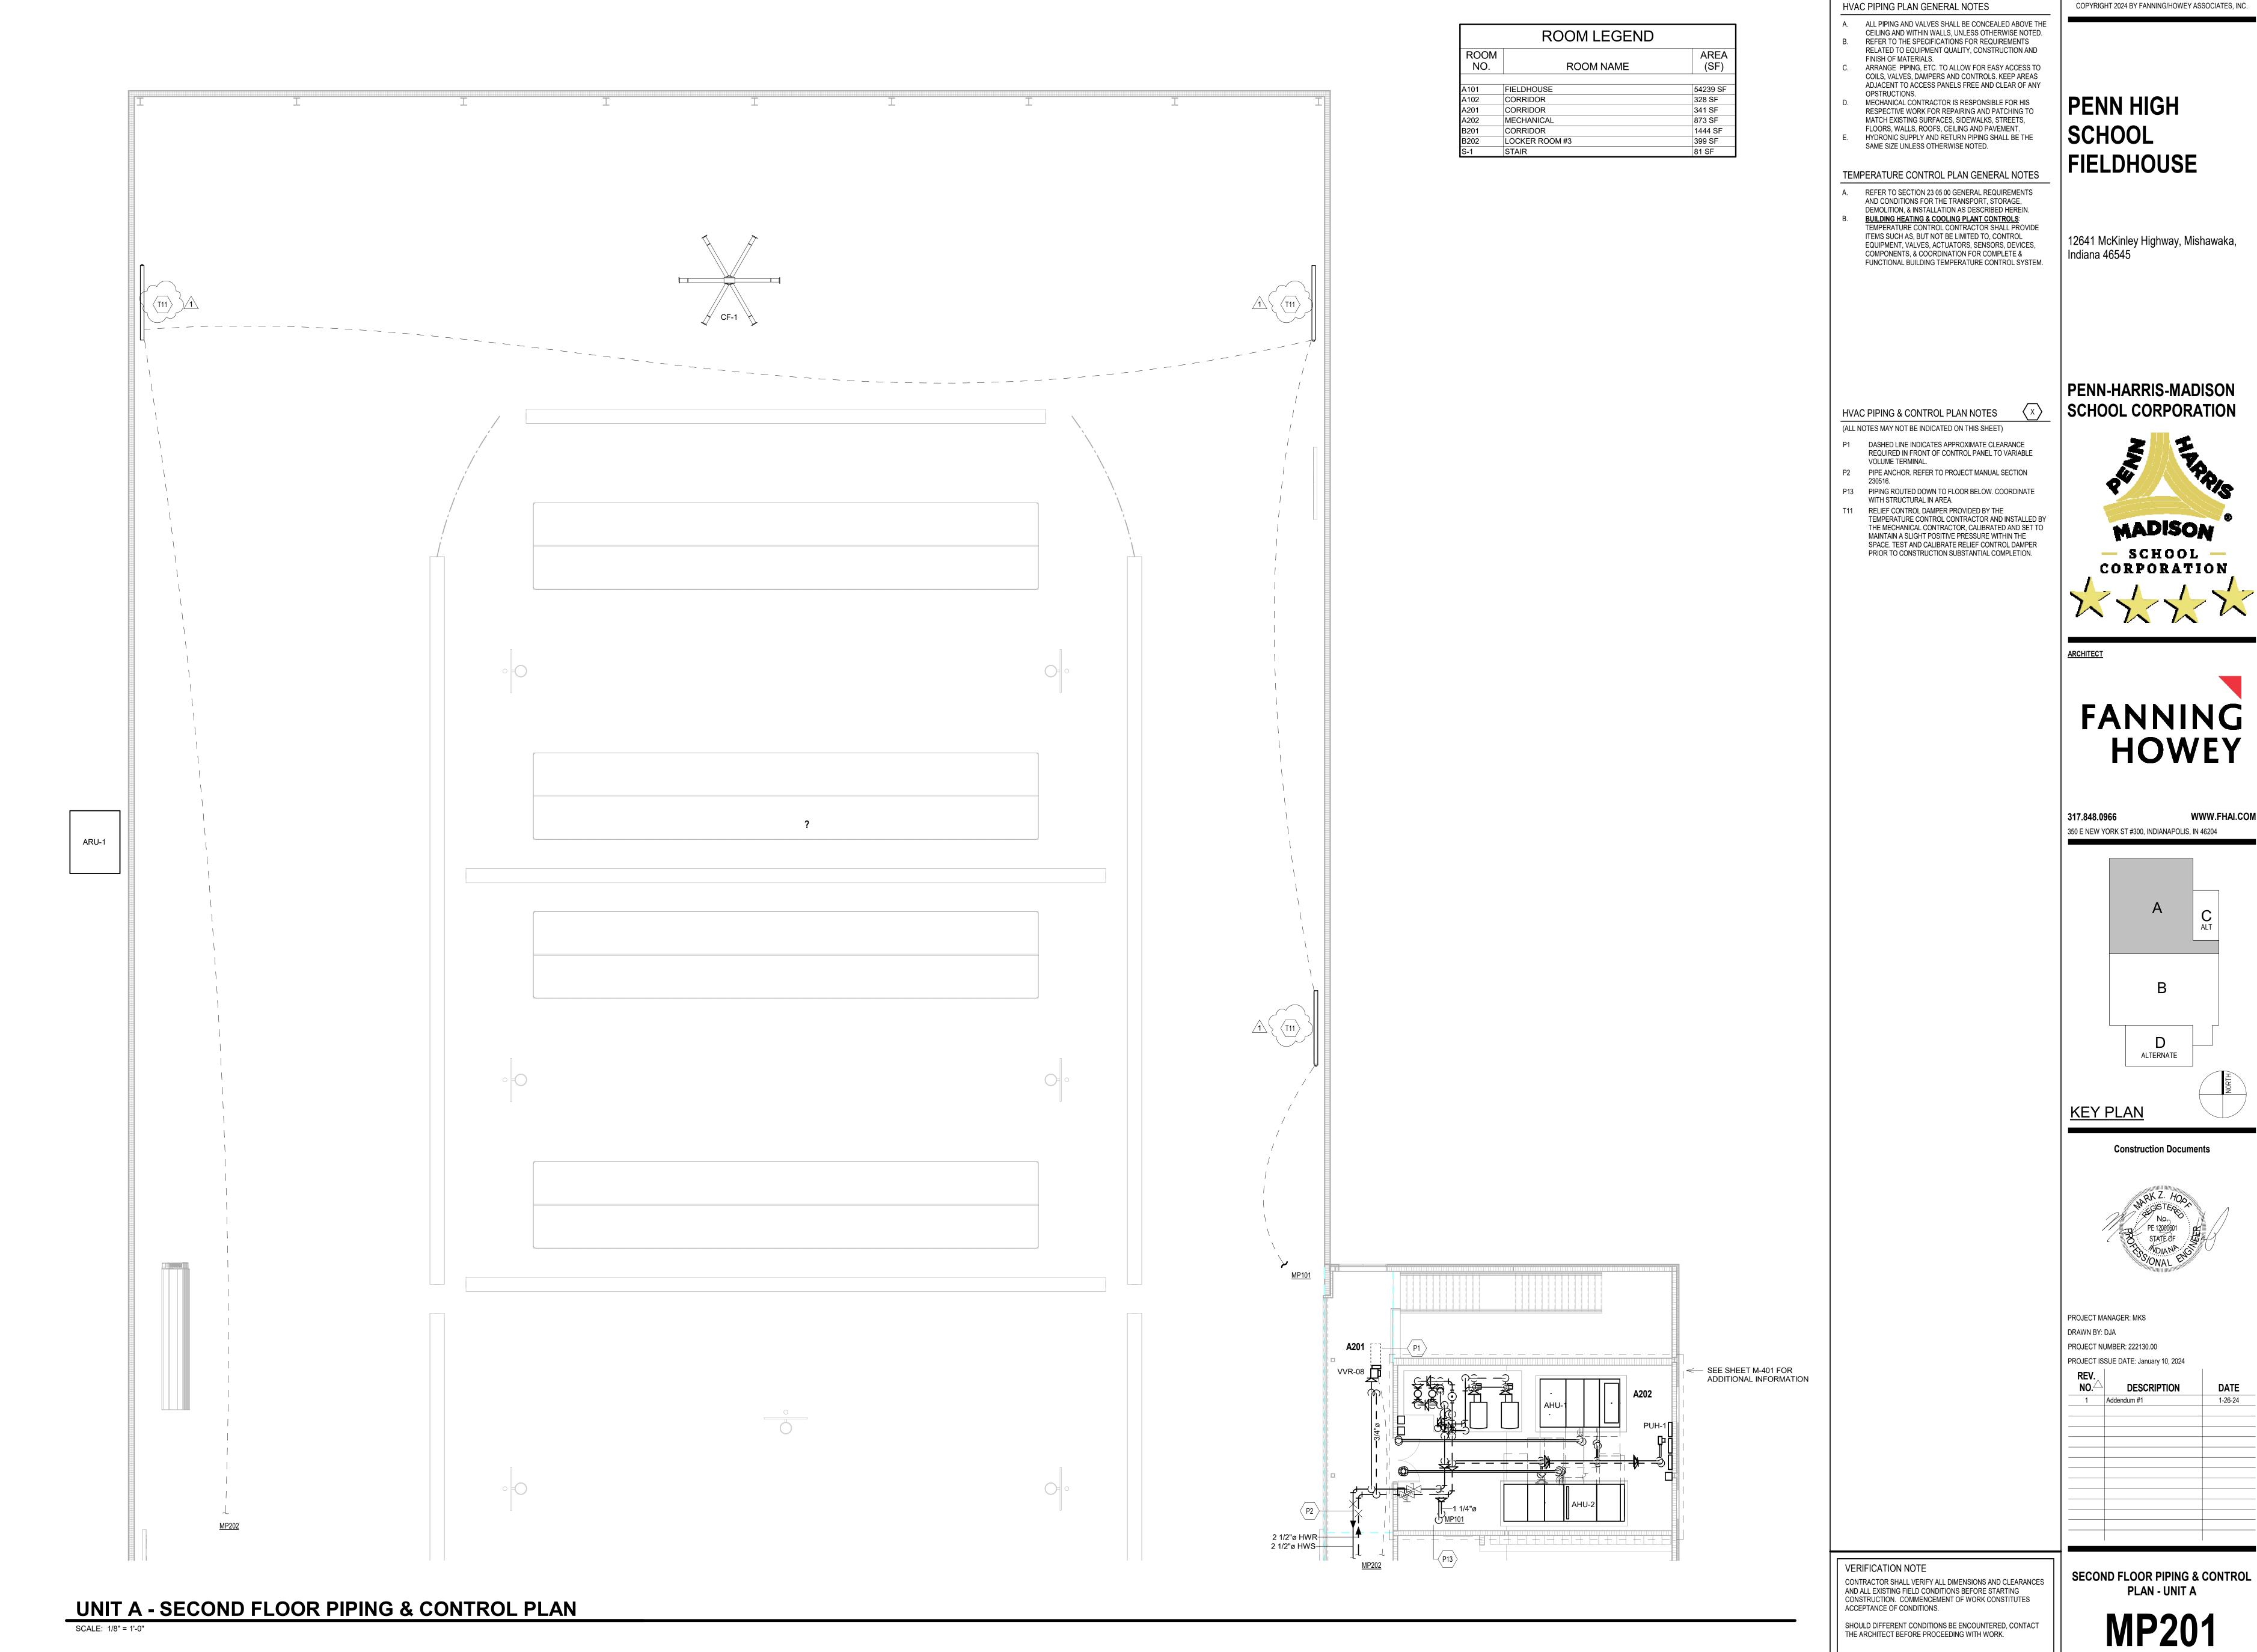
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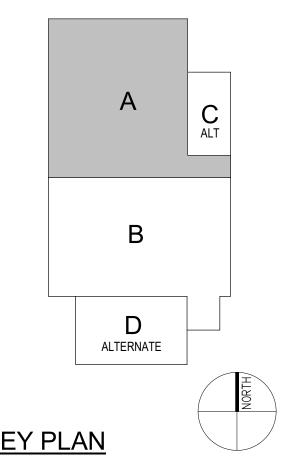
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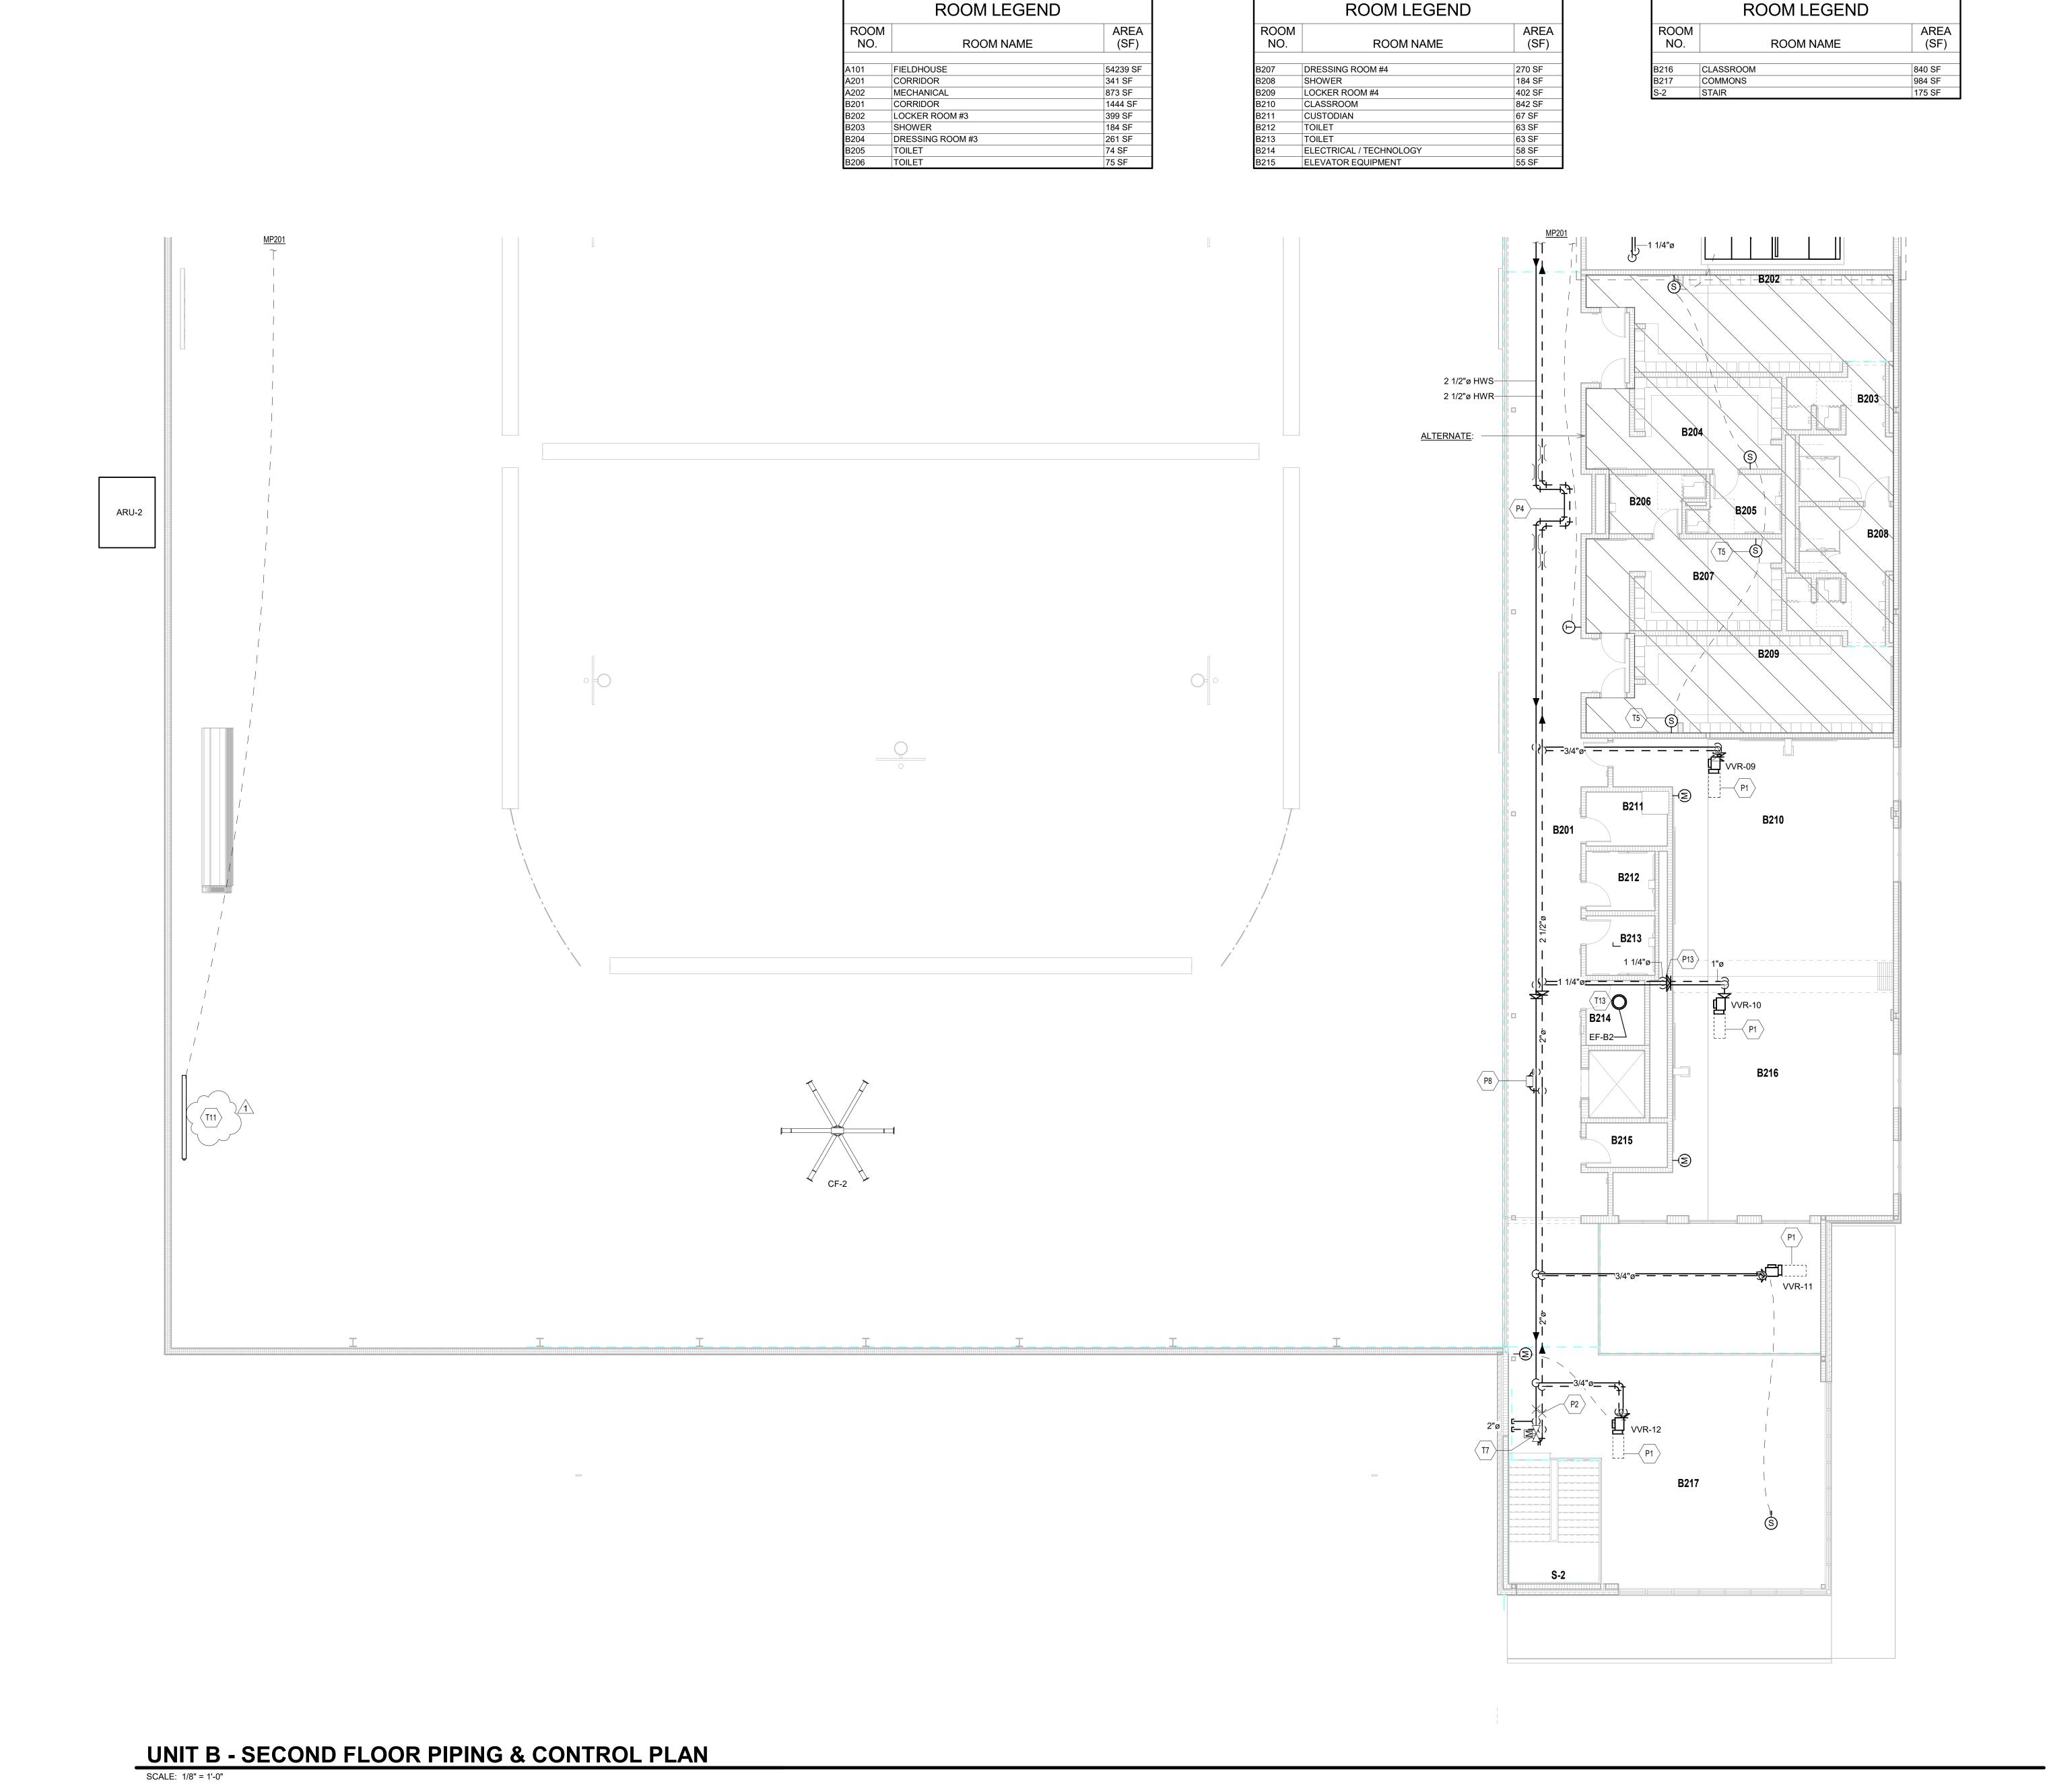
FIRST FLOOR PIPING & CONTROL PLAN - UNIT A



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NO.	DESCRIPTION	DATE
1	Addendum #1	1-26-24
	I	I

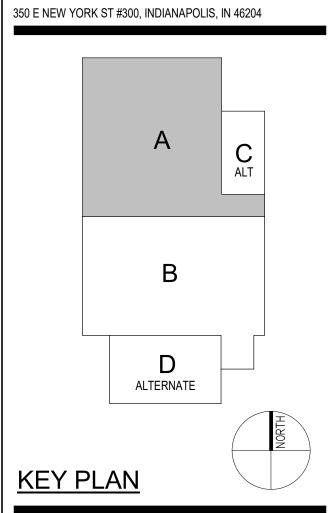

HVAC PIPING PLAN GENERAL NOTES

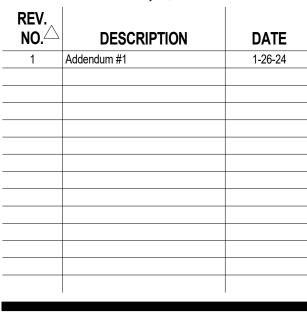- A. ALL PIPING AND VALVES SHALL BE CONCEALED ABOVE THE CEILING AND WITHIN WALLS, UNLESS OTHERWISE NOTED.

 B. REFER TO THE SPECIFICATIONS FOR REQUIREMENTS
 - REFER TO THE SPECIFICATIONS FOR REQUIREMENTS
 RELATED TO EQUIPMENT QUALITY, CONSTRUCTION AND
 FINISH OF MATERIALS.
 ARRANGE PIPING, ETC. TO ALLOW FOR EASY ACCESS TO
- COILS, VALVES, DAMPERS AND CONTROLS. KEEP AREAS
 ADJACENT TO ACCESS PANELS FREE AND CLEAR OF ANY
 OPSTRUCTIONS.

 D. MECHANICAL CONTRACTOR IS RESPONSIBLE FOR HIS
 RESPECTIVE WORK FOR REPAIRING AND PATCHING TO
- D. MECHANICAL CONTRACTOR IS RESPONSIBLE FOR HIS RESPECTIVE WORK FOR REPAIRING AND PATCHING TO MATCH EXISTING SURFACES, SIDEWALKS, STREETS, FLOORS, WALLS, ROOFS, CEILING AND PAVEMENT.

 E. HYDRONIC SUPPLY AND RETURN PIPING SHALL BE THE SAME SIZE UNLESS OTHERWISE NOTED.

TEMPERATURE CONTROL PLAN GENERAL NOTES

A. REFER TO SECTION 23 05 00 GENERAL REQUIREMENTS
AND CONDITIONS FOR THE TRANSPORT, STORAGE,
DEMOLITION, & INSTALLATION AS DESCRIBED HEREIN.

B. BUILDING HEATING & COOLING PLANT CONTROLS:
TEMPERATURE CONTROL CONTRACTOR SHALL PROVIDE
ITEMS SUCH AS, BUT NOT BE LIMITED TO, CONTROL
EQUIPMENT, VALVES, ACTUATORS, SENSORS, DEVICES,
COMPONENTS, & COORDINATION FOR COMPLETE &

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HVAC PIPING & CONTROL PLAN NOTES (ALL NOTES MAY NOT BE INDICATED ON THIS SHEET)

FUNCTIONAL BUILDING TEMPERATURE CONTROL SYSTEM.

- P1 DASHED LINE INDICATES APPROXIMATE CLEARANCE REQUIRED IN FRONT OF CONTROL PANEL TO VARIABLE
- VOLUME TERMINAL.
 P2 PIPE ANCHOR. REFER TO PROJECT MANUAL SECTION
 230546.
 P4 NESTED HOSE AND BRAID PIPE EXPANSION LOOP SIZED
- P8 DIFFERENTIAL PRESSURE TRANSMITTER FOR HEATING WATER VARIABLE VOLUME PUMP CONTROL. TRANSMITTER PROVIDED BY TEMPERATURE CONTROL CONTRACTOR AND INSTALLED BY HVAC CONTRACTOR

FOR EXPANSION. REFER TO DETAIL.

- P13 PIPING ROUTED DOWN TO FLOOR BELOW. COORDINATE WITH STRUCTURAL IN AREA.

 TEMPERATURE CONTROL CONTRACTOR SHALL PROVIDE AVERAGING THERMOSTATS.
- T7 APPROXIMATE LOCATION OF 2-WAY MODULATING HEATING WATER CONTROL VALVE. SET TO MINIMUM FLOW THROUGHOUT THE HEATING SYSTEM (25 GPM). IF WRESTLING/DANCE ADDITION IS APPROVED THIS CAN BE
- ELIMINATED.

 T11 RELIEF CONTROL DAMPER PROVIDED BY THE
 TEMPERATURE CONTROL CONTRACTOR AND INSTALLED BY
 THE MECHANICAL CONTRACTOR, CALIBRATED AND SET TO
 MAINTAIN A SLIGHT POSITIVE PRESSURE WITHIN THE
- MAINTAIN A SLIGHT POSITIVE PRESSURE WITHIN THE SPACE. TEST AND CALIBRATE RELIEF CONTROL DAMPER RRIOR TO CONSTRUCTION SUBSTANTIAL COMPLETION.

 T13 EXHAUST FAN SHALL BE CONTROLLED VIA LOCAL TIMER SWITCH.

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ARCHITECT

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A

C
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B

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ALT

KEY PLAN

Construction Documents



PROJECT MANAGER: MKS

DRAWN BY: DJA

PROJECT NUMBER: 222130.00

PROJECT ISSUE DATE: January 10, 2024

REV.

NO.	DESCRIPTION	DATE
1	Addendum #1	1-26-24


VERIFICATION NOTE

CONTRACTOR SHALL VERIFY ALL DIMENSIONS AND CLEARANCES AND ALL EXISTING FIELD CONDITIONS BEFORE STARTING CONSTRUCTION. COMMENCEMENT OF WORK CONSTITUTES ACCEPTANCE OF CONDITIONS.


SHOULD DIFFERENT CONDITIONS BE ENCOUNTERED, CONTACT THE ARCHITECT BEFORE PROCEEDING WITH WORK.

SECOND FLOOR PIPING & CONTROL PLAN - UNIT B


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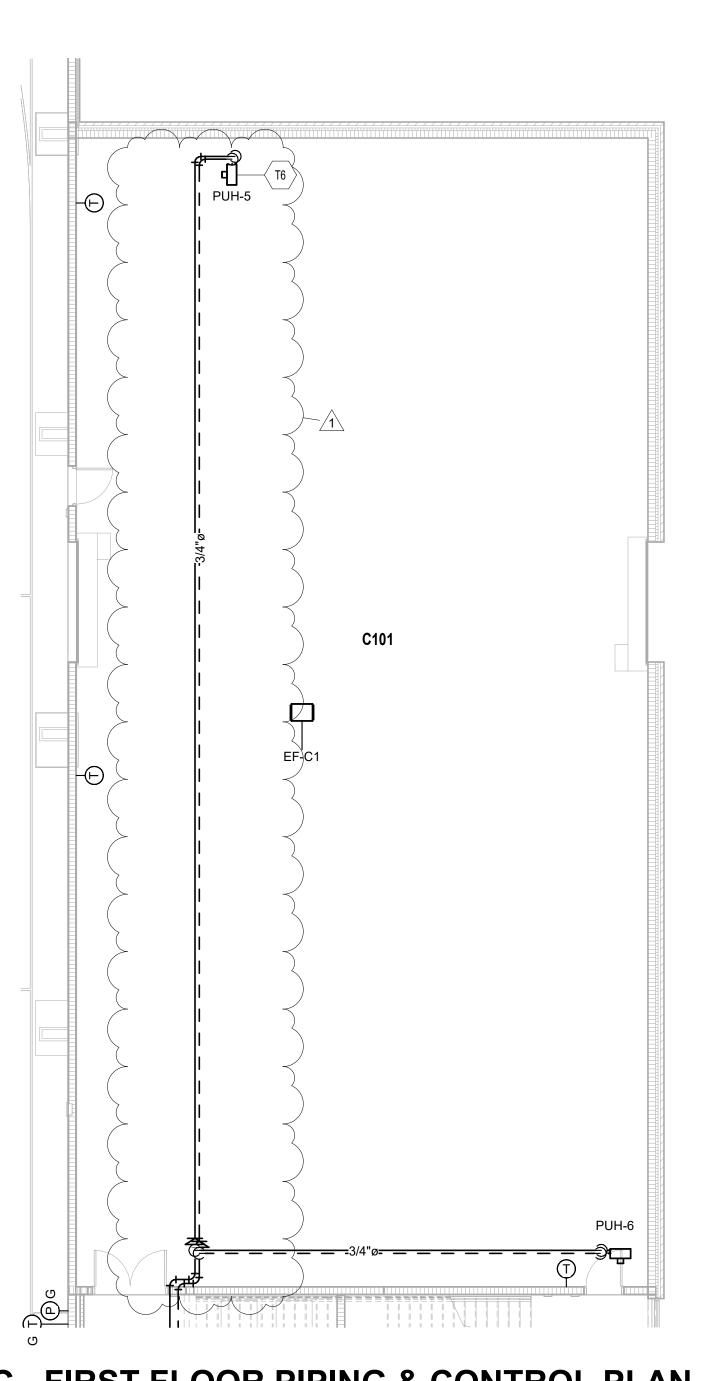
UNIT D - SECOND FLOOR PIPING & CONTROL PLAN -**ALTERNATE**

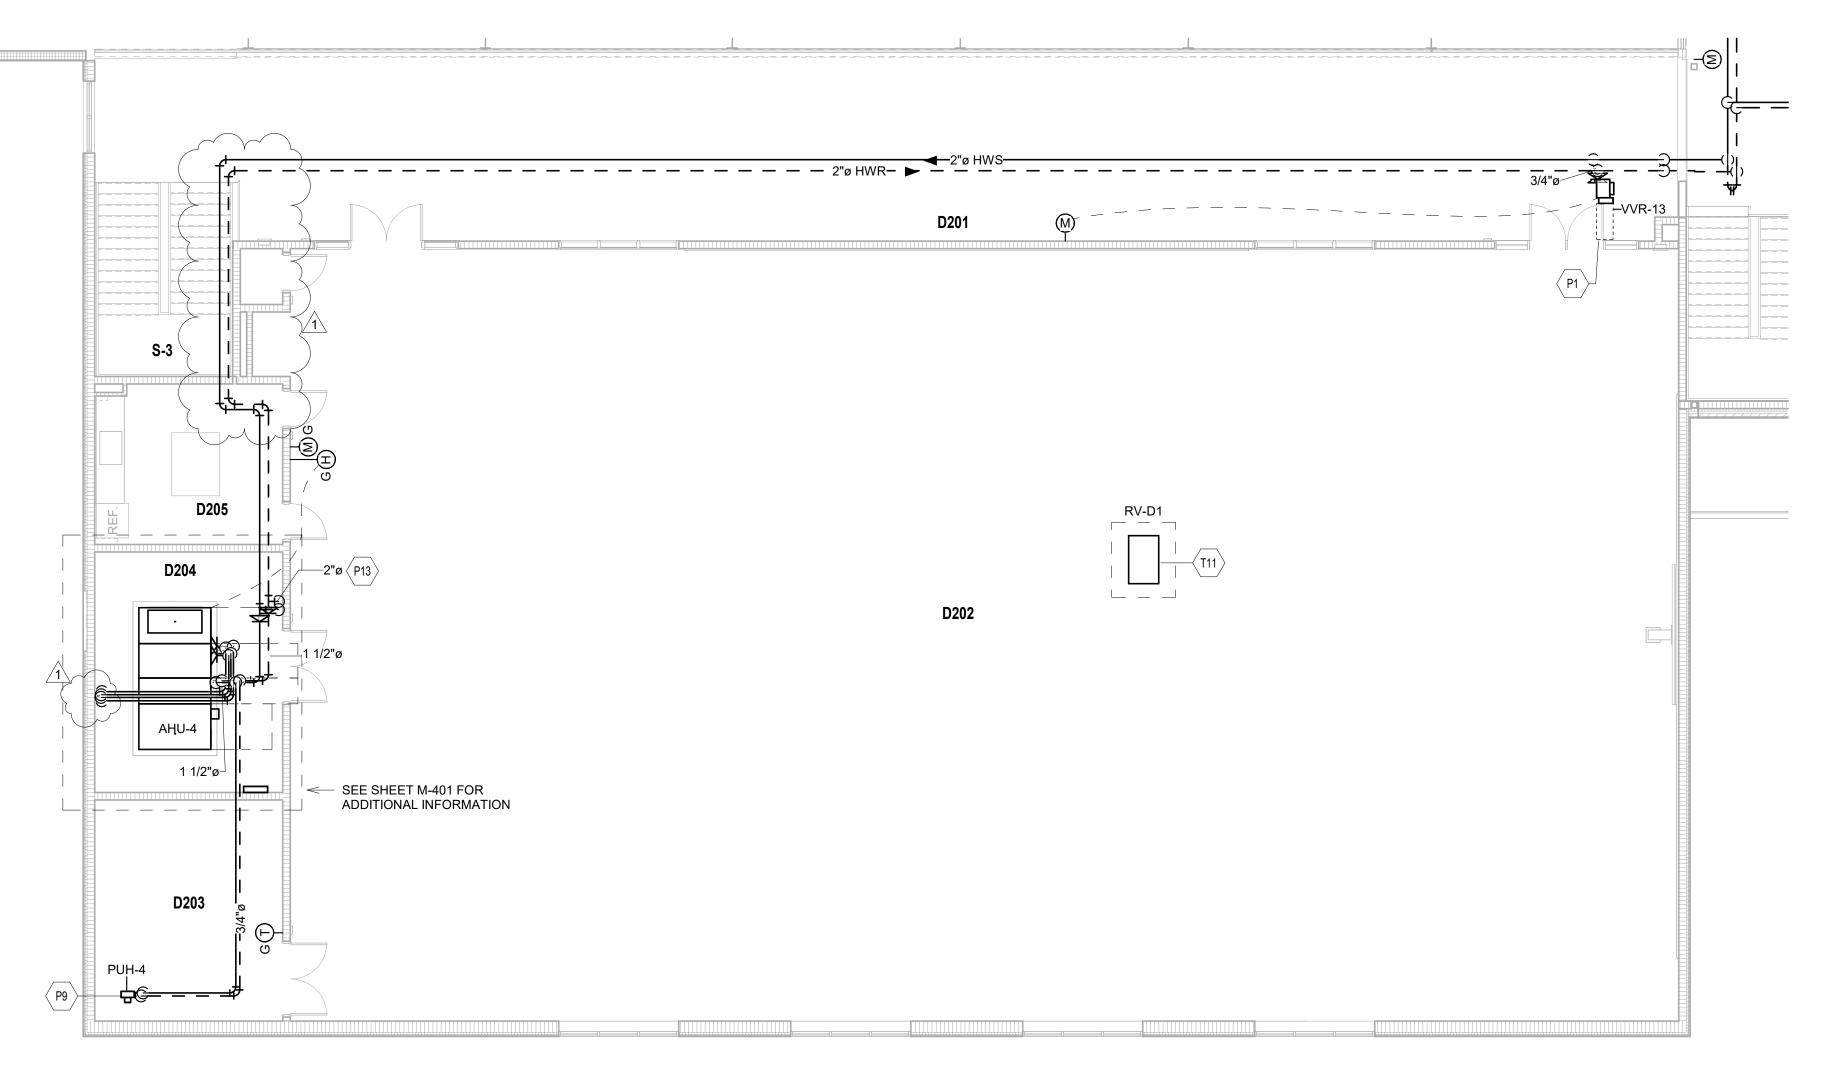

UNIT D - FIRST FLOOR PIPING & CONTROL PLAN - ALTERNATE

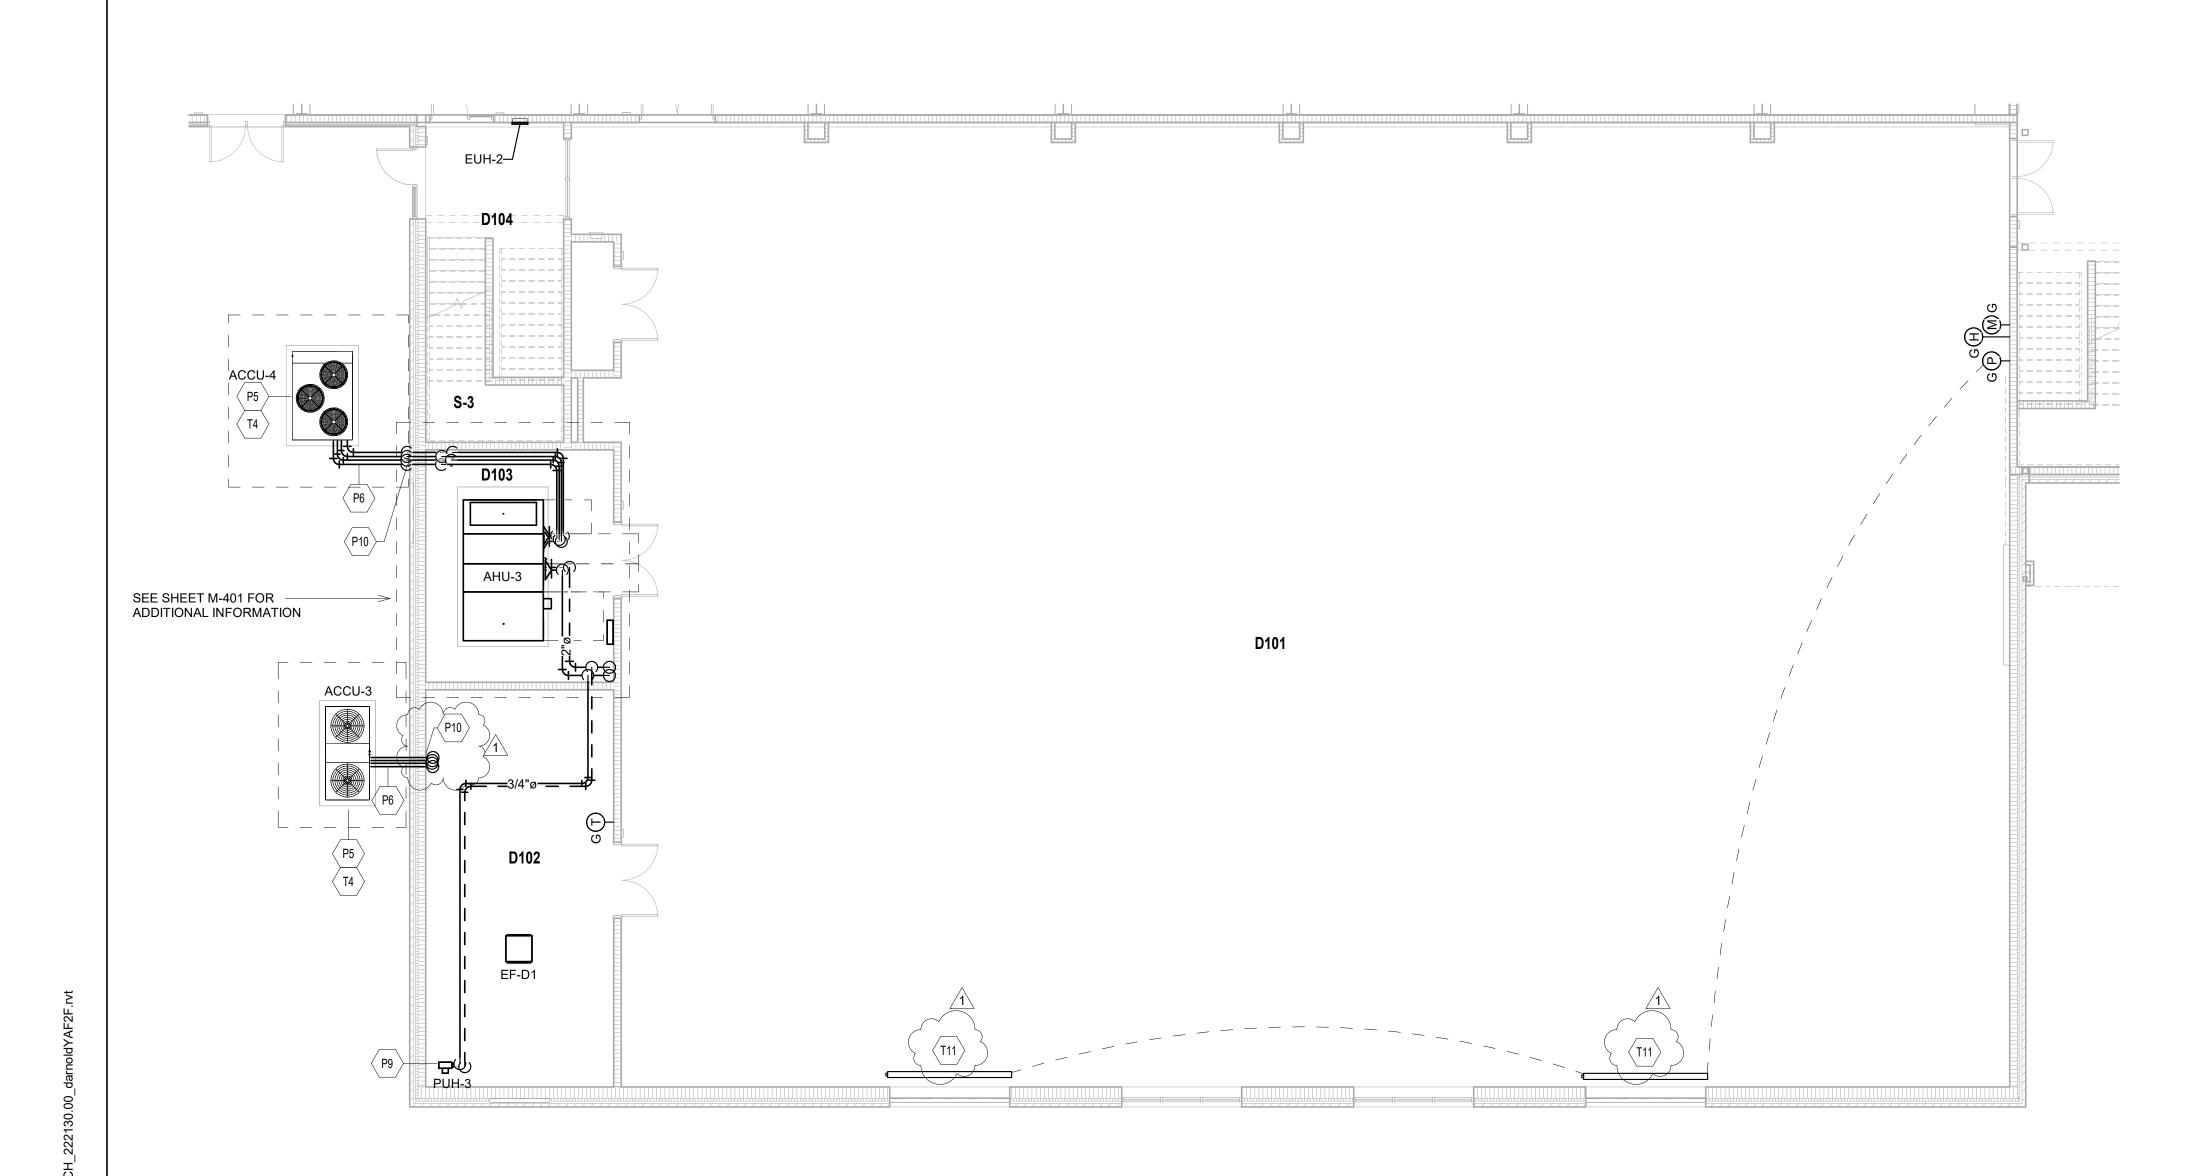

ROOM LEGEND - ALTERNATE

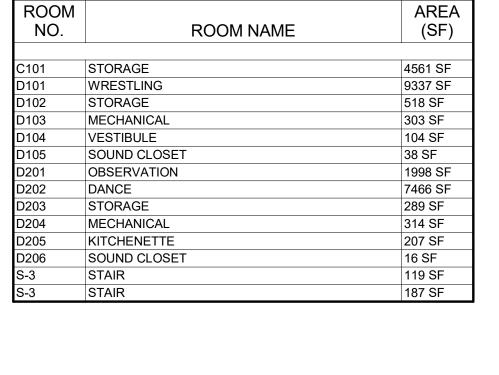

UNIT C - FIRST FLOOR PIPING & CONTROL PLAN - ALTERNATE

HVAC PIPING PLAN GENERAL NOTES

- A. ALL PIPING AND VALVES SHALL BE CONCEALED ABOVE THE CEILING AND WITHIN WALLS, UNLESS OTHERWISE NOTED.
- REFER TO THE SPECIFICATIONS FOR REQUIREMENTS RELATED TO EQUIPMENT QUALITY, CONSTRUCTION AND FINISH OF MATERIALS. ARRANGE PIPING, ETC. TO ALLOW FOR EASY ACCESS TO

COILS, VALVES, DAMPERS AND CONTROLS. KEEP AREAS

- ADJACENT TO ACCESS PANELS FREE AND CLEAR OF ANY OPSTRUCTIONS. MECHANICAL CONTRACTOR IS RESPONSIBLE FOR HIS RESPECTIVE WORK FOR REPAIRING AND PATCHING TO
 - MATCH EXISTING SURFACES, SIDEWALKS, STREETS, FLOORS, WALLS, ROOFS, CEILING AND PAVEMENT. HYDRONIC SUPPLY AND RETURN PIPING SHALL BE THE SAME SIZE UNLESS OTHERWISE NOTED.

TEMPERATURE CONTROL PLAN GENERAL NOTES

FUNCTIONAL BUILDING TEMPERATURE CONTROL SYSTEM.

A. REFER TO SECTION 23 05 00 GENERAL REQUIREMENTS AND CONDITIONS FOR THE TRANSPORT, STORAGE, DEMOLITION, & INSTALLATION AS DESCRIBED HEREIN. **BUILDING HEATING & COOLING PLANT CONTROLS**: TEMPERATURE CONTROL CONTRACTOR SHALL PROVIDE ITEMS SUCH AS, BUT NOT BE LIMITED TO, CONTROL EQUIPMENT, VALVES, ACTUATORS, SENSORS, DEVICES, COMPONENTS, & COORDINATION FOR COMPLETE &

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HVAC PIPING & CONTROL PLAN NOTES (ALL NOTES MAY NOT BE INDICATED ON THIS SHEET)

- P1 DASHED LINE INDICATES APPROXIMATE CLEARANCE REQUIRED IN FRONT OF CONTROL PANEL TO VARIABLE
- VOLUME TERMINAL. P5 INSTALL CONDENSING UNIT ON 6" CONCRETE PAD.
- COORDINATE EXACT LOCATION AND INSTALLATION WITH ALL TRADES. P6 INSTALL ALL REFRIGERANT PIPING PER THE MANUFACTURER'S RECOMMENDATIONS. ALL PIPING ON THE
- EXTERIOR OF THE BUILDING SHALL BE WRAPPED WITH INSULATION AND THEN COVERED WITH A PVC JACKET PER THE PROJECT MANUAL. PROVIDE PIPE SUPPORTS AS REQUIRED TO PROPERLY SUPPORT THE PIPING. P9 SUPPORT UNIT HEATER FROM STRUCTURE ABOVE WITH
- SUPPLEMENTAL STEEL AND THREADED ROD AS REQUIRED. COORDINATE FINAL HEIGHT IN FIELD. P10 ROUTE REFRIGERANT PIPING THROUGH THE WALL OR THROUGH ROOF. SEAL ALL AROUND THE PIPING.
- P13 PIPING ROUTED DOWN TO FLOOR BELOW. COORDINATE WITH STRUCTURAL IN AREA.
- T4 TEMPERATURE CONTROL CONTRACTOR SHALL PROVIDE INTERCONNECTING CONTROL WIRING TO OUTDOOR CONDENSING UNIT.
- T6 APPROXIMATE LOCATION OF 3-WAY MODULATING HEATING WATER CONTROL VALVE.
- T11 RELIEF CONTROL DAMPER PROVIDED BY THE TEMPERATURE CONTROL CONTRACTOR AND INSTALLED BY THE MECHANICAL CONTRACTOR CALIBRATED AND SET TO SPACE. TEST AND CALIBRATE RELIEF CONTROL DAMPER PRIOR TO CONSTRUCTION SUBSTANTIAL COMPLETION.

PENN-HARRIS-MADISON SCHOOL CORPORATION



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350 E NEW YORK ST #300, INDIANAPOLIS, IN 46204 KEY PLAN

Construction Documents



PROJECT MANAGER: MKS DRAWN BY: DJA PROJECT NUMBER: 222130.00 PROJECT ISSUE DATE: January 10, 2024

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1	Addendum #1	1-26-24


VERIFICATION NOTE

CONTRACTOR SHALL VERIFY ALL DIMENSIONS AND CLEARANCES AND ALL EXISTING FIELD CONDITIONS BEFORE STARTING CONSTRUCTION. COMMENCEMENT OF WORK CONSTITUTES ACCEPTANCE OF CONDITIONS.

SHOULD DIFFERENT CONDITIONS BE ENCOUNTERED, CONTACT THE ARCHITECT BEFORE PROCEEDING WITH WORK.

PIPING & CONTROL PLAN - UNIT C & D (ALTERNATE)

MP203

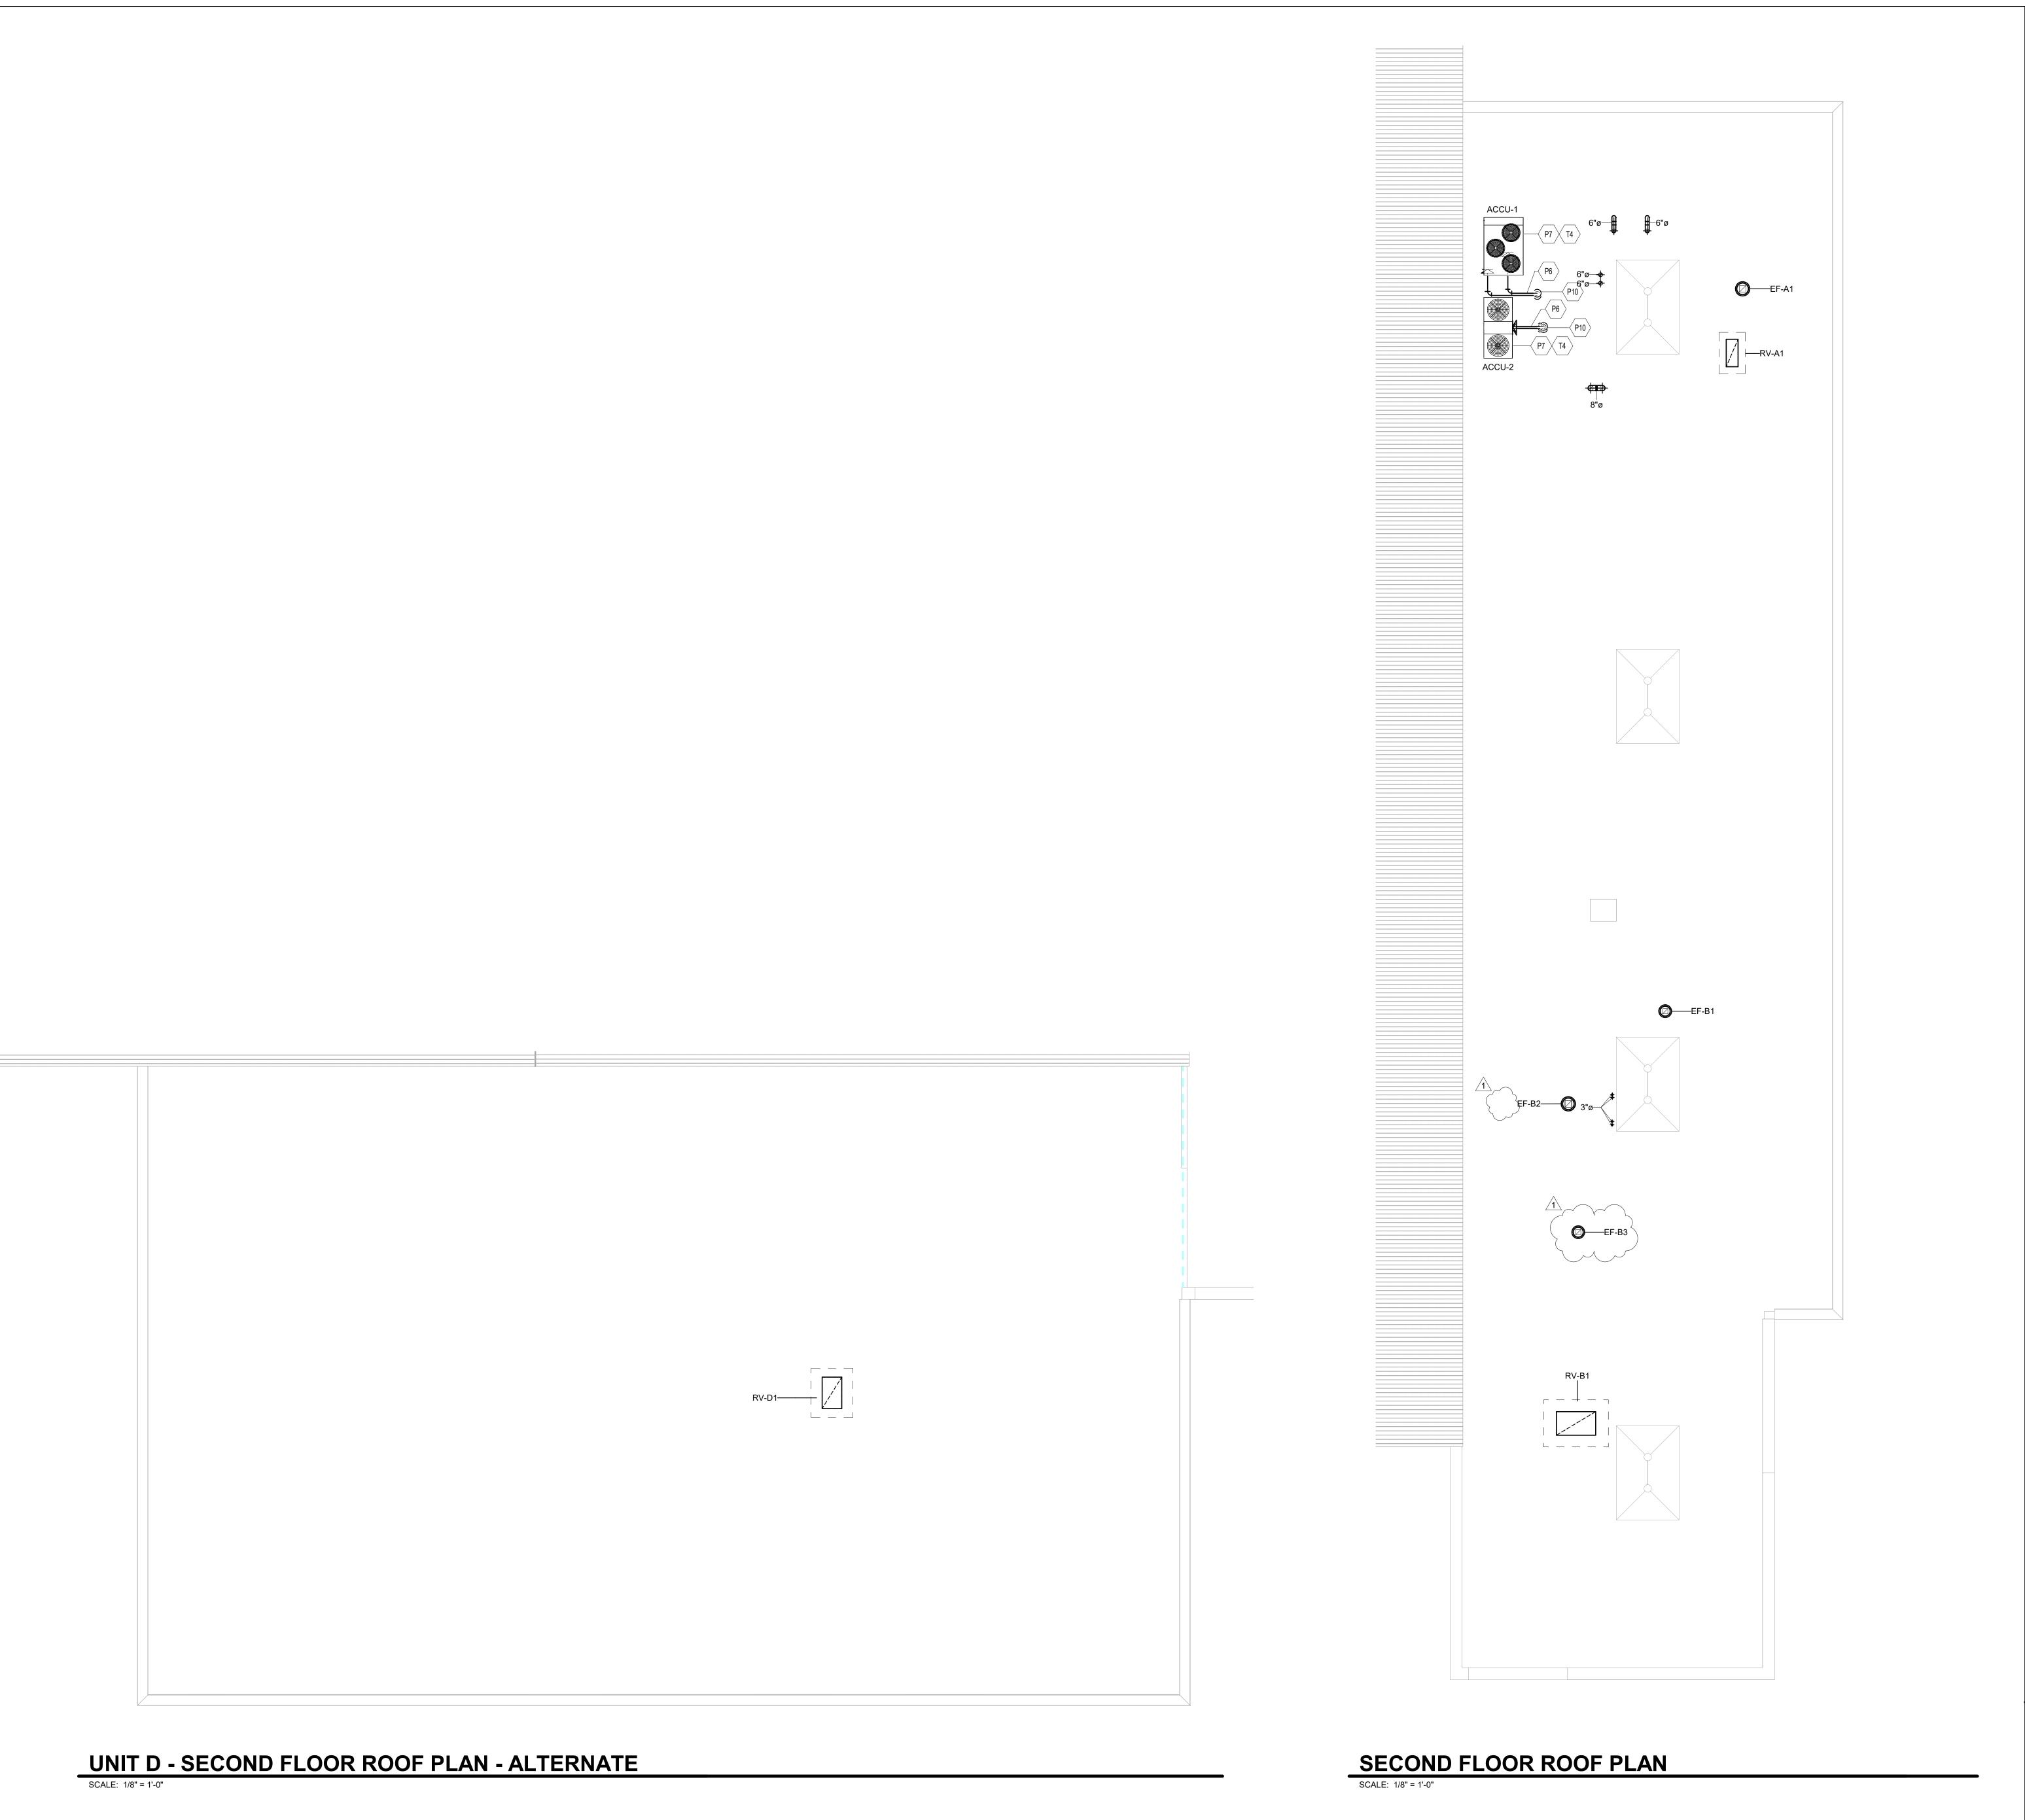

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MECHANICAL ROOF PLAN NOTES

(ALL NOTES MAY NOT BE INDICATED ON THIS SHEET)

- P6 INSTALL ALL REFRIGERANT PIPING PER THE
 MANUFACTURER'S RECOMMENDATIONS. ALL PIPING ON THE
 EXTERIOR OF THE BUILDING SHALL BE WRAPPED WITH
 INSULATION AND THEN COVERED WITH A PVC JACKET PER
 THE PROJECT MANUAL. PROVIDE PIPE SUPPORTS AS
 REQUIRED TO PROPERLY SUPPORT THE PIPING.
- P7 CONDENSING UNIT MOUNTED ON ROOF. INSTALLED ON INSULATED VIBRATION ISOLATION ROOF CURB.
 P10 ROUTE REFRIGERANT PIPING THROUGH THE WALL OR
- THROUGH ROOF. SEAL ALL AROUND THE PIPING.

 T4 TEMPERATURE CONTROL CONTRACTOR SHALL PROVIDE INTERCONNECTING CONTROL WIRING TO OUTDOOR CONDENSING UNIT.


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Construction Documents



PROJECT MANAGER: MKS

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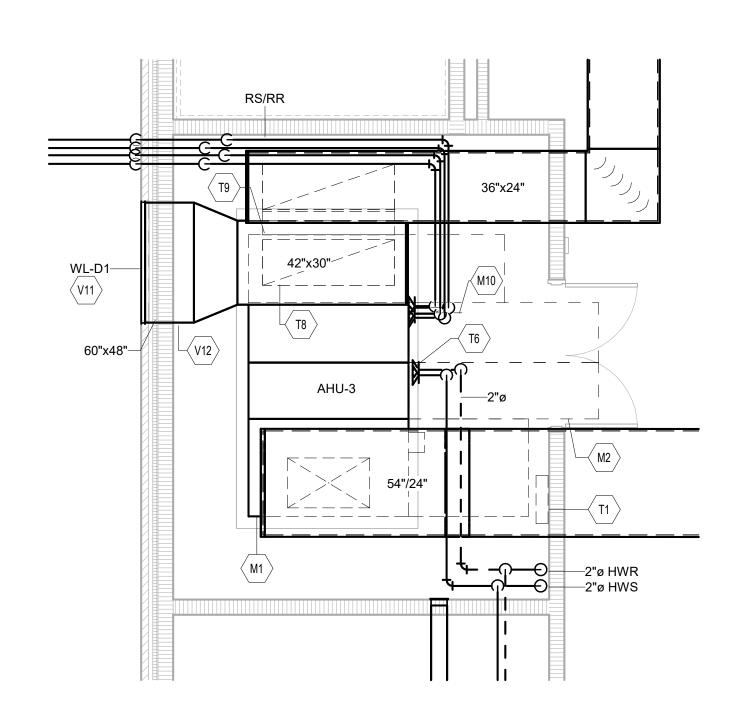
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SHOULD DIFFERENT CONDITIONS BE ENCOUNTERED, CONTACT THE ARCHITECT BEFORE PROCEEDING WITH WORK.


MECHANICAL ROOF PLAN

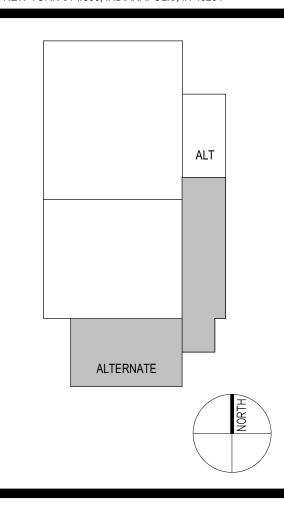MR101




UNIT D - FIRST FLOOR MECHANICAL ROOM

SCALE: 1/4" = 1'-0"

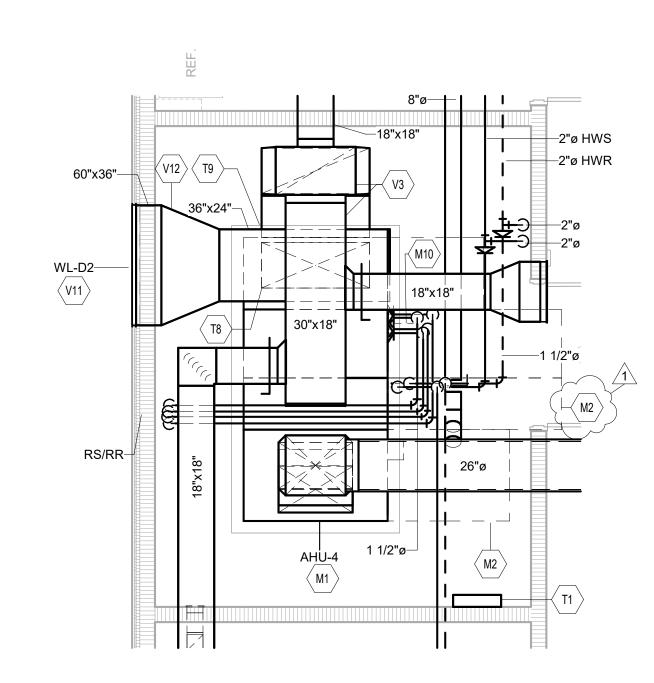


UNIT D - SECOND FLOOR MECHANICAL ROOM

SCALE: 1/4" = 1'-0"

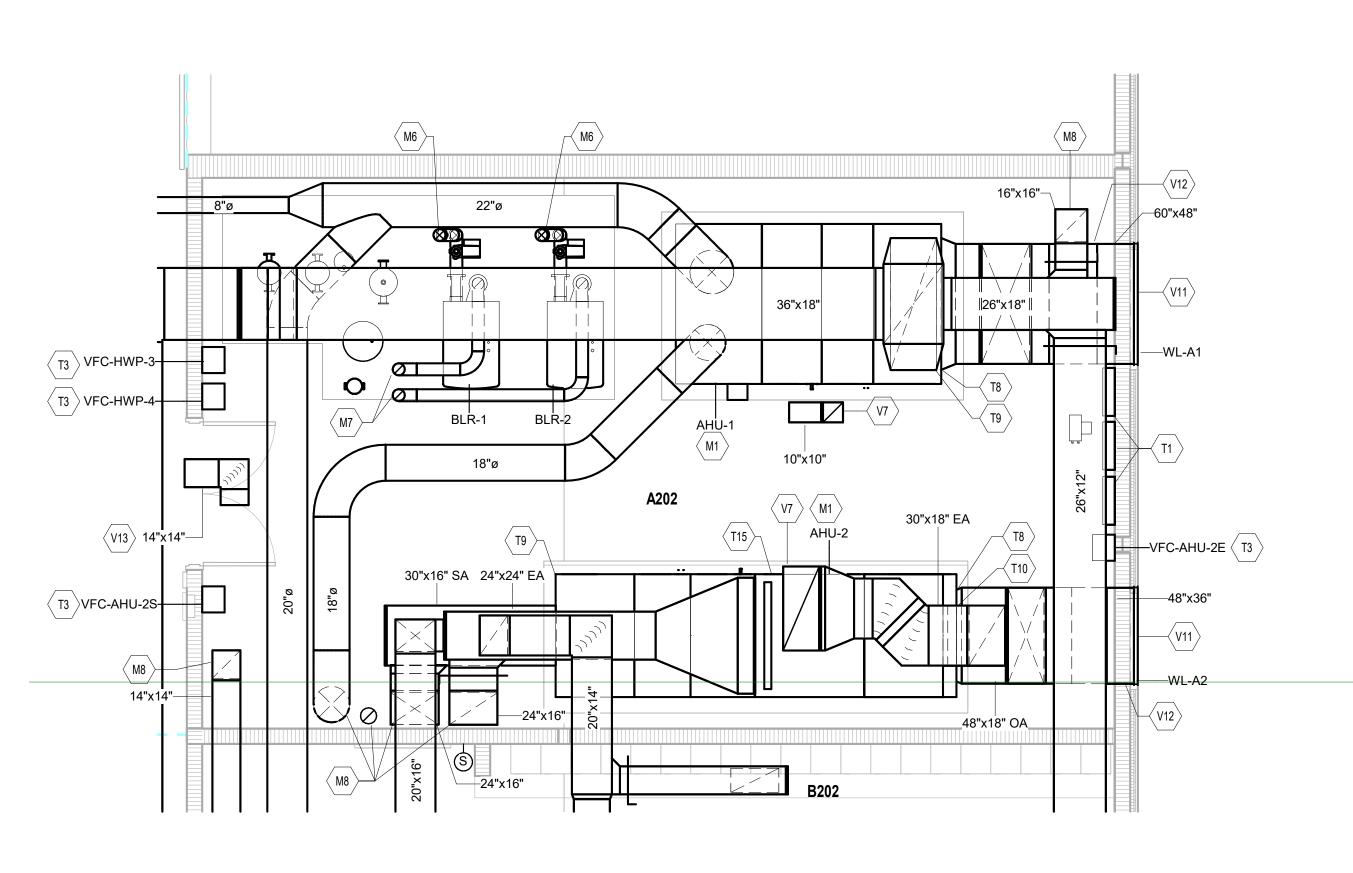

UNIT A - SECOND FLOOR BOILER ROOM VENTILATION PLAN

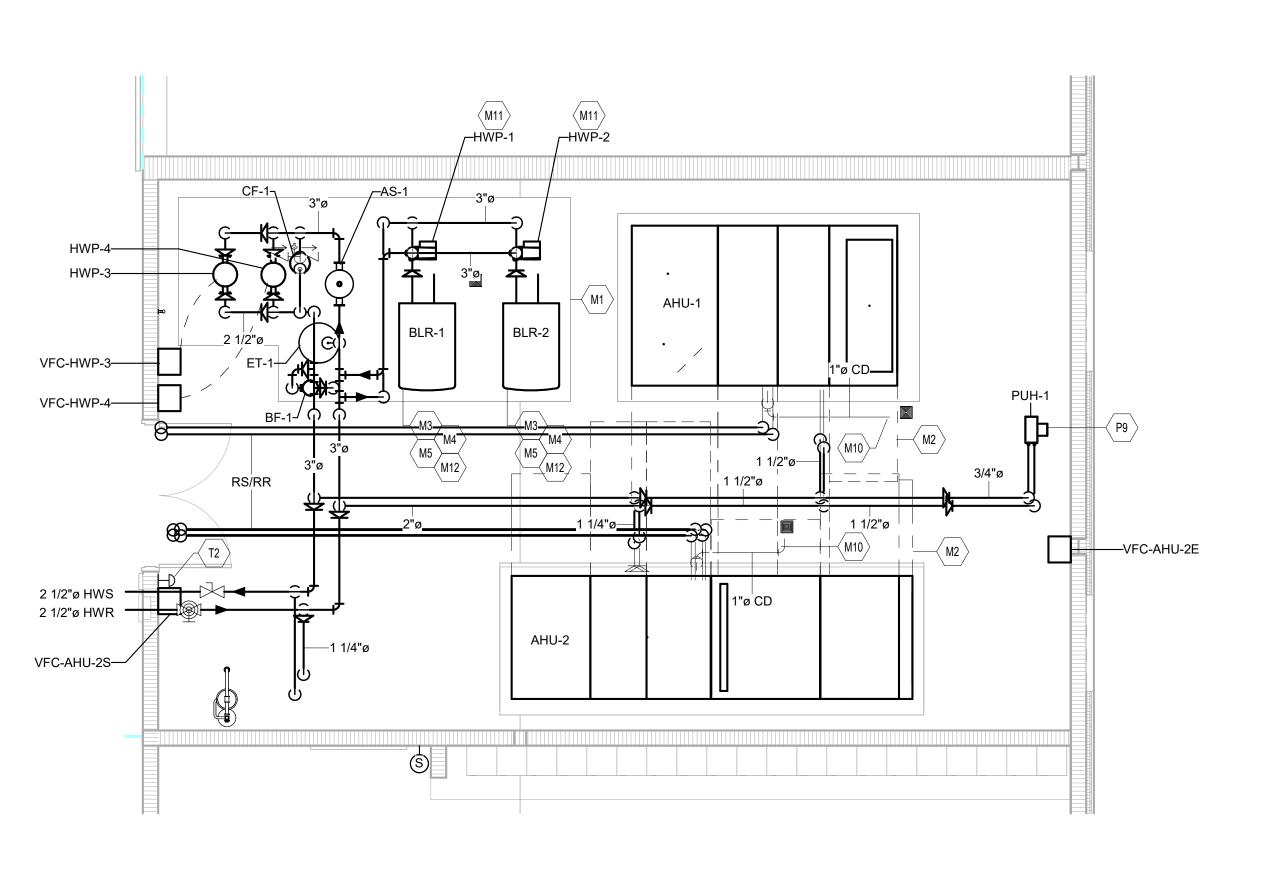

UNIT A - SECOND FLOOR BOILER ROOM PIPING PLAN

SCALE: 1/4" = 1'-0"

MECHANICAL ROOM PLAN GENERAL NOTES

- A. ALL DUCTWORK, PIPING AND VALVES SHALL BE
 CONCEALED ABOVE THE CEILING AND WITHIN WALLS,
 UNLESS OTHERWISE NOTED.

 B. PEFER TO THE SPECIEICATIONS FOR REQUIREMENTS.
- B. REFER TO THE SPECIFICATIONS FOR REQUIREMENTS
 RELATED TO EQUIPMENT QUALITY, CONSTRUCTION AND
 FINISH OF MATERIALS.
 C. ARRANGE DUCTWORK, PIPING, ETC. TO ALLOW FOR EASY
- ACCESS TO COILS, VALVES, DAMPERS AND CONTROLS.
 KEEP AREAS ADJACENT TO ACCESS PANELS FREE AND
 CLEAR OF ANY OBSTRUCTIONS.

 SEAL DUCT PENETRATIONS THROUGH THE FLOOR AND/OR
 WALLS IN ACCORDANCE WITH MECHANICAL CODE AND
 SMACNA REQUIREMENTS. SEAL DUCT PENETRATIONS
 THROUGH FIRE RATED FLOORS AND/OR WALLS WITH A

MATERIAL HAVING SAME FIRE RATING AS THE WALL

- AND/OR FLOOR.

 E. MECHANICAL CONTRACTOR IS RESPONSIBLE FOR HIS RESPECTIVE WORK FOR REPAIRING AND PATCHING TO MATCH EXISTING SURFACES, SIDEWALKS, STREETS, FLOORS, WALLS, ROOFS, CEILING AND PAVEMENT.

 F. ALL RECTANGULAR SHEET METAL DUCT SIZES SHOWN ARE INSIDE FREE AREA DIMENSIONS. ALL ROUND DUCT SIZES
- SHOWN ARE INSIDE DIAMETERS.

 G. PROVIDE BALANCING DAMPER AT EACH DUCT BRANCH, SERVING DIFFUSER, GRILLE AND REGISTER.

 H. INSTALL WALL THERMOSTATS, TEMPERATURE SENSORS, HUMIDISTATS, ETC. 44" ABOVE THE FINISH FLOOR IN ACCORDANCE WITH ADA REQUIREMENTS.

 I. COORDINATE ALL REQUIRED WALL, ROOF AND FLOOR OPENINGS (BOTH DIMENSIONS AND LOCATIONS) WITH ALL
- OPENINGS (BOTH DIMENSIONS AND LOCATIONS) WITH ALL OTHER TRADES.

 J. COORDINATE MECHANICAL SYSTEM INSTALLATION WITH STRUCTURE, FIRE PROTECTION AND LIGHTING LAYOUT.

 K. PROVIDE ALL NECESSARY TRANSITIONS TO EQUIPMENT
- LOCKERS/SHOWER AREAS SHALL BE MADE OF ALUMINUM IN ACCORDANCE WITH SMACNA REQUIREMENTS.

 M. HYDRONIC SUPPLY AND RETURN PIPING SHALL BE THE SAME SIZE UNLESS OTHERWISE NOTED.

ALL RETURN/EXHAUST AIR DUCT ABOVE

MECHANICAL ROOM PLAN NOTES

FROM SIZES SHOWN ON PLAN.

- (ALL NOTES MAY NOT BE INDICATED ON THIS SHEET)

 M1 INSTALL EQUIPMENT ON 3.75" HIGH CONCRETE
- HOUSEKEEPING PAD.

 M2 CLEARANCE REQUIRED FOR AIR HANDLING UNIT COIL
 PUILS
- M3 NATURAL GAS TRAIN APPROVED BY FACTORY MUTUAL (FM).
 DIVISION 22 PLUMBING CONTRACTOR TO INSTALL NATURAL
 GAS PIPING TO END OF GAS TRAIN. REFER TO DETAIL.

 M4 PROVIDE AND INSTALL PRESSURE RELIEF VALVE TO
- BOILER. REFER TO BOILER MANUFACTURER FOR
 RECOMMENDED LOCATION. PIPE FULL SIZE TO FLOOR
 DRAIN. SUPPORT PIPING INDEPENDENTLY OF VALVE TO
 PREVENT STRESS AND TO ALLOW PROPER OPERATION.

 M5 PROVIDE AND INSTALL CONDENSATE PIPING, TRAP
 ASSEMBLY, AND CONDENSATE NEUTRALIZER KIT PER
- MANUFACTURERS REQUIREMENTS (FOR EACH BOILER).
 ROUTE CONDENSATE PIPING TO NEAREST FLOOR DRAIN AS SHOWN ON DRAWINGS. PROVIDE PIT FOR NEUTRALIZATION KIT AND SUPPORT FOR CONDENSATE TRAP AS NECESSARY.

 M6 PROVIDE AND INSTALL 6" COMBUSTION AIR INLET PER MANUFACTURER REQUIREMENTS (FOR EACH BOILER).

COORDINATE FINAL VENT DIAMETER WITH APPROVED SUBMITTALS. TERMINATE COMBUSTION AIR INLET WITH

WITHIN 10 FEET. TERMINATE THE VENT WITH AN SUPPORT

- GOOSENECK. REFER TO DETAIL. PIPE SIZE AND INSTALLATION PER MANUFACTURERS REQUIREMENTS.

 M7 PROVIDE AND INSTALL 6" EXHAUST VENT WITH A MINIMUM 1/4 INCH PER FOOT PITCH UPWARDS PER MANUFACTURERS REQUIREMENTS (FOR EACH BOILER). COORDINATE FINAL VENT DIAMETER WITH APPROVED SUBMITTALS. EXHAUST VENT MUST BE 3 FEET ABOVE THE COMBUSTION AIR INLET, AND 2 FEET ABOVE ANY HIGHER PORTION OF THE BUILDING
- M8 DUCT ROUTED DOWN TO FLOOR BELOW. COORDINATE WITH STRUCTURAL STEEL IN AREA.

 M10 CONDENSATE DRAIN PIPING WITH WATER SEAL TRAP FROM UNIT TO NEAREST FLOOR DRAIN. CUT END OF PIPE AT A 45 DEGREE ANGLE. CONDENSATE DRAIN PIPING AND TRAP SIZED PER MANUFACTURERS REQUIREMENTS. REFER TO

COLLAR, ROOF FLASHING, AND VELOCITY CONE.

- M11 PROVIDE AND INSTALL IN-LINE PRIMARY PUMPS FOR EACH BOILER. REFER TO DETAIL. SEE MECHANICAL SCHEDULES AND SPECIFICATIONS.
- M12 BOILER MAKE-UP WATER LINE SHALL CONNECT TO 1"
 DOMESTIC WATER LINE IN THIS ROOM. CONNECT TO
 DOMESTIC WATER LINE WITH BACKFLOW PREVENTER.
 P9 SUPPORT UNIT HEATER FROM STRUCTURE ABOVE WITH
 SUPPLEMENTAL STEEL AND THREADED ROD AS REQUIRED.
 COORDINATE FINAL HEIGHT IN FIELD.
- APPROXIMATE LOCATION OF TEMPERATURE CONTROL PANEL. COORDINATE EXACT LOCATION WITH ALL TRADES.

 APPROXIMATE LOCATION OF BOILER SHUT-DOWN SWITCH PROVIDED AND INSTALLED BY TEMPERATURE CONTROL CONTRACTOR. MERGENCY EQUIPMENT SHUT-DOWN SWITCH SHALL SEND AN ALARM TO THE BAS. COORDINATE WITH ALL TRADES.
- TEMPERATURE CONTROL CONTRACTOR SHALL PROVIDE INTERCONNECTING WIRING BETWEEN VARIABLE
- FREQUENCY CONTROLLER(S) AND EQUIPMENT.

 APPROXIMATE LOCATION OF 3-WAY MODULATING HEATING WATER CONTROL VALVE.

 OUTSIDE AIR CONTROL DAMPER SHALL BE FACTORY
- MOUNTED IN AIR HANDLING UNIT. DAMPER OPERATORS
 PROVIDED BY TEMPERATURE CONTROL CONTRACTOR.

 T9 RETURN AIR CONTROL DAMPER SHALL BE FACTORY
 MOUNTED IN AIR HANDLING UNIT. DAMPER OPERATORS
 PROVIDED BY TEMPERATURE CONTROL CONTRACTOR
- MOUNTED IN AIR HANDLING UNIT. DAMPER OPERATORS PROVIDED BY TEMPERATURE CONTROL CONTRACTOR.

 T10 EXHAUST AIR CONTROL DAMPER SHALL BE FACTORY MOUNTED IN AIR HANDLING UNIT. DAMPER OPERATORS PROVIDED BY TEMPERATURE CONTROL CONTRACTOR.

 T15 ENERGY RECOVERY WHEEL BYPASS DAMPERS SHALL BE FACTORY MOUNTED IN AIR HANDLING UNIT. WIRING AND TERMINATIONS BY TEMPERATURE CONTROL CONTRACTOR.
- CONTROL CONTRACTOR.

 /3 ROUTE DUCTWORK BETWEEN/THROUGH STRUCTURAL STEEL. COORDINATE EXACT LOCATION WITH STRUCTURAL CONTRACTOR AND ALL OTHER TRADES.

DAMPER OPERATORS PROVIDED BY TEMPERATURE

- V7 DUCT ROUTED UP TO FLOOR ABOVE. COORDINATE WITH STRUCTURAL IN AREA.
 V11 INSULATED SHEET METAL PLENUM MOUNTED BEHIND WALL LOUVER. TRANSITION BOTTOM OF DUCT AT A SLOPE DOWNWARD TO WALL LOUVER. SEAL ALL SEAMS AND
- EDGES WATER TIGHT. WRAP PLENUM WITH INSULATION.
 REFER TO DETAIL.

 V12 INSTALL DRIP PAN UNDER WALL LOUVER. PAN SHALL BE
 SEALED WATER TIGHT. DRIP PAN TO EXTEND A MINIMUM OF
- 8" BEYOND DUCTWORK.

 V13 AIR TRANSFER WALL OPENING LOCATED ABOVE THE CEILING. COORDINATE EXACT LOCATION WITH ALL TRADES. END OF DUCT OPEN TO SPACE.

ALLS,
ENTS

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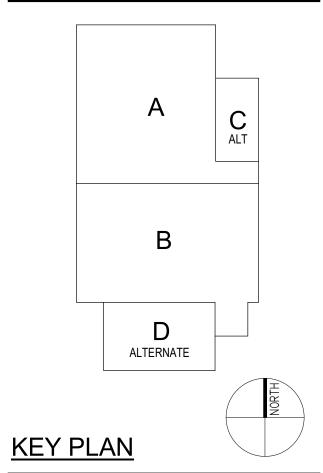
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Construction Documents



PROJECT MANAGER: MKS

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MECHANICAL ROOM

M-401

BASIS OF DESIGN: JOHNSON AIR ROTATION.

REFER TO PLANS & SCHEMATIC SHEETS FOR UNIT LAYOUT DETAILS.

3 REFER TO SPECIFICATION SECTION 237413. 4 FACTORY MOUNTED VARIABLE FREQUENCY CONTROLLER (VFC) SHALL BE PROVIDED ON THE SUPPLY FAN(S). MAXIMUM COOLING COIL FACE VELOCITY SHALL BE 500 FPM.

MAXIMUM FILTER FACE VELOCITY SHALL BE 500 FPM. PROVIDE CONVENIENCE OUTLET AND LIGHTS ON A SEPARATE CIRCUIT. SINGLE-POINT POWER CONNECTION. 9 INCLUDE FACTORY MOUNTED DISCONNECT SWITCH.

10 2" MERV 8 FILTERS.

11 FACTORY MOUNTED OUTSIDE AND RETURN AIR DAMPERS SIZED FOR 100% AIRFLOW. 12 MAXIMUM NOISE LEVEL SHALL BE 70 dBA WHEN STANDING 10' AWAY AT GROUND LEVEL.

13 STAINLESS STEEL HEAT EXCHANGER. 14 20:1 TURN DOWN - GAS HEATER.

15 CUSTOM COLOR AS SELECTED BY THE ARCHITECT/ENGINEER.

	AIR HANDLING UNIT SCHEDULE																																							
		IDENTITY			SUPPLY FAN		,	SUPF	PLY FAN						EXHA	UST FAN			ELEC	RICAL			CC	OLING		,	DX (COIL			HEATING			НС	T WATER COIL		UNIT	SIZE (IN)		
MARK	MFG	MODEL	LOCATION	AREA SERVED	EQUIPMENT Nominal (CFM)	OUTSIDE AIR (CFM)	TYPE	ESP (IN-WG)	FAN RPM	DRIVE		VFD /	AIRFLOW (CFM) TYPE I	ESP (IN-WG)	FAN RPM DRIVE	ВНР	MOTOR HP VFD	VOLT.	PH	TOT. CAP. (BTU/H)	SENS. CAP. (BTU/H)	EAT DB (°F)	WB LAT DB (°F)	LAT WB APD (IN-W	G) FACE VEL. (FPM)	REFRIG.	SST (°F)	CAP. (BTU/	(H) EAT LAT DB	DESCRIPTION	APD (IN-WG)	FACE VEL. (FPM)	EWT LWT (°F)	WPD (FT-WG)	FLOW (GPM)	L	и н	OPER. W (LB)	T NOTES
AHU-1	TRANE	CSAA025	MECHANICAL ROOM	COMMONS	8500	1950	PLENUM	2.50	1753	DIREC	T 15	Yes							460 V	3	304	217	77.2 64	1.3 52.5	51.3 0.61	410	R-410A	45	319	55 90	HEATING HOT WATER	0.08	421	180 140	1.73	16.0	133 8	56	2396	1,2,3,4,5,7,8,9,10,12
AHU-2	TRANE	CSAA010	MECHANICAL ROOM	LOCKERS	4750	4750	PLENUM	1.50	2563	DIREC	T 7.5	Yes	5,450	PLENUM	1.5	2256 DIREC	Γ 0.01	5 Yes	460 V	3	185	132	77.1 64	1.6 53.0	52.2 0.66	407	R-410A	45	238	46 95	HEATING HOT WATER	0.11	445	180 140	1.10	11.9	199	87	3603	1,3,4,5,6,7,8,10,11,1
AHU-3	TRANE	CSAA021	MECHANICAL ROOM	WRESTLING	8000	2800	PLENUM	0.80	2110	DIREC	T 15	Yes							460 V	3	311	210	78.6 6	5.3 56.4	54.3 0.55	456	R-410A	45	502	46 104	HEATING HOT WATER	0.12	403	180 140	0.28	25.0	135	56	2463	1,2,3,4,5,6,7,8,10
AHU-4	TRANE	CSAA017	MECHANICAL ROOM	DANCE	6000	1350	PLENUM	0.80	1433	DIREC	T 5	Yes							460 V	3	142	116	76.8 64	4.0 53.8	52.1 0.44	439	R-410A	45	258	55 95	HEATING HOT WATER	0.10	480	180 140	2.88	13.0	133	2 45	1803	1,2,3,4,5,6,7,8,10

REFER TO SPECIFICATION SECTION 23 73 13.

FACTORY MOUNTED VARIABLE FREQUENCY CONTROLLER (VFC) SHALL BE PROVIDED ON SUPPLY FAN. REFER TO ELECTRICAL DRAWINGS AND SPECIFICATIONS FOR VFC'S.

REFER TO PLANS & SCHEMATIC SHEETS FOR UNIT LAYOUT DETAILS.

PROVIDE FACTORY MOUNTED CONVENIENCE OUTLETS AND INTERNAL LIGHTS AT EACH ACCESS DOOR. PROVIDE CONVENIENCE OUTLET AND LIGHTS ON SEPARATE CIRCUIT.

5 SINGLE POINT ELECTRICAL CONNECTION TO UNITS.

INSTALL HEATING COIL IN RE-HEAT POSITION.

MAXIMUM FILTER FACE VELOCITY SHALL BE 550 FPM.

MAXIMUM COOLING COIL FACE VELOCITY SHALL BE 550 FPM. UNIT SHALL INCLUDE FACTORY MOUNTED BELMOUTH FITTINGS.

10 INCLUDE FACTORY MOUNTED RETURN AND OUTSIDE AIR DAMPERS. 11 FIELD MOUNTED VARIABLE FREQUENCY CONTROLLER (VFC) SHALL BE PROVIDED ON

SUPPLY/EXHAUST FAN. REFER TO ELECTRICAL DRAWINGS AND SPECIFICATIONS FOR VFC'S. 12 PROVIDE WITH SCCR RATING OF 10KAIC OR ABOVE.

										AIR-TO-A	IR ENER	GY RECO	VERY EQI	JIPMENT SC	HEDULE												
	IDENTITY DAT	A					SU	PPLY AIR	DATA								EXH	IAUST AIF	R DATA						HEAT W	HEEL	
			AREA SERVED	AIR F	LOW		SUM	MER			WIN	ITER		AIR F	LOW		SUM	MER			WIN	TER		APD	ELECTR	ICAL	NOTES
TAG	MFG	MODEL	AREA SERVED	CFM	CFM	EAT	「(°F)	LAT	(°F)	EAT	(°F)	LAT	Γ (°F)	CFM	CFM	EAT	(°F)	LAT	(°F)	EAT	(°F)	LAT	(°F)	in-(wg)	V DU	U-	NOTES
				IN	OUT	DB	WB	DB	WB	DB	WB	DB	WB	IN	OUT	DB	WB	DB	WB	DB	WB	DB	WB]	V PH	П	
AHU-2	TRANE	CSAA010	LOCKERS	4,750	5,004	88.1	72.7	77.1	64.6	-2	-3	51.2	42.3	5,705	5,450	74	61.7	83.2	69.1	72	55	25.6	24.4	1.00	460 3	60	1,3,4,5,6,7,8,10,

ĺ					AIR-	-COOLED CONDE	NSING UNIT SCHEDUL	.E								
	IDENTITY D	ATA				PERFO	RMANCE DATA		СОМІ	PRESSOR	DATA	CONDENSER FAN DATA	ELEC.	TRICAL	. DATA	
MARK	MANUFACTURER	TONNAGE	WEIGHT (LBS)	LOCATION	CAPACITY (TONS)	REFRIG TYPE	SAT. CONDENSER TEMP	AMBIENT TEMP	QTY	MCA	MOCP	QTY	VOLT	PH	FREQ	NOTES
ACCU-1	TRANE	30 TON	1,936	ROOF	383.2	R410A	43 °F	95 °F	2	63	80	3	460	3	60	1,2,3,4,6,7,9
ACCU-2	TRANE	15 TON	705	ROOF	184.5	R410A	45 °F	95 °F	2	32	40	2	460	3	60	1,2,3,4,6,7,9
ACCU-3	TRANE	20 TON	771	OUTSIDE	286.9	R410A	45 °F	95 °F	2	40	50	2	460	3	60	1,2,3,5,6,7,8
ACCU-4	TRANE	25 TON	1,921	OUTSIDE	316.2	R410A	45 °F	95 °F	1	52	70	3	460	3	60	1,2,3,5,6,7,8
ACCU-5	TRANE	60 TON	3,462	OUTSIDE	786.9	R410A	45 °F	95 °F	4	120	125	6	460	3	60	1,2,3,5,6,7,8
ACCIL-6	TRANE	60 TON	3.462	OUTSIDE	786.9	R410A	45 °F	95 °F	4	120	125	6	460	3	60	1235678

REFER TO PROJECT MANUAL FOR ADDITIONAL REQUIREMENTS.

INCLUDE THE FOLLOWING ACCESSORIES, HIGH AMBIENT UNLOADER PRESSURE STAT, PROTECTIVE COIL GUARDS COMPLETELY AROUND ENTIRE UNIT, PHASE LOSS/VOLTAGE

PROTECTION AND VIBRATION ISOLATORS. UNIT SHALL INCLUDE FROST PREVENTION DEVICE TO BE INSTALLED AT COIL.

UNIT SHALL BE INSTALLED ON ROOF SUPPORT RAILS WITH VIBRATION ISOLATORS. COORDINATE EXACT LOCATION IN FIELD.

UNIT SHALL BE INSTALLED ON 6" CONCRETE HOUSEKEEPING PAD WITH VIBRATION ISOLATORS. COORDINATE EXACT LOCATION IN FIELD.

INSTALL REFRIGERANT PIPING SIZES AND QUANTITIES PER MANUFACTURERS REQUIREMENTS. SINGLE POINT POWER CONNECTION. PROVIDE COMPRESSOR BLANKETS FOR SOUND ATTENUATION.

											HEATING	BOILER SCH	IEDULE														
					Н	EAT EXCH	ANGER CI	RITERIA &	PERFOR	MANCE				DESI	GN & RAT	ED HEATIN	IG PERFORMANO	E		FUEL		ELECTRICAL	CRITERIA	& PERFO	RMANCE		
TAG	TYPE	MANUF.	MODEL	COLUTION		ŀ	IHS FLOW	1	EW/T	LVA/T	\ \ \	NPD	CAPAC	YTI		MAXIM	IUM	DECION		MIN	MAV		SINGLE P	OINT		WEIGHT	NOTES
IAG	IIFE	WANUF.	WIODEL	SOLUTION TYPE	(%)	DESIGN	MIN	MAX	(°F)	LWT	DESIGN	MAX	DESIGN	MINI (9/)	TEMP	RISE	PRESSURE	DESIGN EFFICIENCY (%)	TYPE	(IN.WC)	(IN WC)	SE	RVICE		FLA	(LBS)	NOTES
				1112		(GPM)	(GPM)	(GPM)	(' '	(' '	(FT.HD)	(FT.HD)	(MBH)	WIII (/0)	(°F)	(°F)	(PSIG)	El l'IolENGT (70)		(111.110)	(111.110)	(VOLTS)	(HZ)	(PH)	(AMPS)		
BLR-1	CONDENSING BOILER	AERCO	BMK 1500	WATER	100	75	25	250	140	180	5	10	1,500	5	190	130	160	96.8	FM	4	14	120	60	1	16	1,610 1	1,2,3,4
BLR-2	CONDENSING BOILER	AERCO	BMK 1500	WATER	100	75	25	250	140	180	5	10	1,500	5	190	130	160	96.8	FM	4	14	120	60	1	16	1,610 1	1,2,3,4

REFER TO PROJECT MANUAL SECTION.

SINGLE POINT POWER CONNECTION ELECTRICAL REQUIREMENTS VARY BY UNIT MANUFACTURER.

PROVIDE DEDICATED 120V POWER CONNECTION FOR CONTROL PANEL.

							CABINET	UNIT HI	ATER S	CHEDULI	E												
		IDENTITY	DATA			LOCATION	UNIT	DIMENS	IONS	FAN	DATA	Н	EATING PERFORMAN	CE			HW	COIL		ELEC	TRICAL D	ATA	
			WEIGHT										CAPACITY	EAT	LAT	FLOW	EWT	LWT	WPD				
MARK	MFG	MODEL	(LBS)	TYPE	#	NAME	W	L	Н	CFM	HP	HEAT SOURCE	(BTUH)	(°F)	(°F)	(GPM)	(°F)	(°F)	(FT)	VOLTS	PH	FREQ	NOTES
CUH-1	TRANE	FFHB0201	78	VERTICAL RECESSED	A104	TRAINING	25"	35"	10"	300	0.05	HOT WATER	16,240	60	110	0.5	180	115	1.4	277 V	1	60	1,2,4,5,6
CUH-2	TRANE	FFHB0601	128	HORIZONTAL CEILING RECESSED	B120	VESTIBULE	25"	35"	10"	600	0.1	HOT WATER	36,940	60	116.8	1.5	180	130.7	2.8	277 V	1	60	1,2,3,5,6,7

PROVIDE WITH SCCR RATING OF 10KAIC OR ABOVE.

COLOR TO BE AS SPECIFIED BY ARCHITECT.

NOTE:

INCLUDE FACTORY MOUNTED DISCONNECT.

UNIT SCHEDULED WITH BOTTOM STAMPED INLET AND OUTLET. 4 UNIT SCHEDULED WITH FRONT STAMPED INLET AND OUTLET.

UNIT FURNISHED WITH ADJUSTABLE LOUVER FIN DIFFUSERS TO PROVIDE DIRECTIONAL AIR FLOW CONTROL.

6 LOW VOLTAGE WALL MOUNTED 2-STAGE TEMPERATURE SENSOR BY THE TCC. SUPPORT HEATER FROM STRUCTURE ABOVE WITH MINIMUM OF FOUR (4), 3/8" DIAMETER THREADED RODS AND VIBRATION ISOLATORS.

				EL	ECTRIC UNIT HEATE	R SCHEDU	JLE						
	IDENTITY D	ATA	FAN	DATA	HEATING PER	RFORMAN	CE	ELEC	CTIC HEAT	ELEC.	TRICAL D	ATA	
MARK	MFG	MODEL	CFM	НР	HEAT SOURCE	EAT (°F)	LAT (°F)	kW	NO. OF CONTOL STEPS	VOLTS	PH	FREQ	NOTES
EUH-1	TRANE	UHAA021ATAD	175	0	ELECTRIC	60	100	2	1	208 V	1	60	1,2,3,4
EUH-2	TRANE	UHAA041ATAD	175	0	ELECTRIC	60	100	4	1	208 V	1	60	1,2,3,4

HORIZONTAL RECESSED UNIT ELECTRIC HEAT WITH INTERNAL THERMOSTAT. INCLUDE FACTORY MOUNTED DISCONNECT

PROVIDED WITH BUILT-IN THERMOSTAT.

						2222			•								
	IDENTITY DATE	•	1				LER UNIT HEATER					0011		E. E.			
	IDENTITY DAT	A		FAN DATA		HE	ATING PERFORMAN	ICE			HW	COIL		ELEC	TRICAL D	AIA	
							CAPACITY	EAT	LAT	FLOW	EWT	LWT	WPD				
MARK	MFG	MODEL	CFM	QTY	HP	HEAT SOURCE	(BTUH)	(°F)	(°F)	(GPM)	(°F)	(°F)	(FT)	VOLTS	PH	FREQ	NOTES
PUH-1	TRANE	UHS-024	450	1	0.05	HOT WATER	20,570	60	109	2	180	160	0.01	120 V	1	60	1,2,3,4
PUH-2	TRANE	UHS-018	395	1	0.05	HOT WATER	15,430	60	102	1.5	180	160	0.01	120 V	1	60	1,2,3,4
PUH-3	TRANE	UHS-018	395	1	0.05	HOT WATER	15,430	60	102	1.5	180	160	0.01	120 V	1	60	1,2,3,4
PUH-4	TRANE	UHS-018	395	1	0.05	HOT WATER	15,430	60	102	1.5	180	160	0.01	120 V	1	60	1,2,3,4
PUH-5	TRANE	UHS-036	550	1	0.05	HOT WATER	30,850	60	119	3	180	160	0.01	120 V	1	60	1,2,3,4
PUH-6	TRANE	UHS-036	550	1	0.05	HOT WATER	30,850	60	119	3	180	160	0.01	120 V	1	60	1,2,3,4

SUPPORT HEATER FROM STRUCTURE ABOVE WITH A MINIMUM OF (2) 3/8" DIAMETER THREADED RODS

UNIT FURNIISHED WITH ADJUSTABLE LOUVER FIN DIFFUSES TO PROVIDE DIRECTIONAL AIR FLOW CONTROL. INCLUDE FACTORY MOUNTED DISCONNECT

4 REFER TO SPECIFICATION SECTION 233423 FOR ADDITIONAL REQUIREMENTS.

				HIGH VOLUME	LOW SPEED CEI	LING FAN S	CHEDULE							
	IDENTITY DA	TA					LOCATION		MAX	E	LECTRICAL	DATA		
MARK	MANUFACTURER	MODEL	WEIGHT	TYPE	DRIVE	#	NAME	DIA.	RPM	WATTS	VOLTS	PH	FREQ	NOTES
CF-1	Big Ass Fans	PFX4-14	130 lb	HIGH VOLUME LOW SPEED	DIRECT	A101	FIELDHOUSE	14'	94	750	480 V	3	60	1,2,3,4,5,6,7,8

NOTES: 1 REFER TO SPECIFICATION SECTION 233423 FOR ADDITIONAL REQUIREMENTS. 2 COLOR SHALL BE PROVIDED FROM MANUFACTURER'S FULL RANGE OF COLORS AS SELECTED BY

ARCHITECT/ENGINEER. 3 MOUNT BOTTOM AT 10'-0" AFF.

4 VFC SHALL BE FACTORY MOUNTED TO THE MOTOR AND WALL MOUNTED CONTROLLER.

COORDINATE LOCATION OF FAN AND ALL ASSOCIATED COMPONENTS WITH ALL TRADES. FANS SHALL BE INTERLOCKED TO SHUT DOWN IMMEDIATELY UPON RECEIVING A WATERFLOW

SIGNAL FROM THE FIRE ALARM SYSTEM. COORDINATE WITH DIVISION 28. INCLUDE WALL MOUNTED PUSH BUTTON CONTROLLERS.

REMOTE TOUCH SCREEN LED WALL MOUNTED SPEED CONTROLS BY UNIT MANUFACTURER. CONTROLS SHALL BE CAPABLE OF CONTROLLING ALL THREE FANS FROM A SINGLE

			EXTERIOR	R LOUVER SC	HEDULE		
IDENTITY DATA	MAX AIRFLOW (CFM)	TOP OF LOUVER ELEVATION	NECK SIZE	MIN FREE AREA (SF)	FREE AREA	LOUVER TYPE	NOTES
MARK	(CI WI)	LLLVATION		AREA (SF)	VELO. (FPM)		
WL-A1	8,500	25' - 4 3/4"	60"x48"	9.0	944 FPM	OUTSIDE AIR	1,2,3,4,5
WL-A2	5,000	-186' - 10 3/4"	48"x36"	5.4	926 FPM	OUTSIDE AIR	1,2,3,4,5
WL-A3	10,000	29' - 3 3/4"	120"x64"	24.0	417 FPM	RELIEF AIR	1,2,3,4,5
WL-A4	10,000	29' - 3 3/4"	120"x64"	24.0	417 FPM	RELIEF AIR	1,2,3,4,5
WL-A5	10,000	29' - 3 3/4"	120"x64"	24.0	417 FPM	RELIEF AIR	1,2,3,4,5
WL-B1	10,000	29' - 3 3/4"	120"x64"	24.0	417 FPM	RELIEF AIR	1,2,3,4,5
WL-D1	8,000	10' - 0 3/4"	60"x48"	9.0	889 FPM	OUTSIDE AIR	1,2,3,4,5
WL-D2	6,000	24' - 10 3/4"	60"x36"	6.8	889 FPM	OUTSIDE AIR	1,2,3,4,5
WL-D3	3,250	12' - 10 3/4"	60"x28"	5.3	619 FPM	EXHAUST AIR	1,2,3,4,5
WL-D4	4,750	12' - 11 3/4"	120"x28"	10.5	452 FPM	RELIEF AIR	1,2,3,4,5
WL-D5	4,750	12' - 11 3/4"	120"x28"	10.5	452 FPM	RELIEF AIR	1,2,3,4,5

1 REFER TO PROJECT MANUAL SECTION 089000.

PFX4-14 130 lb HIGH VOLUME LOW SPEED DIRECT A101 FIELDHOUSE 14' 94 750 480 V 3 60 1.2.3.4.5.6.7.8

2 SEAL ALL AROUND WITH SILICONE. 3 REFER TO INSTALLATION DETAILS ON ARCHITECTURAL DRAWING.

4 CUSTOM COLOR AS SELECTED BY ARCHITECT/ENGINEER. 5 COORDINATE SIZE AND LOCATION WITH ALL TRADES.

									VAV TERMINAL	UNIT SCHI	EDULE								
	IDENTITY	DATA		AIR FLO	W (CFM)		SOUND			ŀ	EATING				HOT WATER	COIL		UNIT	
MARK	MFG	MODEL	INLET SIZE	MIN FLOW	MAX FLOW	RAD	IC DISCH	ATTEN	CAP. (BTU/H)	EAT (°F)	LAT (°F)	DESCRIPTION	EWT (°F)	LWT (°F)	APD (IN-WG)	WPD (FT-WG)	FLOW (GPM)	WT (LB)	NOTES
VVR-01	TRANE	VCWF08	8"	500	250	27	20	Yes	21690	55	97	HEATING HOT WATER	180	144	0.28	0.13	1.25	31	1,2,3,4,5,6,7,8,
VVR-02	TRANE	VCWF10	10"	625	313	24	22	Yes	31500	55	102	HEATING HOT WATER	180	130	0.19	0.27	1.25	42	1,2,3,4,5,6,7,8,
VVR-03	TRANE	VCWF08	8"	450	225	26	20	Yes	19110	55	95	HEATING HOT WATER	180	142	0.20	0.09	1.00	31	1,2,3,4,5,6,7,8,
VVR-04	TRANE	VCWF08	8"	400	200	26	20	Yes	19110	55	95	HEATING HOT WATER	180	142	0.20	0.09	1.00	31	1,2,3,4,5,6,7,8,
VVR-05	TRANE	VCWF10	10"	600	300	24	22	Yes	26030	55	103	HEATING HOT WATER	180	130	0.18	0.27	1.25	42	1,2,3,4,5,6,7,8,
VVR-06	TRANE	VCWF06	6"	225	113	26	20	Yes	12520	55	106	HEATING HOT WATER	180	130	0.16	0.17	0.50	28	1,2,3,4,5,6,7,8,
VVR-07	TRANE	VCWF08	8"	400	200	26	20	Yes	19110	55	99	HEATING HOT WATER	180	142	0.20	0.09	1.00	31	1,2,3,4,5,6,7,8,
VVR-08	TRANE	VCWF10	12"	900	450	24	23	Yes	39150	55	100	HEATING HOT WATER	180	135	0.28	0.51	1.75	42	1,2,3,4,5,6,7,8,
VVR-09	TRANE	VCWF12	12"	1000	500	26	21	Yes	46670	55	98	HEATING HOT WATER	180	133	0.23	0.24	2.00	53	1,2,3,4,5,6,7,8,
VVR-10	TRANE	VCWF12	12"	1000	500	26	21	Yes	46670	55	98	HEATING HOT WATER	180	133	0.23	0.24	2.00	53	1,2,3,4,5,6,7,8,
VVR-11	TRANE	VCWF12	12"	900	450	26	21	Yes	45060	55	100	HEATING HOT WATER	180	134	0.22	0.24	2.00	53	1,2,3,4,5,6,7,8,
VVR-12	TRANE	VCWF12	12"	900	450	25	21	Yes	45060	55	101	HEATING HOT WATER	180	135	0.20	0.24	2.00	53	1,2,3,4,5,6,7,8,
VVR-13	TRANE	VCWF12	12"	1000	500	26	21	Yes	46670	55	95	HEATING HOT WATER	180	133	0.23	0.18	2.00	53	1,2,3,4,5,6,7,8,

1 REFER TO SPECIFICATION SECTION 233600.

2 HEATING COIL DESIGN BASED ON HIGH-EFFICIENCY, HOT WATER COIL, UNLESS OTHERWISE NOTED.

3 PROVIDE NUMBER OF COIL ROWS AS REQUIRED TO MEET MBH. COILS MAY REQUIRE 4-ROW.

4 UNIT MANUFACTURER SHALL PROVIDE REQUIRED HANGING BRACKETS TO PROPERLY SUPPORT UNIT.

6 COILS SHALL BE SELECTED WITH 10' WPD MAXIMUM.

5 UNIT SELECTION MUST ALLOW FOR A MINIMUM OF 0.40" DOWNSTREAM STATIC PRESSURE.

7 DIVISION 26 CONTRACTOR TO SUPPLY 120/1 POWER TO EACH VAV TERMINAL. DIVISION 23 CONTRACTOR TO PROVIDE TRANSFORMER AND DISCONNECT. DISCONNECT TO BE TOTALLY ENCLOSED EXTERNAL FROM VAV CONTROL PANEL BOX. DISCONNECT SHALL DE-ENERGIZE ALL POWER IN CONTROL PANEL. 8 NOISE LEVELS ARE NOT TO EXCEED 20 NC

9 PROVIDE FACTORY-MOUNTED AND PRE-PROGRAMMED, PRESSURE-INDEPENDENT, BACNET DDC CONTROLLER WITH

THROAT SIZE | OVERALL SIZE | DAMPER MOTOR | DRIP | WEIGHT VELOCITY FREE AREA AIRFLOW W L W L H OPERATED PAN (LBS) 1000 FPM | 5.3 SF | 5200 CFM | 18" | 42" | 32" | 63" | 28" ROOF 590 FPM 14.5 SF 8500 CFM 36" 58" 62" 75" 31" YES YES 168 1,2,3,4,5,6 ROOF 600 FPM 10.0 SF 6000 CFM 30" 48" 34" 63" 28" YES YES 89 1,2,3,4,5,6

REFER TO PROJECT MANUAL SECTION 233723 HOODS TO BE MOUNTED ON MINIMUM 12" HIGH ROOF CURB.

3 COLOR SHALL BE PROVIDED FROM MANUFACTURER'S FULL RANGE OF COLORS AS SELECTED BY ARCHITECT/ENGINEER. UNITS TO BE PROVIDED WITH A HINGE BASE KIT.

5 CONTROL DAMPER PROVIDED BY TEMPERATURE CONTROL CONTRACTOR WHERE REQUIRED.

6 DRIP PAN TO EXTEND A MINIMUM OF 6" ON EACH SIDE OF HOOD

IDENTITY DA	ATA				PERFOR	RMANCE DATA	١	ELECT	RICAL D	ATA			
MANUFACTURER	MODEL	WEIGHT (LBS)	TYPE	CFM	RPM	ESP (IN-WG)	MOTOR HP	VOLTS	PH	FREQ	SONES	CONTROLS	NOTES
GREENHECK	G-90-VG	29	ROOF MOUNTED	500	1185	0.13	1/10	120 V	1	60	4.7	С	1,2,4,5,6,7,8
GREENHECK	G-060-VG	19	ROOF MOUNTED	150	1600	0.2	1/15	120 V	1	60_	4.0	A	1,2,4,5,6,7,8
GREENHECK	G-080-VG	28	ROOF MOUNTED	300/	1290	0.2	1/10	120/V	1	60	5.3	D	1,2,4,5,6,7,8
GREENHECK	G-060-VG	19	ROOF MOUNTED	150	1600	0.2	1/15	120 V	1	60	4.0	С	1,2,4,5,6,7,8
 GREENHECK	√\$Q-100 -√ G	45	ANL'INE	1,200	1560	0,25	_1/4\	120\V	11	60~	9.9	С	1,2,3,4,7,8
GREENHECK	SQ-160-VG	147	INLINE	3,250	1200	0.25	1	208 V	3	60	14 (B.1	1,2,3,4,7,8

1 INCLUDE DISCONNECT SWITCH. INCLUDE BACKDRAFT DAMPER.

SUPPORT FROM STRUCTURE ABOVE WITH VIBRATION ISOLATORS.

MOUNT ON 12" HIGH ROOF CURB. INSTALL DRIP PAN UNDER UNIT.

INCLUDE SPEED CONTROL AND FACTORY MOUNTED DISCONNECT. 8 STANDARD COLOR AS SELECTED BY ARCHITECT/ENGINEER.

REFER TO SPECIFICATION SECTION 233423 FOR ADDITIONAL REQUIREMENTS

.2 WITH LIGHTS .3 WITH LOCAL SWITCH

.1 WITH TIMER SWITCH

B TIMER SWITCH CONTROL BY DIVISION 26

AUTOMATIC OPERATION BY REVERSE ACTING THERMOSTAT INTERLOCK EXHAUST FAN WITH POPCORN MACHINE

A AUTOMATIC OCCUPIED OPEATION BY LOCAL TEMPERATURE CONTROL ZONE

REFER TO MECHANICAL DRAWINGS FOR **EQUIPMENT THAT IS WITHIN ALTERNATES**

PENN HIGH SCHOOL **FIELDHOUSE**

12641 McKinley Highway, Mishawaka, Indiana 46545

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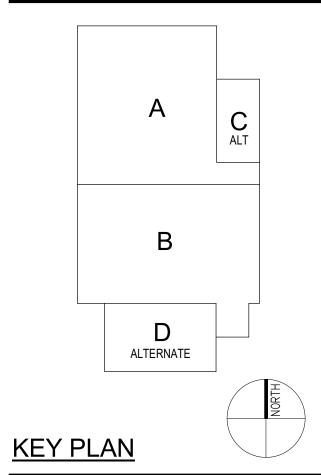
PENN-HARRIS-MADISON SCHOOL CORPORATION



ARCHITECT



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Construction Documents



PROJECT MANAGER: MKS DRAWN BY: DJA PROJECT NUMBER: 222130.00 PROJECT ISSUE DATE: January 10, 2024

REV. NO.△	DESCRIPTION	DATE
1	Addendum #1	1-26-24

MECHANICAL SCHEDULES

______ NEW UTILITY (1) TRANSFORMER (ALTERNATE) -ALTERNATE / ONE WAY NEW UTILITY (P1) TRANSFORMER (BASE BID) — ELECTRICAL ROOM A105 ALTERNATE (1) 1AH1-10 EXISTING DRIVE

ELECTRICAL SITE PLAN

1" = 30'-0"


PLAN NOTES:

- (L1) WIRE SITE LIGHTING TO INDICATED 20A, 1-POLE CIRCUIT BREAKER IN PANEL "1AH1" VIA LIGHTING CONTACTOR LC-4 LOCATED ADJACENT TO PANEL. VERIFY CONDUIT AND WIRE SIZE PER VOLTAGE DROP REQUIREMENTS.
- (L8) PROVIDE WITH 2 # 8, #8 G IN 1" CONDUIT (TYPICAL).
- L9 IF ALTERNATE IS ACCEPTED, WIRE SOUTH PARKING LOT SITE LIGHTING TO LIGHTING CIRCUIT SERVING FIXTURES ALONG EXISTING DRIVE TO THE SOUTH.
- P1) UTILITY COMPANY PAD-MOUNTED TRANSFORMER. PROVIDE A PAD PER UTILITY COMPANY REQUIREMENTS.
- P16 PROVIDE 4" SCHEDULE 40 PVC CONDUIT FOR NEW UTILITY PRIMARY SERVICE.
- PROVIDE 24" X 36" POLYMER CONCRETE PULL BOX LABELED "POWER" FOR UTILITY PRIMARY SERVICE.
- (218) IF ALTERNATE IS ACCEPTED, EXTEND UTILITY SERVICE CONDUIT TO ALTERNATE TRANSFORMER
- GROUNDING FIELD FOR SECONDARY ELECTRIC
 SERVICE REFER TO DETAILS ON SHEET F-50 SERVICE. REFER TO DETAILS ON SHEET E-501 FOR REQUIREMENTS. COORDINATE EXACT LOCATION WITH CIVIL DRAWINGS AND WITH OTHER SITE FEATURES IN THE SAME AREA.
- (43) BUILDING PERIMETER GROUNDING RING FOR SECONDARY ELECTRIC SERVICE. REFER TO PROJECT MANUAL SECTION 26 05 26 AND DETAILS ON SHEET E-501 FOR REQUIREMENTS. COORDINATE EXACT ROUTING WITH ALL UNDERGROUND UTILITIES, DOWNSPOUT LEADERS, AND EXISTING CONDITIONS TO RUN GROUNDING CONDUCTOR CONTINUOUSLY AROUND PERIMETER OF BUILDING. CONNECT TO MAIN SERVICE GROUNDING BUSBAR IN ELECTRICAL ROOM IN ADDITION TO OTHER GROUNDING AND BONDING CONNECTIONS INDICATED IN PROJECT MANUAL SECTION. 26 05 26 AND DETAILS ON SHEET

ANCHOR BOLTS BY POLE MANUFACTURER VIBRATION DAMPENING ----— POLE SEE LUMINAIRE SCHEDULE SET POLES USING DOUBLE NUT - PROVIDE (2) PIECE BASE COVER PER POLE CONSTRUCTION METHOD -GROUT UNDER BASE PLATES - 1" CHAMFER PROVIDE (4) CHANNELS AT — HORIZONTAL RE-STEEL TIES EACH BASE ---#3 AT 12" C/C RUB AND SEAL ALL EXPOSED CONCRETE — FINISH GRADE -VERTICAL RE-STEEL 6 EA. #6 DIA. — 3" MINIMUM CONCRETE COVER OVER RE-STEEL 3000 PSI AIR ENTRAINED -— BACKFILL EXCAVATION WITH CONCRETE CONCRETE - REMOVE ALL SPOILS FROM SITE

PROVIDE 5/8 " x 8'-0" GROUND ROD AT EACH POLE (TOP AT 2'-0" BELOW GRADE) AND CONNECT TO POLE WITH 1#6 AWG SOLID CU CONDUCTOR IN 1/2" PVC CONDUIT. TACK WELD ALL ANCHOR BOLT NUTS IN PLACE WHEN POLES ARE SET AND PLUMB. REPAIR FINISH WITH GALCON PAINT.

LIGHTING POLE FOUNDATION DETAIL (16'-6" TO 30'-0" LONG)

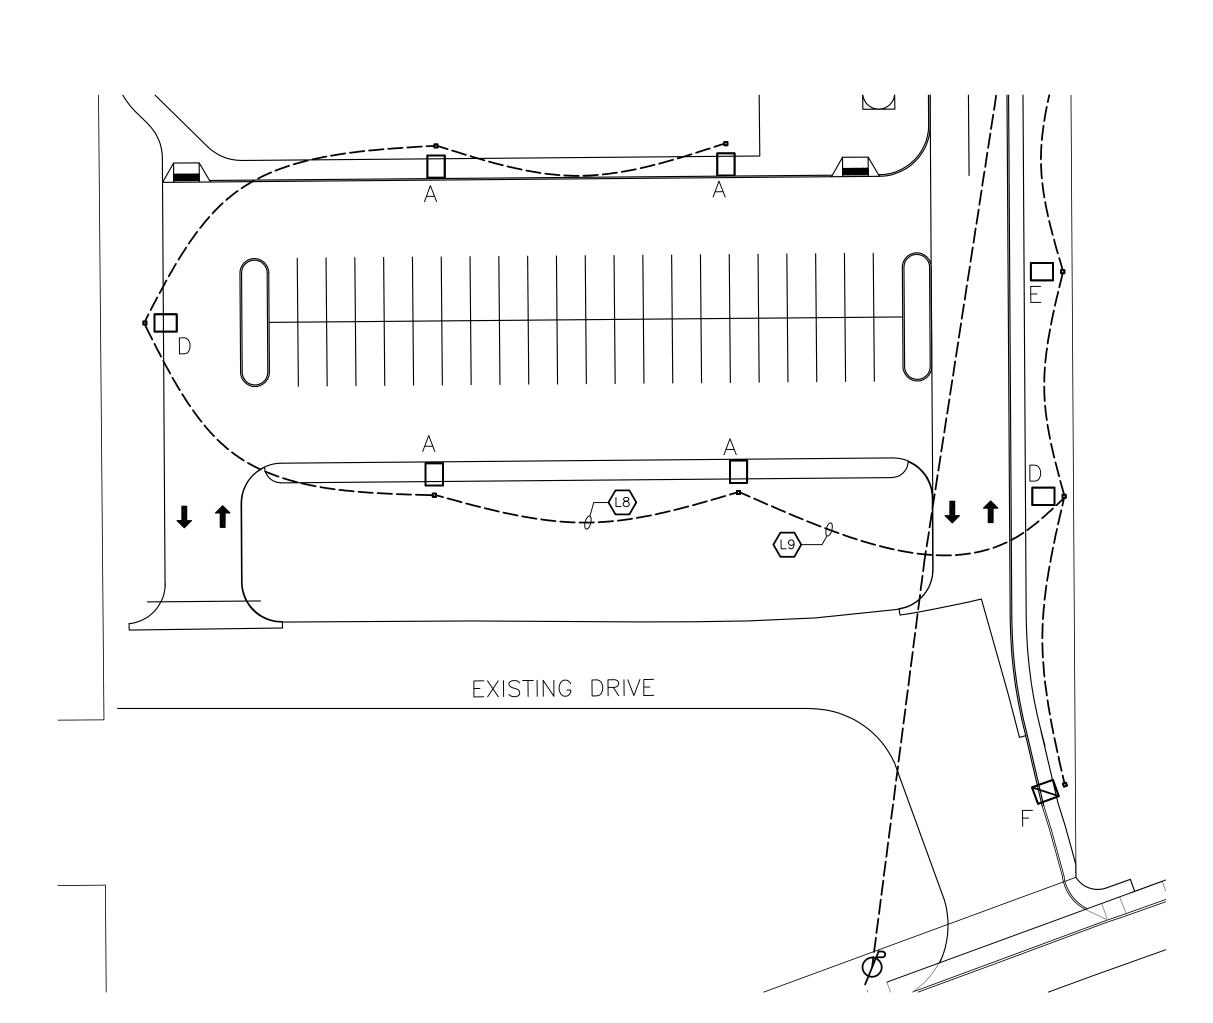

SOUTH PARKING SITE PLAN ALTERNATE

GENERAL NOTES:

- A. COORDINATE ALL UNDERGROUND OBSTRUCTIONS PRIOR TO STARTING EXCAVATION ACTIVITIES. PROVIDE PUBLIC AND PRIVATE UTILITY LOCATE SERVICES AND COORDINATE WITH OWNER. AVOID ALL UNDERGROUND OBSTRUCTIONS WHETHER IDENTIFIED OR NOT IDENTIFIED
- IN THESE DOCUMENTS. B. THE TERM "PROVIDE" INDICATES CONTRACTOR SHALL FURNISH AND INSTALL ITEMS AND CONNECT AS REQUIRED TO OBTAIN A COMPLETE AND OPERABLE
- C. WORK SHALL BE IN ACCORDANCE WITH THE LATEST EDITION OF ALL LOCAL, STATE AND NATIONAL CODES INCLUDING, BUT NOT LIMITED TO NFPA 70 (NATIONAL ELECTRIC CODE), NFPA 72, NFPA 101, INTERNATIONAL BUILDING CODE, ETC. D. CONFLICTS BETWEEN THE APPLICABLE CODES,
- STANDARDS, AND THE PLANS AND SPECIFICATIONS SHALL BE SUBMITTED TO THE ARCHITECT IN WRITING PRIOR TO PROCEEDING WITH WORK. E. ADDITIONAL ELECTRICAL REQUIREMENTS MAY BE SHOWN ON PLANS FROM OTHER DISCIPLINES IN THIS SET. IT IS THE CONTRACTOR'S RESPONSIBILITY TO REVIEW ALL PLANS AND SPECIFICATIONS FOR A COMPLETE
- UNDERSTANDING OF THE PROJECT REQUIREMENTS. F. WHERE CONFLICTS ARE FOUND BETWEEN DRAWINGS, DETAILS, OR SPECIFICATIONS, THE MORE STRINGENT REQUIREMENT SHALL APPLY. NOTIFY ARCHITECT OF DISCREPANCY IN WRITING.
- G. INITIATING WORK CONSTITUTES CONTRACTOR ACCEPTANCE OF THE EXISTING CONDITIONS ASSOCIATED WITH THE WORK IN QUESTION. H. CONTRACTOR SHALL CONTACT UTILITIES AND VERIFY UTILITY REQUIREMENTS PRIOR TO COMMENCING
- CONSTRUCTION. CONFLICTS BETWEEN UTILITY REQUIREMENTS AND THE PLANS OR SPECIFICATIONS SHALL BE SUBMITTED TO THE ARCHITECT IN WRITING PRIOR TO PROCEEDING WITH WORK. CONTRACTOR SHALL ARRANGE A PRE-CONSTRUCTION MEETING WITH THE UTILITY COMPANY TO REVIEW REQUIREMENTS. INCOMING SERVICE CONDUITS AND SUBSTRUCTURES SHALL BE INSTALLED PER UTILITY COMPANY STANDARDS.
- I. THESE DRAWINGS AND SPECIFICATIONS DO NOT INDICATE METHODS OF CONSTRUCTION. THE CONTRACTOR SHALL SUPERVISE AND DIRECT THE WORK AND IS RESPONSIBLE FOR CONSTRUCTION MEANS, METHODS, TECHNIQUES, SEQUENCES, PROCEDURES, AND SAFE PRACTICES. J. DRAWINGS ARE DIAGRAMMATIC IN NATURE AND CANNOT
- SHOW EVERY CONNECTION, JUNCTION BOX, WIRE, AND CONDUIT, ETC. THE EXACT LOCATIONS AND ARRANGEMENT OF PARTS SHALL BE DETERMINED AS THE WORK PROGRESSES. ITEMS NOT INDICATED ON DRAWINGS REASONABLY INFERRED TO BELONG TO THE WORK DESCRIBED SHALL BE FURNISHED AND INSTALLED TO PROVIDE A COMPLETE AND OPERATIONAL
- K. WORK SHALL BE COORDINATED WITH EXISTING CONDITIONS, NEW CONSTRUCTION, OWNER'S VENDORS, OTHER TRADES, AND THEIR DOCUMENTS. THE CONTRACTOR SHALL VISIT THE SITE BEFORE SUBMITTING HIS BID. CONTRACTOR SHALL CONTACT OWNER FOR AN APPOINTMENT TO VISIT THE SITE. L. AN INSULATED GROUND CONDUCTOR SIZED PER NEC SHALL BE PROVIDED WITH EACH FEEDER AND BRANCH
- M. PROVIDE A DEDICATED NEUTRAL FOR EACH LINE TO NEUTRAL CIRCUIT. MULTI-WIRE BRANCH CIRCUITS ARE
- NOT PERMITTED UNLESS SPECIFICALLY INDICATED ON N. MINIMUM WIRE SIZE IS #10 AWG. SEE SPECIFICATIONS
- FOR MINIMUM CONDUIT SIZE. O. ELECTRICAL PANELS INCLUDING BUT NOT LIMITED TO LIGHTING CONTROL PANELS, POWER DISTRIBUTION WILL HAVE A MAX DEVICE HEIGHT OF 72" AFF.
- P. PROVIDE GROUNDING TYPE EXPANSION FITTINGS OR OTHER APPROVED METHODS TO ALLOW FOR EXPANSION, CONTRACTION, AND DEFLECTION.

PENN HIGH SCHOOL FIELD HOUSE

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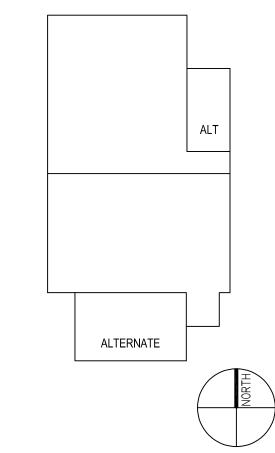
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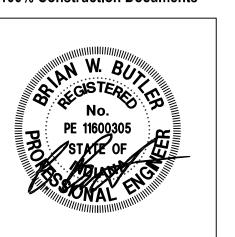




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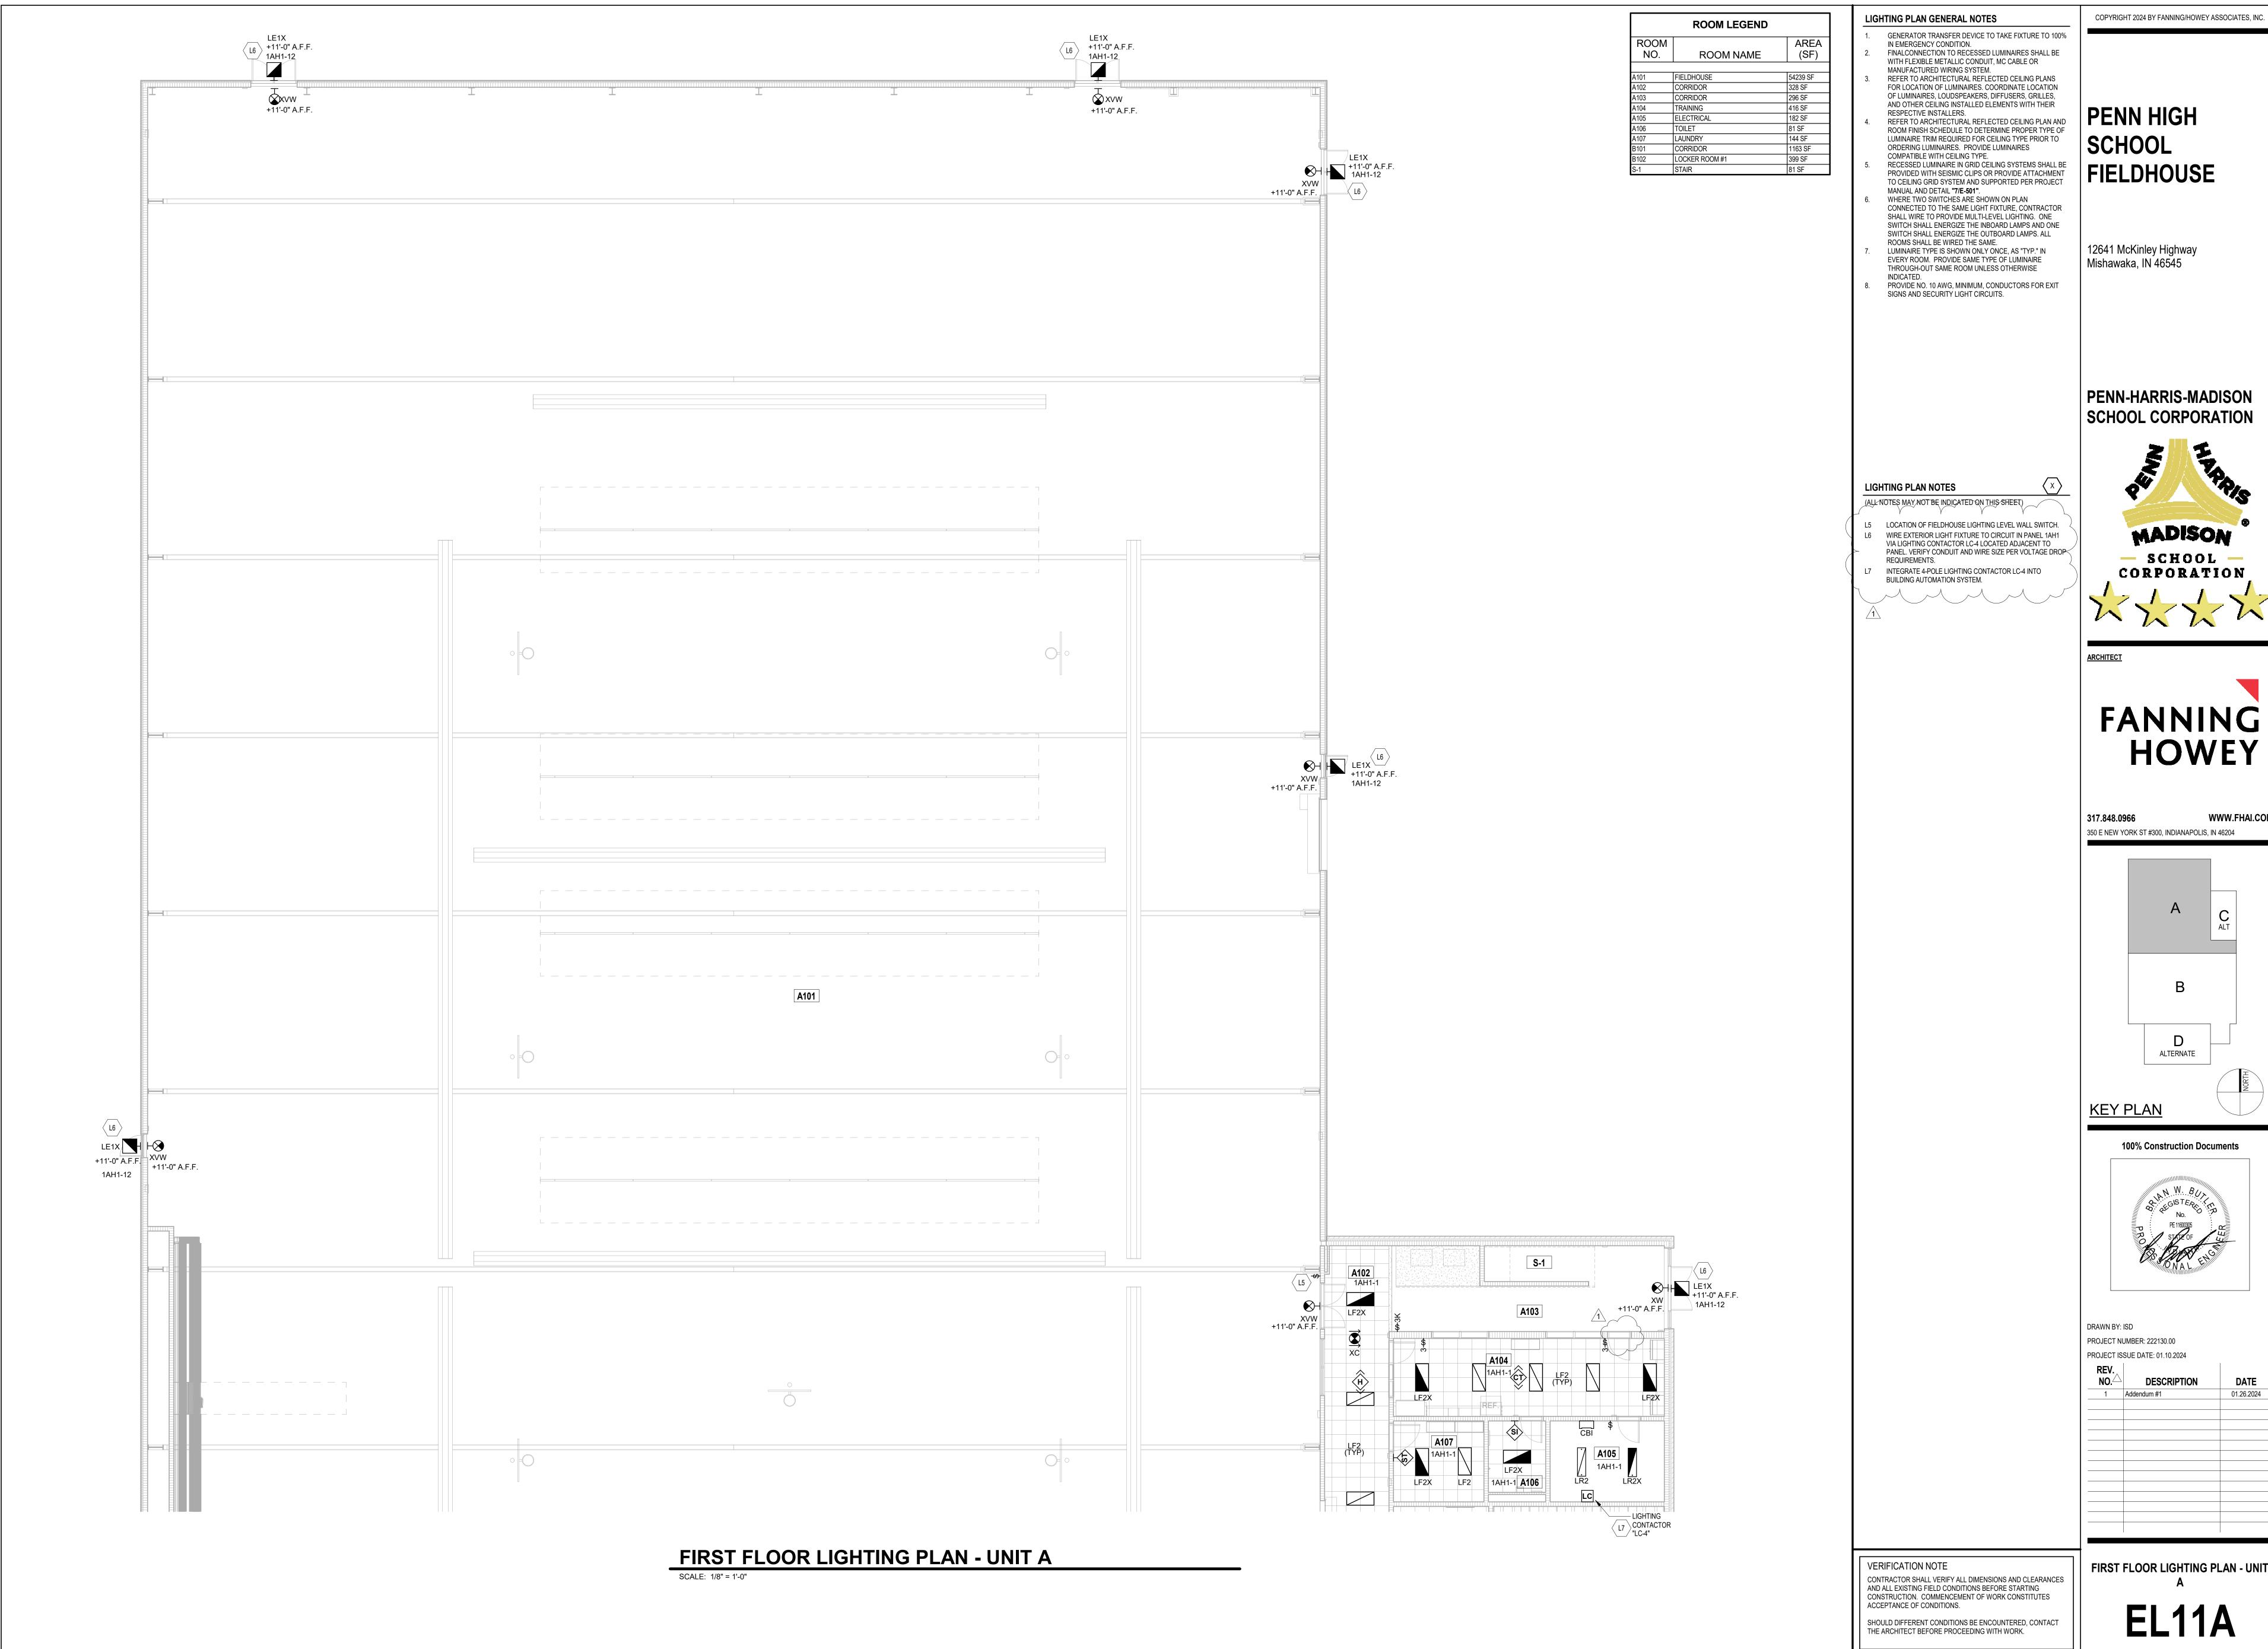


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ROJECT ISS	SUE DATE: 01.10.2024	
REV. NO.	DESCRIPTION	DATE
1	Addendum #1	01.26.2024

ELECTRICAL SITE PLANS

ES101



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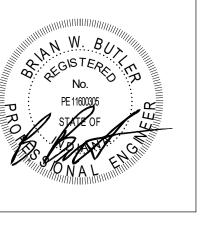
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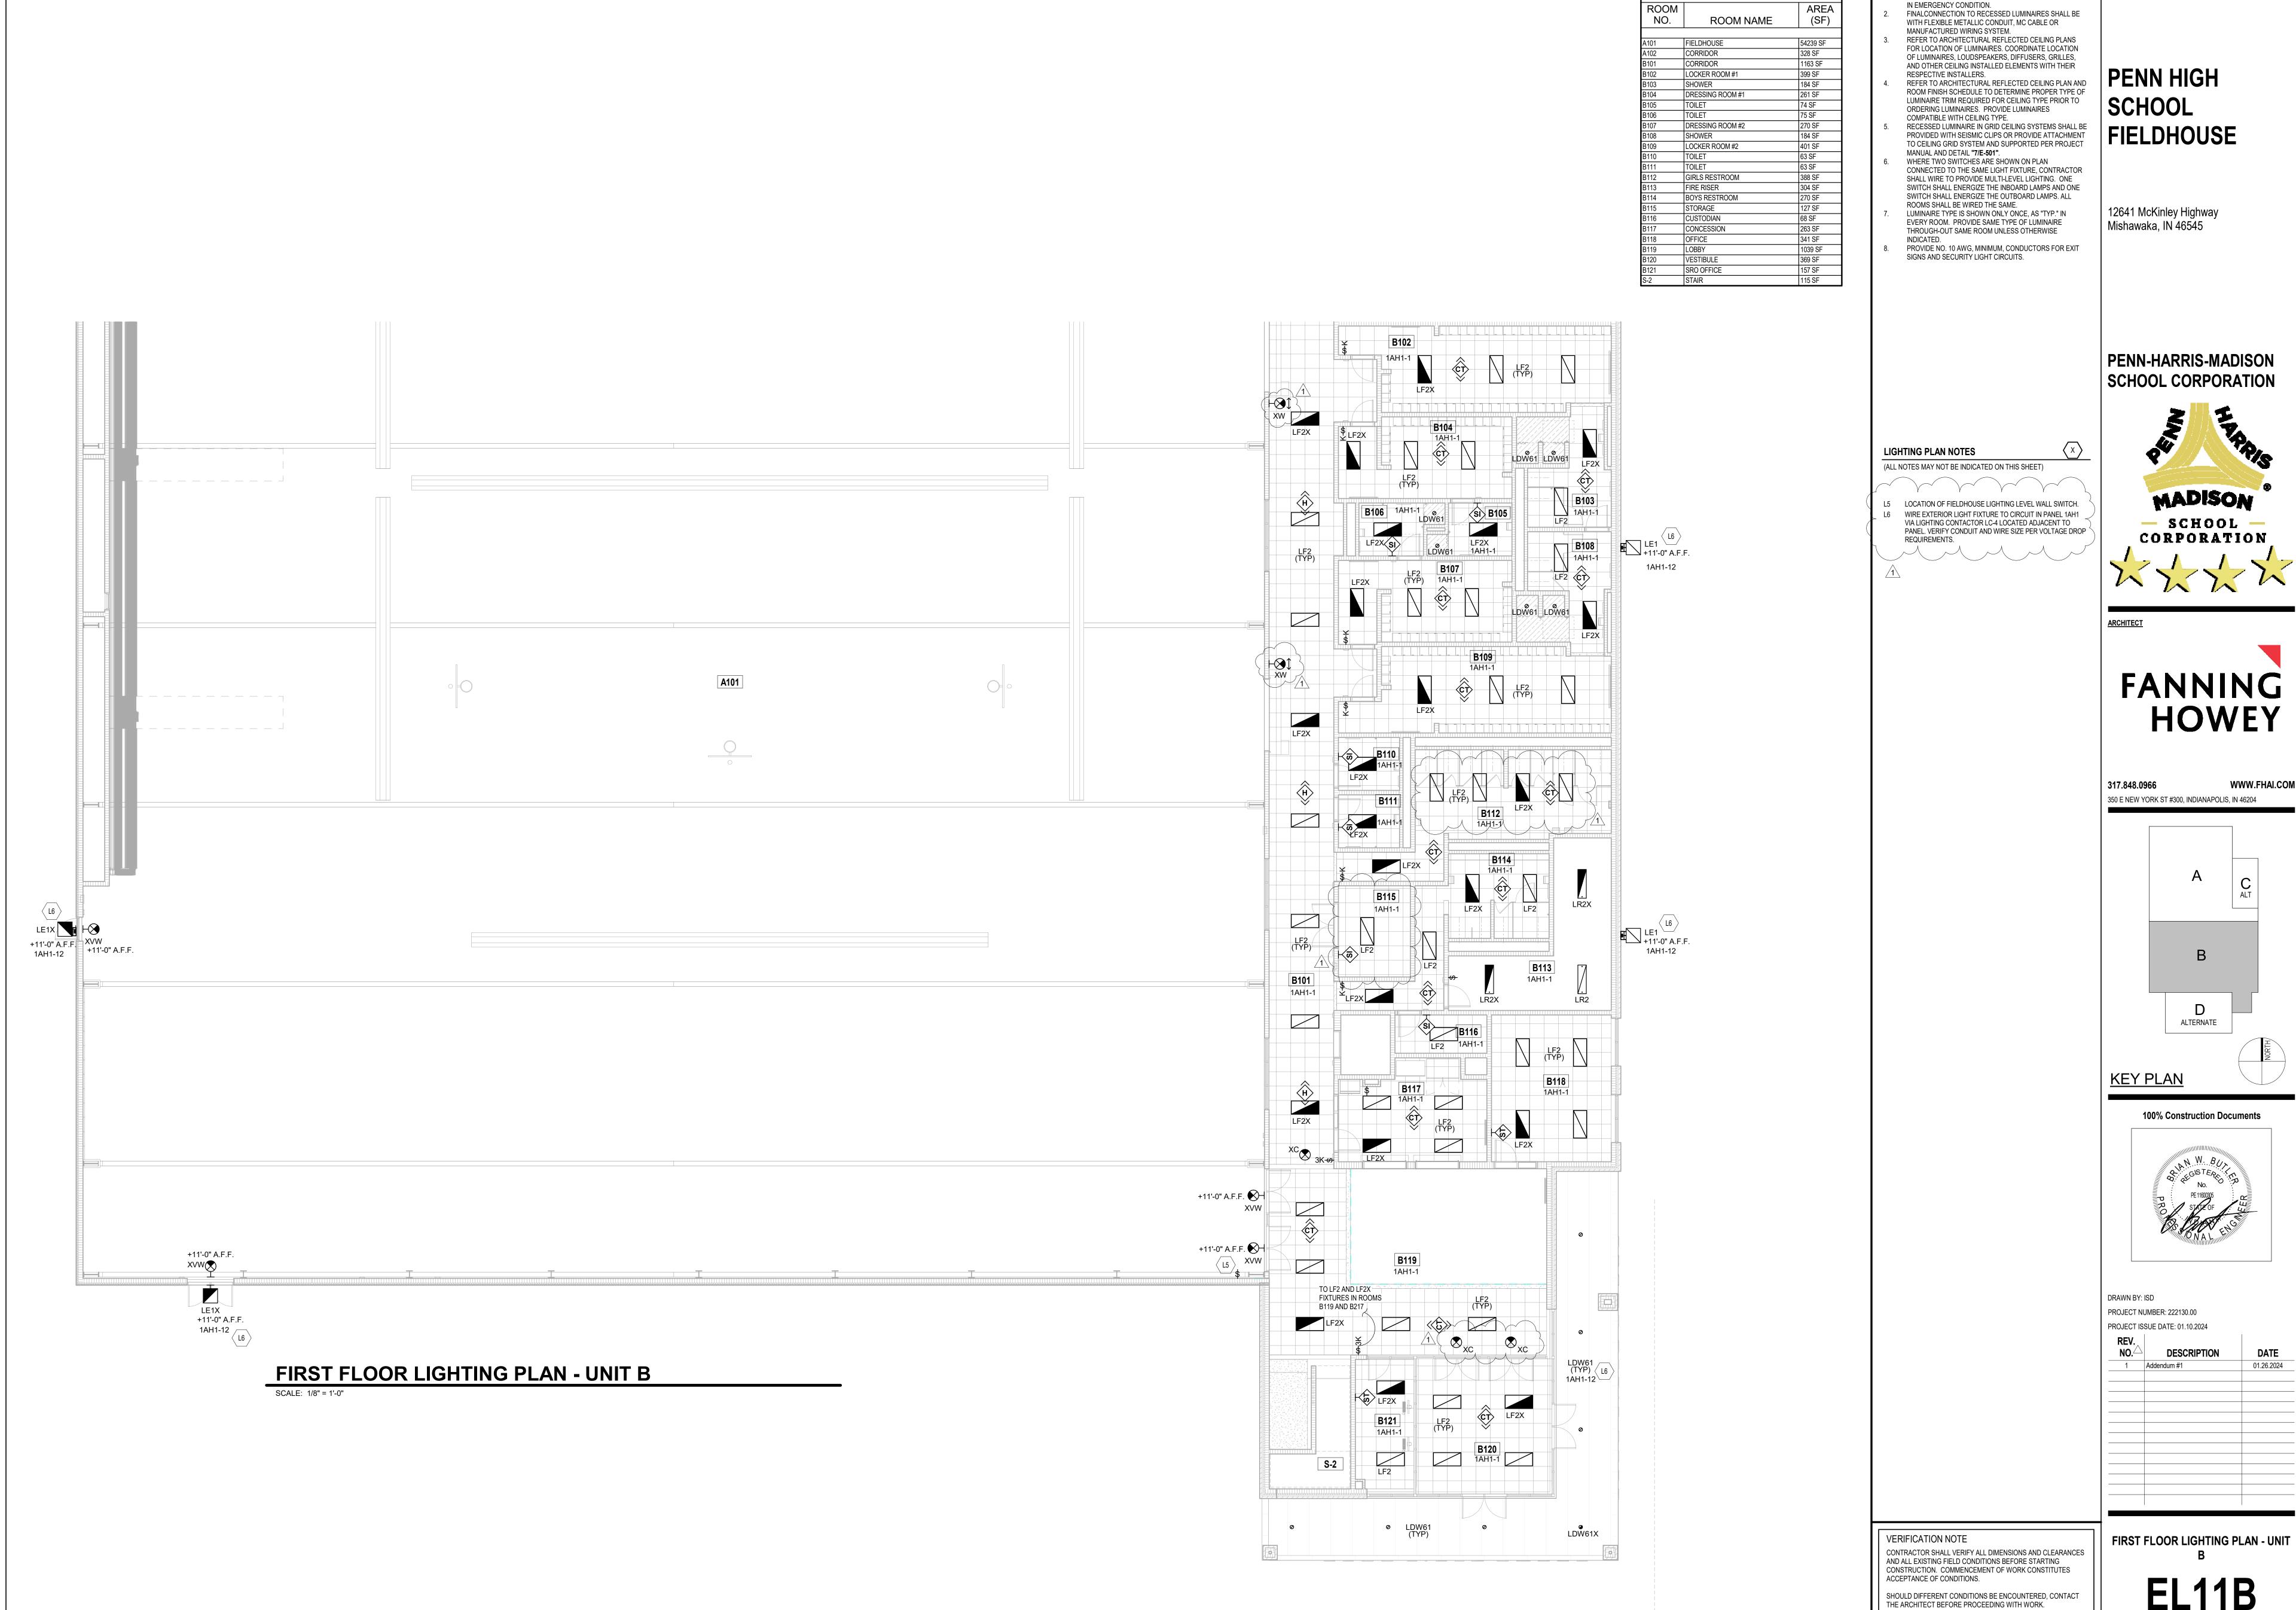
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FIRST FLOOR LIGHTING PLAN - UNIT




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LIGHTING PLAN GENERAL NOTES


GENERATOR TRANSFER DEVICE TO TAKE FIXTURE TO 100%

ROOM LEGEND

ROOM LEGEND		
ROOM		AR
NO.	ROOM NAME	(S
A101	FIELDHOUSE	54239 5
A102	CORRIDOR	328 SF
A103	CORRIDOR	296 SF
B119	LOBBY	1039 SF
S-1	STAIR	81 SF
S-2	STAIR	115 SF

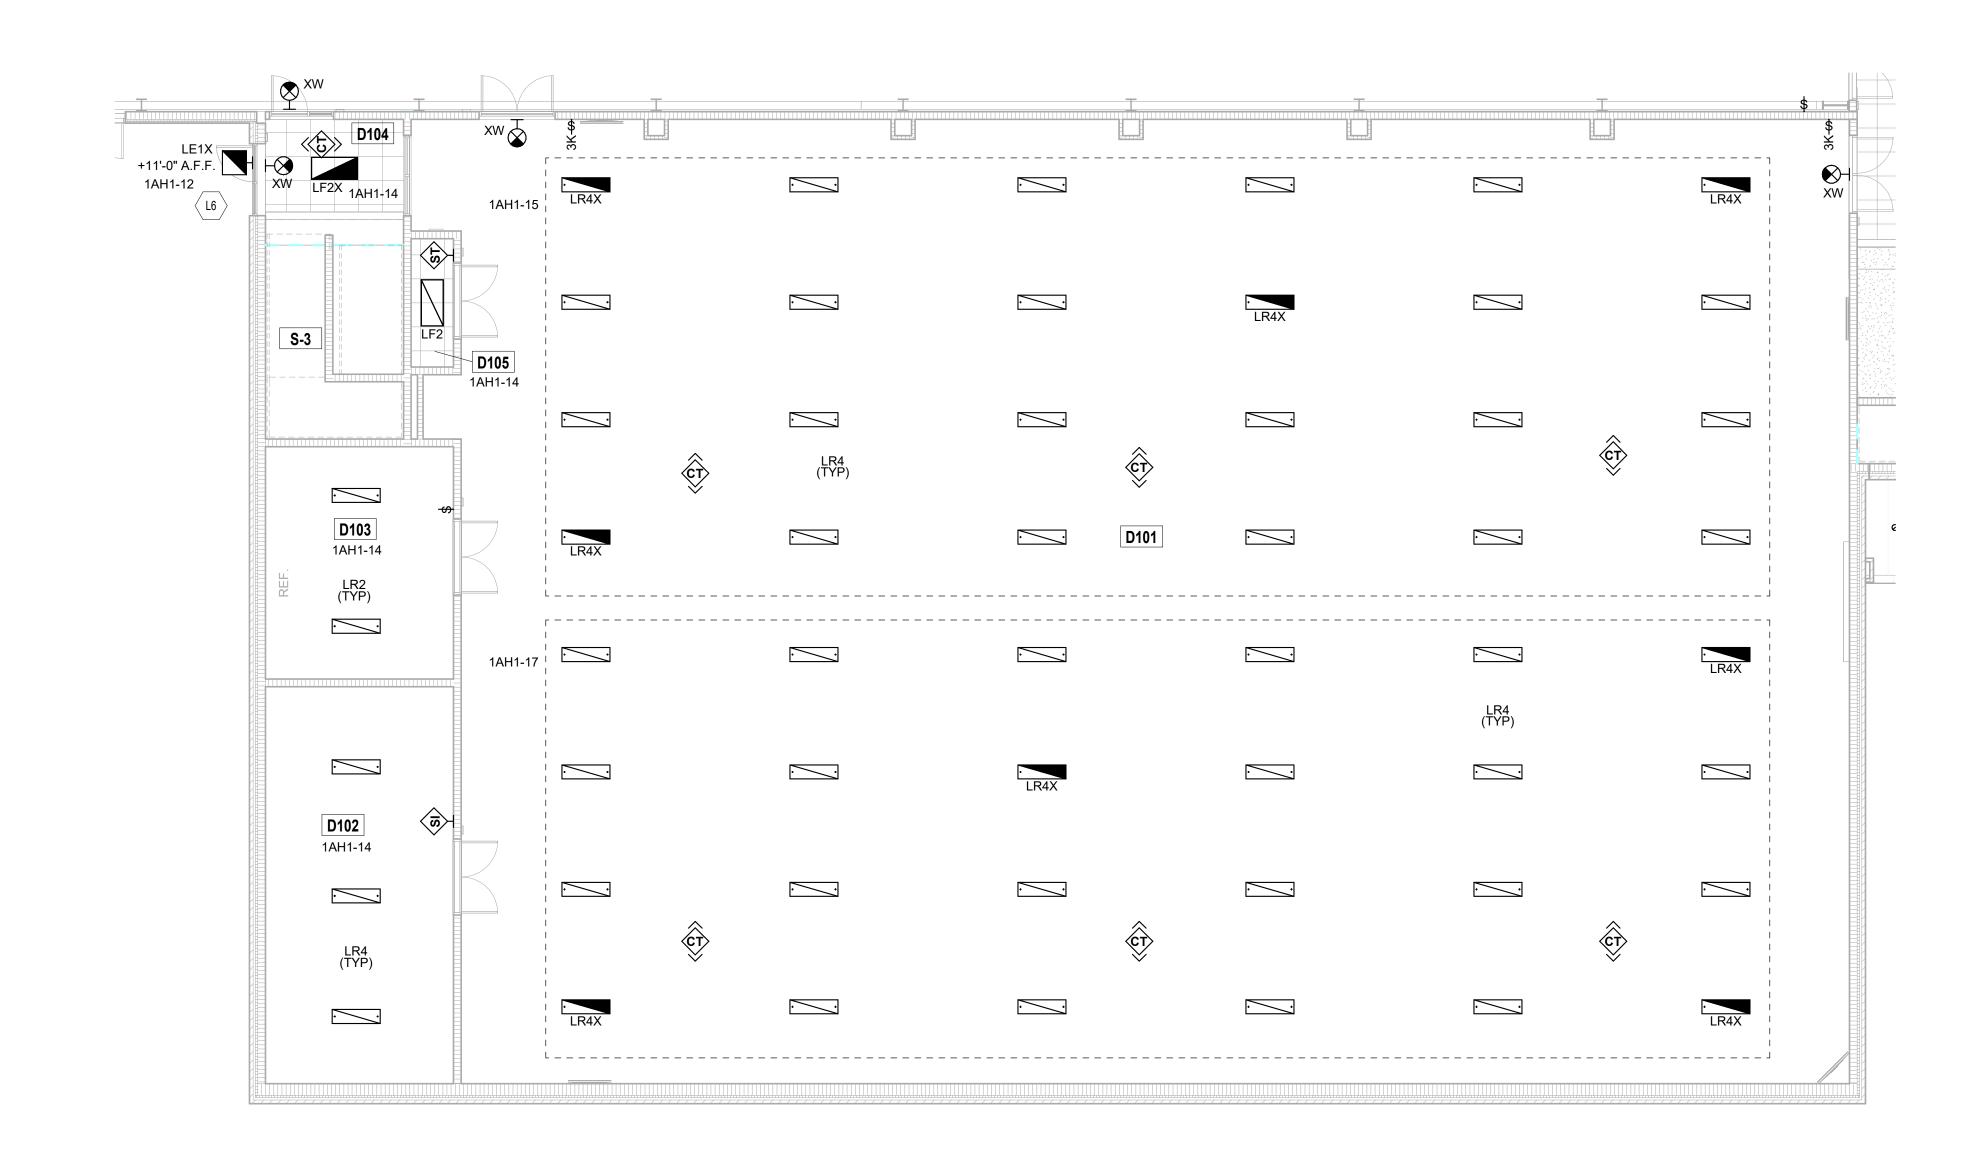

FIRST FLOOR LIGHTING PLAN ALTERNATE - UNIT D

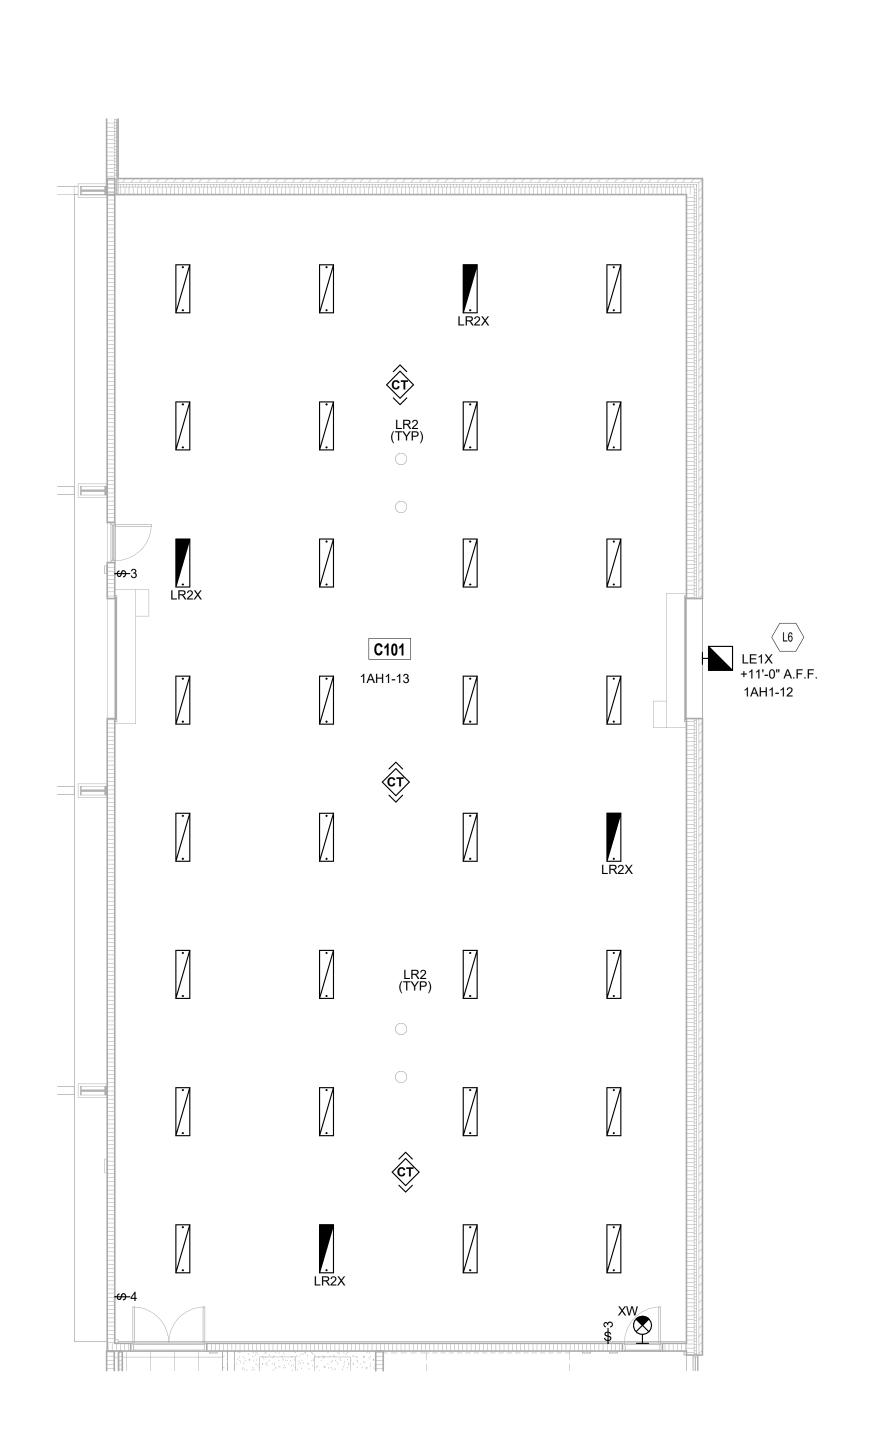

FIRST FLOOR LIGHTING PLAN ALTERNATE - UNIT C

LIGHTING PLAN GENERAL NOTES

RESPECTIVE INSTALLERS.

LIGHTING PLAN NOTES

REQUIREMENTS.

(ALL NOTES MAY NOT BE INDICATED ON THIS SHEET)

- 1. GENERATOR TRANSFER DEVICE TO TAKE FIXTURE TO 100% IN EMERGENCY CONDITION. FINALCONNECTION TO RECESSED LUMINAIRES SHALL BE
- WITH FLEXIBLE METALLIC CONDUIT, MC CABLE OR MANUFACTURED WIRING SYSTEM. REFER TO ARCHITECTURAL REFLECTED CEILING PLANS FOR LOCATION OF LUMINAIRES. COORDINATE LOCATION OF LUMINAIRES, LOUDSPEAKERS, DIFFUSERS, GRILLES, AND OTHER CEILING INSTALLED ELEMENTS WITH THEIR
- REFER TO ARCHITECTURAL REFLECTED CEILING PLAN AND ROOM FINISH SCHEDULE TO DETERMINE PROPER TYPE OF LUMINAIRE TRIM REQUIRED FOR CEILING TYPE PRIOR TO ORDERING LUMINAIRES. PROVIDE LUMINAIRES COMPATIBLE WITH CEILING TYPE. RECESSED LUMINAIRE IN GRID CEILING SYSTEMS SHALL BE PROVIDED WITH SEISMIC CLIPS OR PROVIDE ATTACHMENT TO CEILING GRID SYSTEM AND SUPPORTED PER PROJECT MANUAL AND DETAIL "7/E-501".
- WHERE TWO SWITCHES ARE SHOWN ON PLAN CONNECTED TO THE SAME LIGHT FIXTURE, CONTRACTOR SHALL WIRE TO PROVIDE MULTI-LEVEL LIGHTING. ONE SWITCH SHALL ENERGIZE THE INBOARD LAMPS AND ONE SWITCH SHALL ENERGIZE THE OUTBOARD LAMPS. ALL ROOMS SHALL BE WIRED THE SAME. LUMINAIRE TYPE IS SHOWN ONLY ONCE, AS "TYP." IN EVERY ROOM. PROVIDE SAME TYPE OF LUMINAIRE THROUGH-OUT SAME ROOM UNLESS OTHERWISE
- INDICATED. PROVIDE NO. 10 AWG, MINIMUM, CONDUCTORS FOR EXIT SIGNS AND SECURITY LIGHT CIRCUITS.

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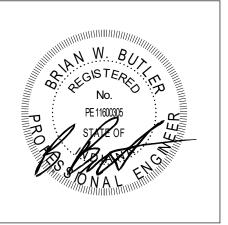
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MADISON L6 WIRE EXTERIOR LIGHT FIXTURE TO CIRCUIT IN PANEL 1AH1 VIA LIGHTING CONTACTOR LC-4 LOCATED ADJACENT TO — school — PANEL. VERIFY CONDUIT AND WIRE SIZE PER VOLTAGE DROP CORPORATION

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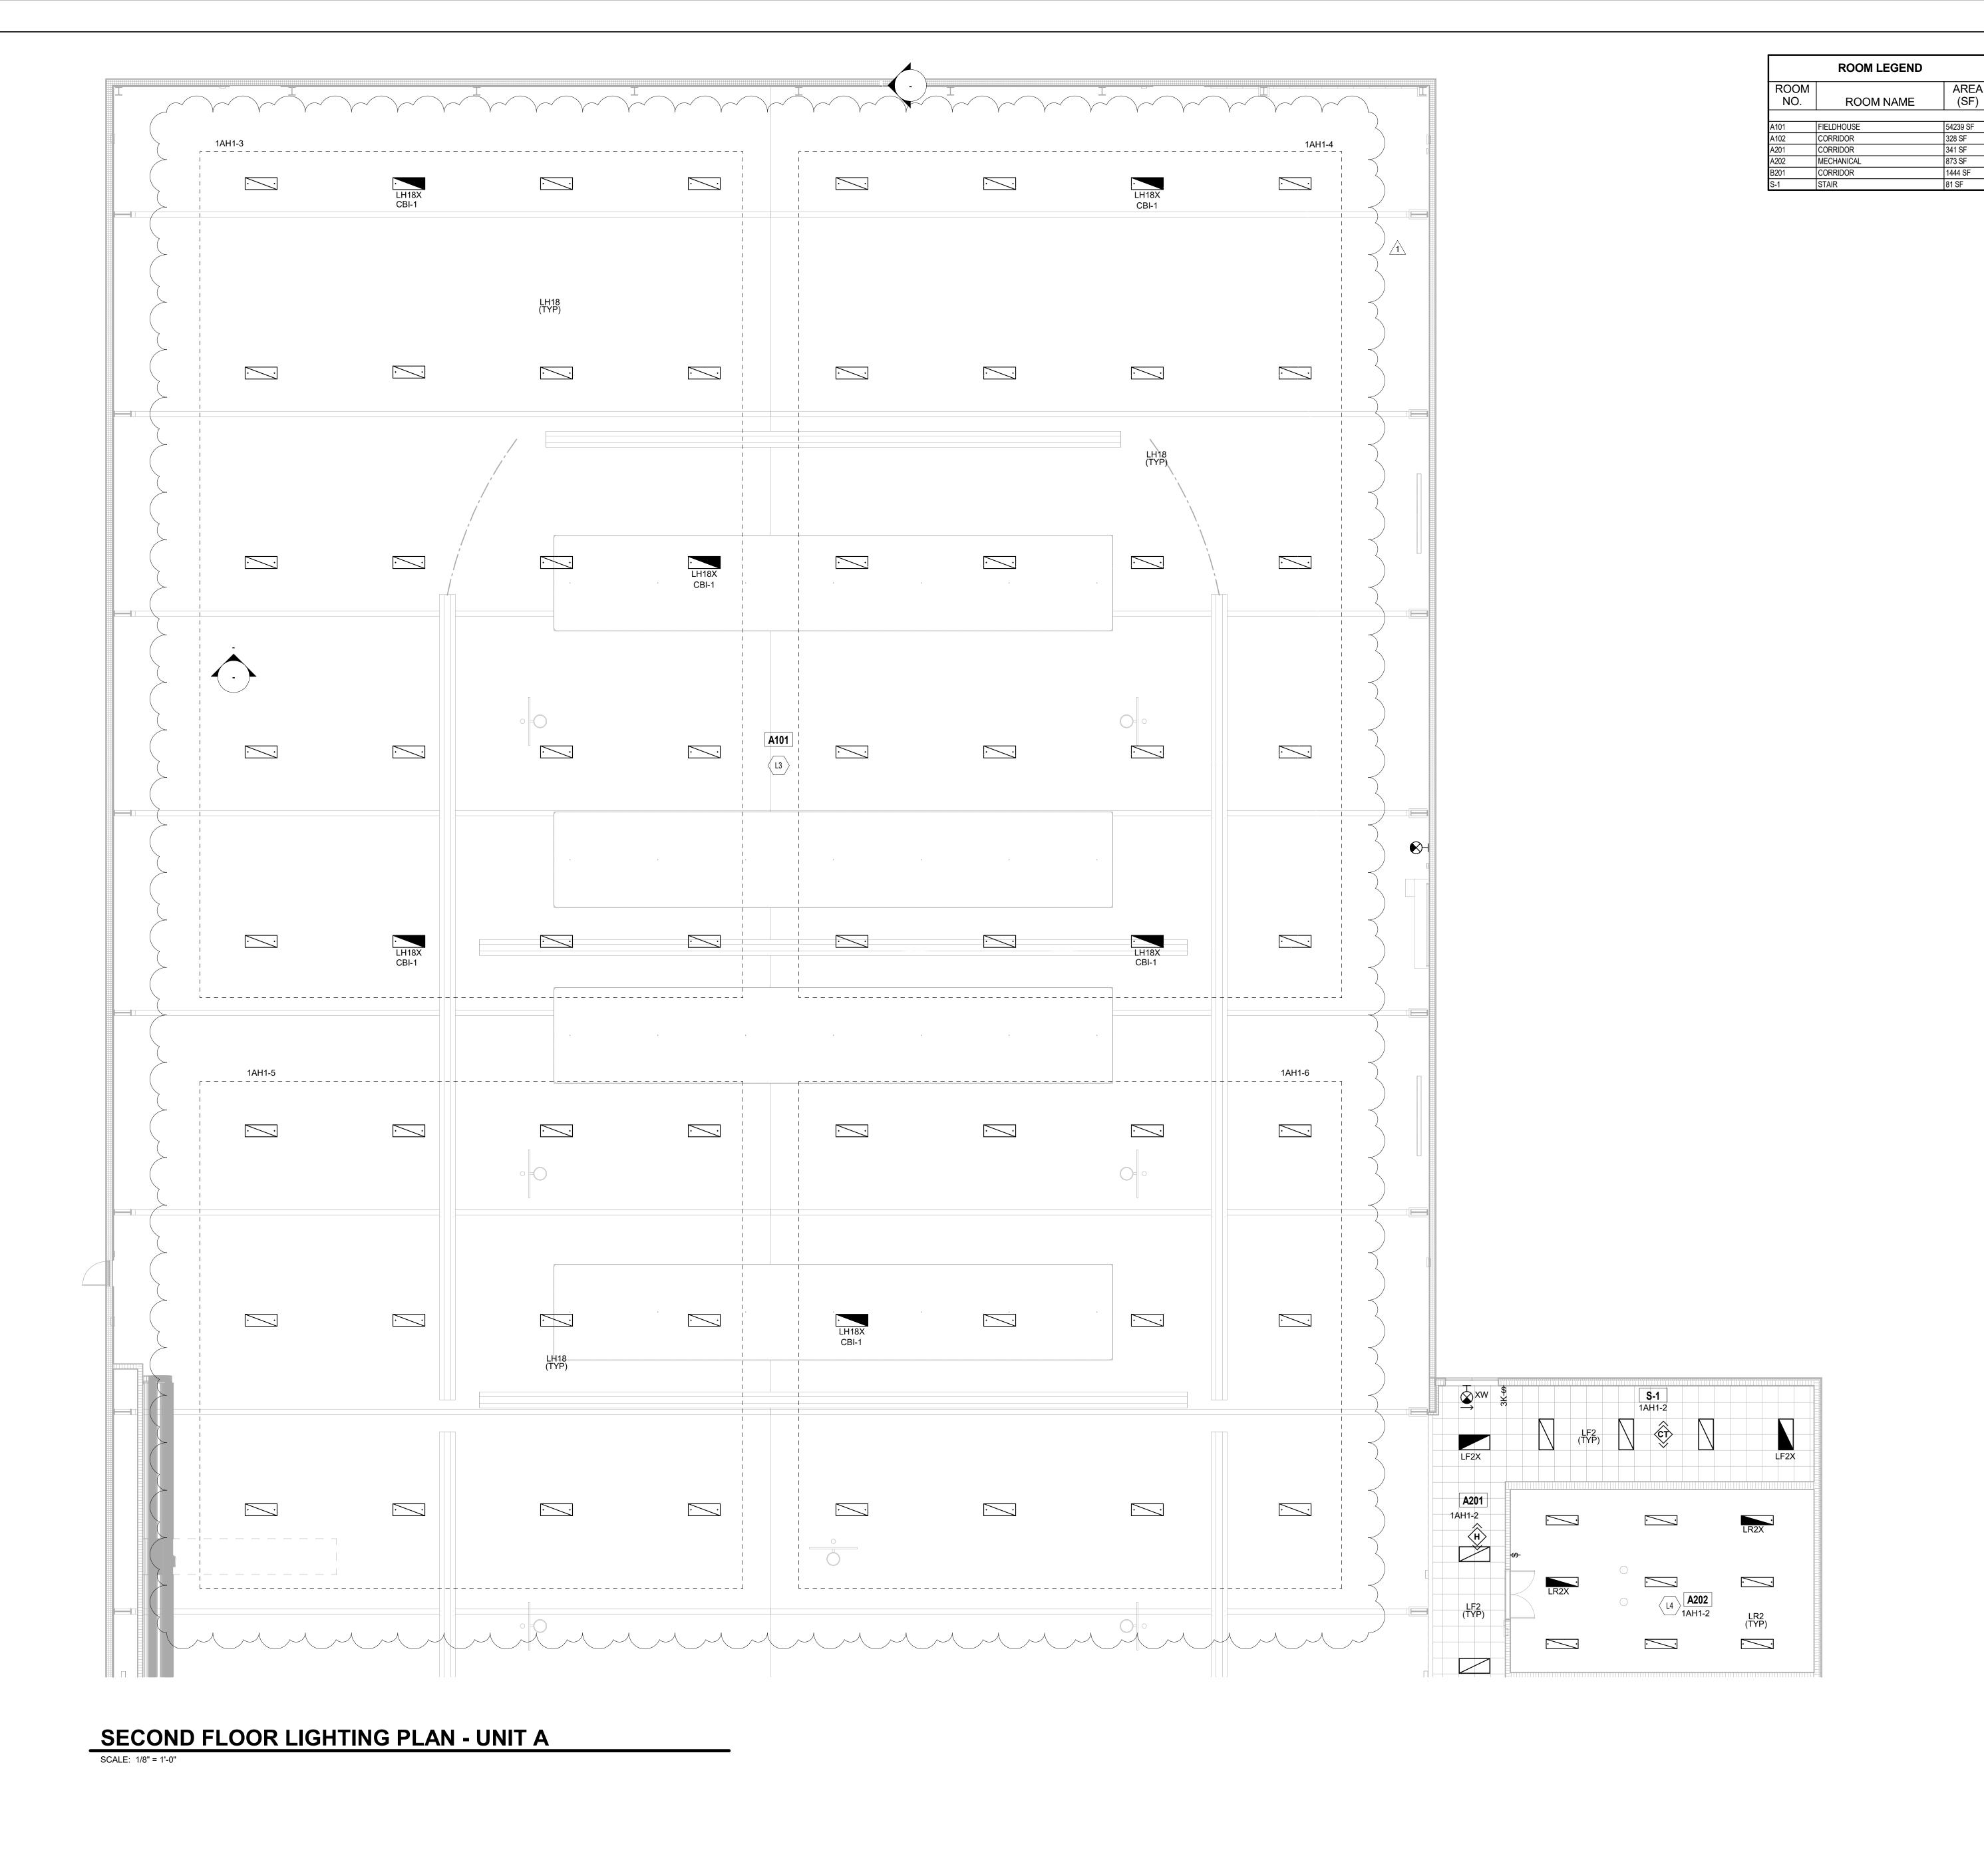


PROJECT NUMBER: 222130.00 PROJECT ISSUE DATE: 01.10.2024

VERIFICATION NOTE CONTRACTOR SHALL VERIFY ALL DIMENSIONS AND CLEARANCES AND ALL EXISTING FIELD CONDITIONS BEFORE STARTING CONSTRUCTION. COMMENCEMENT OF WORK CONSTITUTES

ACCEPTANCE OF CONDITIONS. SHOULD DIFFERENT CONDITIONS BE ENCOUNTERED, CONTACT THE ARCHITECT BEFORE PROCEEDING WITH WORK.

FIRST FLOOR LIGHTING PLAN ALTERNATE - UNIT C AND D



LIGHTING PLAN GENERAL NOTES

 GENERATOR TRANSFER DEVICE TO TAKE FIXTURE TO 100% IN EMERGENCY CONDITION.
 FINALCONNECTION TO RECESSED LUMINAIRES SHALL BE

FINALCONNECTION TO RECESSED LUMINAIRES SHALL BE WITH FLEXIBLE METALLIC CONDUIT, MC CABLE OR MANUFACTURED WIRING SYSTEM.
REFER TO ARCHITECTURAL REFLECTED CEILING PLANS FOR LOCATION OF LUMINAIRES. COORDINATE LOCATION OF LUMINAIRES, LOUDSPEAKERS, DIFFUSERS, GRILLES,

AND OTHER CEILING INSTALLED ELEMENTS WITH THEIR

RESPECTIVE INSTALLERS.

4. REFER TO ARCHITECTURAL REFLECTED CEILING PLAN AND ROOM FINISH SCHEDULE TO DETERMINE PROPER TYPE OF LUMINAIRE TRIM REQUIRED FOR CEILING TYPE PRIOR TO ORDERING LUMINAIRES. PROVIDE LUMINAIRES COMPATIBLE WITH CEILING TYPE.

5. RECESSED LUMINAIRE IN GRID CEILING SYSTEMS SHALL BE PROVIDED WITH SEISMIC CLIPS OR PROVIDE ATTACHMENT TO CEILING GRID SYSTEM AND SUPPORTED PER PROJECT

MANUAL AND DETAIL "7/E-501".

6. WHERE TWO SWITCHES ARE SHOWN ON PLAN CONNECTED TO THE SAME LIGHT FIXTURE, CONTRACTOR SHALL WIRE TO PROVIDE MULTI-LEVEL LIGHTING. ONE SWITCH SHALL ENERGIZE THE INBOARD LAMPS AND ONE SWITCH SHALL ENERGIZE THE OUTBOARD LAMPS. ALL ROOMS SHALL BE WIRED THE SAME.

7. LUMINAIRE TYPE IS SHOWN ONLY ONCE, AS "TYP." IN EVERY ROOM. PROVIDE SAME TYPE OF LUMINAIRE

THROUGH-OUT SAME ROOM UNLESS OTHERWISE

INDICATED.
PROVIDE NO. 10 AWG, MINIMUM, CONDUCTORS FOR EXIT
SIGNS AND SECURITY LIGHT CIRCUITS.

LIGHTING PLAN NOTES

STRUCTURE.

(ALL NOTES MAY NOT BE INDICATED ON THIS SHEET)

L3 MOUNT LIGHT FIXTURES EVEN WITH THE BOTTOM CHORD OF

L4 MOUNT LIGHT FIXTURES IN THIS ROOM TO MISS MECHANICAL

PENN HIGH SCHOOL

.____.

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MADISON

SCHOOL

CORPORATION


ARCHITECT

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A C ALT B

KEY PLAN

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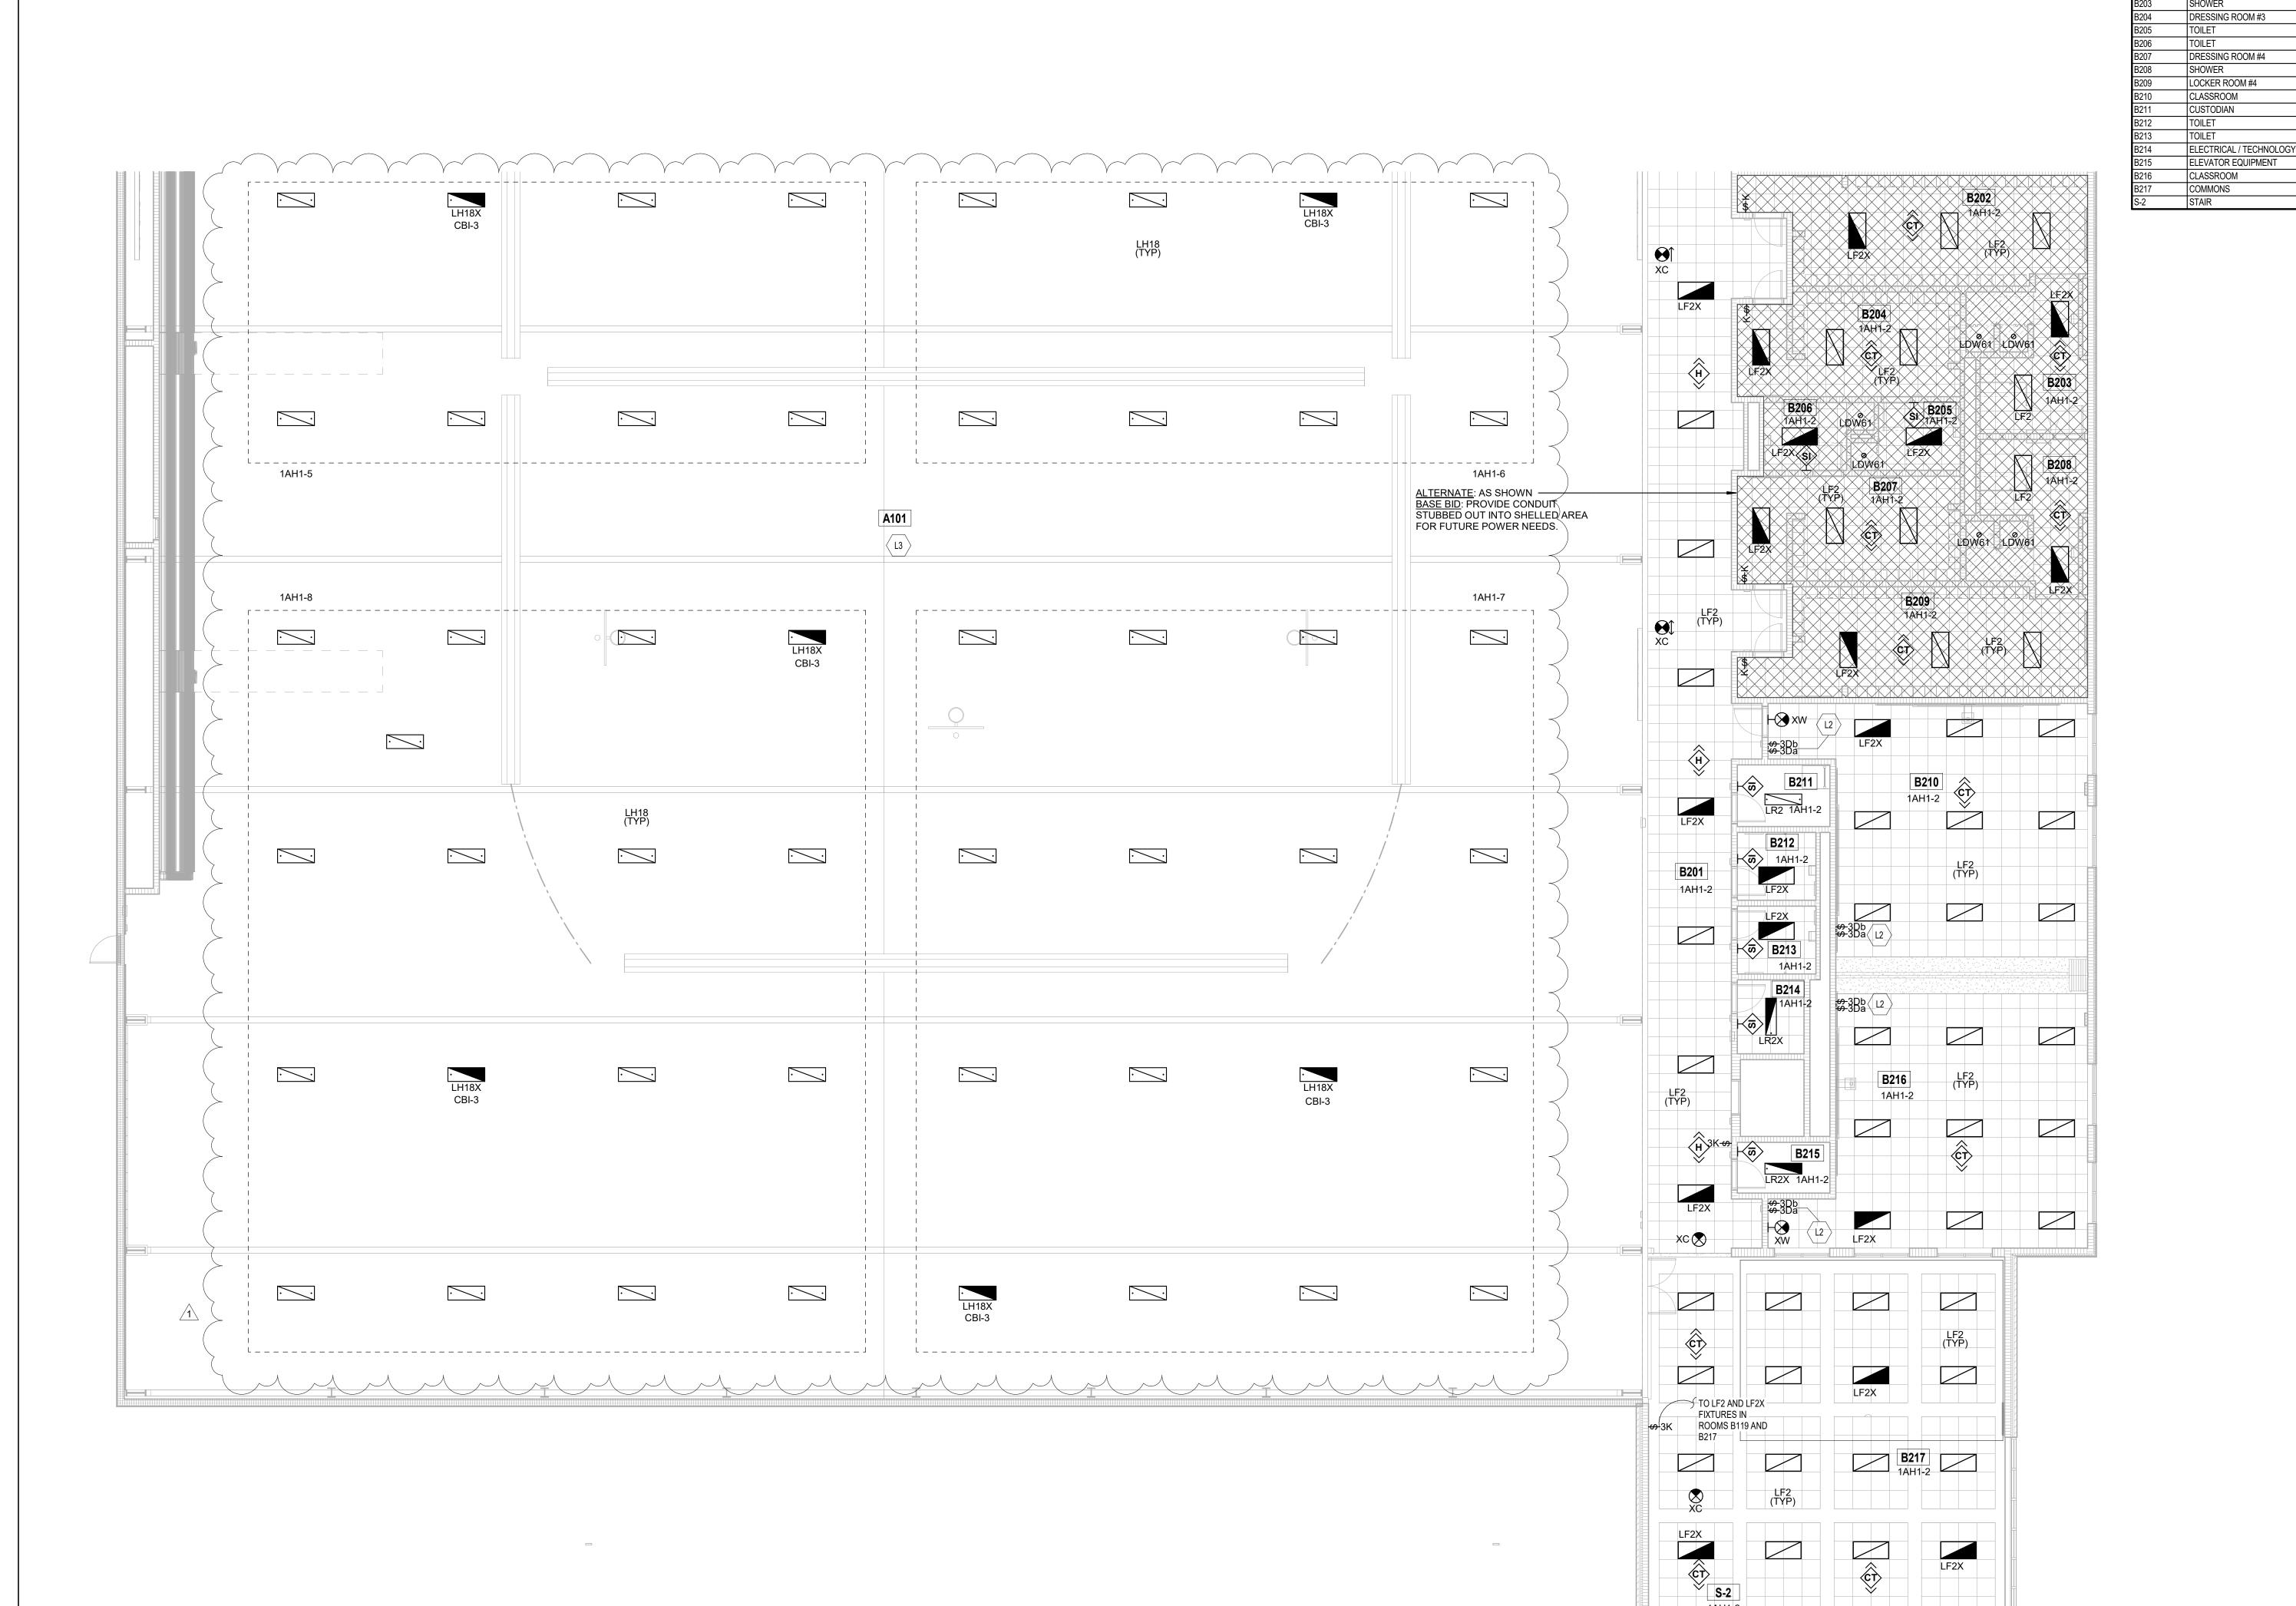
CONTRACTOR SHALL VERIFY ALL DIMENSIONS
AND ALL EXISTING FIELD CONDITIONS REFORE

CONTRACTOR SHALL VERIFY ALL DIMENSIONS AND CLEARANCES
AND ALL EXISTING FIELD CONDITIONS BEFORE STARTING
CONSTRUCTION. COMMENCEMENT OF WORK CONSTITUTES
ACCEPTANCE OF CONDITIONS.

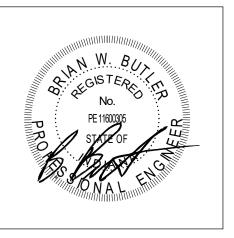SHOULD DIFFERENT CONDITIONS BE ENCOUNTERED, CONTACT THE ARCHITECT BEFORE PROCEEDING WITH WORK.

SECOND FLOOR LIGHTING PLAN -UNIT A

EL12A



SECOND FLOOR LIGHTING PLAN - UNIT B

ROOM LEGEND LIGHTING PLAN GENERAL NOTES

1444 SF

399 SF

184 SF

184 SF

984 SF

175 SF

NO.

LOCKER ROOM #3

AREA
ROOM NAME

(SF)

1. GENERATOR TRANSFER DEVICE TO TAKE FIXTURE TO 100% IN EMERGENCY CONDITION.
2. FINALCONNECTION TO RECESSED LUMINAIRES SHALL BE WITH FLEXIBLE METALLIC CONDUIT, MC CABLE OR MANUFACTURED WIRING SYSTEM.

10 SEPTEMBLY OF THE PROPERTY OF

MANUFACTURED WIRING SYSTEM.

3. REFER TO ARCHITECTURAL REFLECTED CEILING PLANS FOR LOCATION OF LUMINAIRES. COORDINATE LOCATION OF LUMINAIRES, LOUDSPEAKERS, DIFFUSERS, GRILLES, AND OTHER CEILING INSTALLED ELEMENTS WITH THEIR RESPECTIVE INSTALLERS.

4. REFER TO ARCHITECTURAL REFLECTED CEILING PLAN AND ROOM FINISH SCHEDLULE TO DETERMINE PROPER TYPE OF

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PROVIDE NO. 10 AWG, MINIMUM, CONDUCTORS FOR EXIT SIGNS AND SECURITY LIGHT CIRCUITS.

LIGHTING PLAN NOTES

(ALL NOTES MAY NOT BE INDICATED ON THIS SHEET)

OTHER LIGHT FIXTURES IN THIS ROOM.

WIRE ONE DIMMER SWITCH TO LIGHT FIXTURES ALONG TEACHING WALL. WIRE THE OTHER DIMMER SWITCH TO ALL

MOUNT LIGHT FIXTURES EVEN WITH THE BOTTOM CHORD OF

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PENN HIGH SCHOOL FIELDHOUSE

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PENN-HARRIS-MADISON SCHOOL CORPORATION

MADISON

SCHOOL —
CORPORATION

POUITEOT


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A CALT

B

KEY PLAN

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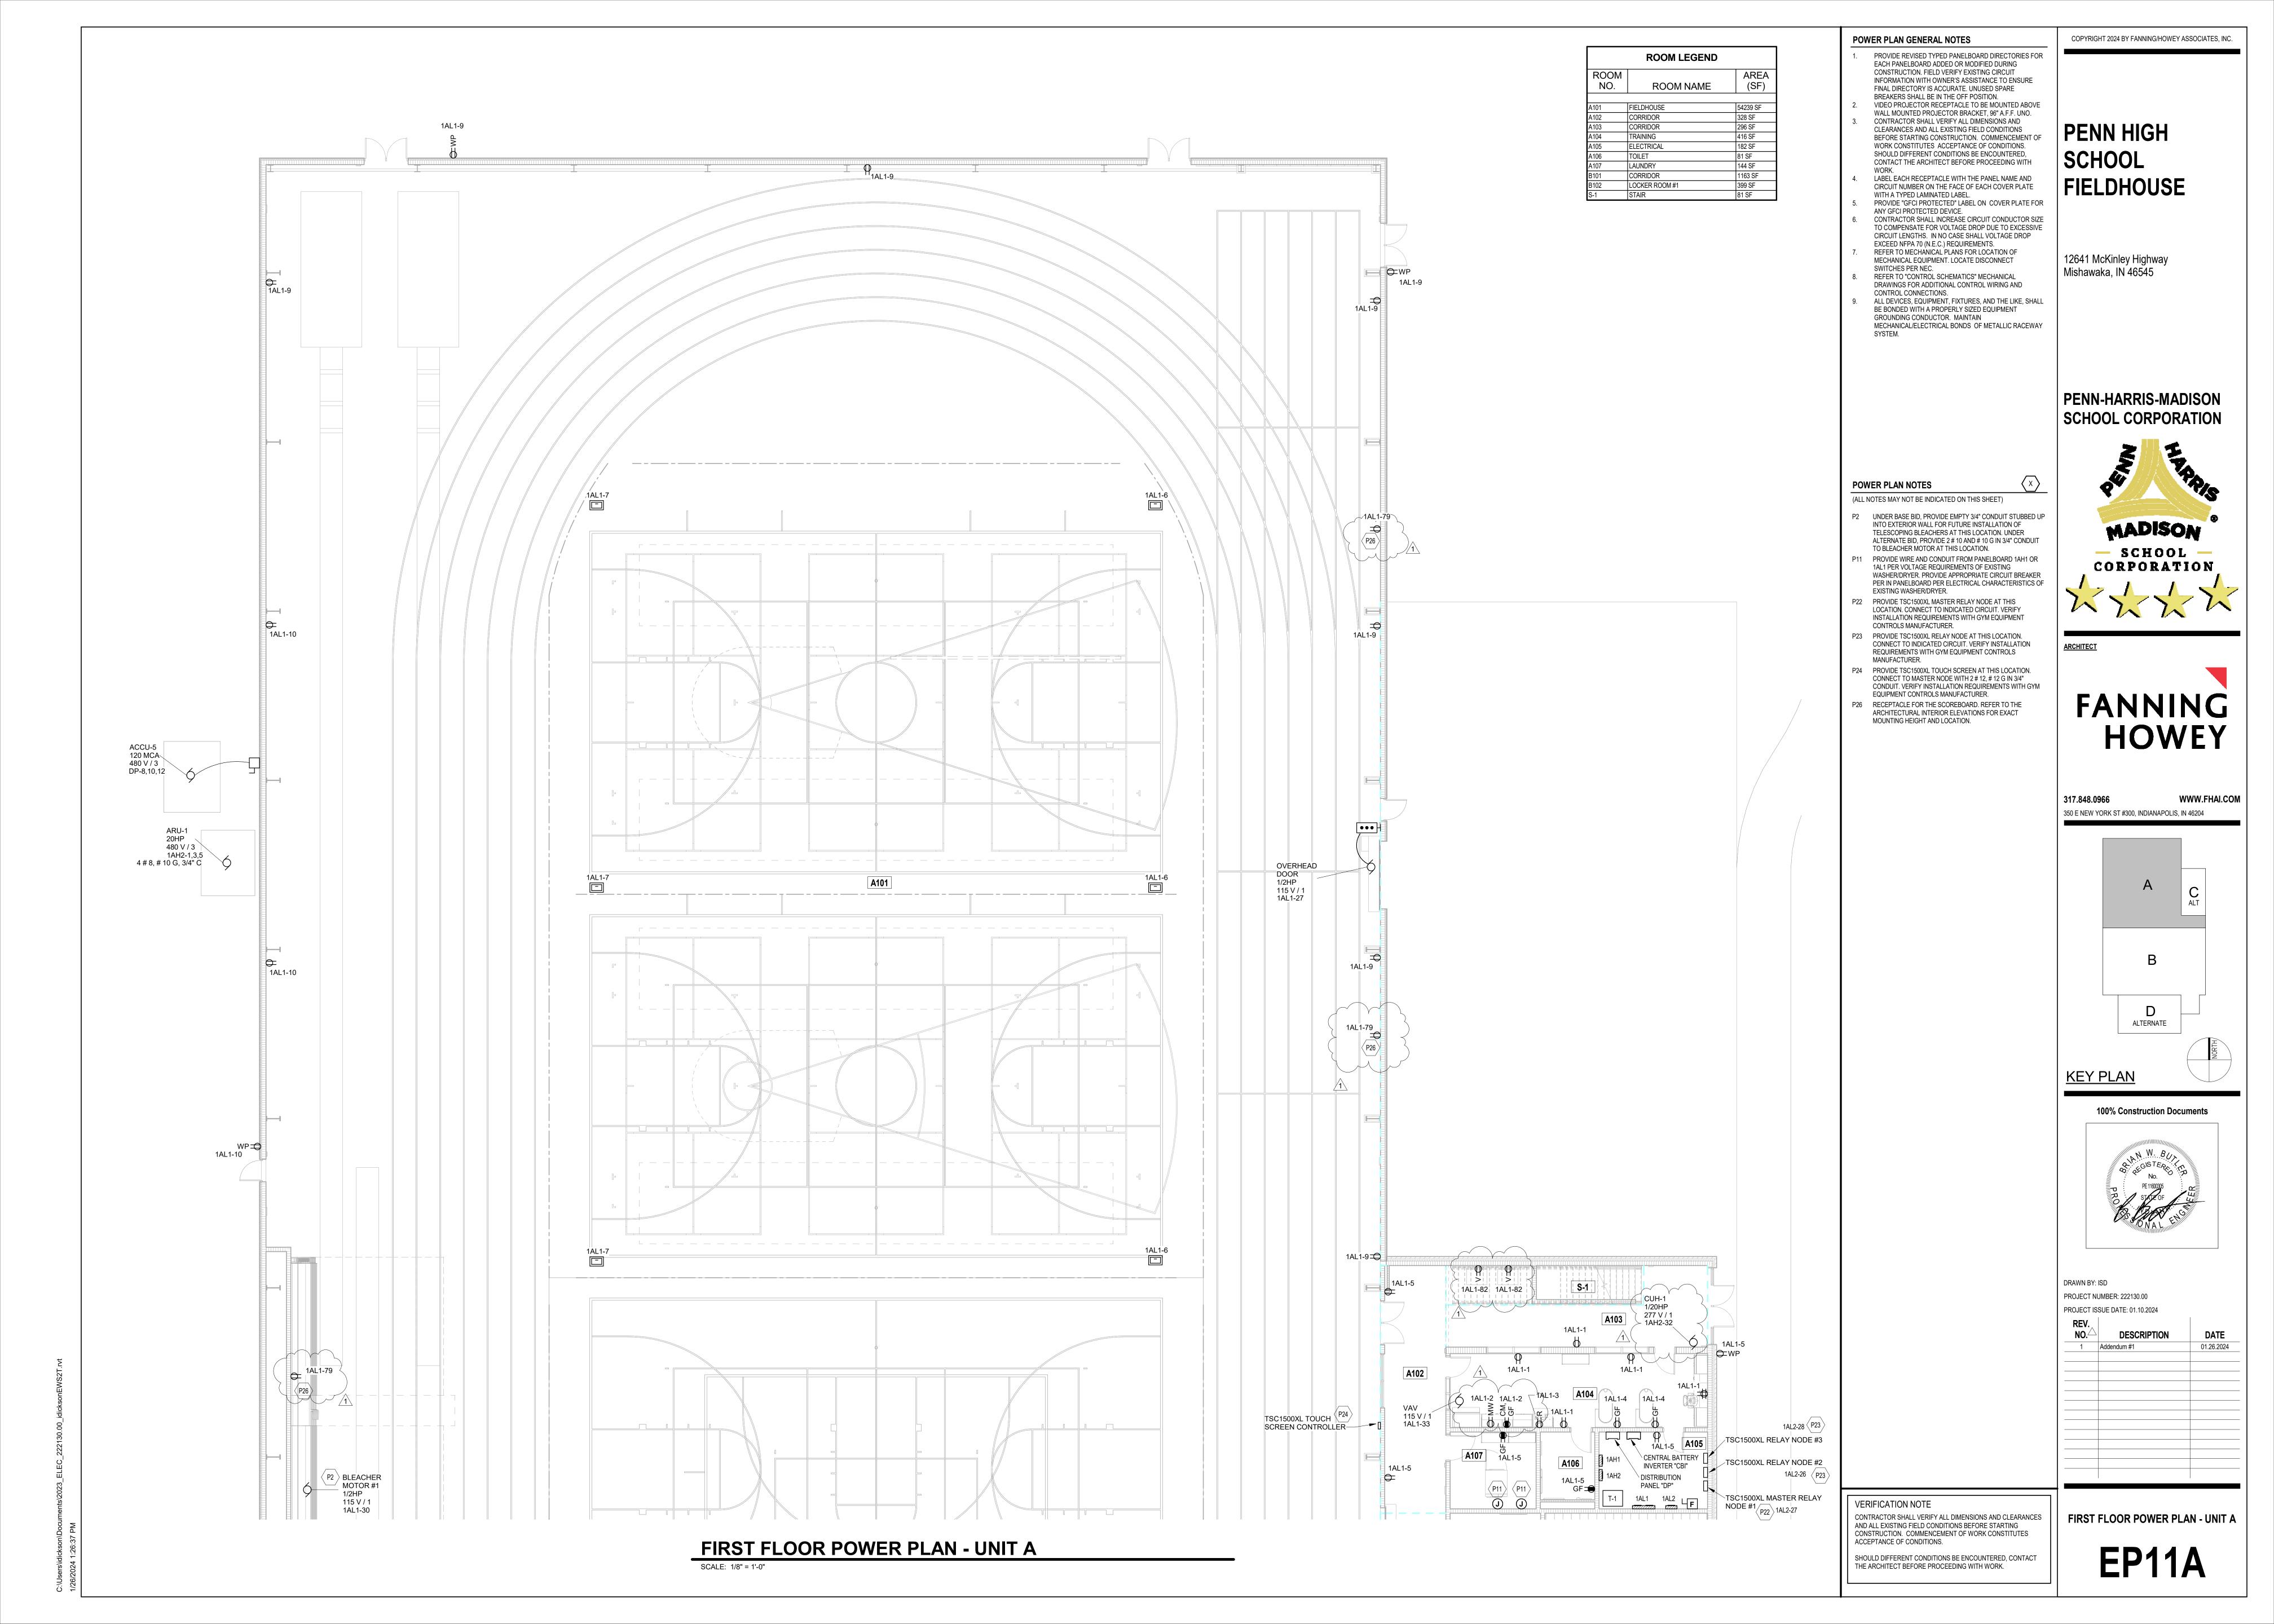
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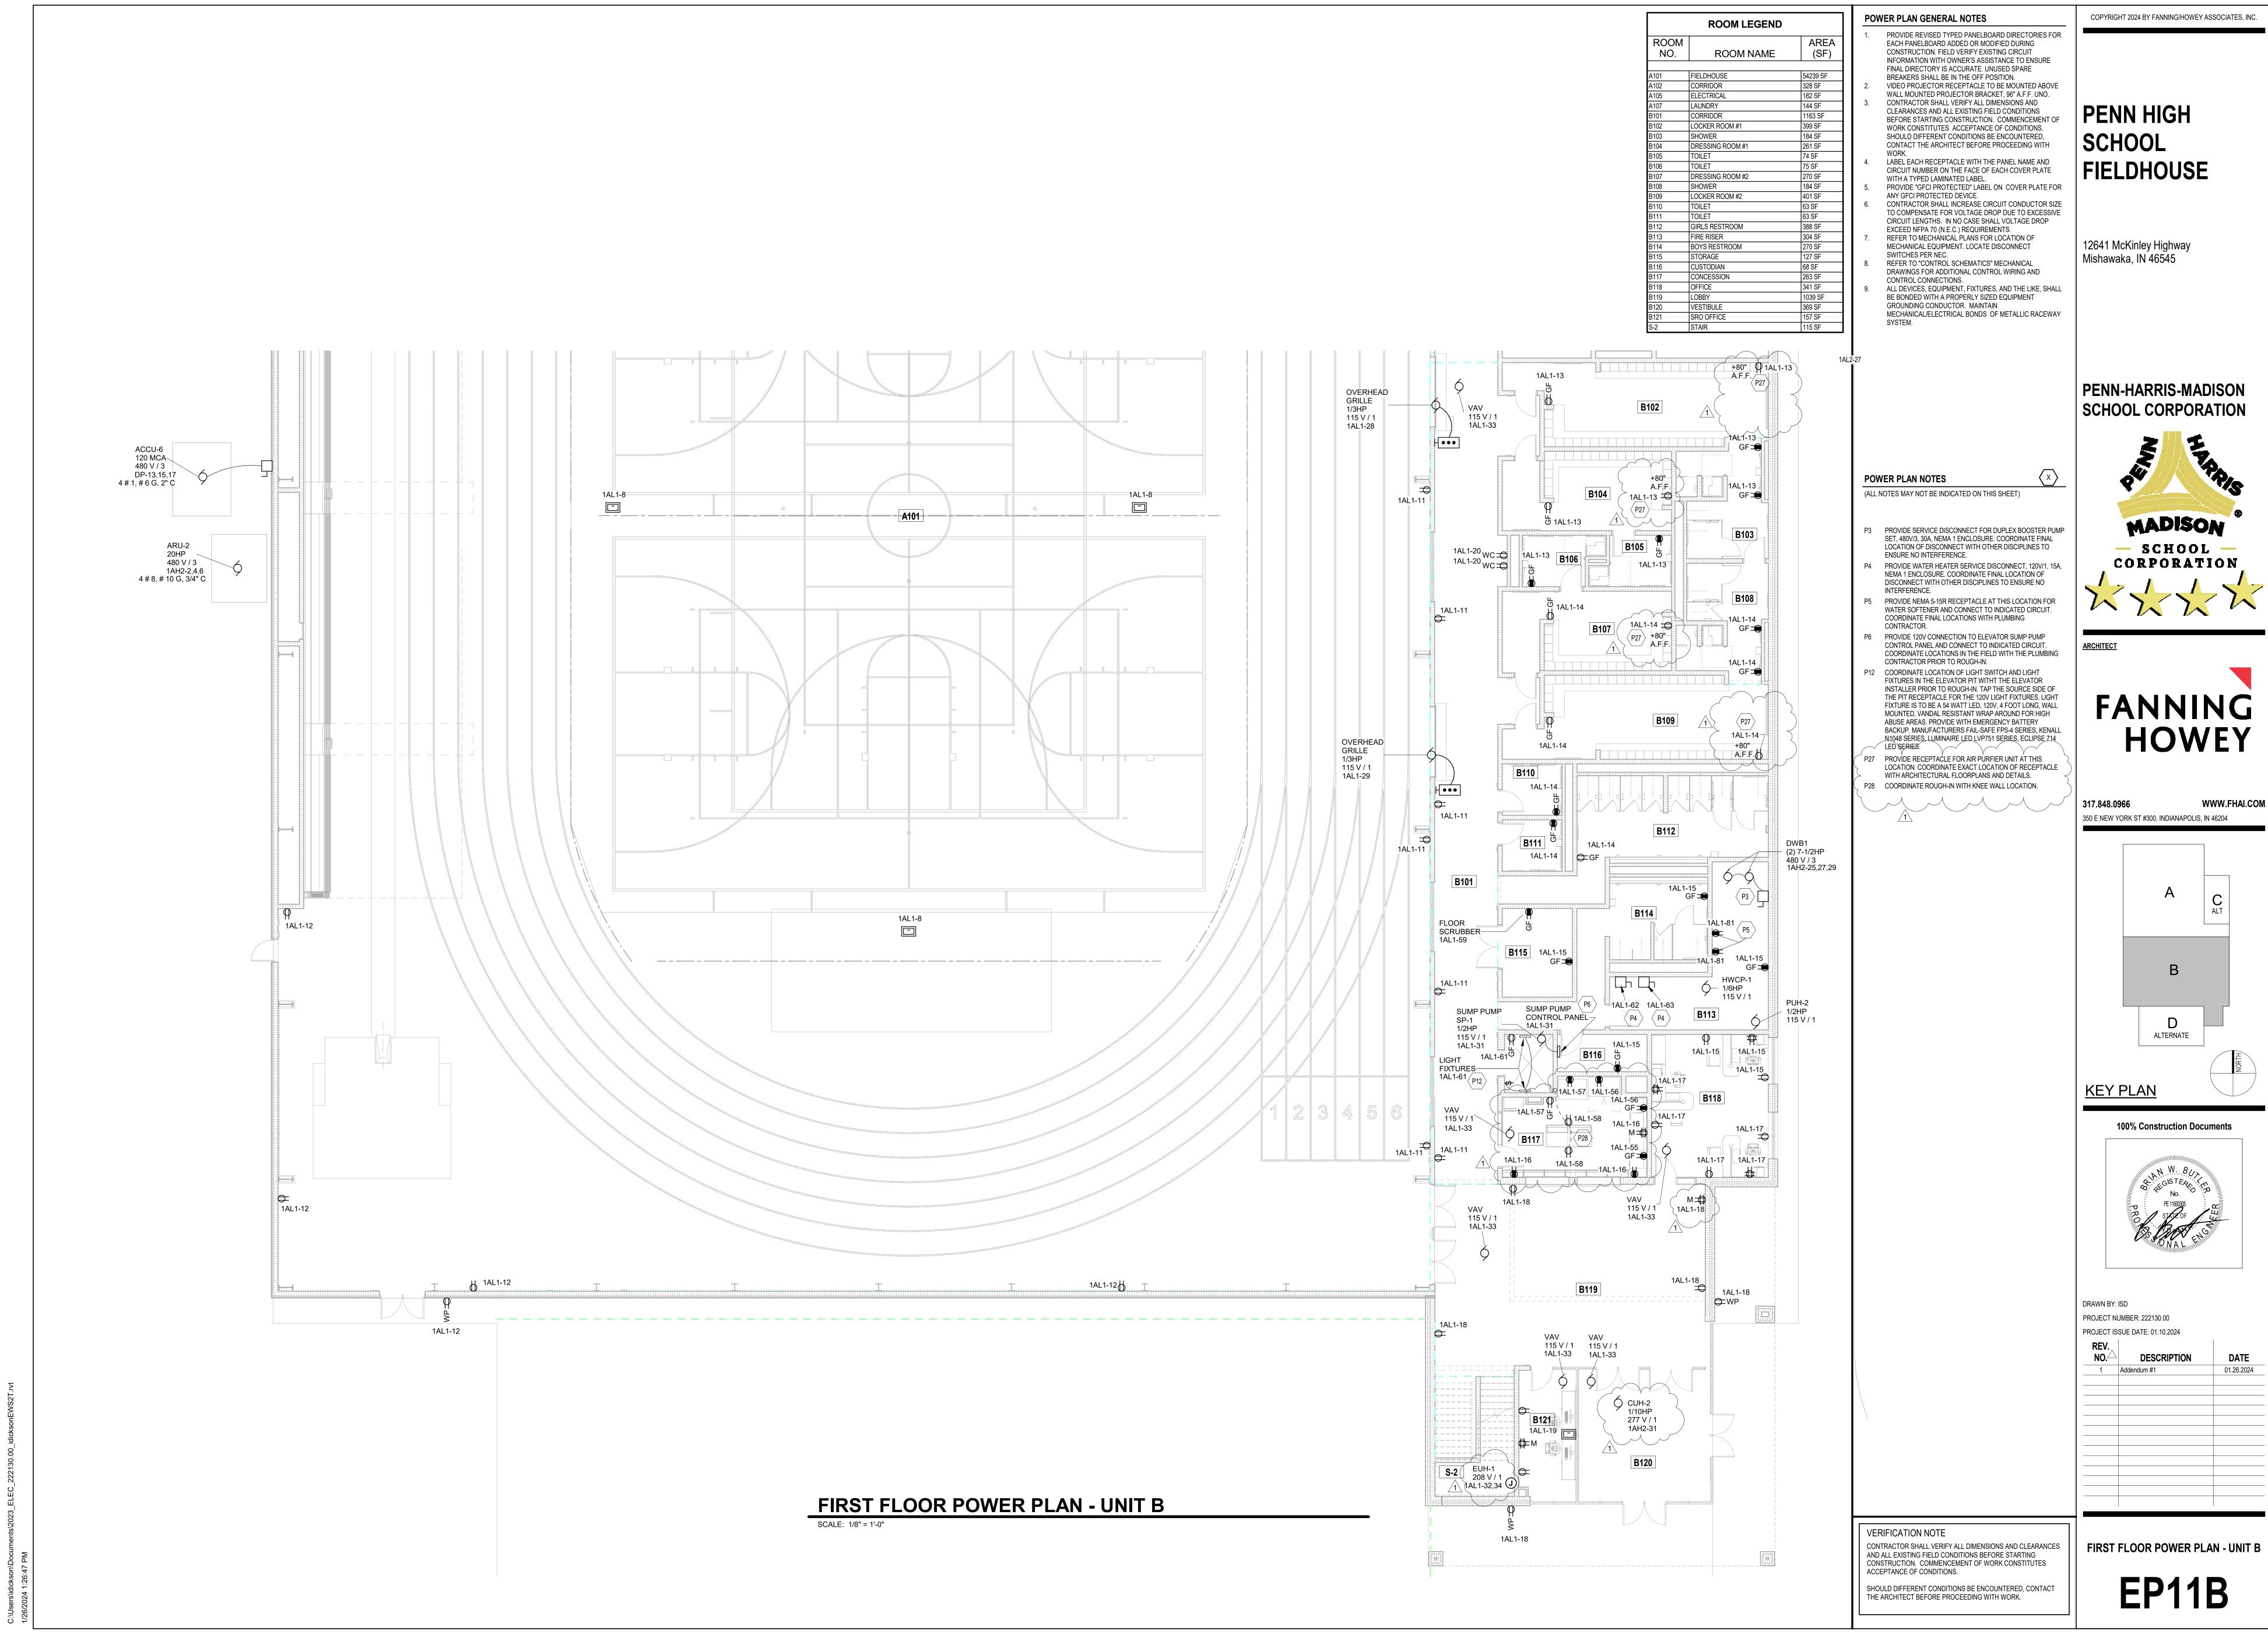
CONTRACTOR SHALL VERIFY ALL DIMENSIONS AND CLEARANCES
AND ALL EXISTING FIELD CONDITIONS BEFORE STARTING
CONSTRUCTION. COMMENCEMENT OF WORK CONSTITUTES
ACCEPTANCE OF CONDITIONS.

SHOULD DIFFERENT CONDITIONS BE ENCOUNTERED, CONTACT THE ARCHITECT BEFORE PROCEEDING WITH WORK.

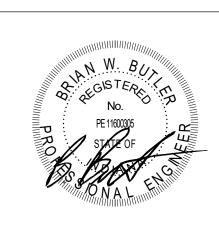SECOND FLOOR LIGHTING PLAN -UNIT B

EL12B






	ROOM LEGEND	
ROOM		AR
NO.	ROOM NAME	(S
A101	FIELDHOUSE	54239 5
B119	LOBBY	1039 SF
S-2	STAIR	115 SF

	EUH-2	AL1-38 \(\frac{1}{2} \)	1AL1-38		1AL1-38	1AL1-38	
	D104	<u>/1</u> \					
	D105	FOR WRESTLING ROOM SOUND					1AL1-40
	+80"	CABINET 1AL1-43					M — — — — — — — — — — — — — — — — — — —
ACCU-4	S-3						1AL1-40
ACCU-4 52 MCA 480 V / 3 DP-19,21,23 4 # 6, # 10 G IN 1" C	D103						
	AHU-3 15HP						
1AL1-46 WP -	480 V / 3 1AH2-26,28,30 4 # 8, # 10 G IN 1" C			D101			1AL1-40
	9 1AL1-46 ■			5101			(P26)
	1AL1-44 1AL1-46						1AL1-40 -
ACCU-3 40 MCA 480 V / 3 DP-20,22,24 4 # 8, # 10 G IN 1" C							
10P-20,22,24 4 # 8, # 10 G IN 1" C	D102 EF-D1						
	1HP 208 V / 3 1AL2-29,31,33 1AL1-44						1AL1-40 —
	9						
	PUH-3 1/20HP 115 V / 1	\(\sum_{\text{\text{\text{\text{\text{\text{\text{\text{\text{\text{\text{\text{\text{\text{\text{\text{\text{\text{\text{\text{\text{\text{\text{\text{\text{\text{\text{\text{\text{\text{\text{\text{\text{\text{\text{\text{\text{\text{\text{\text{\text{\text{\text{\text{\text{\text{\text{\text{\text{\text{\text{\text{\text{\text{\text{\text{\text{\text{\text{\text{\text{\text{\text{\text{\text{\text{\text{\text{\text{\text{\text{\text{\text{\text{\text{\text{\text{\text{\text{\text{\text{\text{\text{\text{\text{\text{\text{\text{\text{\text{\text{\text{\text{\text{\text{\text{\text{\text{\text{\text{\text{\text{\text{\text{\text{\text{\text{\text{\text{\text{\text{\text{\text{\text{\text{\text{\text{\text{\text{\text{\text{\text{\text{\text{\text{\text{\text{\text{\text{\text{\text{\text{\text{\text{\text{\text{\text{\text{\text{\text{\text{\text{\text{\text{\text{\text{\text{\text{\text{\text{\text{\text{\text{\text{\text{\text{\text{\text{\text{\text{\text{\text{\text{\text{\text{\text{\text{\text{\text{\text{\text{\text{\text{\text{\text{\text{\text{\text{\text{\text{\text{\text{\text{\text{\text{\text{\text{\text{\text{\text{\tint{\text{\text{\text{\text{\text{\text{\text{\text{\text{\text{\text{\text{\text{\text{\text{\text{\text{\text{\text{\text{\text{\text{\text{\text{\text{\text{\text{\text{\text{\text{\text{\tint{\text{\text{\text{\text{\text{\text{\text{\text{\text{\text{\text{\text{\text{\text{\text{\text{\text{\text{\text{\text{\text{\tin}\text{\text{\text{\text{\text{\text{\text{\text{\text{\ti}\text{\text{\text{\text{\text{\text{\text{\text{\text{\text{\tin}\tint{\text{\text{\text{\text{\text{\text{\text{\text{\text{\tin}\text{\text{\text{\text{\text{\text{\text{\text{\text{\text{\text{\text{\text{\text{\text{\text{\text{\text{\text{\text{\tex{\ti}\text{\text{\text{\text{\text{\text{\text{\text{\text{\text{\text{\text{\text{\text{\text{\text{\text{\texi}\text{\text{\text{\text{\text{\text{\text{\text{\texi}\text{\text{\text{\texit{\texi}\titt{\text{\texi}\text{\text{\text{\text{\text{\tex{	1AL1-42		1AL1-42	1AL1-42	1AL1-40 M — — — — — — — — — — — — — — — — — — —
	Q 1AL1-44	∑ 1AL1-42	b		b	<u></u>	
	1Δ	Y d ≥ L1-46					

FIRST FLOOR POWER PLAN ALTERNATE - UNIT D

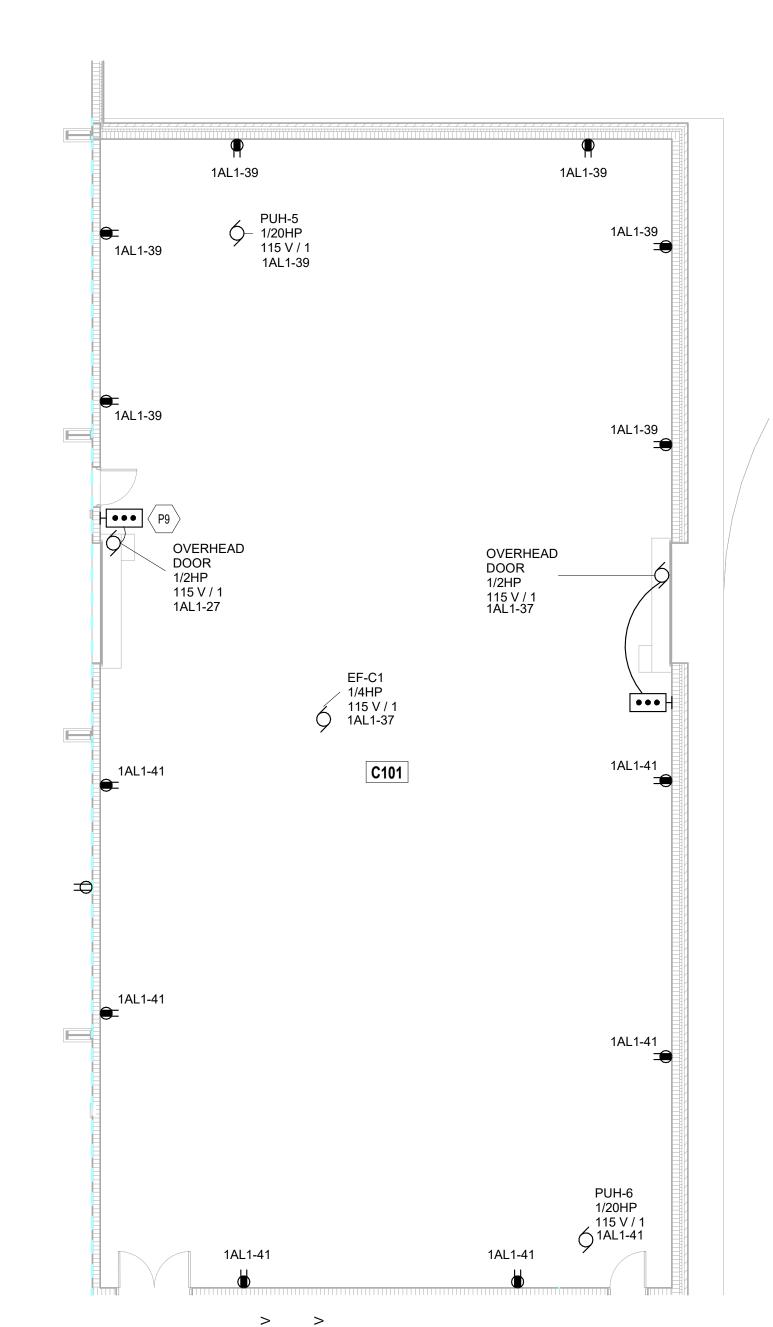

FIRST FLOOR POWER PLAN ALTERNATE - UNIT C

POWER PLAN GENERAL NOTES

1. PROVIDE REVISED TYPED PANELBOARD DIRECTORIES FOR EACH PANELBOARD ADDED OR MODIFIED DURING CONSTRUCTION. FIELD VERIFY EXISTING CIRCUIT INFORMATION WITH OWNER'S ASSISTANCE TO ENSURE FINAL DIRECTORY IS ACCURATE. UNUSED SPARE

FINAL DIRECTORY IS ACCURATE. UNUSED SPARE
BREAKERS SHALL BE IN THE OFF POSITION.

2. VIDEO PROJECTOR RECEPTACLE TO BE MOUNTED ABOVE
WALL MOUNTED PROJECTOR BRACKET, 96" A.F.F. UNO.

3. CONTRACTOR SHALL VERIFY ALL DIMENSIONS AND
CLEARANCES AND ALL EXISTING FIELD CONDITIONS
BEFORE STARTING CONSTRUCTION. COMMENCEMENT OF
WORK CONSTITUTES ACCEPTANCE OF CONDITIONS.
SHOULD DIFFERENT CONDITIONS BE ENCOUNTERED,

WORK.

LABEL EACH RECEPTACLE WITH THE PANEL NAME AND
CIRCUIT NUMBER ON THE FACE OF EACH COVER PLATE

CONTACT THE ARCHITECT BEFORE PROCEEDING WITH

WITH A TYPED LAMINATED LABEL.

5. PROVIDE "GFCI PROTECTED" LABEL ON COVER PLATE FOR ANY GFCI PROTECTED DEVICE.

6. CONTRACTOR SHALL INCREASE CIRCUIT CONDUCTOR SIZE

TO COMPENSATE FOR VOLTAGE DROP DUE TO EXCESSIVE CIRCUIT LENGTHS. IN NO CASE SHALL VOLTAGE DROP EXCEED NFPA 70 (N.E.C.) REQUIREMENTS.

7. REFER TO MECHANICAL PLANS FOR LOCATION OF

MECHANICAL EQUIPMENT. LOCATE DISCONNECT
SWITCHES PER NEC.

8. REFER TO "CONTROL SCHEMATICS" MECHANICAL
DRAWINGS FOR ADDITIONAL CONTROL WIRING AND
CONTROL CONNECTIONS.

9. ALL DEVICES, EQUIPMENT, FIXTURES, AND THE LIKE, SHALL
BE BONDED WITH A PROPERLY SIZED EQUIPMENT

MECHANICAL/ELECTRICAL BONDS OF METALLIC RACEWAY

GROUNDING CONDUCTOR. MAINTAIN

SCHOOL FIELDHOUSE

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PENN-HARRIS-MADISON SCHOOL CORPORATION

POWER PLAN NOTES

(ALL NOTES MAY NOT BE INDICATED ON THIS SHEET)

P9 UNDER ALTERNATE BID, PROVIDE THE PUSHBUTTON CONTROLLER FOR THE OVERHEAD DOOR ON THE UNIT C SIDE

OF THE DOOR.

P26 RECEPTACLE FOR THE SCOREBOARD. REFER TO THE
ARCHITECTURAL INTERIOR ELEVATIONS FOR EXACT
MOUNTING HEIGHT AND LOCATION.

MADISON

SCHOOL

CORPORATION

ARCHITECT

FANNING HOWEY


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A
CALT

B

LEGY PLAN

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VERIFICATION NOTE

CONTRACTOR SHALL VERIFY ALL DIMENSIONS AND CLEARANCES
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ACCEPTANCE OF CONDITIONS.

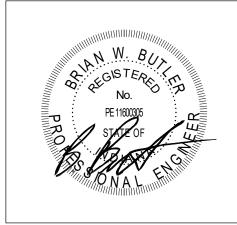SHOULD DIFFERENT CONDITIONS BE ENCOUNTERED, CONTACT THE ARCHITECT BEFORE PROCEEDING WITH WORK.

ALTERNATE- UNIT C AND D

FIRST FLOOR POWER PLAN



ROOM LEGEND ROOM AREA NO. **ROOM NAME** (SF) CORRIDOR MECHANICAL CORRIDOR 1444 SF LOCKER ROOM #3 399 SF DRESSING ROOM #3 DRESSING ROOM #4 184 SF SHOWER LOCKER ROOM #4 CLASSROOM CUSTODIAN ELECTRICAL / TECHNOLOGY ELEVATOR EQUIPMENT CLASSROOM COMMONS 984 SF STAIR 175 SF

POWER PLAN GENERAL NOTES

PROVIDE REVISED TYPED PANELBOARD DIRECTORIES FOR EACH PANELBOARD ADDED OR MODIFIED DURING CONSTRUCTION. FIELD VERIFY EXISTING CIRCUIT INFORMATION WITH OWNER'S ASSISTANCE TO ENSURE FINAL DIRECTORY IS ACCURATE. UNUSED SPARE BREAKERS SHALL BE IN THE OFF POSITION.

VIDEO PROJECTOR RECEPTACLE TO BE MOUNTED ABOVE WALL MOUNTED PROJECTOR BRACKET, 96" A.F.F. UNO. CONTRACTOR SHALL VERIFY ALL DIMENSIONS AND CLEARANCES AND ALL EXISTING FIELD CONDITIONS BEFORE STARTING CONSTRUCTION. COMMENCEMENT OF WORK CONSTITUTES ACCEPTANCE OF CONDITIONS. SHOULD DIFFERENT CONDITIONS BE ENCOUNTERED,

CONTACT THE ARCHITECT BEFORE PROCEEDING WITH WORK.

LABEL EACH RECEPTACLE WITH THE PANEL NAME AND CIRCUIT NUMBER ON THE FACE OF EACH COVER PLATE

WITH A TYPED LAMINATED LABEL.
PROVIDE "GFCI PROTECTED" LABEL ON COVER PLATE FOR ANY GFCI PROTECTED DEVICE.
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TO COMPENSATE FOR VOLTAGE DROP DUE TO EXCESSIVE CIRCUIT LENGTHS. IN NO CASE SHALL VOLTAGE DROP EXCEED NFPA 70 (N.E.C.) REQUIREMENTS.
REFER TO MECHANICAL PLANS FOR LOCATION OF MECHANICAL EQUIPMENT. LOCATE DISCONNECT SWITCHES PER NEC.

8. REFER TO "CONTROL SCHEMATICS" MECHANICAL DRAWINGS FOR ADDITIONAL CONTROL WIRING AND CONTROL CONNECTIONS.

POWER PLAN NOTES

REQUIREMENTS.

REQUIREMENTS.

(ALL NOTES MAY NOT BE INDICATED ON THIS SHEET)

PROVIDE #10 CONDUCTORS.

P7 TECHNOLOGY RACK (IDF) RECEPTACLE. COORDINATE

MOUNTING LOCATION AND INSTALLATION REQUIREMENTS

P8 NEW LIT SIGNAGE AT THIS LOCATION. PROVIDE WITH 2 # 10

P13 PROVIDE ELEVATOR DISCONNECT PER THE MANUFACTURERS RECOMMENDATIONS WITH SHUNT-TRIP DEVICE IN

P14 PROVIDE ELEVATOR CAB LIGHTS DISCONNECT PER THE

P15 TECHNOLOGY RACK (IDF) BACKBOARD RECEPTACLES. REFER

FOR FUTURE LIT SIGNAGE AT THIS LOCATION. PROVIDE CONDUIT SUCH THAT FUTURE SIGNAGE CAN BE TIED INTO EXTERIOR BUILDING LIGHTING CIRCUIT. COORDINATE FINAL

P21 CONNECT GYM EQUIPMENT CONTROLS MOTOR TO INDICATED CIRCUIT IN PANEL 1AL2. WIRE MOTOR THROUGH RELAY BOX

P25 PROVIDE 3/4" EMRTY CONDUIT FROM TSC1500XL RELAY NODE

LOCATION. COORDINATE EXACT LOCATION OF RECEPTACLE WITH ARCHITECTURAL FLOORPLANS AND DETAILS.

TO THIS LOCATION FOR FUTURE PIVIDER CURTAIN.

P27 PROVIDE RECEPTACLE FOR AIR PURFIER UNIT AT THIS

LOCATED IN ELECTRICAL ROOM A105. PROVIDE WITH 2 # 10, # 10 G IN 3/4" C. PROVIDE ADDITONAL CONTROL SIGNALS FOR UP AND DOWN ADJUSTMENT PER MANUFACTURER REQUIREMENTS, MINIMUM # 10 CONDUCTORES. VERIFY INSTALLATION REQUIREMENTS WITH GYM EQUIPMENT

TO DETAIL "4/E1.02" FOR MOUNTING LOCATIONS AND REQUIREMENTS. PROVIDE #10 CONDUCTORS.

P19 PROVIDE EMPTY 3/4" CONDUIT AND BOX AT THIS LOCATION

WITH ALL NATIONAL, STATE, AND LOCAL CODE

LOCATION WITH ARCHITECTURE PLANS.

CONTROLS MANUFACTURER.

AND # 10 G IN 3/4" CONDUIT AND CONNECT TO EXTERIOR

BUILDING LIGHTING CIRCUIT. VERFIY MOUNTING HEIGHT IN

ACCORDANCE WITH ALL NATIONAL, STATE, AND LOCAL CODE

MANUFACTURERS RECOMMENDATIONS AND IN ACCORDANCE

WITH THE TECHNOLOGY CONTRACTOR PRIOR TO ROUGH-IN.

9. ALL DEVICES, EQUIPMENT, FIXTURES, AND THE LIKE, SHALL BE BONDED WITH A PROPERLY SIZED EQUIPMENT GROUNDING CONDUCTOR. MAINTAIN MECHANICAL/ELECTRICAL BONDS OF METALLIC RACEWAY SYSTEM.

PENN HIGH SCHOOL FIELDHOUSE

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A CALT

B

ALTERNATE

KEY PLAN

100% Construction Documents



DRAWN BY: ISD
PROJECT NUMBER: 222130.00
PROJECT ISSUE DATE: 01.10.2024

NO.	DESCRIPTION	DATE
1	Addendum #1	01.26.2024

VERIFICATION NOTE

CONTRACTOR SHALL VERIFY ALL DIMENSIONS AND CLEARANCES AND ALL EXISTING FIELD CONDITIONS BEFORE STARTING CONSTRUCTION. COMMENCEMENT OF WORK CONSTITUTES ACCEPTANCE OF CONDITIONS.

SHOULD DIFFERENT CONDITIONS BE ENCOUNTERED, CONTACT THE ARCHITECT BEFORE PROCEEDING WITH WORK.

SECOND FLOOR POWER PLAN - UNIT

EP12B

	ROOM LEGEND	
ROOM		AF
NO.	ROOM NAME	(5
		•
A101	FIELDHOUSE	54239
B201	CORRIDOR	1444 5
B217	COMMONS	984 SF
S-2	STAIR	175 SF

	ROOM LEGEND	
ROOM		AF
NO.	ROOM NAME	(S
		•
A101	FIELDHOUSE	54239
B201	CORRIDOR	1444 S
B217	COMMONS	984 SF

POWER PLAN GENERAL NOTES

- PROVIDE REVISED TYPED PANELBOARD DIRECTORIES FOR EACH PANELBOARD ADDED OR MODIFIED DURING CONSTRUCTION. FIELD VERIFY EXISTING CIRCUIT INFORMATION WITH OWNER'S ASSISTANCE TO ENSURE FINAL DIRECTORY IS ACCURATE. UNUSED SPARE BREAKERS SHALL BE IN THE OFF POSITION.
 - VIDEO PROJECTOR RECEPTACLE TO BE MOUNTED ABOVE WALL MOUNTED PROJECTOR BRACKET, 96" A.F.F. UNO. CONTRACTOR SHALL VERIFY ALL DIMENSIONS AND CLEARANCES AND ALL EXISTING FIELD CONDITIONS BEFORE STARTING CONSTRUCTION. COMMENCEMENT OF WORK CONSTITUTES ACCEPTANCE OF CONDITIONS. SHOULD DIFFERENT CONDITIONS BE ENCOUNTERED, CONTACT THE ARCHITECT BEFORE PROCEEDING WITH
 - LABEL EACH RECEPTACLE WITH THE PANEL NAME AND
- CIRCUIT NUMBER ON THE FACE OF EACH COVER PLATE WITH A TYPED LAMINATED LABEL. PROVIDE "GFCI PROTECTED" LABEL ON COVER PLATE FOR ANY GFCI PROTECTED DEVICE.
- CONTRACTOR SHALL INCREASE CIRCUIT CONDUCTOR SIZE TO COMPENSATE FOR VOLTAGE DROP DUE TO EXCESSIVE CIRCUIT LENGTHS. IN NO CASE SHALL VOLTAGE DROP EXCEED NFPA 70 (N.E.C.) REQUIREMENTS. REFER TO MECHANICAL PLANS FOR LOCATION OF
- MECHANICAL EQUIPMENT. LOCATE DISCONNECT SWITCHES PER NEC. REFER TO "CONTROL SCHEMATICS" MECHANICAL DRAWINGS FOR ADDITIONAL CONTROL WIRING AND
- CONTROL CONNECTIONS. ALL DEVICES, EQUIPMENT, FIXTURES, AND THE LIKE, SHALL BE BONDED WITH A PROPERLY SIZED EQUIPMENT GROUNDING CONDUCTOR. MAINTAIN MECHANICAL/ELECTRICAL BONDS OF METALLIC RACEWAY

SCHOOL **FIELDHOUSE**

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POWER PLAN NOTES (ALL NOTES MAY NOT BE INDICATED ON THIS SHEET)



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100% Construction Documents



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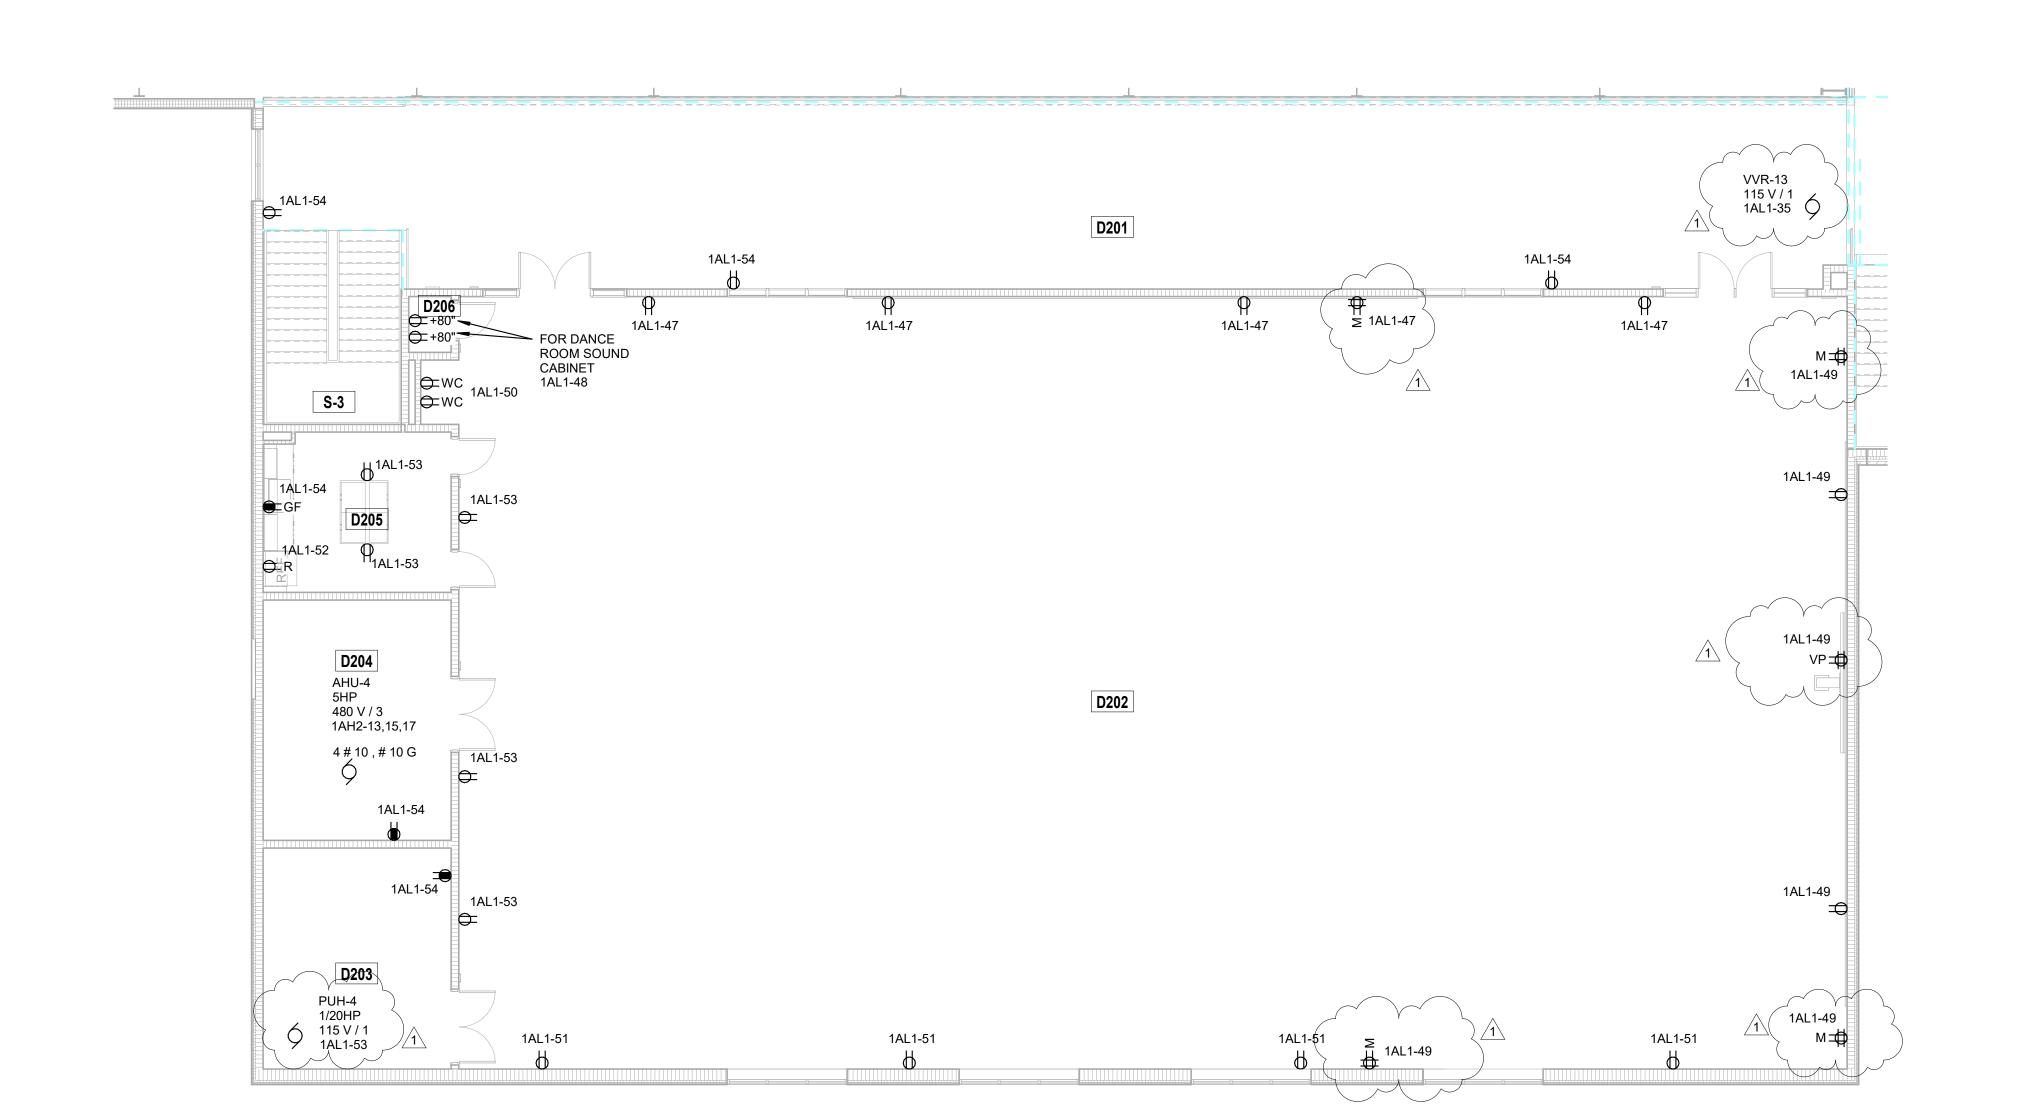
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1	Addendum #1	01.26.2024

VERIFICATION NOTE


CONTRACTOR SHALL VERIFY ALL DIMENSIONS AND CLEARANCES AND ALL EXISTING FIELD CONDITIONS BEFORE STARTING CONSTRUCTION. COMMENCEMENT OF WORK CONSTITUTES ACCEPTANCE OF CONDITIONS.

SHOULD DIFFERENT CONDITIONS BE ENCOUNTERED, CONTACT THE ARCHITECT BEFORE PROCEEDING WITH WORK.

SECOND FLOOR POWER PLAN **ALTERNATE - UNIT D**



SECOND FLOOR POWER PLAN ALTERNATE - UNIT D SCALE: 1/8" = 1'-0"

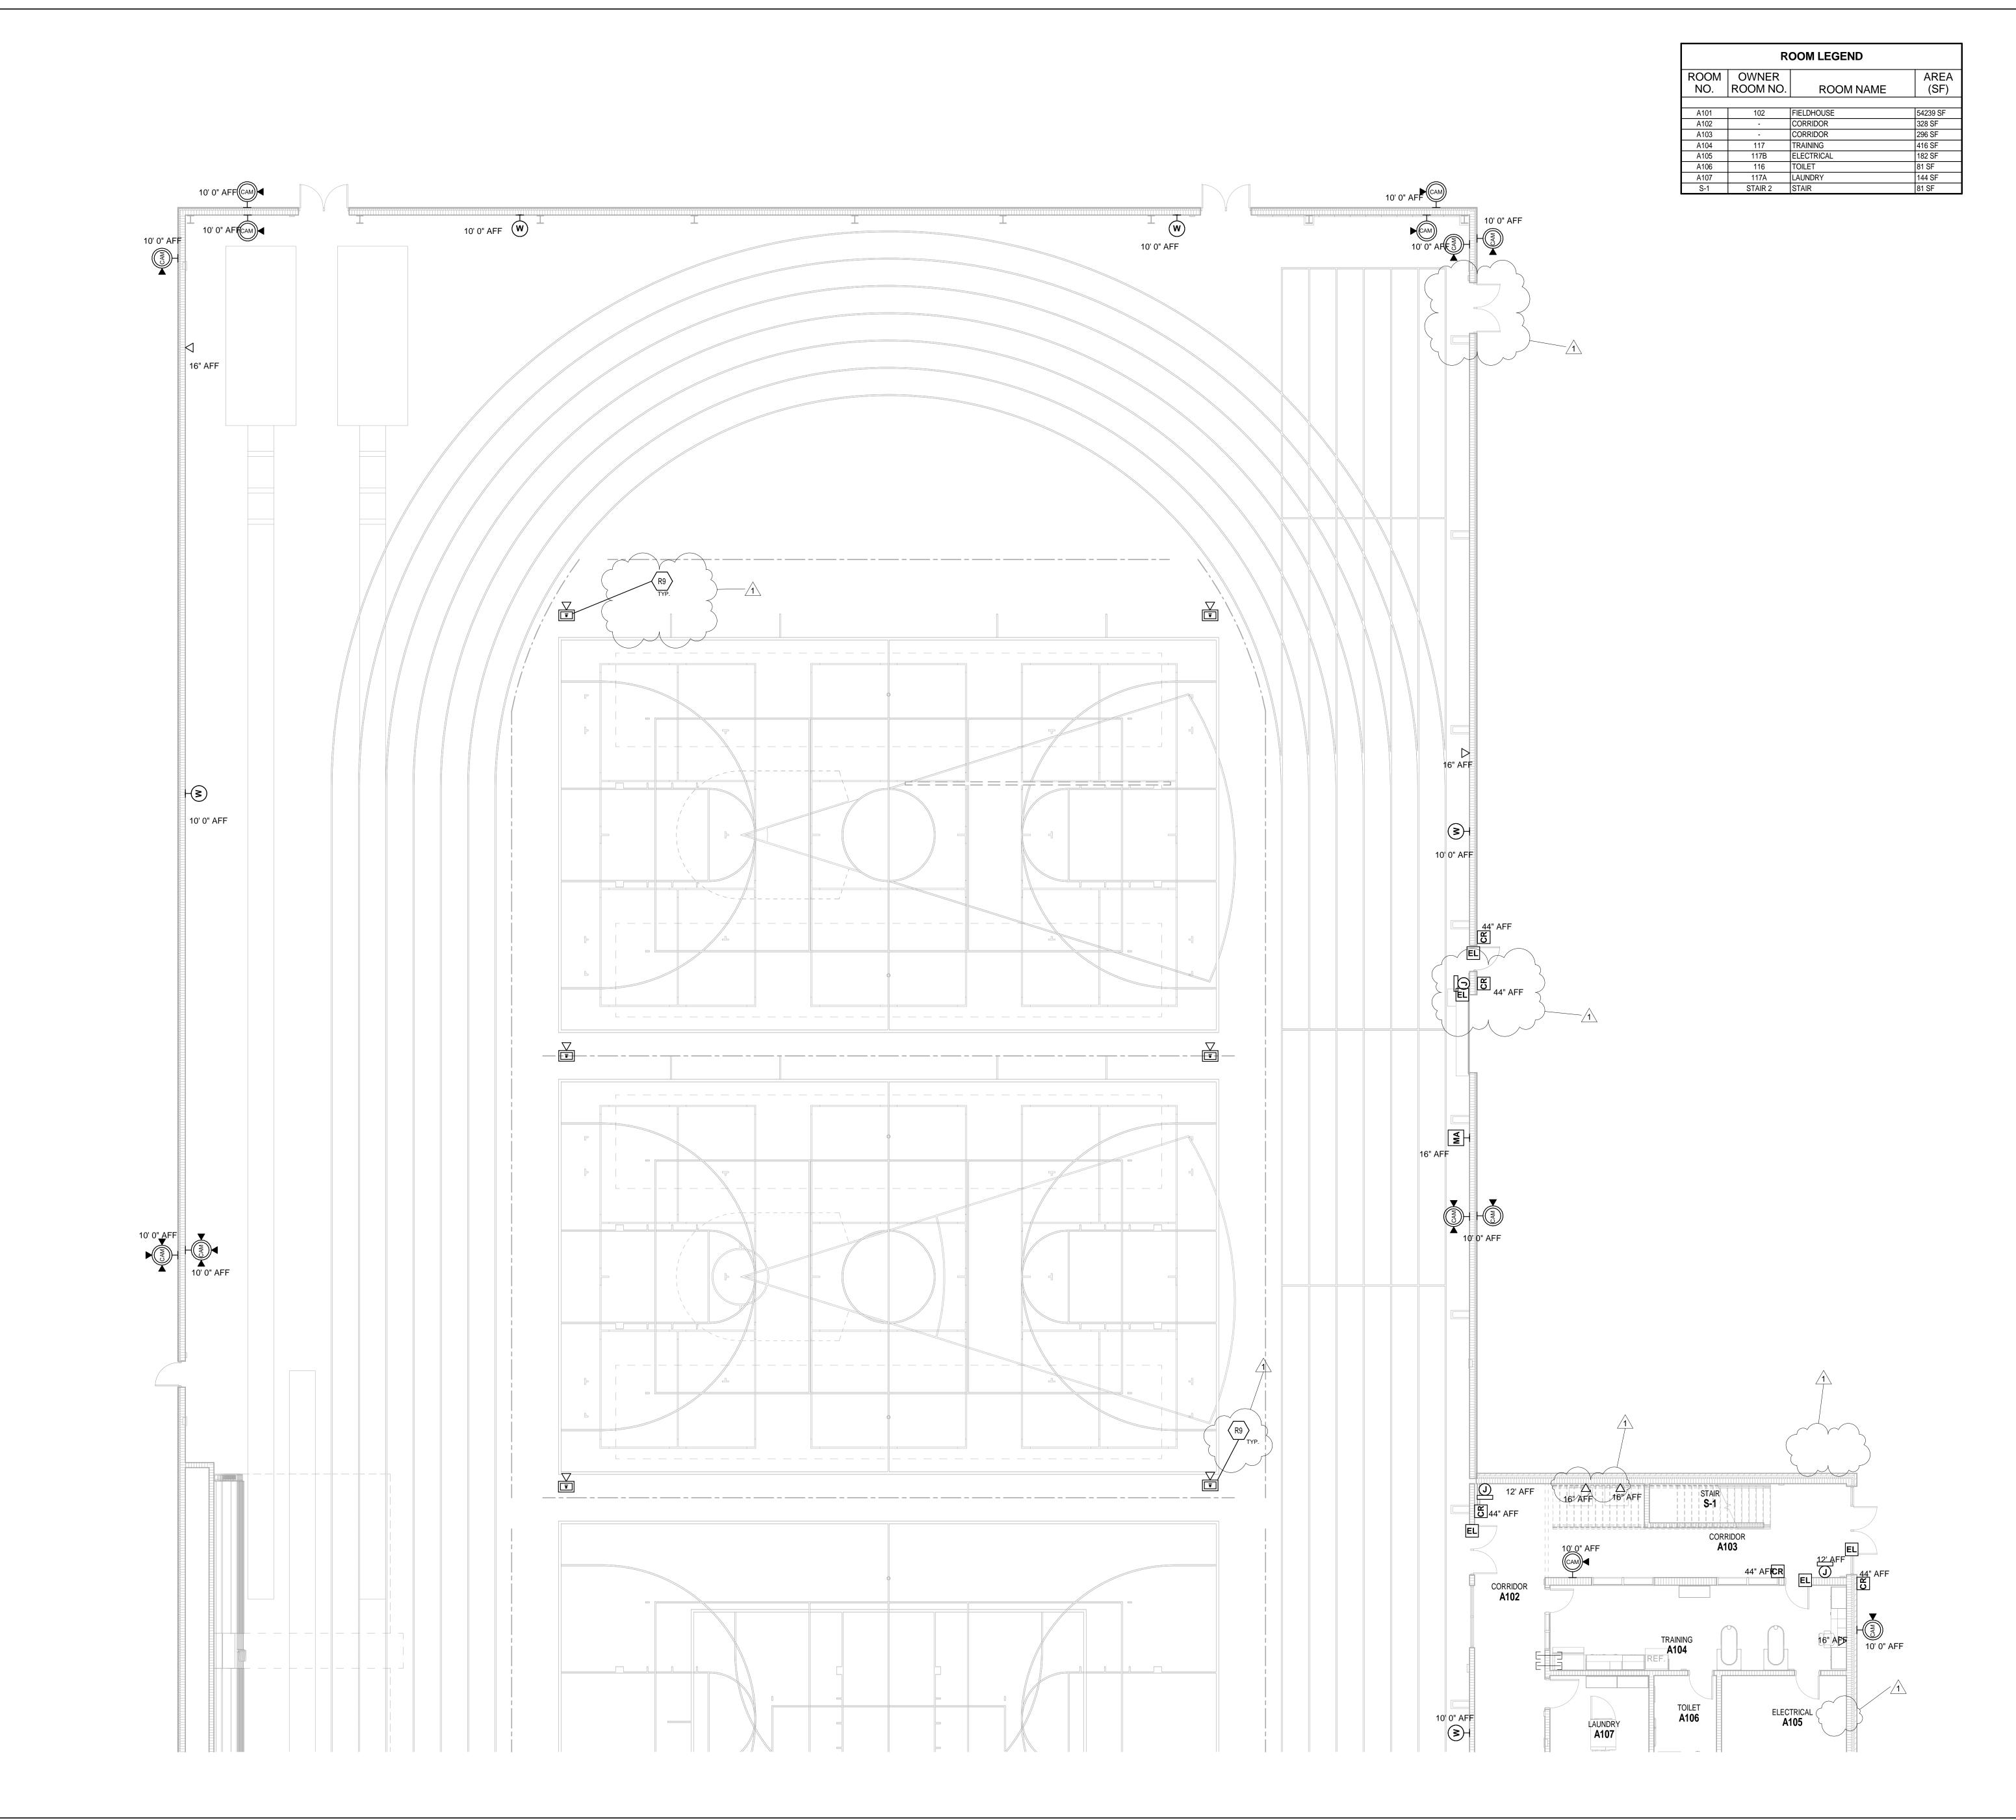

TECHNOLOGY ROUGH-IN GENERAL NOTES

A. DEVICES SHALL BE INSTALLED AT LOCATIONS SHOWN ON DRAWINGS. LOCATIONS OF DEVICES SHALL BE COORDINATED WITH OTHER ELECTRICAL DEVICES/ CASEWORK/ ARCHITECTURAL FEATURES AND OTHER TRADES PRIOR TO ROUGH-IN. IF RELOCATION OF DEVICES IS REQUIRED DUE TO LACK OF COORDINATION BETWEEN ELECTRICAL DRAWINGS AND OTHER TRADES, ANY

ELECTRICAL DRAWINGS AND OTHER TRADES, ANY
ASSOCIATED COSTS SHALL BE RESPONSIBILITY OF
ELECTRICAL CONTRACTOR.
DIVISION 26 CONTACTOR IS RESPONSIBLE TO PROVIDE
AND INSTALL ALL DATA SLEEVES WITH PROPER BUSHINGS
AS SHOWN ON THE E3 DRAWINGS AND ON ET501 DETAILS.

C. COORDINATE THE INSTALLATION OF ALL SPEAKER
LOCATION ROUGH IN PLACEMENTS AND BACKBONE
CONDUIT INSTALLATION WITH THE DIVISION 27
CONTRACTOR PRIOR TO INSTALLATION.

D. COORDINATE ALL CLOSET OR CABINET POWER NEEDS AND
PLACEMENTS WITH THE DIVISION 27 CONTRACTOR PRIOR
TO INSTALLATION.

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ROUGH-IN PLAN NOTES X

(ALL NOTES MAY NOT BE INDICATED ON THIS SHEET)

NOTE


R9 ALL FLOORBOXES IN FIELDHOUSE WILL HAVE ONE EMPTY CONDUIT TO EACH BOX FOR FUTURE DATA CABLING.

MADISON SCHOOL CORPORATION


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CONSTRUCTION DOCUMENTS



PROJECT MANAGER: MKS

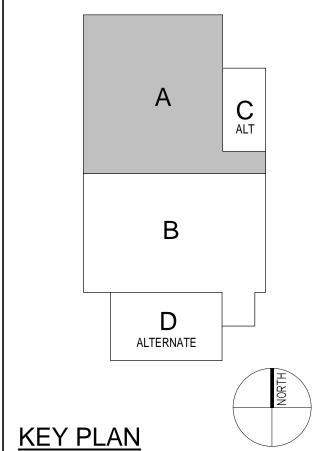DRAWN BY: CDT

PROJECT NUMBER: 222130.00

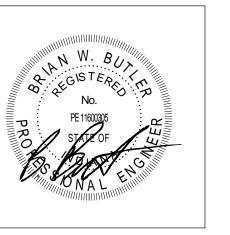PROJECT ISSUE DATE: 1.13.2024

REV. No.	DESCRIPTION	DATE
1	Addendum #1	1.26.2024


VERIFICATION NOTE

CONTRACTOR SHALL VERIFY ALL DIMENSIONS AND CLEARANCES AND ALL EXISTING FIELD CONDITIONS BEFORE STARTING CONSTRUCTION. COMMENCEMENT OF WORK CONSTITUTES ACCEPTANCE OF CONDITIONS.

SHOULD DIFFERENT CONDITIONS BE ENCOUNTERED, CONTACT THE ARCHITECT BEFORE PROCEEDING WITH WORK.

FIRST FLOOR TECHNOLOGY ROUGH-IN PLAN - UNIT A

ET11A

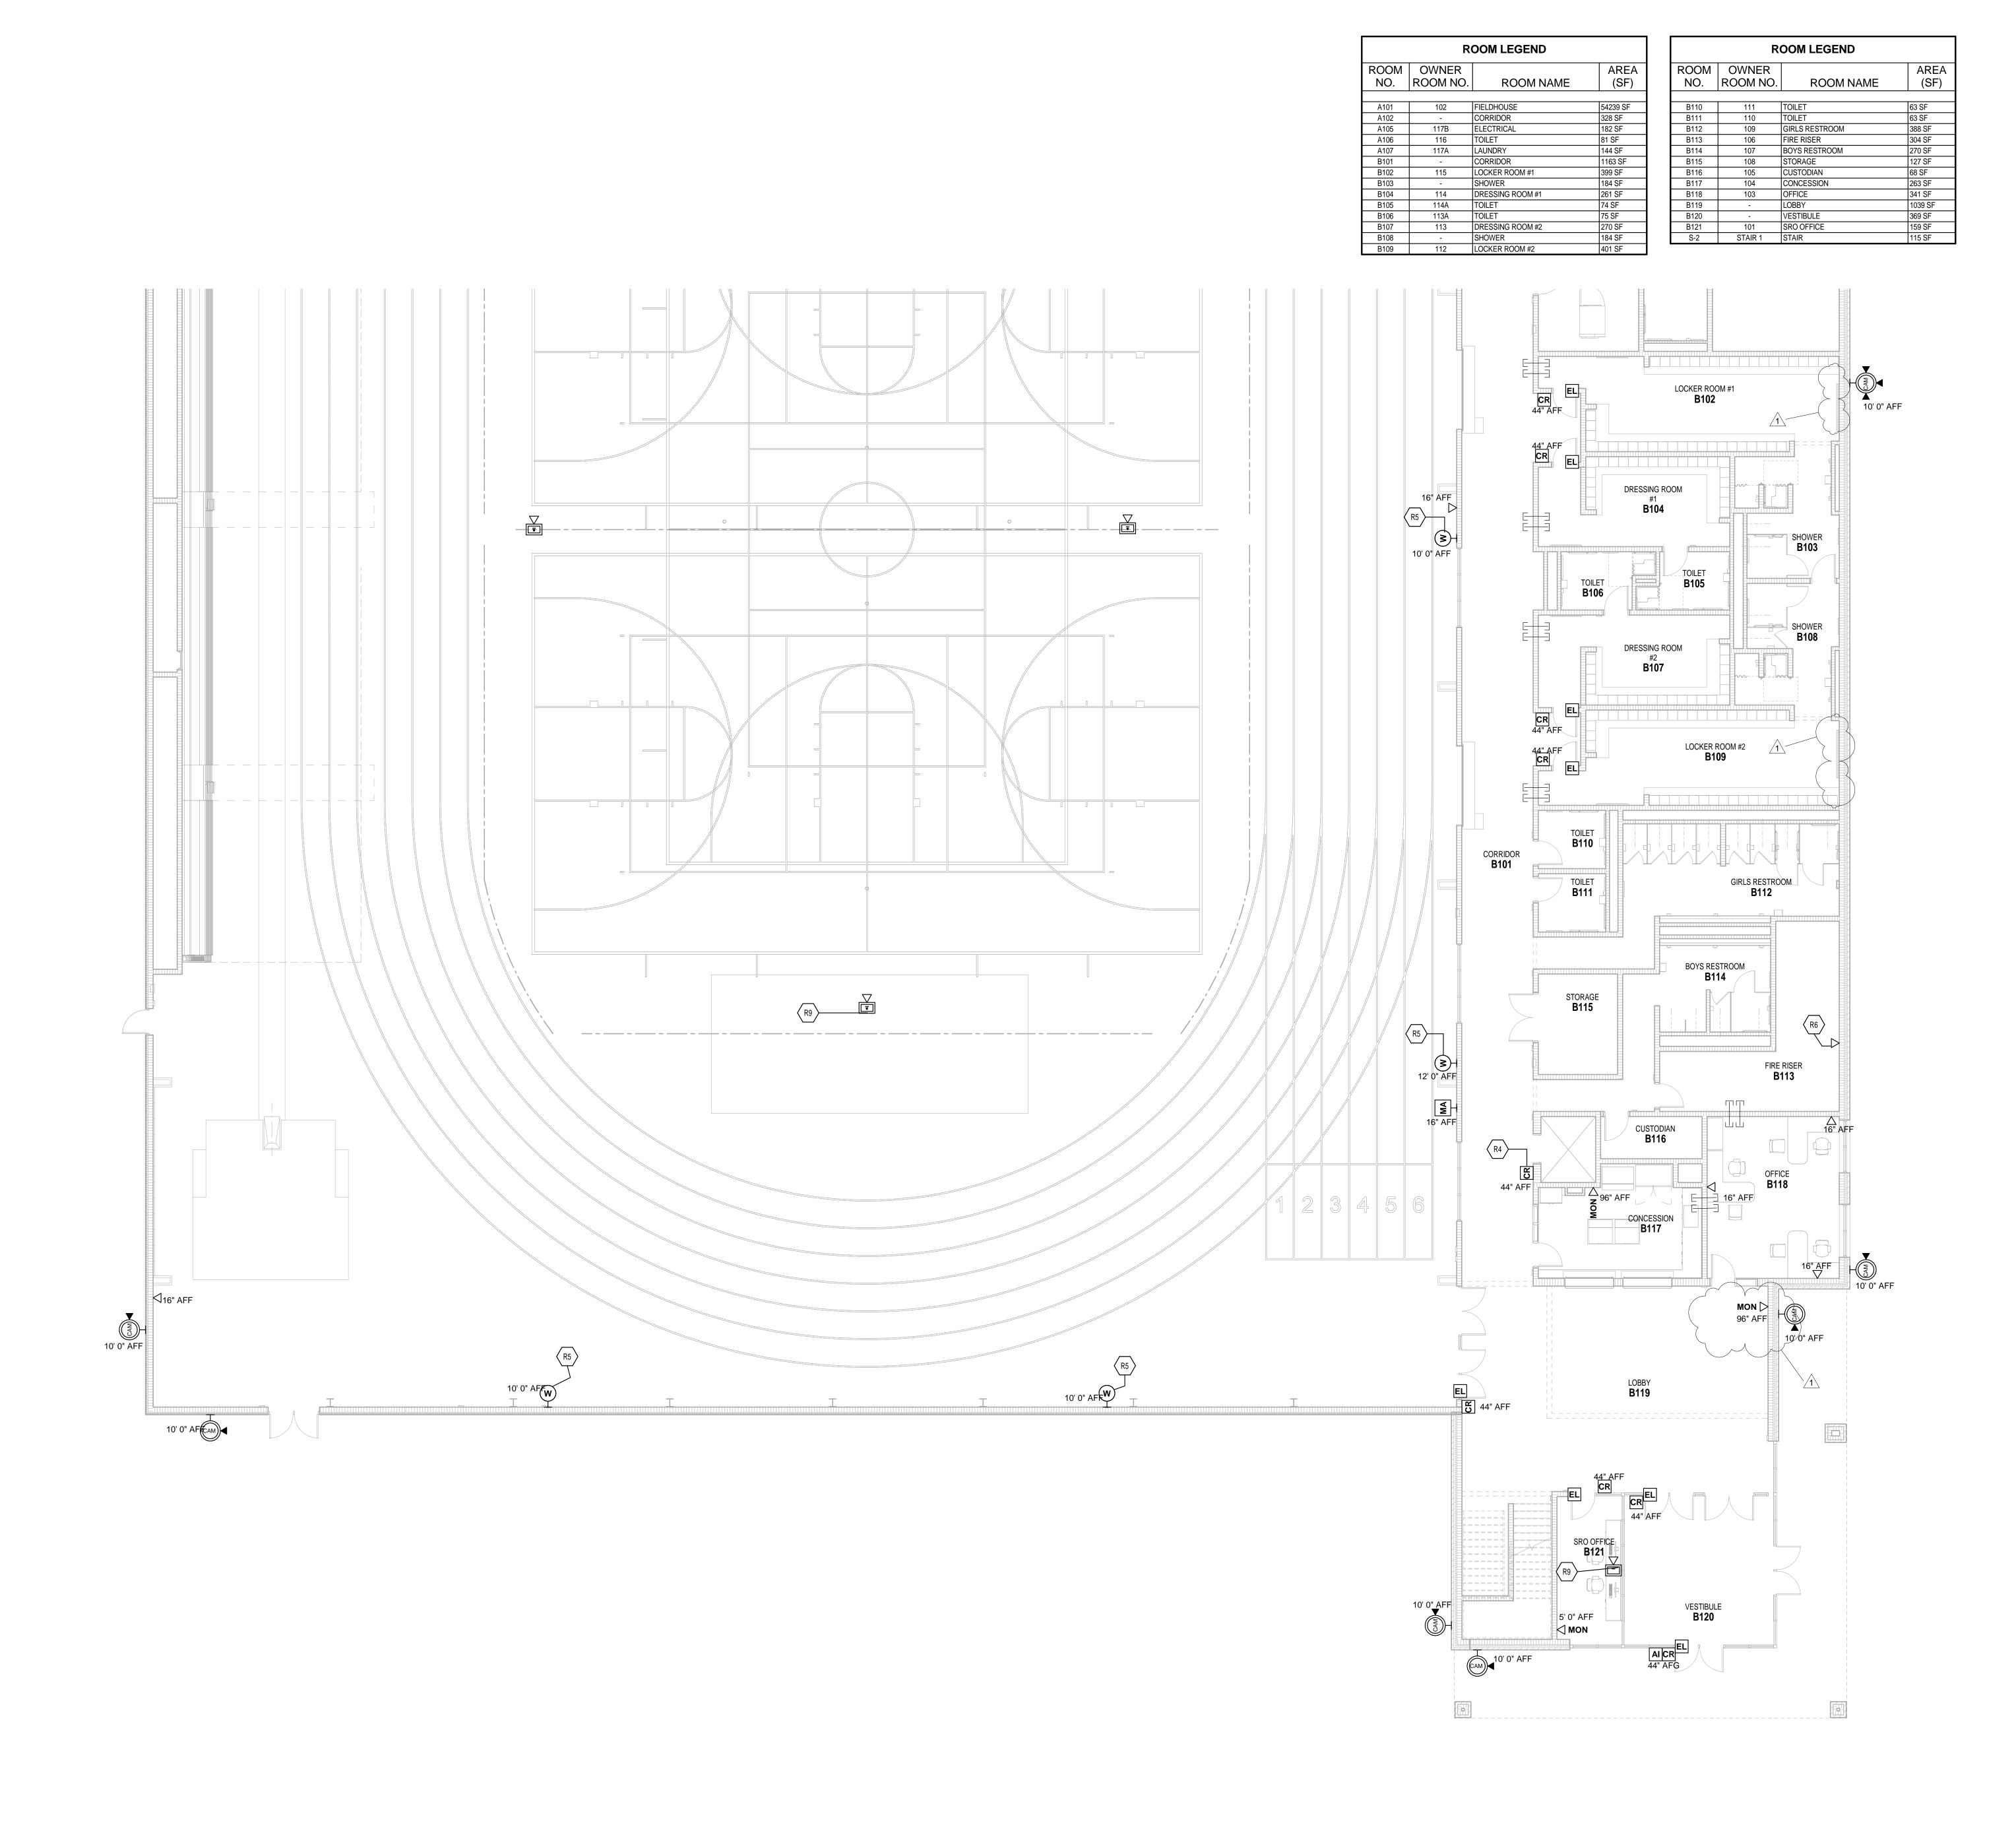

TECHNOLOGY ROUGH-IN GENERAL NOTES

- A. DEVICES SHALL BE INSTALLED AT LOCATIONS SHOWN ON DRAWINGS. LOCATIONS OF DEVICES SHALL BE COORDINATED WITH OTHER ELECTRICAL DEVICES/ CASEWORK/ ARCHITECTURAL FEATURES AND OTHER TRADES PRIOR TO ROUGH-IN. IF RELOCATION OF DEVICES IS REQUIRED DUE TO LACK OF COORDINATION BETWEEN ELECTRICAL DRAWINGS AND OTHER TRADES, ANY ASSOCIATED COSTS SHALL BE RESPONSIBILITY OF
 - ELECTRICAL CONTRACTOR. DIVISION 26 CONTACTOR IS RESPONSIBLE TO PROVIDE AND INSTALL ALL DATA SLEEVES WITH PROPER BUSHINGS
- AS SHOWN ON THE E3 DRAWINGS AND ON ET501 DETAILS. COORDINATE THE INSTALLATION OF ALL SPEAKER LOCATION ROUGH IN PLACEMENTS AND BACKBONE CONDUIT INSTALLATION WITH THE DIVISION 27 CONTRACTOR PRIOR TO INSTALLATION. COORDINATE ALL CLOSET OR CABINET POWER NEEDS AND

TO INSTALLATION.

ROUGH-IN PLAN NOTES

CONTRACTORS.

CONTRACTOR.

(ALL NOTES MAY NOT BE INDICATED ON THIS SHEET)

<u>NOTE</u>

R4 CARD READERS WILL BE ADDED TO THE ELEVATOR. COORDINATE WITH THE TECHNOLOGY AND ELEVATOR

R6 PROVIDE 3/4" CONDUIT TO ACCESSIBLE LAY-IN CEILING FOR FIRE ALARM. VERIFY EXACT LOCATIONS WITH FIRE ALARM

R9 ALL FLOORBOXES IN FIELDHOUSE WILL HAVE ONE EMPTY CONDUIT TO EACH BOX FOR FUTURE DATA CABLING.

R5 PROVIDE WIRE GUARDS ON ANY WALL MOUNTED EQUIPMENT FOR ADDED PROTECTION.

SCHOOL **FIELDHOUSE** PLACEMENTS WITH THE DIVISION 27 CONTRACTOR PRIOR

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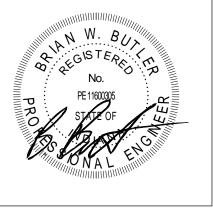
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<u>ARCHITECT</u>

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PROJECT MANAGER: MKS DRAWN BY: CDT PROJECT NUMBER: 222130.00 PROJECT ISSUE DATE: 1.13.2024

REV. NO.△	DESCRIPTION	DATE
1	Addendum #1	1.26.2024

VERIFICATION NOTE CONTRACTOR SHALL VERIFY ALL DIMENSIONS AND CLEARANCES AND ALL EXISTING FIELD CONDITIONS BEFORE STARTING CONSTRUCTION. COMMENCEMENT OF WORK CONSTITUTES ACCEPTANCE OF CONDITIONS.

SHOULD DIFFERENT CONDITIONS BE ENCOUNTERED, CONTACT THE ARCHITECT BEFORE PROCEEDING WITH WORK.

FIRST FLOOR TECHNOLOGY **ROUGH-IN PLAN - UNIT B**

ROOM LEGEND				
ROOM NO.	OWNER ROOM NO.	ROOM NAME	ARE/ (SF)	
A101	102	FIELDHOUSE	54239 SF	
A102	-	CORRIDOR	328 SF	
A103	-	CORRIDOR	296 SF	
A104	117	TRAINING	416 SF	
B119	-	LOBBY	1039 SF	
S-1	STAIR 2	STAIR	81 SF	
S-2	STAIR 1	STAIR	115 SF	

STORAGE C101

MON 🔀

FIRST FLOOR TECHNOLOGY ROUGH-IN PLAN - UNIT D

96" AFF

FIELDHOUSE **A101**

WRESTLING **D101**

2 ALTERNATE

SCALE: 1/8" = 1'-0"

VESTIBULE **D104**

MECHANICAL **D103**

STORAGE **D102**

FIRST FLOOR TECHNOLOGY ROUGH-IN PLAN - UNIT C ALTERNATE

SCALE: 1/8" = 1'-0"

CORRIDOR A103

TECHNOLOGY ROUGH-IN GENERAL NOTES

- A. DEVICES SHALL BE INSTALLED AT LOCATIONS SHOWN ON DRAWINGS. LOCATIONS OF DEVICES SHALL BE COORDINATED WITH OTHER ELECTRICAL DEVICES/ CASEWORK/ ARCHITECTURAL FEATURES AND OTHER TRADES PRIOR TO ROUGH-IN. IF RELOCATION OF DEVICES IS REQUIRED DUE TO LACK OF COORDINATION BETWEEN ELECTRICAL DRAWINGS AND OTHER TRADES, ANY
- ASSOCIATED COSTS SHALL BE RESPONSIBILITY OF ELECTRICAL CONTRACTOR. DIVISION 26 CONTACTOR IS RESPONSIBLE TO PROVIDE
- AND INSTALL ALL DATA SLEEVES WITH PROPER BUSHINGS AS SHOWN ON THE E3 DRAWINGS AND ON ET501 DETAILS. COORDINATE THE INSTALLATION OF ALL SPEAKER LOCATION ROUGH IN PLACEMENTS AND BACKBONE CONDUIT INSTALLATION WITH THE DIVISION 27 CONTRACTOR PRIOR TO INSTALLATION.
 COORDINATE ALL CLOSET OR CABINET POWER NEEDS AND PLACEMENTS WITH THE DIVISION 27 CONTRACTOR PRIOR

ROUGH-IN PLAN NOTES

(ALL NOTES MAY NOT BE INDICATED ON THIS SHEET)

R11 COORDINATE POWER NEEDS WITH TECHNOLOGY AND SOUND SYSTEM COORDINATOR.

PENN HIGH SCHOOL **FIELDHOUSE**

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KEY PLAN

CONSTRUCTION DOCUMENTS

PROJECT MANAGER: MKS DRAWN BY: CDT PROJECT NUMBER: 222130.00


VERIFICATION NOTE CONTRACTOR SHALL VERIFY ALL DIMENSIONS AND CLEARANCES AND ALL EXISTING FIELD CONDITIONS BEFORE STARTING
CONSTRUCTION. COMMENCEMENT OF WORK CONSTITUTES

FIRST FLOOR TECHNOLOGY

ROUGH-IN PLAN - UNIT C& D ALT

ACCEPTANCE OF CONDITIONS.

SHOULD DIFFERENT CONDITIONS BE ENCOUNTERED, CONTACT THE ARCHITECT BEFORE PROCEEDING WITH WORK.

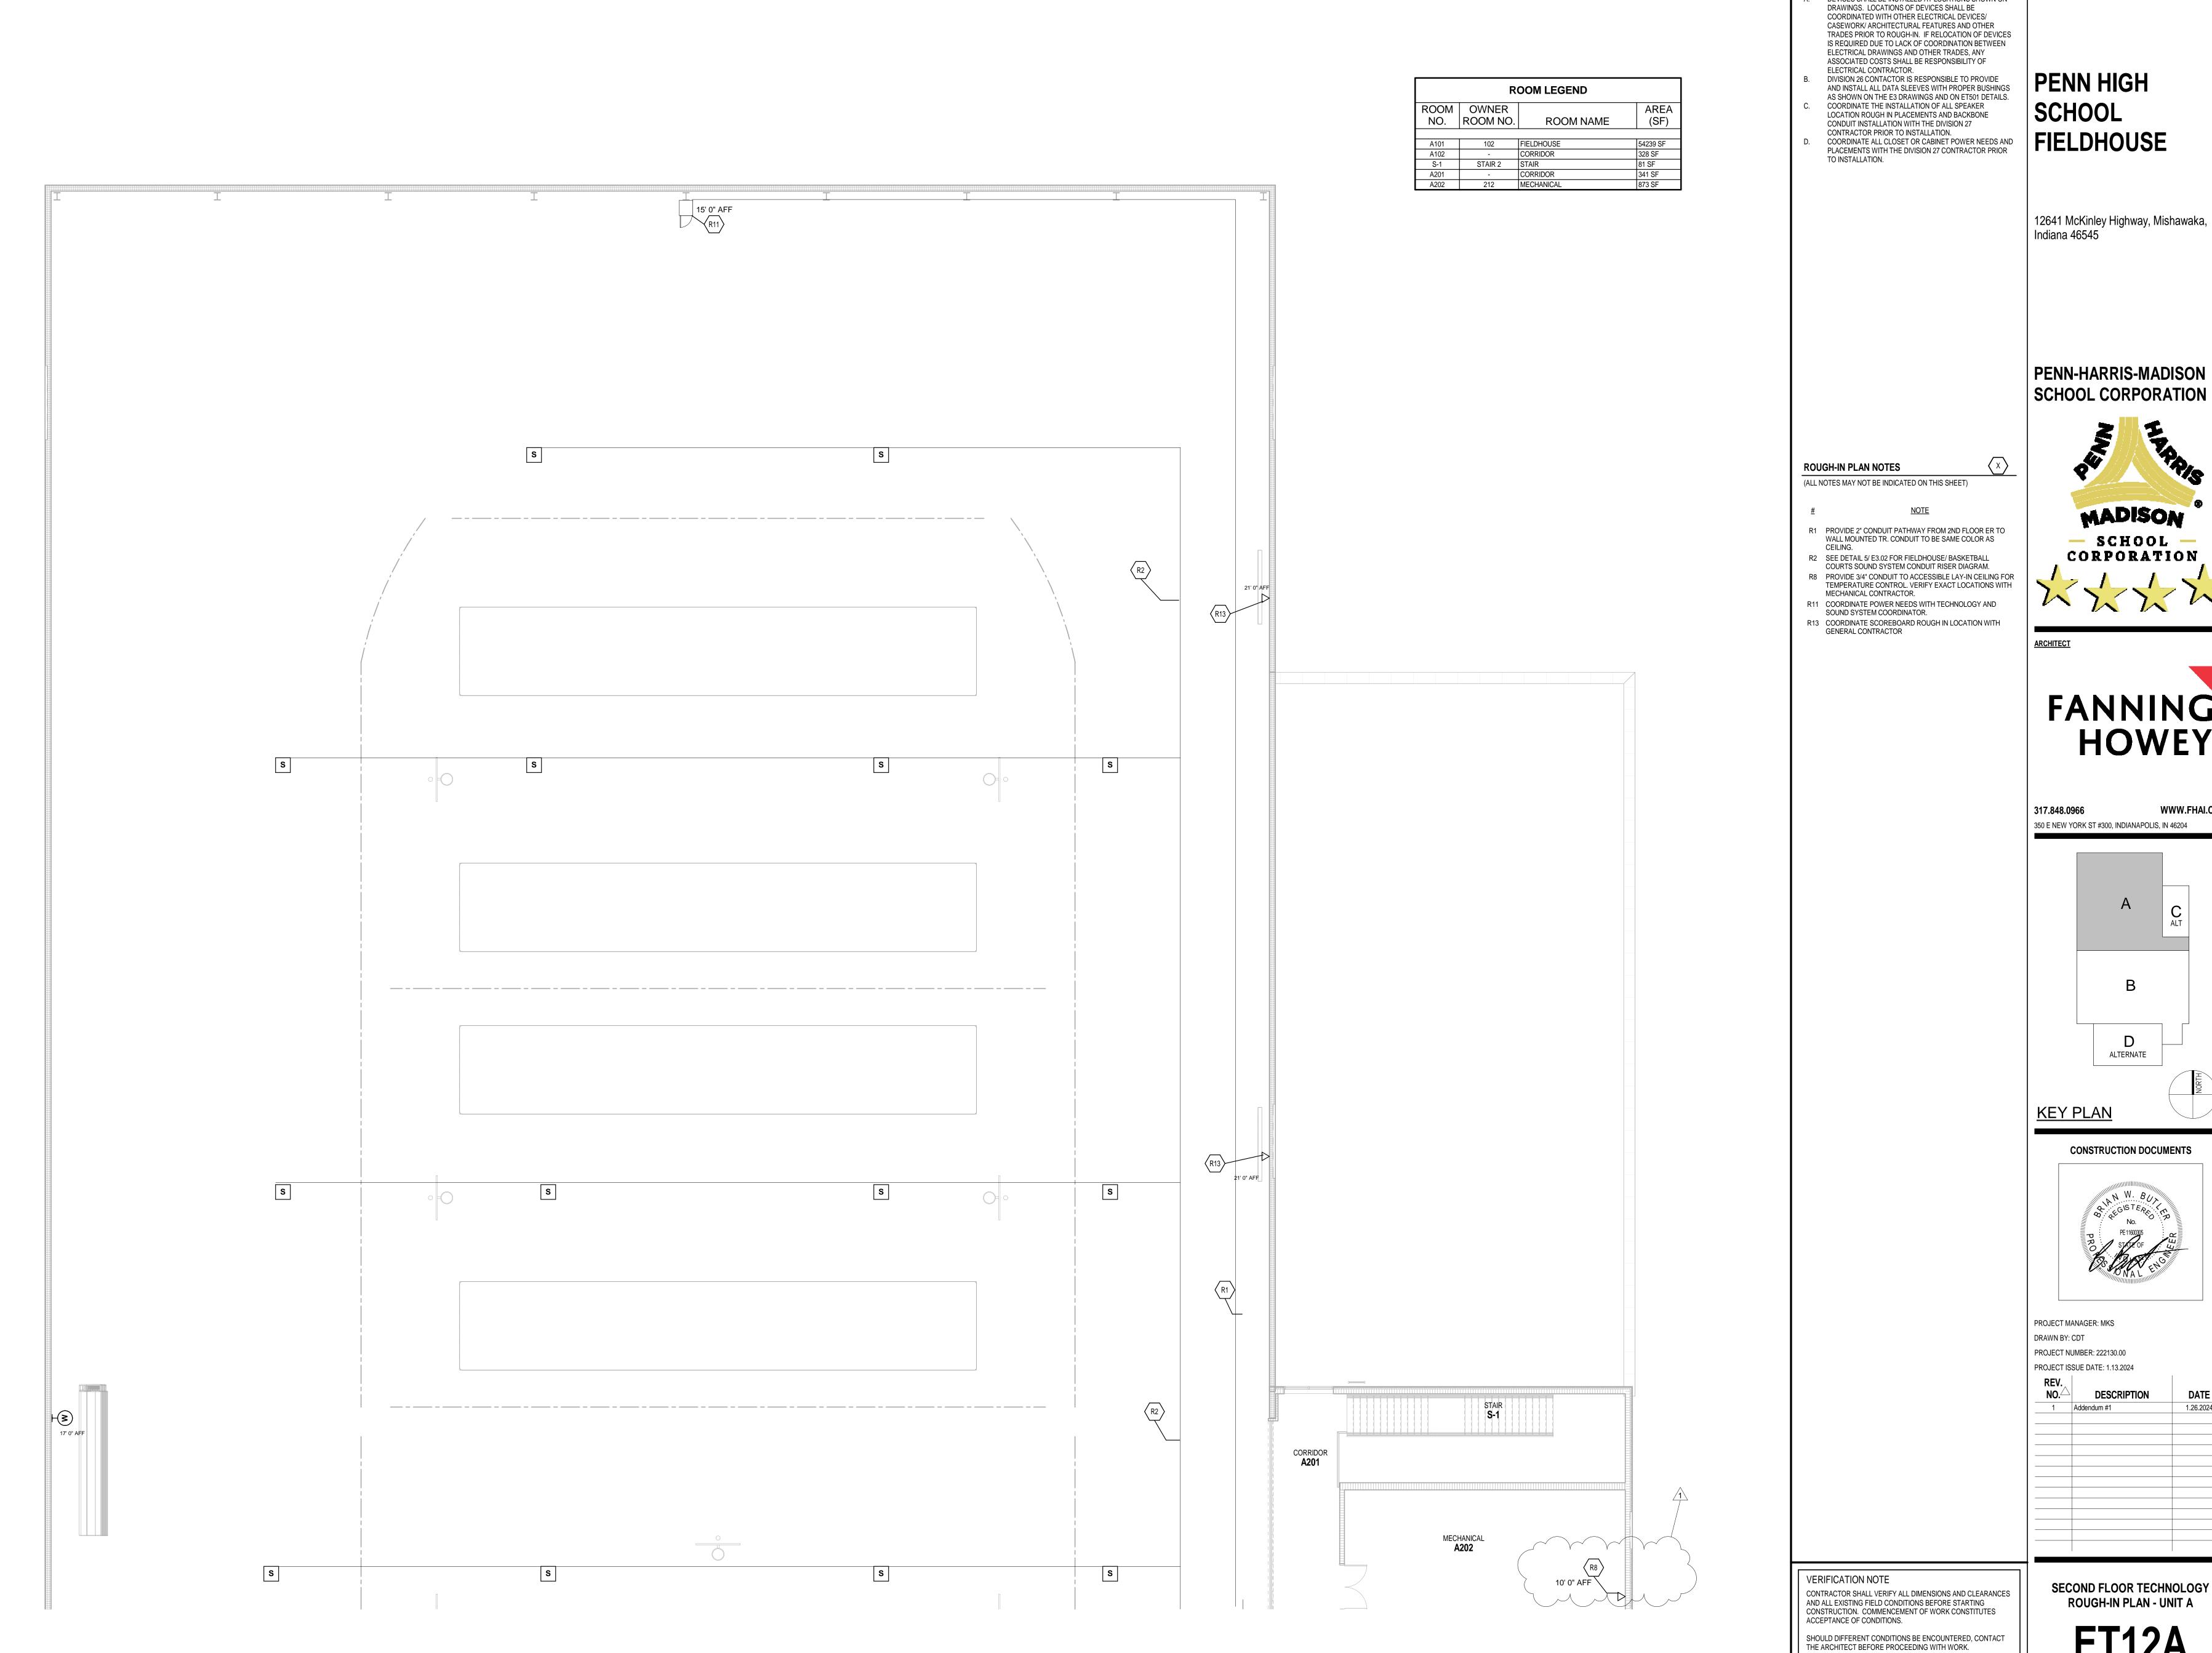

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TECHNOLOGY ROUGH-IN GENERAL NOTES

A. DEVICES SHALL BE INSTALLED AT LOCATIONS SHOWN ON

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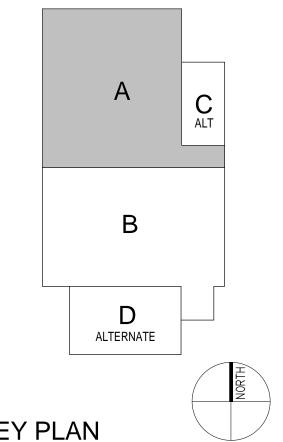
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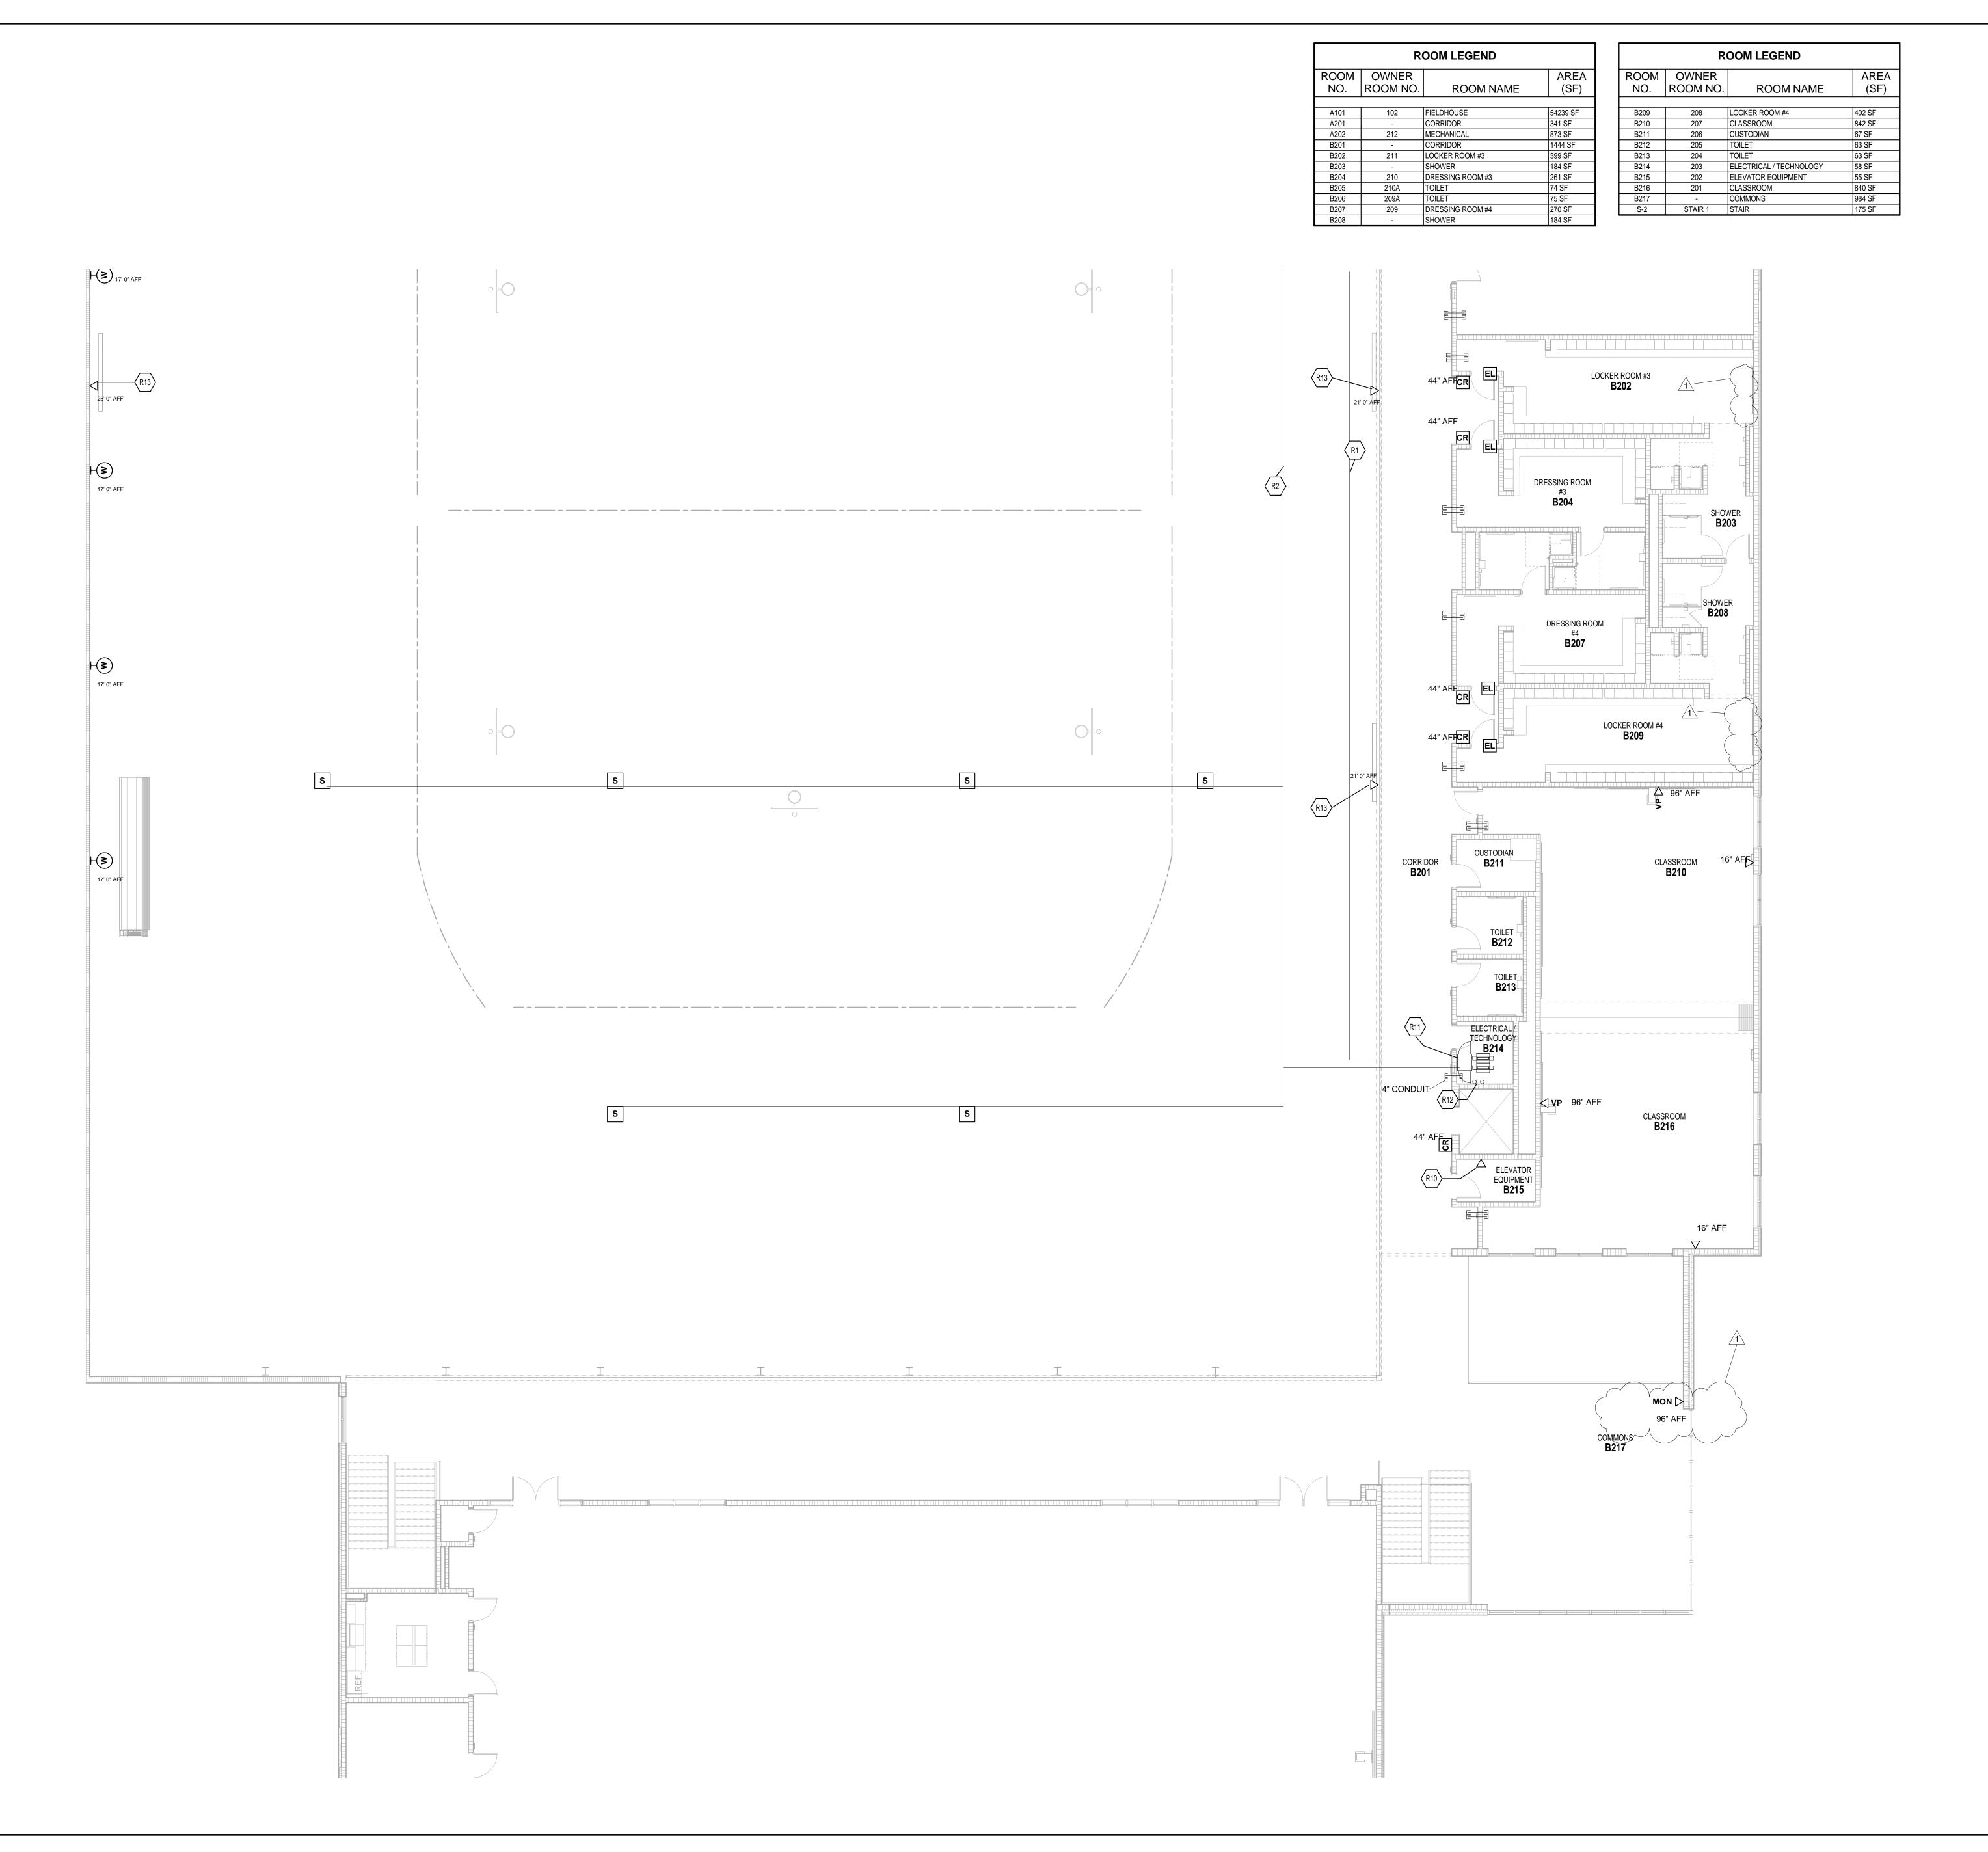
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NO.	DESCRIPTION	DATE
1	Addendum #1	1.26.2024

SECOND FLOOR TECHNOLOGY **ROUGH-IN PLAN - UNIT A**



TECHNOLOGY ROUGH-IN GENERAL NOTES

A. DEVICES SHALL BE INSTALLED AT LOCATIONS SHOWN ON DRAWINGS. LOCATIONS OF DEVICES SHALL BE COORDINATED WITH OTHER ELECTRICAL DEVICES/ CASEWORK/ ARCHITECTURAL FEATURES AND OTHER TRADES PRIOR TO ROUGH-IN. IF RELOCATION OF DEVICES IS REQUIRED DUE TO LACK OF COORDINATION BETWEEN

ELECTRICAL DRAWINGS AND OTHER TRADES, ANY ASSOCIATED COSTS SHALL BE RESPONSIBILITY OF ELECTRICAL CONTRACTOR. DIVISION 26 CONTACTOR IS RESPONSIBLE TO PROVIDE AND INSTALL ALL DATA SLEEVES WITH PROPER BUSHINGS AS SHOWN ON THE E3 DRAWINGS AND ON ET501 DETAILS.

COORDINATE THE INSTALLATION OF ALL SPEAKER LOCATION ROUGH IN PLACEMENTS AND BACKBONE CONDUIT INSTALLATION WITH THE DIVISION 27 CONTRACTOR PRIOR TO INSTALLATION. COORDINATE ALL CLOSET OR CABINET POWER NEEDS AND PLACEMENTS WITH THE DIVISION 27 CONTRACTOR PRIOR

TO INSTALLATION.

ROUGH-IN PLAN NOTES

ELEVATOR CONTRACTOR.

GENERAL CONTRACTOR

SOUND SYSTEM COORDINATOR.

(ALL NOTES MAY NOT BE INDICATED ON THIS SHEET)

<u>NOTE</u>

R1 PROVIDE 2" CONDUIT PATHWAY FROM 2ND FLOOR ER TO WALL MOUNTED TR. CONDUIT TO BE SAME COLOR AS

ELEVATOR EQUIPMENT. VERIFY EXACT LOCATIONS WITH

R11 COORDINATE POWER NEEDS WITH TECHNOLOGY AND

R12 PROVIDE 2 - 4" DATA STUBS FROM 2ND FLOOR TO FIRST

R13 COORDINATE SCOREBOARD ROUGH IN LOCATION WITH

R2 SEE DETAIL 5/ E3.02 FOR FIELDHOUSE/ BASKETBALL COURTS SOUND SYSTEM CONDUIT RISER DIAGRAM. R10 PROVIDE 3/4" CONDUIT TO ACCESSIBLE LAY-IN CEILING FOR

PENN HIGH SCHOOL **FIELDHOUSE**

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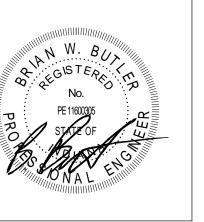
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PROJECT MANAGER: MKS DRAWN BY: CDT PROJECT NUMBER: 222130.00 PROJECT ISSUE DATE: 1.13.2024

REV. NO. \triangle	DESCRIPTION	DATE
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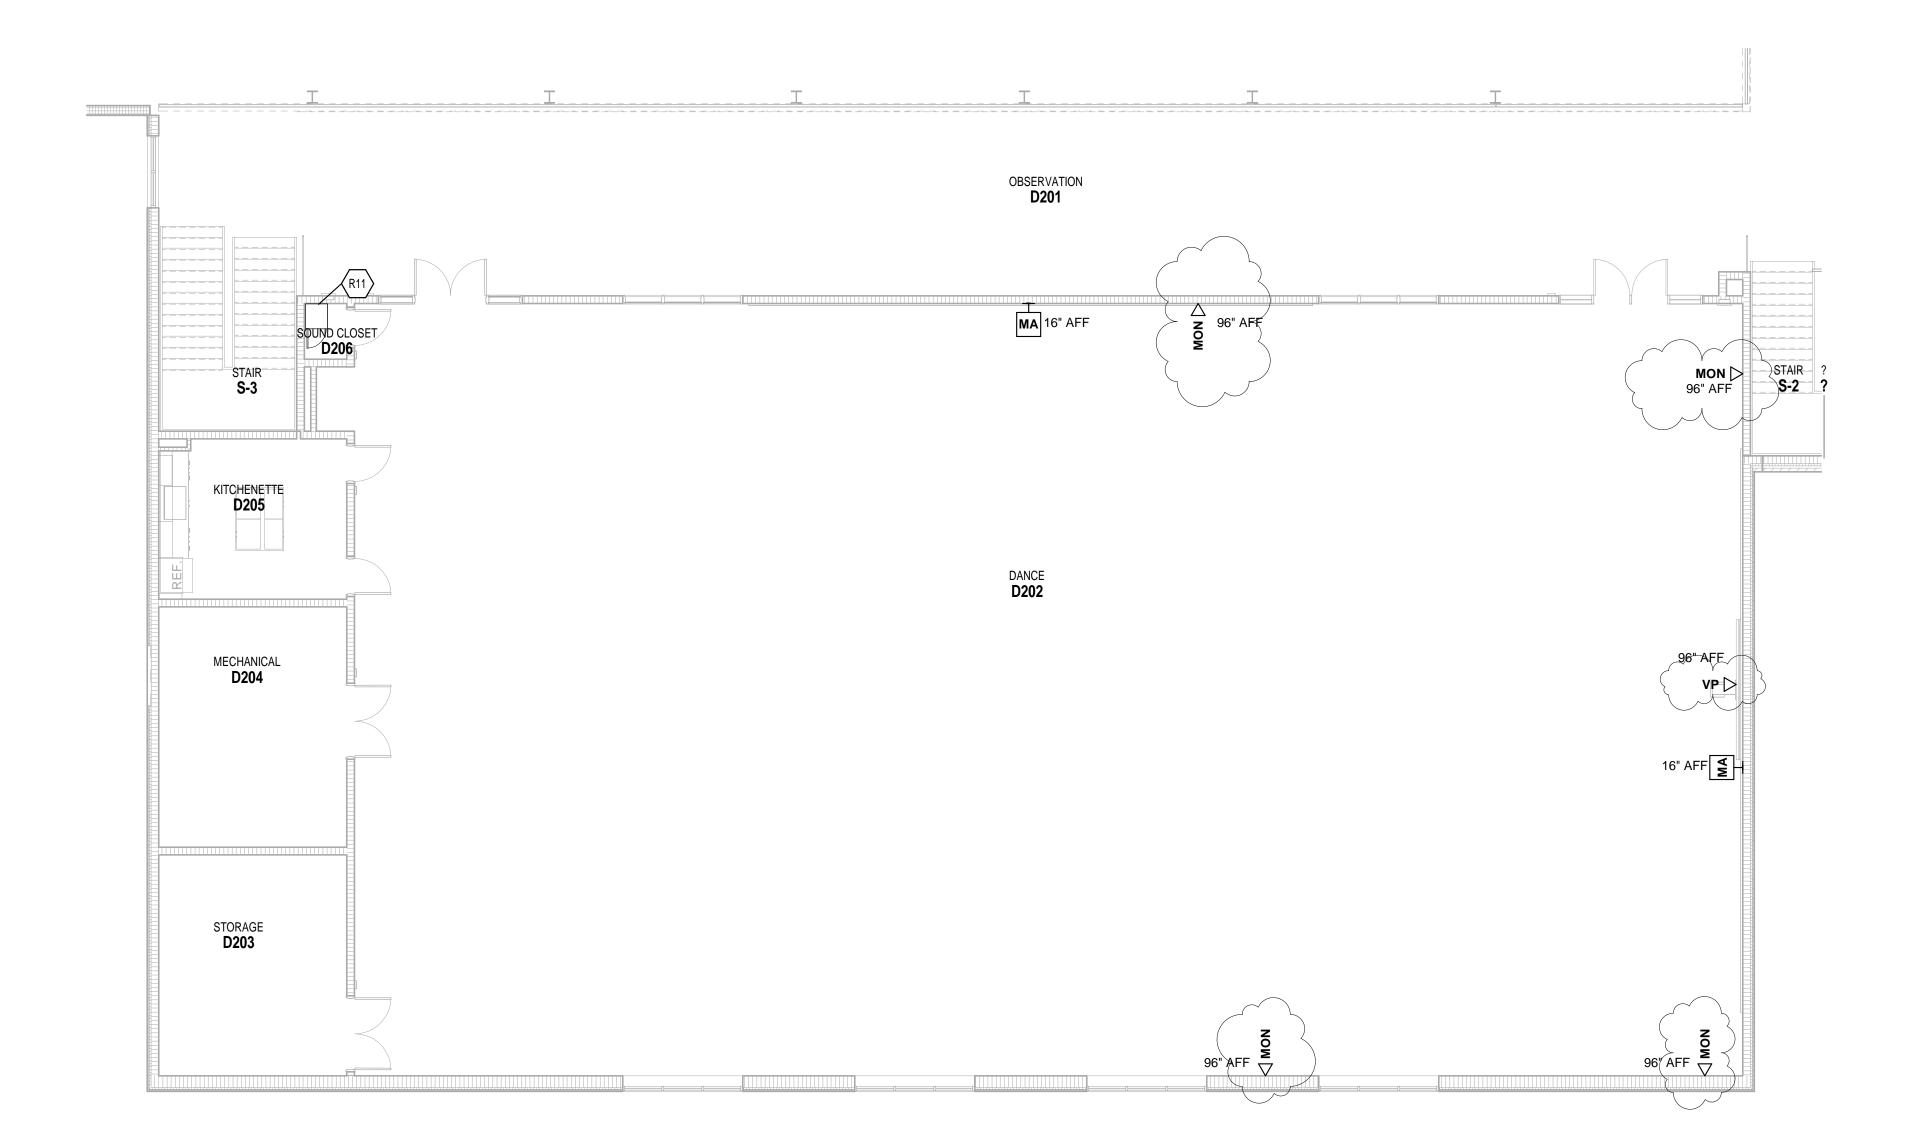
VERIFICATION NOTE

CONTRACTOR SHALL VERIFY ALL DIMENSIONS AND CLEARANCES AND ALL EXISTING FIELD CONDITIONS BEFORE STARTING CONSTRUCTION. COMMENCEMENT OF WORK CONSTITUTES ACCEPTANCE OF CONDITIONS.

SHOULD DIFFERENT CONDITIONS BE ENCOUNTERED, CONTACT THE ARCHITECT BEFORE PROCEEDING WITH WORK.

SECOND FLOOR TECHNOLOGY ROUGH-IN PLAN - UNIT B

	R	OOM LEGEND	
ROOM NO.	OWNER ROOM NO.	ROOM NAME	ARE (SF
			-
A101	102	FIELDHOUSE	54239 SF
B201	-	CORRIDOR	1444 SF
B217	-	COMMONS	984 SF
S-2	STAIR 1	STAIR	175 SF
	·	· · · · · · · · · · · · · · · · · · ·	-



SECOND FLOOR TECHNOLOGY ROUGH-IN PLAN - UNIT D ALTERNATE

N.T.S.

TECHNOLOGY ROUGH-IN GENERAL NOTES

- A. DEVICES SHALL BE INSTALLED AT LOCATIONS SHOWN ON DRAWINGS. LOCATIONS OF DEVICES SHALL BE COORDINATED WITH OTHER ELECTRICAL DEVICES/ CASEWORK/ ARCHITECTURAL FEATURES AND OTHER TRADES PRIOR TO ROUGH-IN. IF RELOCATION OF DEVICES IS REQUIRED DUE TO LACK OF COORDINATION BETWEEN ELECTRICAL DRAWINGS AND OTHER TRADES, ANY ASSOCIATED COSTS SHALL BE RESPONSIBILITY OF
 - ELECTRICAL DRAWINGS AND OTHER TRADES, ANY
 ASSOCIATED COSTS SHALL BE RESPONSIBILITY OF
 ELECTRICAL CONTRACTOR.
 DIVISION 26 CONTACTOR IS RESPONSIBLE TO PROVIDE
 AND INSTALL ALL DATA SLEEVES WITH PROPER BUSHINGS
- AND INSTALL ALL DATA SLEEVES WITH PROPER BUSHINGS
 AS SHOWN ON THE E3 DRAWINGS AND ON ET501 DETAILS.
 C. COORDINATE THE INSTALLATION OF ALL SPEAKER
 LOCATION ROUGH IN PLACEMENTS AND BACKBONE

ROUGH-IN PLAN NOTES

(ALL NOTES MAY NOT BE INDICATED ON THIS SHEET)

<u>NOTE</u>

R11 COORDINATE POWER NEEDS WITH TECHNOLOGY AND SOUND SYSTEM COORDINATOR.

CONDUIT INSTALLATION WITH THE DIVISION 27
CONTRACTOR PRIOR TO INSTALLATION.

D. COORDINATE ALL CLOSET OR CABINET POWER NEEDS AND PLACEMENTS WITH THE DIVISION 27 CONTRACTOR PRIOR TO INSTALLATION.

PENN HIGH SCHOOL FIELDHOUSE

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CORPORATION

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A

C
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B

KEY PLAN

CONSTRUCTION DOCUMENTS

PE11600006
STATE OF

WALLES ON A L

DRAWN BY: CDT

PROJECT NUMBER: 222130.00

PROJECT ISSUE DATE: 1.13.2024


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NO. DESCRIPTION

1 Addendum #1 1

PROJECT MANAGER: MKS

SECOND FLOOR TECHNOLOGY
ROUGH-IN PLAN - UNIT D ALT

ET12D

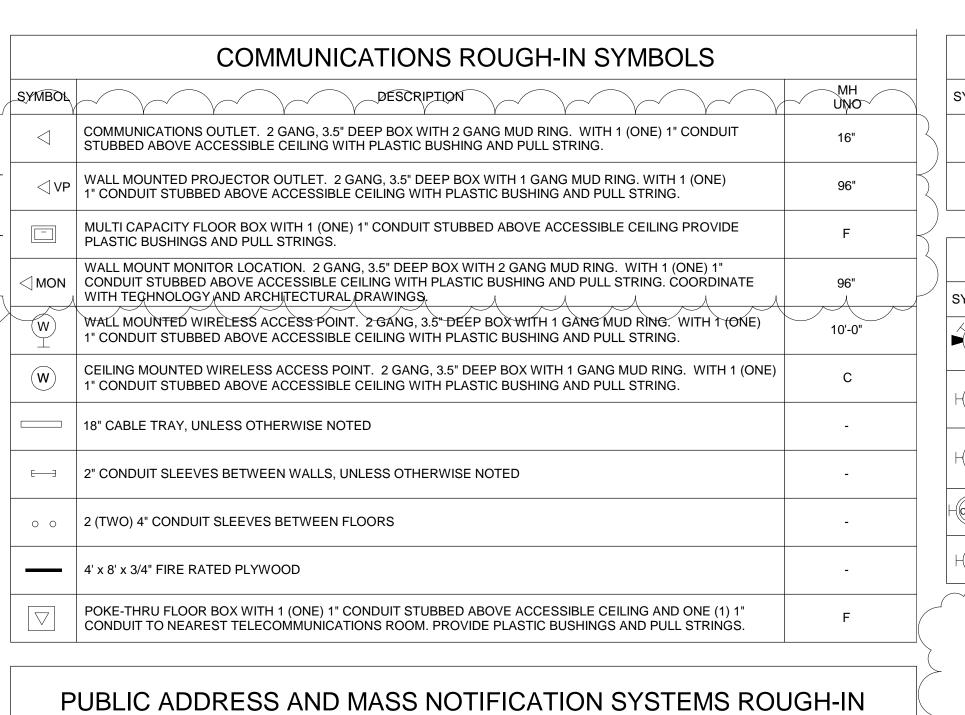


P	UBLIC ADDRESS AND MASS NOTIFICATION SYSTEMS ROU SYMBOLS	JGH-IN
SYMBOL	DESCRIPTION	MH UNO
¥	SOUND SYSTEM ANTENNA. 1 GANG, 3.5" DEEP BOX WITH 1" CONDUIT TO SOUND SYSTEM JUNCTION BOX	BETWEEN JOISTS
S	CEILING MOUNTED SOUND SYSTEM SPEAKER, 1 GANG BOX WITH 1" CONDUIT TO SOUND SYSTEM JUNCTION BOX	-
S	WALL MOUNTED SOUND REINFORCEMENT SPEAKER BOX, 2 GANG, 3.5" DEEP BOX WITH 1 GANG MUD RING. WITH 1 (ONE) 1" CONDUIT STUBBED ABOVE ACCESSIBLE CEILING WITH PLASTIC BUSHING AND PULL STRING.	-
M	MICROPHONE INPUT. 2 GANG, 3.5" DEEP BOX WITH 2 GANG MUD RING. WITH 1 (ONE) 1" CONDUIT TO SOUND SYSTEM JUNCTION BOX WITH PULL STRING.	16"
A	AUXILIARY INPUT. 2 GANG, 3.5" DEEP BOX WITH 2 GANG MUD RING. WITH 1 (ONE) 1" CONDUIT TO SOUND SYSTEM JUNCTION BOX WITH PULL STRING.	16"
MA	WALL MOUNTED MICROPHONE/AUXILIARY INPUT. 2 GANG, 3.5" DEEP BOX WITH 2 GANG MUD RING. WITH 1 (ONE) 1" CONDUIT TO SOUND SYSTEM JUNCTION BOX WITH PULL STRING.	16"
S	WALL MOUNTED SOUND SYSTEM SPEAKER OUTLET. 2 GANG, 3.5" DEEP BOX WITH 1 GANG MUD RING. WITH 1 (ONE) 1" CONDUIT TO SOUND SYSTEM JUNCTION BOX WITH PULL STRING.	NOTED ON DRAWINGS
SA	LINE ARRAY COLUMN SPEAKERS - WALL MOUNTED. 2 GANG, 3.5" DEEP BOX WITH 1 GANG MUD RING. WITH 1 (ONE) 1" CONDUIT TO SOUND SYSTEM JUNCTION BOX WITH PULL STRING.	NOTED ON DRAWINGS
	RECESSED JUNCTION BOX FOR SOUND SYSTEM. REFER TO DETAILS AND FLOORPLANS FOR SIZE.	16"

PRODUCTION INTERCOM, 2 GANG, 3.5" DEEP BOX WITH 1 GANG MUD RING. WITH 1 (ONE) 1" CONDUIT TO

SOUND SYSTEM JUNCTION BOX WITH PULL STRING.

		\mathcal{A}
	ACCESS CONTROL ROUGH-IN SYMBOLS	
SYMBOL	DESCRIPTION	MH UNO
ACP	ACCESS CONTROL PANEL, 2 GANG, 3.5" DEEP BOX WITH 2 GANG MUD RING, 2 (TWO) 1" CONDUIT STUBBED ABOVE ACCESSIBLE LAY-IN CEILING WITH PULL STRING	-
CR	CARD READER. 2 GANG, 3.5" DEEP BOX WITH 2 GANG MUD RING, 1 (ONE) 1" CONDUIT TO JUNCTION BOX ABOVE DOOR	44"
EL	ELECTRONIC LATCH. 2 GANG, 3.5" DEEP BOX WITH 1 GANG MUD RING, 1 (ONE) 1" CONDUIT TO JUNCTION BOX ABOVE DOOR	-
J	24" W x 24" H x 6" D JUNCTION BOX ABOVE DOOR FOR ACCESS CONTROL DOOR CONTROLLER.	ABOVE CLG.
КВ	KEY BOX. 2 GANG, 3.5" DEEP BOX WITH 2 GANG MUD RING, 1 (ONE) 1" CONDUIT STUBBED ABOVE ACCESSIBLE CEILING WITH PLASTIC BUSHING AND PULL STRING.	60"
•	PUSH TO RELEASE BUTTON. 2 GANG, 3.5" DEEP BOX WITH 1 GANG MUD RING. 1" CONDUIT STUBBED ABOVE ACCESSIBLE CEILING WITH PLASTIC BUSHING AND PULL STRING.	44"
ADO	AUTOMATIC DOOR OPERATOR, 1" CONDUIT TO JUNCTION BOX ABOVE DOOR	-
REX	REQUEST TO EXIT SWITCH, 2 GANG, 3.5" DEEP BOX WITH 1 GANG MUD RING, 1 (ONE) 1" CONDUIT TO JUNCTION BOX ABOVE DOOR (LOCATED IN EXIT DOOR HARDWARE)	-

	INTRUSION DETECTION ROUGH-IN SYMBOLS	
SYMBOL	DESCRIPTION	MH UNO
IDCP	INTRUSION DETECTION PANEL, 2 GANG, 3.5" DEEP BOX WITH 2 (TWO) 1" CONDUIT STUBBED ABOVE ACCESSIBLE LAY-IN CEILING	-
DC	DOOR CONTACT ROUGH-IN	-
K	KEYPAD. 2 GANG, 3.5" DEEP BOX WITH 1 GANG MUD RING. 1" CONDUIT STUBBED ABOVE ACCESSIBLE CEILING WITH PLASTIC BUSHING AND PULL STRING.	44"
⊢MD→	WALL MOUNTED MOTION DETECTOR. 2 GANG, 3.5" DEEP BOX WITH 1 GANG MUD RING. 1" CONDUIT STUBBED ABOVE ACCESSIBLE CEILING WITH PULL STRING	-
MD-	CEILING MOUNTED MOTION DETECTOR. 2 GANG, 3.5" DEEP BOX WITH 1 GANG MUD RING. 1" CONDUIT STUBBED ABOVE ACCESSIBLE CEILING WITH PULL STRING	-

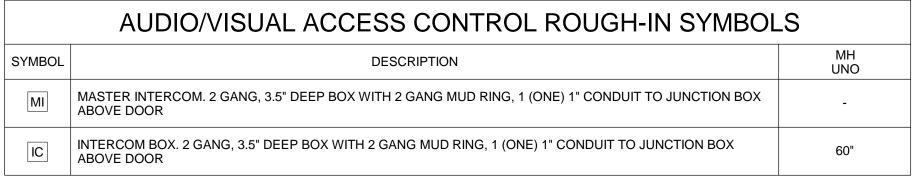

	VIDEO SURVEILLANCE CAMERA ROUGH-IN SYMBOL	-
SYMBOL	DESCRIPTION	MH UNO
CAM	WALL MOUNTED VIDEO SURVEILLANCE CAMERA2 2 GANG, 3.5" DEEP BOX WITH 1 GANG MUD RING WITH 1" CONDUIT STUBBED ABOVE ACCESSIBLE CEILING WITH PULL BOX. (MOUNT WITHIN 12" OF CORNER WHEN APPLICABLE)	+144"
HCAM	WALL MOUNTED VIDEO SURVEILLANCE CAMERAS 2 GANG, 3.5" DEEP BOX WITH 1 GANG MUD RING WITH 1" CONDUIT STUBBED ABOVE ACCESSIBLE CEILING WITH PULL BOX. (MOUNT WITHIN 12" OF CORNER WHEN APPLICABLE)	+144"
HCAM	WALL MOUNTED VIDEO SURVEILLANCE CAMERAS 2 GANG, 3.5" DEEP BOX WITH 1 GANG MUD RING WITH 1" CONDUIT STUBBED ABOVE ACCESSIBLE CEILING WITH PULL BOX. (MOUNT WITHIN 12" OF CORNER WHEN APPLICABLE)	+144"
⊢(CAM) ■ W	WALL MOUNTED VIDEO SURVEILLANCE CAMERA 2 GANG, 3.5" DEEP BOX WITH 1 GANG MUD RING WITH 1" CONDUIT STUBBED ABOVE ACCESSIBLE CEILING WITH PULL BOX. (MOUNT WITHIN 12" OF CORNER WHEN APPLICABLE)	+144"
WP (CAM)	WALL MOUNTED WEATHERPROOF VIDEO SURVEILLANCE CAMERA, 2 GANG, 3.5" DEEP BOX WITH 1 GANG MUD RING WITH 1" CONDUIT STUBBED ABOVE ACCESSIBLE CEILING WITH PULL BOX. (MOUNT WITHIN 12"-16" OF CORNER WHEN APPLICABLE)	+144"

2" CONDUIT SLEEVE FOR SOUND SYSTEM CABLING,

ACCESS CONTROL CABLING, INTRUSION DETECTION CABLING, & BUILDING AUTOMATION SYSTEMS (BAS)

NOTE: SLEEVES SHALL NOT PENETRATE CONCRETE BOND BEAMS OR LINTELS.


2" CONDUIT SLEEVE FOR COMMUNICATION CABLING


- FLOOR


(4 PAIR UTP)

12" MIN.

24" MAX.

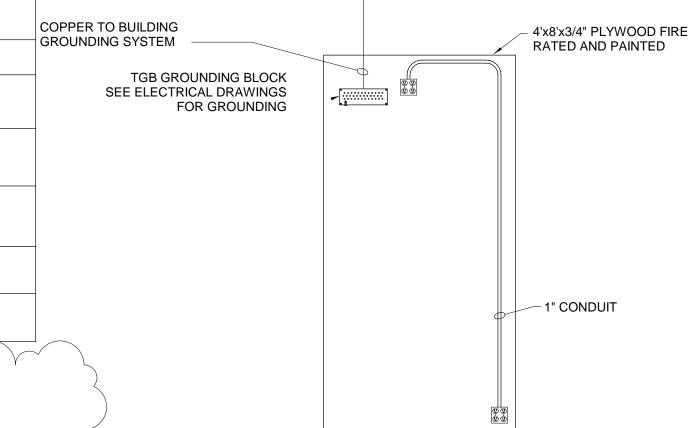

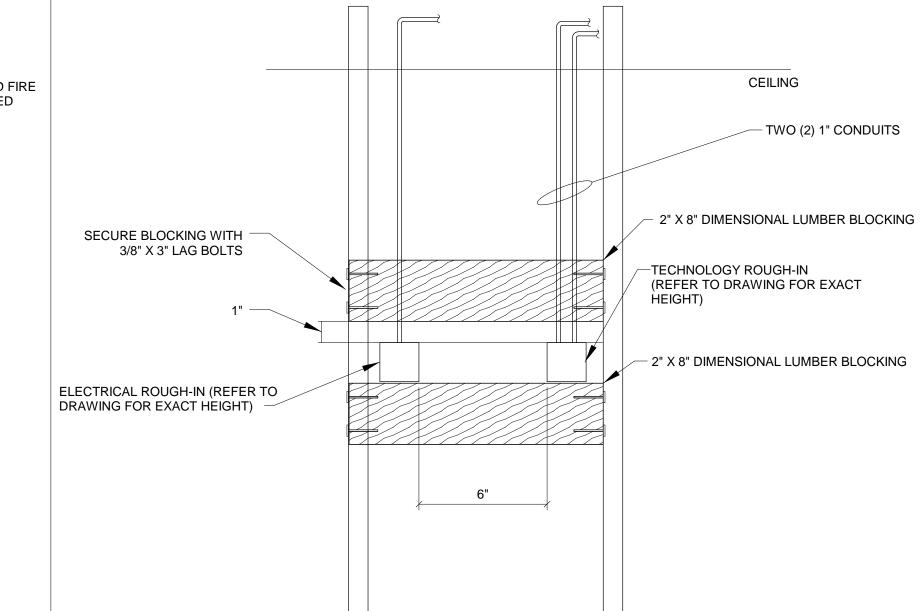


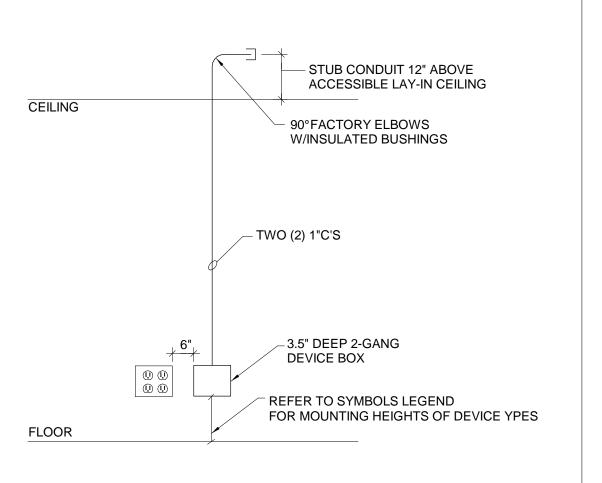

FLOOR


GENERAL NOTES:

- MOUNTING HEIGHTS AS LISTED ON THIS SHEET UNLESS NOTED OTHERWISE.
- 2. PROVIDE BLANK COVERPLATES FOR ALL UNUSED BOXES.
- 3. RECEPTACLES ARE SHOWN FOR COORDINATION ONLY. REFER TO ELECTRICAL DRAWINGS FOR QUANTITY, CIRCUITING, MOUNTING, AND ADDITIONAL REQUIREMENTS.
- 4. PROVIDE PULL STRINGS IN CONDUIT RUNS GREATER THAN 10' IN LENGTH.

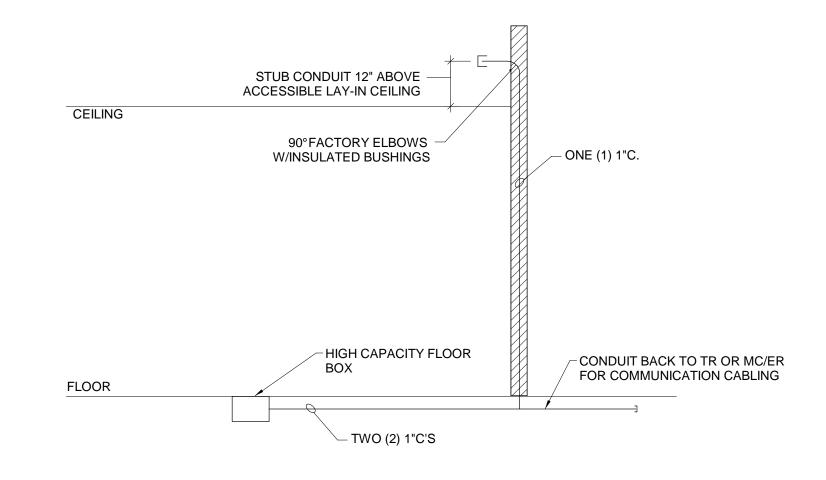


GENERAL NOTES:

- 1. PROVIDE BLANK COVERPLATES FOR ALL UNUSED BOXES.
- 2. RECEPTACLES ARE SHOWN FOR COORDINATION ONLY. REFER TO ELECTRICAL DRAWINGS FOR QUANTITY, CIRCUITING, MOUNTING, AND ADDITIONAL REQUIREMENTS.
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GENERAL NOTES:

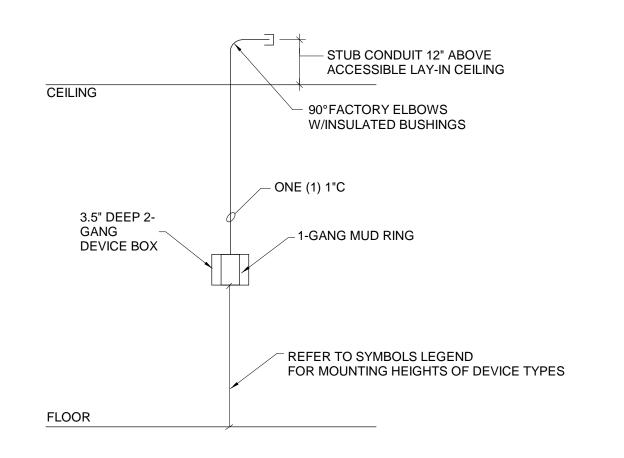- 1. PROVIDE BLANK COVERPLATES FOR ALL UNUSED BOXES.
- 2. PROVIDE PULL STRINGS IN CONDUIT RUNS GREATER THAN 10' IN LENGTH



GENERAL NOTES:

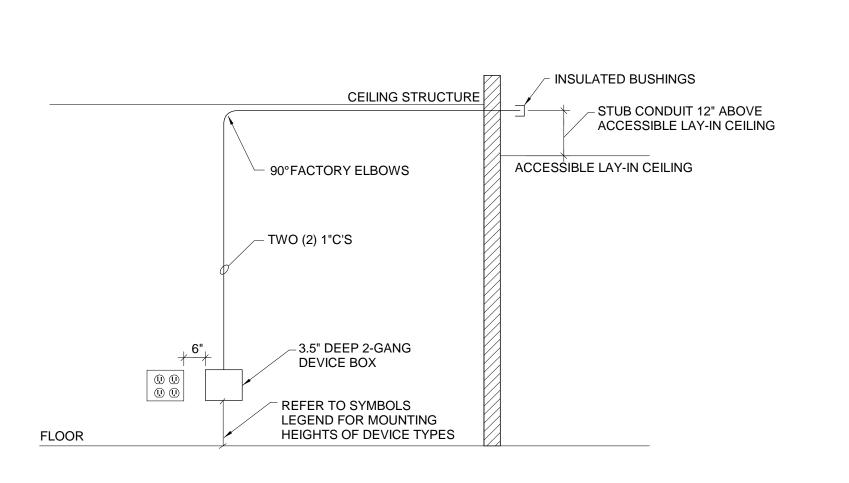- MOUNTING HEIGHTS AS LISTED ON THIS
- SHEET UNLESS NOTED OTHERWISE.


 2. PROVIDE BLANK COVERPLATES FOR ALL UNUSED BOXES.
- 3. RECEPTACLES ARE SHOWN FOR COORDINATION ONLY. REFER TO ELECTRICAL DRAWINGS FOR QUANTITY, CIRCUITING, MOUNTING, AND ADDITIONAL REQUIREMENTS.
- 4. PROVIDE PULL STRINGS IN CONDUIT RUNS GREATER THAN 10'

PENN HIGH SCHOOL FIELDHOUSE

12641 McKinley Highway, Mishawaka, Indiana 46545

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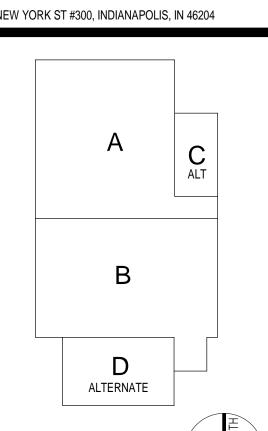
PENN-HARRIS-MADISON

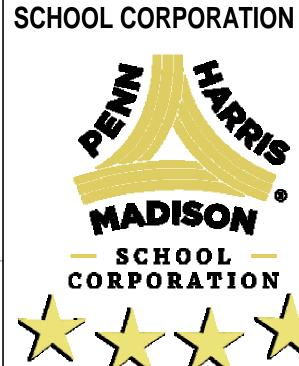


FLOOR

FANNING HOWEY

317.848.0966 WWW.FHAI.COM 350 E NEW YORK ST #300, INDIANAPOLIS, IN 46204



KEY PLAN

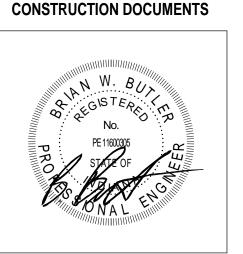

PROJECT MANAGER: MKS

DRAWN BY: CDT


PROJECT NUMBER: 222130.00

PROJECT ISSUE DATE: 1.13.2024

REV. NO. \triangle	DESCRIPTION	DATE
1	Addendum #1	1.26.2024

TECHNOLOGY ROUGH-IN DETAILS

ET501

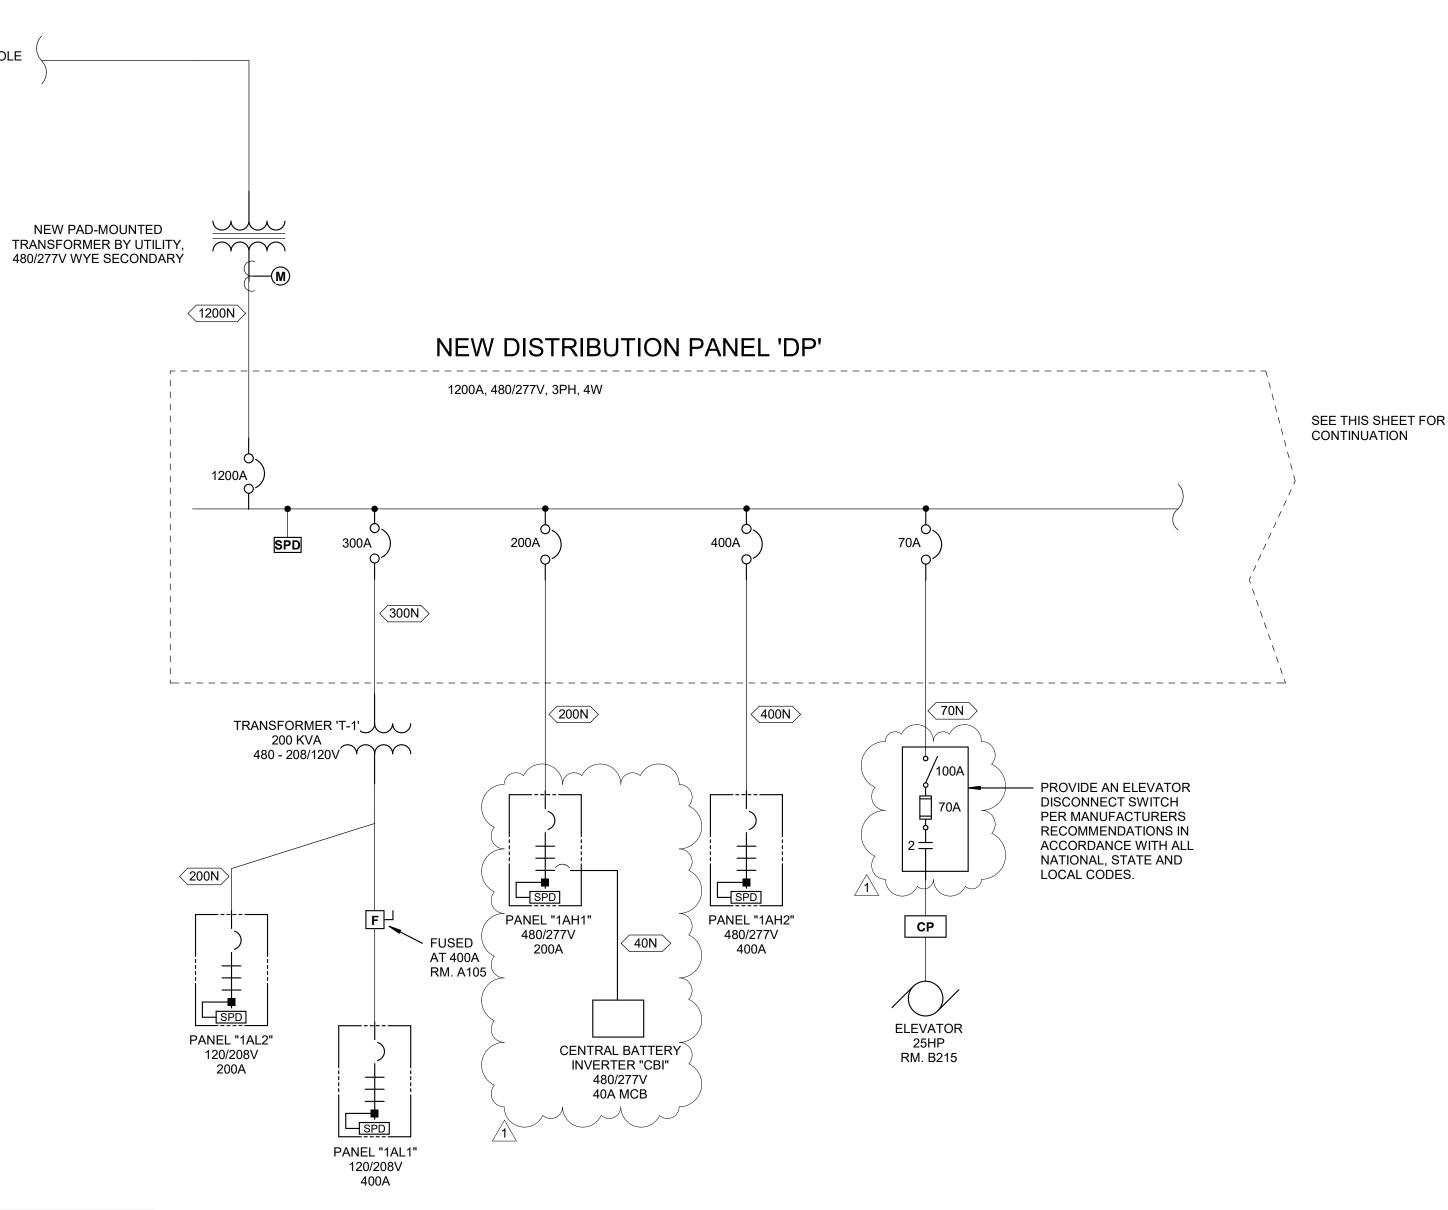

70A	40A	60A	125A	125A	
ACCU-1 63 MCA ROOF	ACCU-3 40 MCA OUTSIDE (ALTERNATE)	ACCU-4 52 MCA OUTSIDE (ALTERNATE)	ACCU-5 125 MCA OUTSIDE	ACCU-6 125 MCA OUTSIDE	

ONE-LINE DIAGRAM

NOT TO SCALE

	PLAN TYPE	MANUFACTURER/CATALOG	MOUNTING	NO.	WATTS	LAMPS TYPE	LUMENS	APPLIED VOLTAGE	DESCRIPTION	LOA
^	\	LITHONIA DSX2 SERIES	30'-0" SQUARE STEEL	1	219 W	LED	29085 lm	277 V	TYPE 2 MEDIUM DISTRIBUTION, 4000K CCT, WITH MULTI-VOLT DRIVER. MOUNT TO NEW	219 V
	· 3		POLE 30'-0" SQUARE STEEL	1	219 W	LED	29423 lm	277 V	30-FOOT SQUARE STEEL POLE, DARK BRONZE FINISH. TYPE 3 MEDIUM DISTRIBUTION, 4000K CCT, WITH MULTI-VOLT DRIVER. MOUNT TO NEW	219 V
			POLE	1					30-FOOT SQUARE STEEL POLE, DARK BRONZE FINISH.	
) 		30'-0" SQUARE STEEL POLE	1	219 W	LED	29861 lm	277 V	30-FOOT SQUARE STEEL POLE, DARK BRONZE FINISH.	219 V
)		30'-0" SQUARE STEEL POLE	1	219 W	LED	21401 lm	277 V	MOUNT TO NEW 30-FOOT SQUARE STEEL POLE, DARK BRONZE FINISH.	219 V
E		LITHONIA DSX2 SERIES	30'-0" SQUARE STEEL POLE	1	219 W	LED	22104 lm	277 V	TYPE 4 BACKLIGHT CONTROL DISTRIBUTION, 4000K CCT, WITH MULTI-VOLT DRIVER. MOUNT TO NEW 30-FOOT SQUARE STEEL POLE, DARK BRONZE FINISH.	219 V
F	=	LITHONIA DSX2 SERIES	30'-0" SQUARE STEEL POLE	1	219 W	LED	21594 lm	277 V	LEFT CORNER CUTOFF DISTRIBUTION, 4000K CCT, WITH MULTI-VOLT DRIVER. MOUNT TO NEW 30-FOOT SQUARE STEEL POLE, DARK BRONZE FINISH.	219 V
L	.DW61	FAIL-SAFE FLD6A SERIES PHILIPS BRANDS A/E APPROVED EQUAL GOTHAM EVO SHOWER SERIES PRESCOLITE LF6LEDG4 SERIES	RECESSED	1	15 W	LED	1000 lm	277 V	6-INCH ROUND APERTURE LED SHOWER LIGHT WITH REGRESSED LENS REFLECTOR, WHITE REFLECTOR AND TRIM, SELF-FLANGED, IP65 WET LOCATION LISTED.	15 VA
L	.DW61X	FAIL-SAFE FLD6A SERIES PHILIPS BRANDS A/E APPROVED EQUAL GOTHAM EVO SHOWER SERIES PRESCOLITE LF6LEDG4 SERIES	RECESSED	1	15 W	LED	1000 lm	277 V	6-INCH ROUND APERTURE LED SHOWER LIGHT WITH REGRESSED LENS REFLECTOR, WHITE REFLECTOR AND TRIM, SELF-FLANGED, IP65 WET LOCATION LISTED, WITH EMERGENCY BATTERY PACK.	15 VA
L	.E1	LITHONIA WDGE2 SERIES	SURFACE WALL	1	32 W	LED	3200 lm	277 V	LED WALL MOUNTED ARCHITECTURAL LUMINAIRE, TYPE 3 MEDIUM DISTRIBUTION, 4000K CCT, 70 CRI, DARK BRONZE FINISH, WITH MVOLT DRIVER. MOUNT ONTO JUNCTION BOX. VANDAL RESISTANT.	32 VA
L	E1X	LITHONIA WDGE2 SERIES	SURFACE WALL	1	32 W	LED	3200 lm	277 V	LED WALL MOUNTED ARCHITECTURAL LUMINAIRE, TYPE 3 MEDIUM DISTRIBUTION, 4000K CCT, 70 CRI, DARK BRONZE FINISH, WITH MVOLT DRIVER. PROVIDE WITH INTEGRAL COLD WEATHER EMERGENCY BATTERY PACK. MOUNT ONTO JUNCTION BOX. VANDAL RESISTANT.	
L	.F2	LITHONIA CPX SERIES	RECESSED	1	45 W	LED	3900 lm	277 V	2 BY 4-FOOT LED FLAT PANEL FIXTURE WITH SATIN WHITE LENS, ALUMINUM FRAME, 4000K, 80CRI, ADJUSTABLE LUMEN OUTPUT, 0-10VDC DIMMING, MVOLT DRIVER.	45 VA
	F2X	LITHONIA CPX SERIES	RECESSED	1	45 W	LED	3900 lm	277 V	2 BY 4-FOOT LED FLAT PANEL FIXTURE WITH SATIN WHITE LENS, ALUMINUM FRAME, 4000K, 80CRI, ADJUSTABLE LUMEN OUTPUT, 0-10VDC DIMMING, MVOLT DRIVER WITH EMERGENCY BATTERY PACK.	45 VA
	.H18	LITHONIA IBG SERIES	SUSPENDED	1	192 W	LED	18000 lm	277 V	2 BY 4-FOOT LED HIGH BAY, 95% REFLECTIVE SPECULAR ALUMINUM REFLECTOR, WIDE DISTRIBUTION, FROSTED ACRYLIC LENS AND WIREGUARD, 0-10VDC DIMMING. PROVIDE WITH ALL MOUNTING HARDWARE AND ACCESSORIES FOR AIRCRAFT CABLE SUSPENSION.	192 V
	.H18X	LITHONIA IBG SERIES	SUSPENDED	1	192 W	LED	18000 lm	277 V	2 BY 4-FOOT LED HIGH BAY, 95% REFLECTIVE SPECULAR ALUMINUM REFLECTOR, WIDE DISTRIBUTION, FROSTED ACRYLIC AND WIREGUARD, 0-10VDC DIMMING. PROVIDE WITH ALL MOUNTING HARDWARE AND ACCESSORIES FOR AIRCRAFT CABLE SUSPENSION. PROVIDE WITH TRANSFER DEVICE COMPATIBLE WITH EMERGENCY BATTERY INVERTER.	192 V
L	R2	METALUX WNLED SERIES DAY-BRITE OWL SERIES LITHONIA SBL SERIES COLUMBIA LAW SERIES OR A/E APPROVED EQUAL	SUSPENDED	1	48 W	LED	4000 lm	277 V	4-FOOT LED WRAP AROUND FIXTURE, ACRYLIC PRISMATIC DIFFUSER, 0-10VDC DIMMING. IF SUSPENDED, INSTALL AT 8-FOOT AFF WITH CONDUIT STEMS (UNO).	48 VA
L	R2X	METALUX WNLED SERIES DAY-BRITE OWL SERIES LITHONIA SBL SERIES COLUMBIA LAW SERIES OR A/E APPROVED EQUAL	SUSPENDED	1	48 W	LED	4000 lm	277 V	4-FOOT LED WRAP AROUND FIXTURE, ACRYLIC PRISMATIC DIFFUSER, 0-10VDC DIMMING, WITH EMERGENCY BATTERY PACK. IF SUSPENDED, INSTALL AT 8-FOOT AFF WITH CONDUIT STEMS (UNO).	48 VA
L	.R4	METALUX WNLED SERIES DAY-BRITE OWL SERIES LITHONIA SBL SERIES HUBBELL BRANDS A/E APPROVED EQUAL	SURFACE	1	73 W	LED	7000 lm	277 V	4-FOOT WRAP LED AROUND FIXTURE, ACRYLIC PRISMATIC DIFFUSER, 0-10VDC DIMMING. IF SUSPENDED, INSTALL AT 8-FOOT AFF WITH CONDUIT STEMS (UNO).	73 VA
	.R4X	METALUX WNLED SERIES DAY-BRITE OWL SERIES LITHONIA SBL SERIES HUBBELL BRANDS A/E APPROVED EQUAL	SURFACE	1	73 W	LED	7000 lm	277 V	4-FOOT WRAP LED AROUND FIXTURE, ACRYLIC PRISMATIC DIFFUSER, 0-10VDC DIMMING, WITH EMERGENCY TRANSFER DEVICE. IF SUSPENDED, INSTALL AT 8-FOOT AFF WITH CONDUIT STEMS (UNO).	73 VA
>	(C	SURE-LITES CX SERIES CHLORIDE 55 LINE SERIES LITHONIA SIGNATURE SERIES DUAL-LITE SEMPRA SERIES OR A/E APPROVED EQUAL	SURFACE CEILING	1	3 W	RED LED	0 lm	277 V	CAST ALUMINUM AC ONLY EXIT SIGN, SINGLE FACE, DIRECTIONAL ARROWS INDICATED, WHITE HOUSING. REFER TO PROJECT MANUAL FOR ADDITIONAL REQUIREMENTS.	3 VA
>	(VW	SURE-LITES UX SERIES CHLORIDE 60 LINE SERIES LITHONIA LV SERIES DUAL-LITE SEWL SERIES	SURFACE WALL	1	3 W	RED LED	0 lm	277 V	CAST ALUMINUM, VANDAL RESISTANT AC ONLY EXIT SIGN, SINGLE FACE, DIRECTIONAL ARROWS INDICATED, WHITE HOUSING, LISTED FOR WET LOCATIONS. REFER TO PROJECT MANUAL FOR ADDITIONAL REQUIREMENTS.	3 VA
>	(W	SURE-LITES CX SERIES CHLORIDE 55 LINE SERIES LITHONIA SIGNATURE SERIES DUAL-LITE SEMPRA SERIES	SURFACE WALL	1	3 W	RED LED	0 lm	277 V	CAST ALUMINUM AC ONLY EXIT SIGN, SINGLE FACE, DIRECTIONAL ARROWS INDICATED, WHITE HOUSING. REFER TO PROJECT MANUAL FOR ADDITIONAL REQUIREMENTS.	3 VA

- SEE SPECIFICATIONS FOR DRIVER REQUIREMENTS.
- 2. FOR ALL DOWNLIGHTING FIXTURES, PROVIDE REQUIRED MOUNTING HARDWARE FOR MOUNTING IN LAY-IN TYPE CEILINGS.
- 3. CONTRACTOR TO VERIFY TYPES AND QUANTITY OF LIGHT FIXTURES REQUIRING EMERGENCY TRANSFER DEVICES AND PROVIDE REQUIRED QUANTITY OF EMERGENCY TRANSFER DEVICES, LABOR, MATERIAL, ETC. IN THE PROJECT BID FOR FIELD INSTALLATION OF EMERGENCY TRANSFER DEVICES.
- 4. LIGHT FIXTURE SUBMITTALS TO INCLUDE DATA SHEETS FOR ALL FIXTURE TYPES, INCLUDING ADDITIONAL DATA SHEETS FOR BALLAST COMBINATIONS REQUIRED TO MEET THE INSTALLATION REQUIREMENTS OF THE VARIOUS FIXTURE TYPES INDICATED IN THE REMARKS COLUMN OF THE FIXTURE SCHEDULES OR ON THE DRAWINGS. SUBMITTALS SHALL ALSO INDICATE COLOR FOR ANY CUSTOM COLOR LIGHT FIXTURES.

ONE LINE	DIAGRAM SYMBOLS	

			ONE	E LINE DIA	GRAM SYMBOLS				
•	MAIN LUG ONLY	DM	DIGITAL ELECTRONIC POWER METER	•		-90	FUSED SWITCH IN SWITCHBOARD, 3P UNO		FUSED POTENTIAL TRANSFORMER
# #	CIRCUIT BREAKER PANELBOARD, REFER TO E8 SERIES DRAWINGS FOR PANELBOARD SCHEDULES	K	KIRK KEY INTERLOCK	皇安	COMBINATION MAGNETIC MOTOR STARTER WITH FUSED SWITCH	-0 0-	DISCONNECT SWITCH IN SWITCHBOARD, 3P UNO	$\overline{}$	CURRENT TRANSFORMERS, 3 UNO
1AL1		─M	UTILITY METER	'			FUSED BOLTED PRESSURE SWITCH WITH GROUND FAULT AND SINGLE PHASE PROTECTION, 3P	<u> </u> (CAPACITOR
<u> </u>	MAIN BREAKER IN		MAIN BREAKER IN		COMBINATION MAGNETIC MOTOR	<u>E</u>	UNO	1.	
$\frac{1}{2}$	CIRCUIT BREAKER PANELBOARD, REFER TO E8 SERIES DRAWINGS FOR PANELBOARD SCHEDULES		CIRCUIT BREAKER PANELBOARD WITH SUB-FEED BREAKER, REFER TO E8 SERIES DRAWINGS	중	STARTER WITH CIRCUIT BREAKER	-0 $$ 0 $$	TRANSFER SWITCH	<u></u> ı	EARTH GROUND
2AL1	TOTAL PROPERTY OF THE PROPERTY	XXXA 5AL1	FOR PANELBOARD SCHEDULES	•	COMBINATION MAGNETIC MOTOR	N	DISCONNECT, 3P UNO	- ○ ^{LA} ○	LIGHTNING ARRESTER
	THROUGH FEED LUGS		MAIN BREAKER IN	<u> </u>	STARTER WITH MOTOR CIRCUIT PROTECTOR		MOLDED CASE CIRCUIT BREAKER, 3P UNO	$\prec \leftarrow$	PLUG AND RECEPTACLE OR DRAWOUT DEVICE
	CIRCUIT BREAKER PANELBOARD, REFER TO E8 SERIES DRAWINGS FOR PANELBOARD SCHEDULES		CIRCUIT BREAKER PANELBOARD WITH INTEGRAL BUS CONNECTED SPD, REFER TO E8 SERIES DRAWINGSFOR PANELBOARD	•	COMBINATION MAGNETIC MOTOR		CIRCUIT BREAKER IN SWITCHBOARD, 3P UNO		POWER TRANSFORMER
3AL1		SPD 6AL1	SCHEDULES	VSC	STARTER WITH VARIABLE SPEED CONTROLLER	—	INSULATED CASED POWER CIRCUIT BREAKER WITH L.I.S.G. PROTECTION FEATURES,		
	MAIN DOLIDI E LLIC		MAIN BREAKER IN	'			3P UNO DRAWOUT CIRCUIT BREAKER,	<u>/x</u> /	3 PHASE MOTOR. X INDICATES HORSEPOWER OR KILOWATTS
# #	MAIN DOUBLE LUG CIRCUIT BREAKER PANELBOARD, REFER TO E8 SERIES DRAWINGS FOR PANELBOARD SCHEDULES	RCUIT BREAKER PANELBOARD, FER TO E8 SERIES DRAWINGS WITH CLOSED N	CIRCUIT BREAKER PANELBOARD WITH SPD MOUNTED ADJACENT WITH CLOSED NIPPLE, REFER TO E8 SERIES DRAWINGS	PD MOUNTED ADJACENT	COMBINATION MAGNETIC MOTOR STARTER WITH ELECTRONIC	SP UNO	СР	CONTROL PANEL FURNISHED UNDER DIVISION 25	
4AL1		7AL1	FOR PANELBOARD SCHEDULES	# ED 	OVERLOADS		SHUNT TRIP OPERATED CIRCUIT BREAKER	(G)	GENERATOR

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PENN HIGH SCHOOL FIELDHOUSE

12641 McKinley Highway Mishawaka, IN 46545


PENN-HARRIS-MADISON SCHOOL CORPORATION





WWW.FHAI.COM 317.848.0966 350 E NEW YORK ST #300, INDIANAPOLIS, IN 46204 ALTERNATE

100% Construction Documents

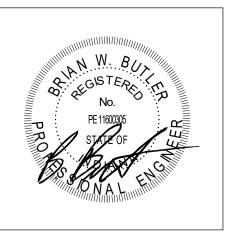

DRAWN BY: ISD PROJECT NUMBER: 222130.00 PROJECT ISSUE DATE: 01.10.2024

NO.	DESCRIPTION	DATE
1	Addendum #1	01.26.2024

LUMINAIRE SCHEDULE AND RISER **DIAGRAM**

TO UTILITY POWER POLE

COPPER FEEDER SCHEDULE

CONDUCTOR SIZE

NEUTRAL

#4

#3/0

#350

GROUND

#14

#14

#12

#12 #10

#10 #10

#10

#10

#8

#8

#8

#8

#6 #6

#6

#6

#6

#6 #6

#4

#4

#4

#3

#3 #3

#3 #3

#2

#2

#1

#1

#1/0

#250

#350

#400

#3/0 4

#4/0 4

#250 4

#400 4

#3

#6 2

#4 2 1/2

#10 1

SIZE

3/4

1 1/2

1 1/2

2 1/2

2 1/2

SOURCE 2014 NEC T310.15(B)(16), COPPER 75C, (THHW, THW, THWN, XHHW)

PHASE

3 # 14

3 # 14

3 # 12

3 # 10 3 # 10

3#8

3#6

3 # 4

3 # 3

3 # 1

3 # 1/0

3 # 1/0 3 # 2/0

3 # 2/0

3 # 3/0 3 # 3/0

3 # 4/0

3 # 250

3 # 250 3 # 350

3 # 350

3 # 500

3 # 500

3 # 600

3 # 600

3 # 250

3 # 250

3 # 350

3 # 600

3 # 600

3 # 600 3 # 600

2000N 5 3 # 600

3000N 7 3 # 600

800N 2 3 # 600 #600 #1/0 4

3300N 8 3 # 600 #600 #400 4
3700 9 3 # 600 #400 4
3700N 9 3 # 600 #600 #400 4

3 # 3

3 # 12

FEEDER

20N

125N

150

175N

350N

Volts: 120/208 Wye Phases: 3 Wires: 4

В

1000... 360 VA

0 VA | 0 VA |

150 A

Demand Factor

104.80%

100.00%

100.00%

65.47%

80.00%

Volts: 120/208 Wye

Phases: 3

Wires: 4

В

1587... 1840...

1 1840... 1840... 1840... 1

0 VA 2000...

16720 VA

Demand Factor

101.01%

100.00%

140 A

16560 VA

138 A

Total Amps:

Connected Load

45494 VA

4000 VA

Legend:

Load Classification

NOTE 1: PROVIDE CIRCUIT UNDER THE ALTERNATE BID.

1840... 1840...

6950 VA

3000 VA

32328 VA

360 VA

A.I.C. Rating: Mains Type: M.C.B Mains Rating: 400 A MCB Rating: 400 A

1 20 A Tub receptacles Rm. A104

1 20 A Fieldhouse floor boxes Rm. A101

20 A Fieldhouse floor boxes Rm. A101

1 20 A Receptacles Rm. B119. Exterior walls

20 A Receptacles Rm. B216 20 A Overhead Door #2 - A101

250 VA 0 VA 1 20 A Monitor receptacles - East Wall D101 (NOTE 1)

1 20 A Water Coolers - D202 (NOTE 1)

20 A Receptacles - Island B117

1 20 A Water cooler receptacles Corr. B101

20 A IDF Rack receptacle Rm. B214

20 A IDF Backboard receptacles Rm. B214

20 A Refrigerator - D205 (NOTE 1)

1 20 A Water cooler receptacles Corr. B101 (NOTE 2)

20 A Receptacles Rms. B202-B206 (NOTE 1)

20 A Receptacles - North Wall D101 (NOTE 1)

20 A Receptacles - East Wall D101 (NOTE 1)

20 A Receptacles - D102-104 & Exterior (NOTE 1)

20 A Receptacles - West Wall D101, PUH-3 Rm. D102... 44

Panel Totals

Total Conn. Load: 62502 VA

Total Est. Demand: 52220 VA

Total Est. Demand: 145 A

A.I.C. Rating:

1 20 A Basketball Backstop #3

1 20 A Basketball Backstop #4

20 A Divider Curtain #4

1 20 A Basketball Backstop #6

20 A Basketball Backstop #8

Panel Totals

Total Conn. Load: 49494 VA

Total Est. Demand: 49954 VA Total Conn.: 137 A

Total Est. Demand: 139 A

1 20 A Basketball Backstop #10

1 20 A Divider Curtain #6

2 20 A EUH-2 Corr. D104 (NOTE 1)

Poles Trip

1840... 1840... 1 20 A Divider Curtain #0

1 20 A TSC1500XL Relay Node #2 Rm. A105

2000...

16214 VA

Estimated Demand

45954 VA

4000 VA

Mains Type: M.C.B

Mains Rating: 200 A

MCB Rating: 200 A

Total Conn.: 173 A

1 20 A Convenience receptacles Corr. B201, Rms...

Poles Trip

 0 VA
 0 VA
 1
 20 A
 Receptacles - East Wall D101 (NOTE 1)

 0 VA
 0 VA
 1
 20 A
 Receptacles - South Wall D101 (NOTE 1)

 0 VA
 0 VA
 1
 20 A
 Receptacles - West Wall D101, PUH-3 Rm.

 0 VA
 0 VA
 1
 20 A
 Receptacles - D102-104 & Exterior (NOTE 2)

| 1212... | 1212... | 345 VA | 750 VA | 1 | 20 A | Temperature Control Pallels | Nill. | 120 E
Estimated Demand

6950 VA

3000 VA

21164 VA

288 VA

 0 VA
 0 VA
 1
 20 A
 Sound Rack - D206 (NOTE 1)

 0 VA
 0 VA
 1
 20 A
 Water Coolers - D202 (NOTE 1)

Circuit Description

20 A Convenience and monitor receptacles Rm. B117 16

1 20 A Microwave and GFCI receptacles Rm. A104

PENN HIGH SCHOOL

> 12641 McKinley Highway Mishawaka, IN 46545

FIELDHOUSE

PENN-HARRIS-MADISON

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ARCHITECT

CKT


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ALTERNATE

100% Construction Documents



DRAWN BY: ISD PROJECT NUMBER: 222130.00 PROJECT ISSUE DATE: 01.10.2024

REV.

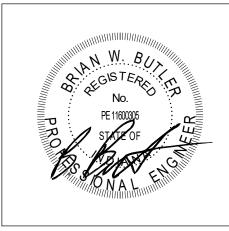	NO. $ riangle$	DESCRIPTION	DATE
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PANELBOARD SCHEDULES

SYMBOL	DESCRIPTION	WIRING DETAIL(S) UNLESS NOTED OTHERWIS
A.C.P.	ACCESS CONTROL PANEL	2/T-502
CR	CARD READER	2/T-502
EL	ELECTRONIC LATCH SET WITH ELECTRONIC POWER TRANSFER	2/T-502
	AUTOMATIC DOOR PUSHBUTTON	-
J	ABOVE CEILING WALL MOUNTED DOOR ACCESS CONTROLLER JUNCTION BOX. WHEN INDICATED WITH C-x, x = THE QUANTITY OF COMMUNICATIONS COPPER HORIZONTAL CABLING, IN ADDITION TO OTHER CABLES NOTED.	2/T-502
•	PUSH TO RELEASE BUTTON	-
ADO	AUTOMATIC DOOR OPERATOR	2/T-502
LD	LOCKDOWN BUTTON	-
AI	AIPHONE DOOR INTERCOM/CAMERA	-
MI	AIPHONE MAIN INTERCOM/CAMERA CONSOLE DESKPHONE	-

SYMBOL	DESCRIPTION	WIRING DETAIL(S) UNLESS NOTED OTHERWISE
	ANTENNA	-
S	CLASSROOM SOUND REINFORCEMENT SPEAKER - CEILING MOUNTED	3/T-502
S	GYMNASIUM SOUND REINFORCEMENT SPEAKER - CEILING MOUNTED	-
S	MULTI-PURPOSE ROOM SOUND SPEAKER - CEILING MOUNTED	-
S	CLASSROOM SOUND REINFORCEMENT SPEAKER - WALL MOUNTED	-
(IC)	WALL MOUNTED SPEAKER	-
S	WALL-MOUNTED-SPEAKER-OUTLET	-
S	CEILING MOUNTED PA SPEAKER	1/T-503
S A	LINE ARRAY COLUMN SPEAKERS - WALL MOUNTED	-
	FULL RANGE CEILING SPEAKER	-
(IC)	CEILING MOUNTED INTERCOM SPEAKER	-
M	WALL MICROPHONE INPUT	-
M	CEILING MICROPHONE	-
A	AUX. INPUT	-
S _M	MONITOR OUTPUT	-
	RECESSED JUNCTION BOX FOR SOUND SYSTEM	-
SÜB	SUBWOOFER	-
MA	WALL MOUNTED MICROPHONE/AUXILIARY INPUT	1/T-503

EILING MOUNTED VIDEO SURVEILLANCE CAMERA. WHEN INDICATED WITH C-x, x THE QUANTITY OF COMMUNICATIONS COPPER HORIZONTAL CABLING, IN DITION TO OTHER CABLES NOTED.	1/T-502			
ALL MOUNTED VIDEO SURVEILLANCE CAMERA WHEN INDICATED WITH C-x-x - THE				
WALL MOUNTED VIDEO SURVEILLANCE CAMERA. WHEN INDICATED WITH C-x, x = THE QUANTITY OF COMMUNICATIONS COPPER HORIZONTAL CABLING, IN ADDITION TO OTHER CABLES NOTED.				
EXTERIOR VIDEO SURVEILLANCE CAMERA SYMBOLS LEGEND				
DESCRIPTION	WIRING DETAIL(S) UNLESS NOTED OTHERWISE			
LL MOUNTED WEATHERPROOF VIDEO SURVEILLANCE CAMERA. WHEN ICATED WITH C-x, x = THE QUANTITY OF COMMUNICATIONS COPPER	1/T-502			
L	EXTERIOR VIDEO SURVEILLANCE CAMERA SYMBOLS DESCRIPTION L MOUNTED WEATHERPROOF VIDEO SURVEILLANCE CAMERA. WHEN			

	TELECOMMUNICATIONS 6A CABLE COLOR LEGEND					
SYSTEM	TERMINATION (RJ45) PANDUIT	CABLE GENERAL	PATCH CABLE (PATCH PANEL)	PATCH CABLE (STATION)		
DATA	WHITE	BLUE	BLUE	BLACK		
WIRELESS	BLUE	BLUE	WHITE	WHITE		
CAMERA	BLUE	BLUE	BLACK	BLACK		
ACCESS	YELLOW	YELLOW	YELLOW	YELLOW		
HVAC	RED	RED	RED	RED		

		CONTRACTOR FURNISH	CONTRACTOR INSTALL	OWNER FURNISH	OWNER INSTALL
	ACCESS CARD READERS, DOOR CONTACTS	NO	NO	YES	YES
	ACCESS, SECURITY CABLING & ROUGH INS	YES	YES	NO	NO
	AV PROJECTOR AND MOUNTS	YES	YES	NO	NO
/	AV PROJECTOR MISC. CABLING (IN WALL)	YES	YÉS	NO_/	NO
	AV MONITOR PATCH CABLES	YES	YES	NÓ	NO
	WIRELESS CLOCKS	NO	NO	YES	YES
	FIBER BACKBONE	YES	YES	NO	NO
	FIBER TERM AND TEST	YES	YES	NO	NO
	FIBER ENCLOSER WITH LC COUPLER PANEL	YES	YES	NO	NO
	NETWORK EQUIPMENT	NO	NO	YES	YES
	NETWORK SFP	NO	NO	YES	YES
	IDF RACKS	YES	YES	NO	NO
	SOUND REINFORCEMENT	YES	YES	NO	ŅO
_	SURVEILLANCE CAMERAS	NO	NO	YES	YES
	SURVEILLANCE CAMERAS CAT6A CABLING	YES	YES	NO	NO
	WIRELESS ACCESS POINTS	NO	YES	YES	NO
	WIRELESS ACCESS POINTS CAT6A CABLING	YES	YES	NO	NO
			·	·	

TECHNOLOGY GENERAL NOTES

A THE COMMUNICATIONS CABLING CONTRACTOR(S) IS/ARE RESPONSIBLE FOR ANY ADDITIONAL CONDUIT SLEEVES. OUTLET/JUNCTION BOXES, SURFACE RACEWAY, CABLE TRAY, DOUBLE GANG SQUARE PLASTER MUD RINGS, ETC. NOT SHOWN ON THE E3 ROUGH IN DRAWINGS.

B THE COMMUNICATIONS CABLING CONTRACTOR(S) IS/ARE RESPONSIBLE FOR COORDINATING WITH ELECTRICAL CONTRACTOR IN EXTENDING THE ELECTRICAL SERVICE FROM THE ELECTRICAL JUNCTION BOX IN THE SPACE TO ALL THE COMMUNICATIONS RACKS/CABINETS.

THE CONTRACTOR(S) SHALL BE RESPONSIBLE FOR REPLACING/REPAIRING DAMAGED CEILING GRID/TILE AS A RESULT OF THEIR INSTALLATION.

D THE CONTRACTOR SHALL VERIFY THE SURFACE RACEWAY LOCATIONS, ROUTING, OPENINGS, ETC. WITH THE BUILDING ELECTRICAL CONTRACTOR. PROVIDE PROPER COVER PLATES FOR THE DEVICES AS REQUIRED.

E THE COMMUNICATIONS CABLING CONTRACTOR SHALL COORDINATE THE EXACT LOCATION OF THE MONITORS AND VIDEO PROJECTOR WITH THE WHITEBOARD INSTALLATION CONTRACTOR AND ELECTRICAL CONTRACTOR TO INSURE A FULL AND CLEAR PROJECTION IMAGE.

TECHNOLOGY ABBREVIATIONS

ABBREVIATIONS USED ON DRAWINGS IN GENERAL ARE LISTED BELOW.

ABOVE FINISH FLOOR ABOVE FINISH GRADE AFG BLANK

CONDUIT CABLE ANTENNA TELEVISION CATV

JUNCTION BOX MAIN CROSS-CONNECT/EQUIPMENT ROOM / MAIN DISTRIBUTION FRAME INDICATES MOUNTING HEIGHT (N) TO BOTTOM OF DEVICE

FROM FINISH FLOOR UNLESS NOTED OTHERWISE NOT IN CONTRACT NOT TO SCALE NTS

TEMPERATURE CONTROL PANEL TCP TELECOMMUNICATIONS ROOM / INTERMEDIATE TR / IDF DISTRIBUTION FRAME

TELEPHONE TERMINATION BOARD **TELEVISION**

UNLESS NOTED OTHERWISE VERIFY IN FIELD VOLUME CONTROL WALL MOUNTED

VIDEO INPUT LOCATION **DEMO TABLE** WIRE GUARD

RELEASE DUAL FACE WEATHER PROOF VIDEO OUTPUT PAN TILT ZOOM

> EXISTING TO REMAIN VIDEO PROJECTOR SURFACE MOUNTED

SCHOOL **FIELDHOUSE**

PENN HIGH

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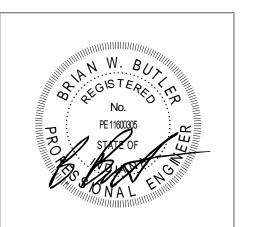
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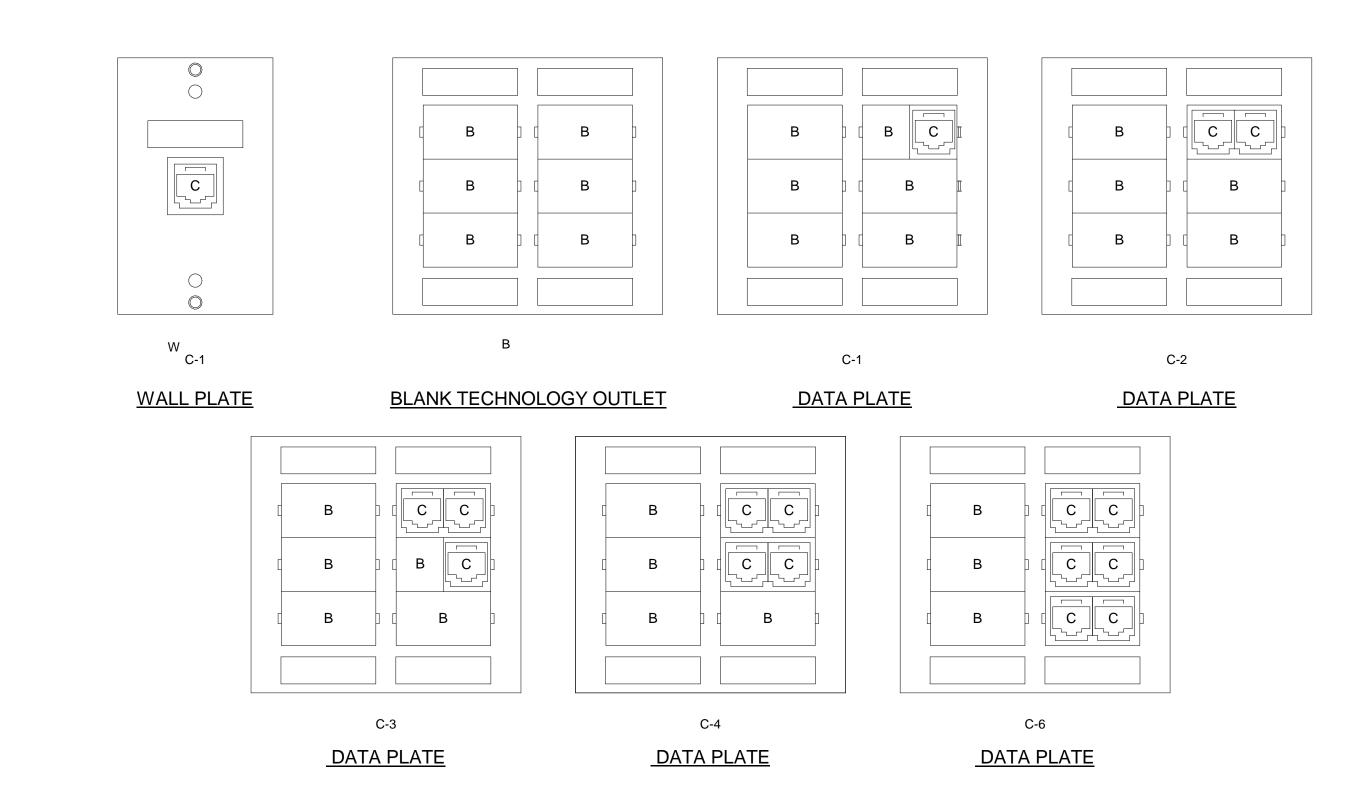


PROJECT MANAGER: MKS DRAWN BY: CDT PROJECT NUMBER: 222130.00 PROJECT ISSUE DATE: 1.13.2024

NO. DESCRIPTION DATE 1.26.2024

> **TECHNOLOGY SYMBOLS & ABBREVIATIONS**

> > T-001



NOTE: REFER TO AV WIRING DETAILS FOR EXACT CONFIGURATIONS OF VIDEO

INPUT (V.I.), VIDEO OUTPUT (VO), AND AV CABINET LOCATIONS..

WALL PLATE CONFIGURATIONS

NO SCALE

TECHNOLOGY FACEPLATE ABBREVIATIONS

C - RJ45 DATA JACK **B - BLANK INSERT**

3.5mm - 3.5mm JACK

HDMI - HDMI CONNECTOR

WB - RJ-45 JACK FOR USB INTERACTIVITY HD - RJ45 JACK FOR VIDEO

NOTE: SLEEVES SHALL NOT

BOND BEAMS OR LINTELS.

PENETRATE IN ANY CONCRETE

SECURE LOOP FROM INDEPENDENT

MAKE THE PLACEMENT KNOWN WITH

IDENTIFICATION FROM THE FLOOR

A CEILING GRID STICKER FOR

QUANTITY, COLOR AND TYPE OF CABLES DIFFER

2" CONDUIT SLEEVE FOR SOUND SYSTEM CABLING,

BUILDING AUTOMATION SYSTEMS (BAS)

CONTROL CABLING, INTRUSION DETECTION CABLING, &

CEILING WIRE 6" TO 12" ABOVE

FOR EACH TYPE OF BOX REFER TO DRAWINGS

CEILING TILE

CONDUIT SLEEVES DETAIL

2 PORT PLENUM SURFACE MOUNT BOX

TO TECH ROOMS

NO SCALE

- 4PR. UTP CABLE

15' PLENUM

PATCH CORD

RATED

20' CABLE COIL

TO TECHNOLOGY DEVICE

TYPICAL ABOVE CEILING JUNCTION BOX - WIRING DETAIL

CABLING

24" MAX.

(4 PAIR UTP) 12" MIN.

2" CONDUIT SLEEVE FOR


- CEILING


NOTE:
CONDUIT SLEEVES SHOWN ON E3
DRAWINGS WILL BE PROVIDED BY
DIVISION 26 CONTRACTOR.

FLOOR

NO SCALE

COMMUNICATION

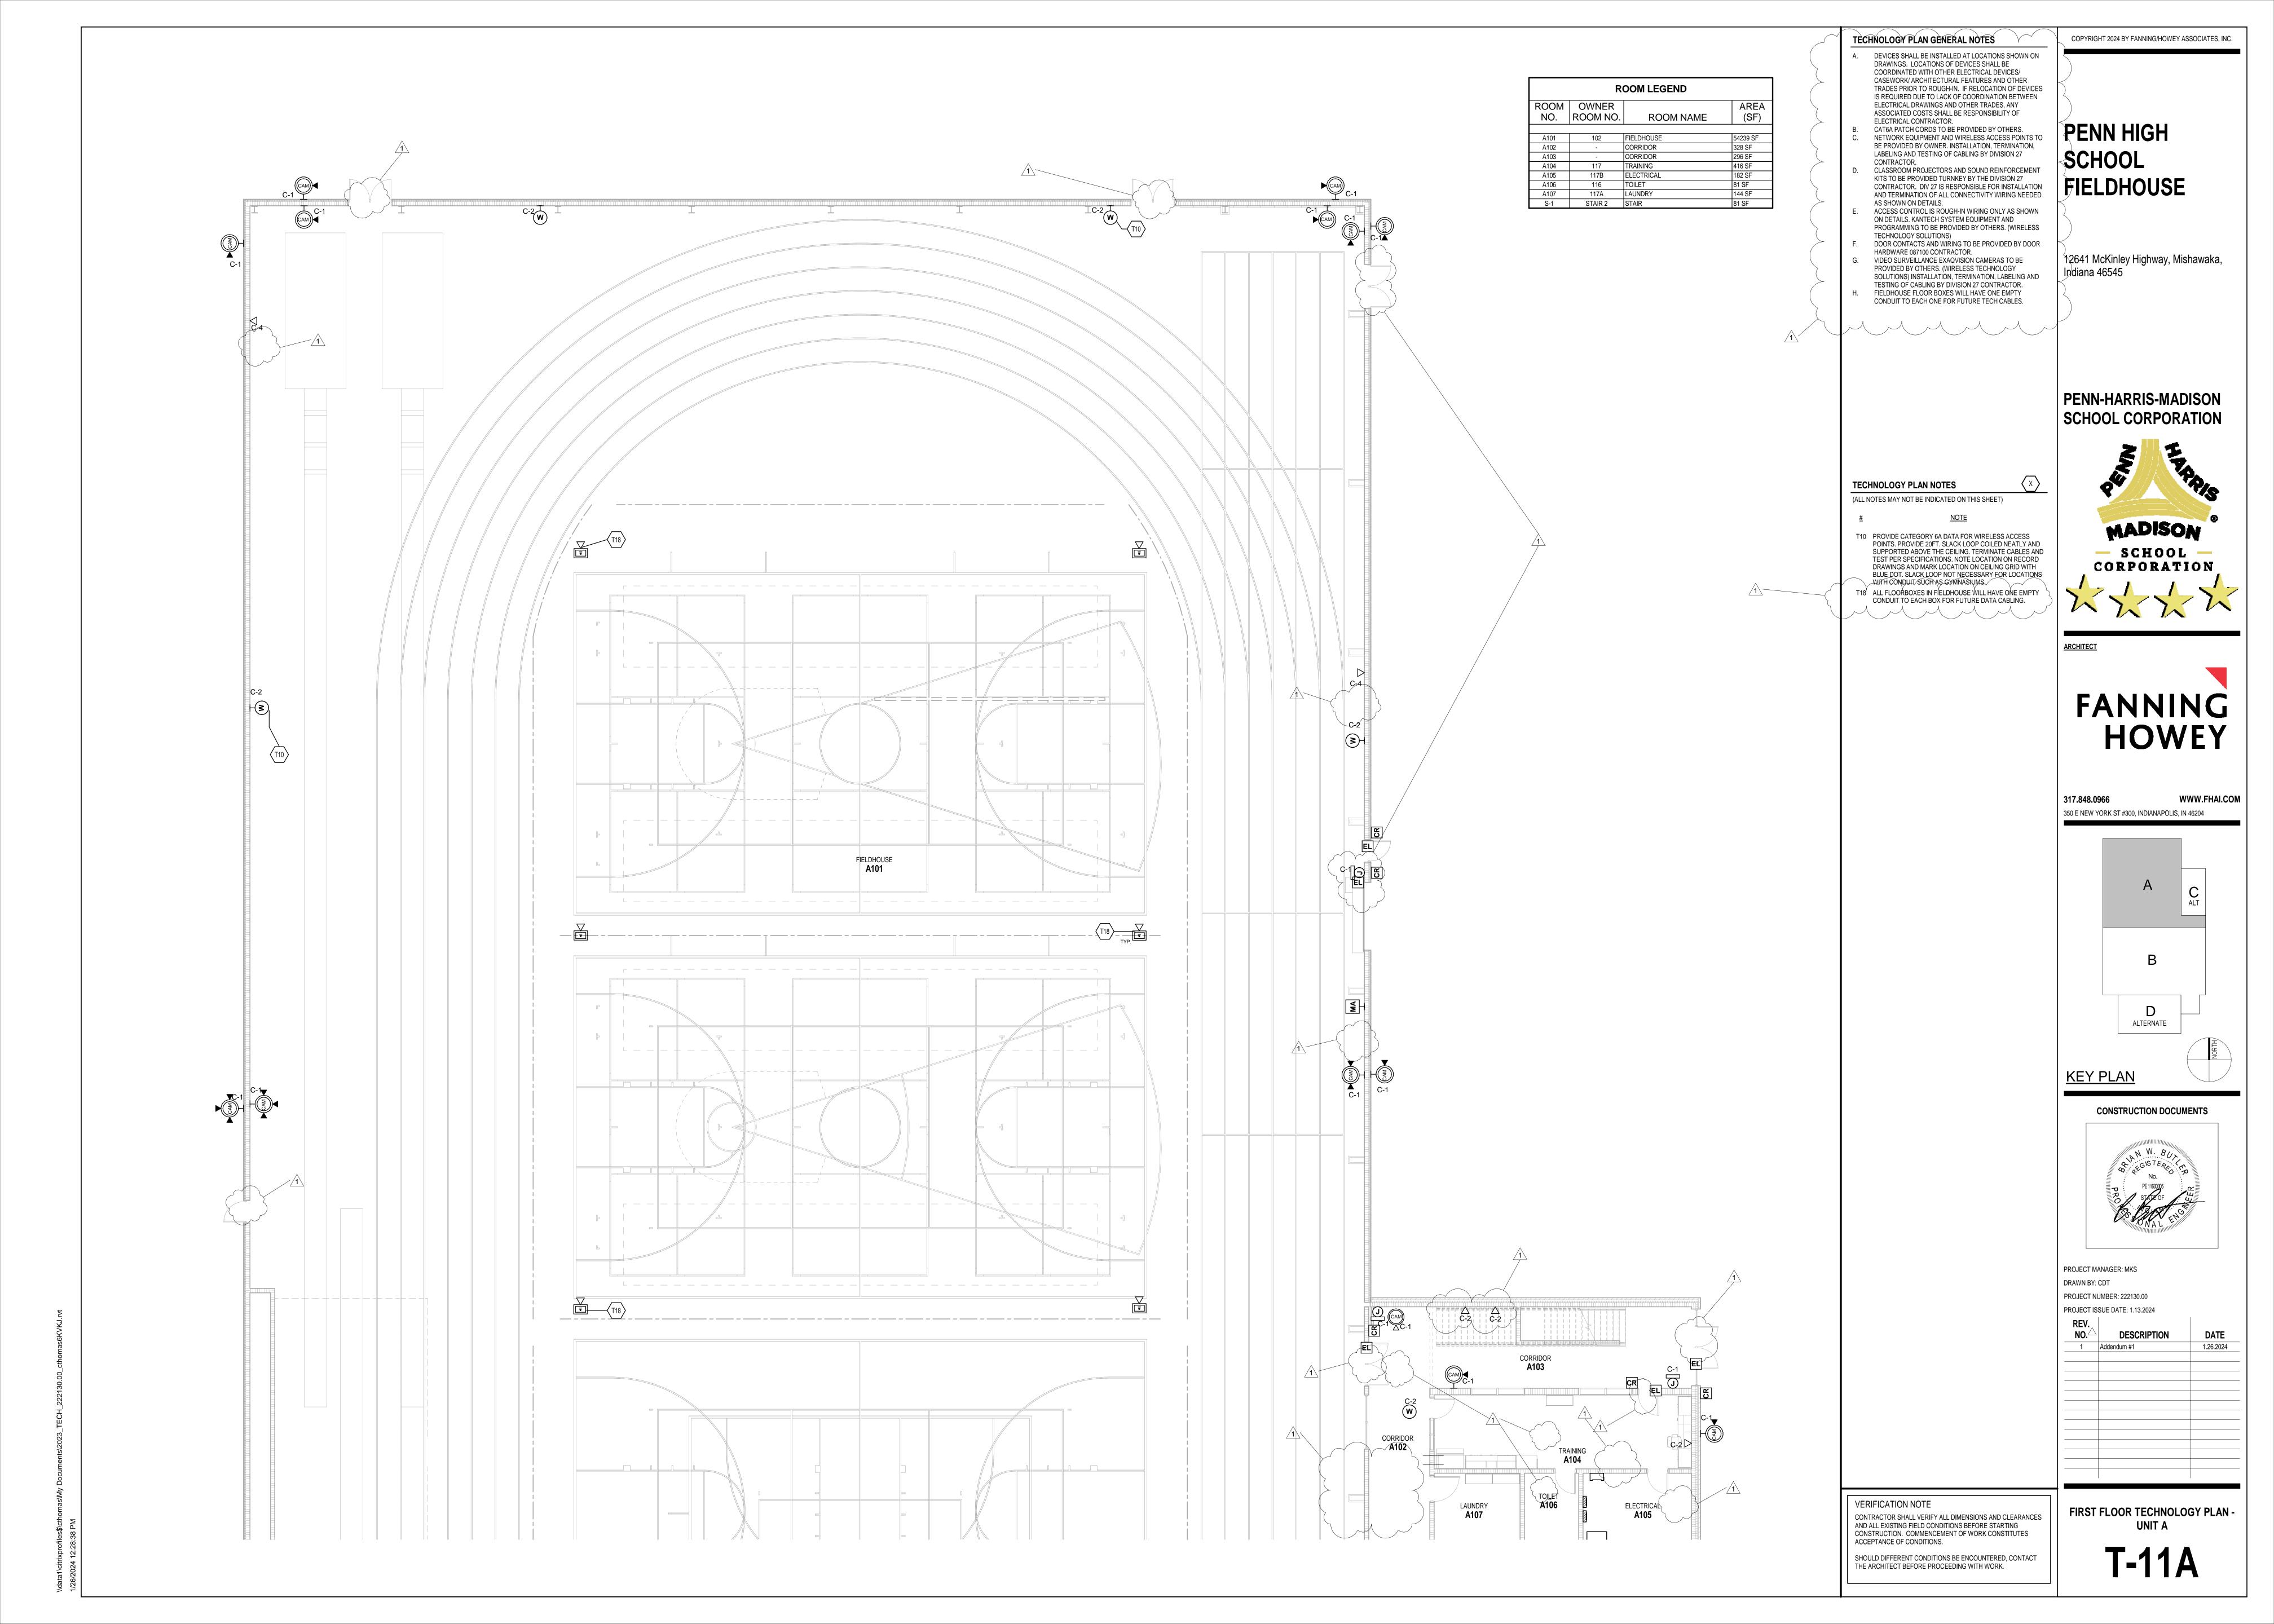

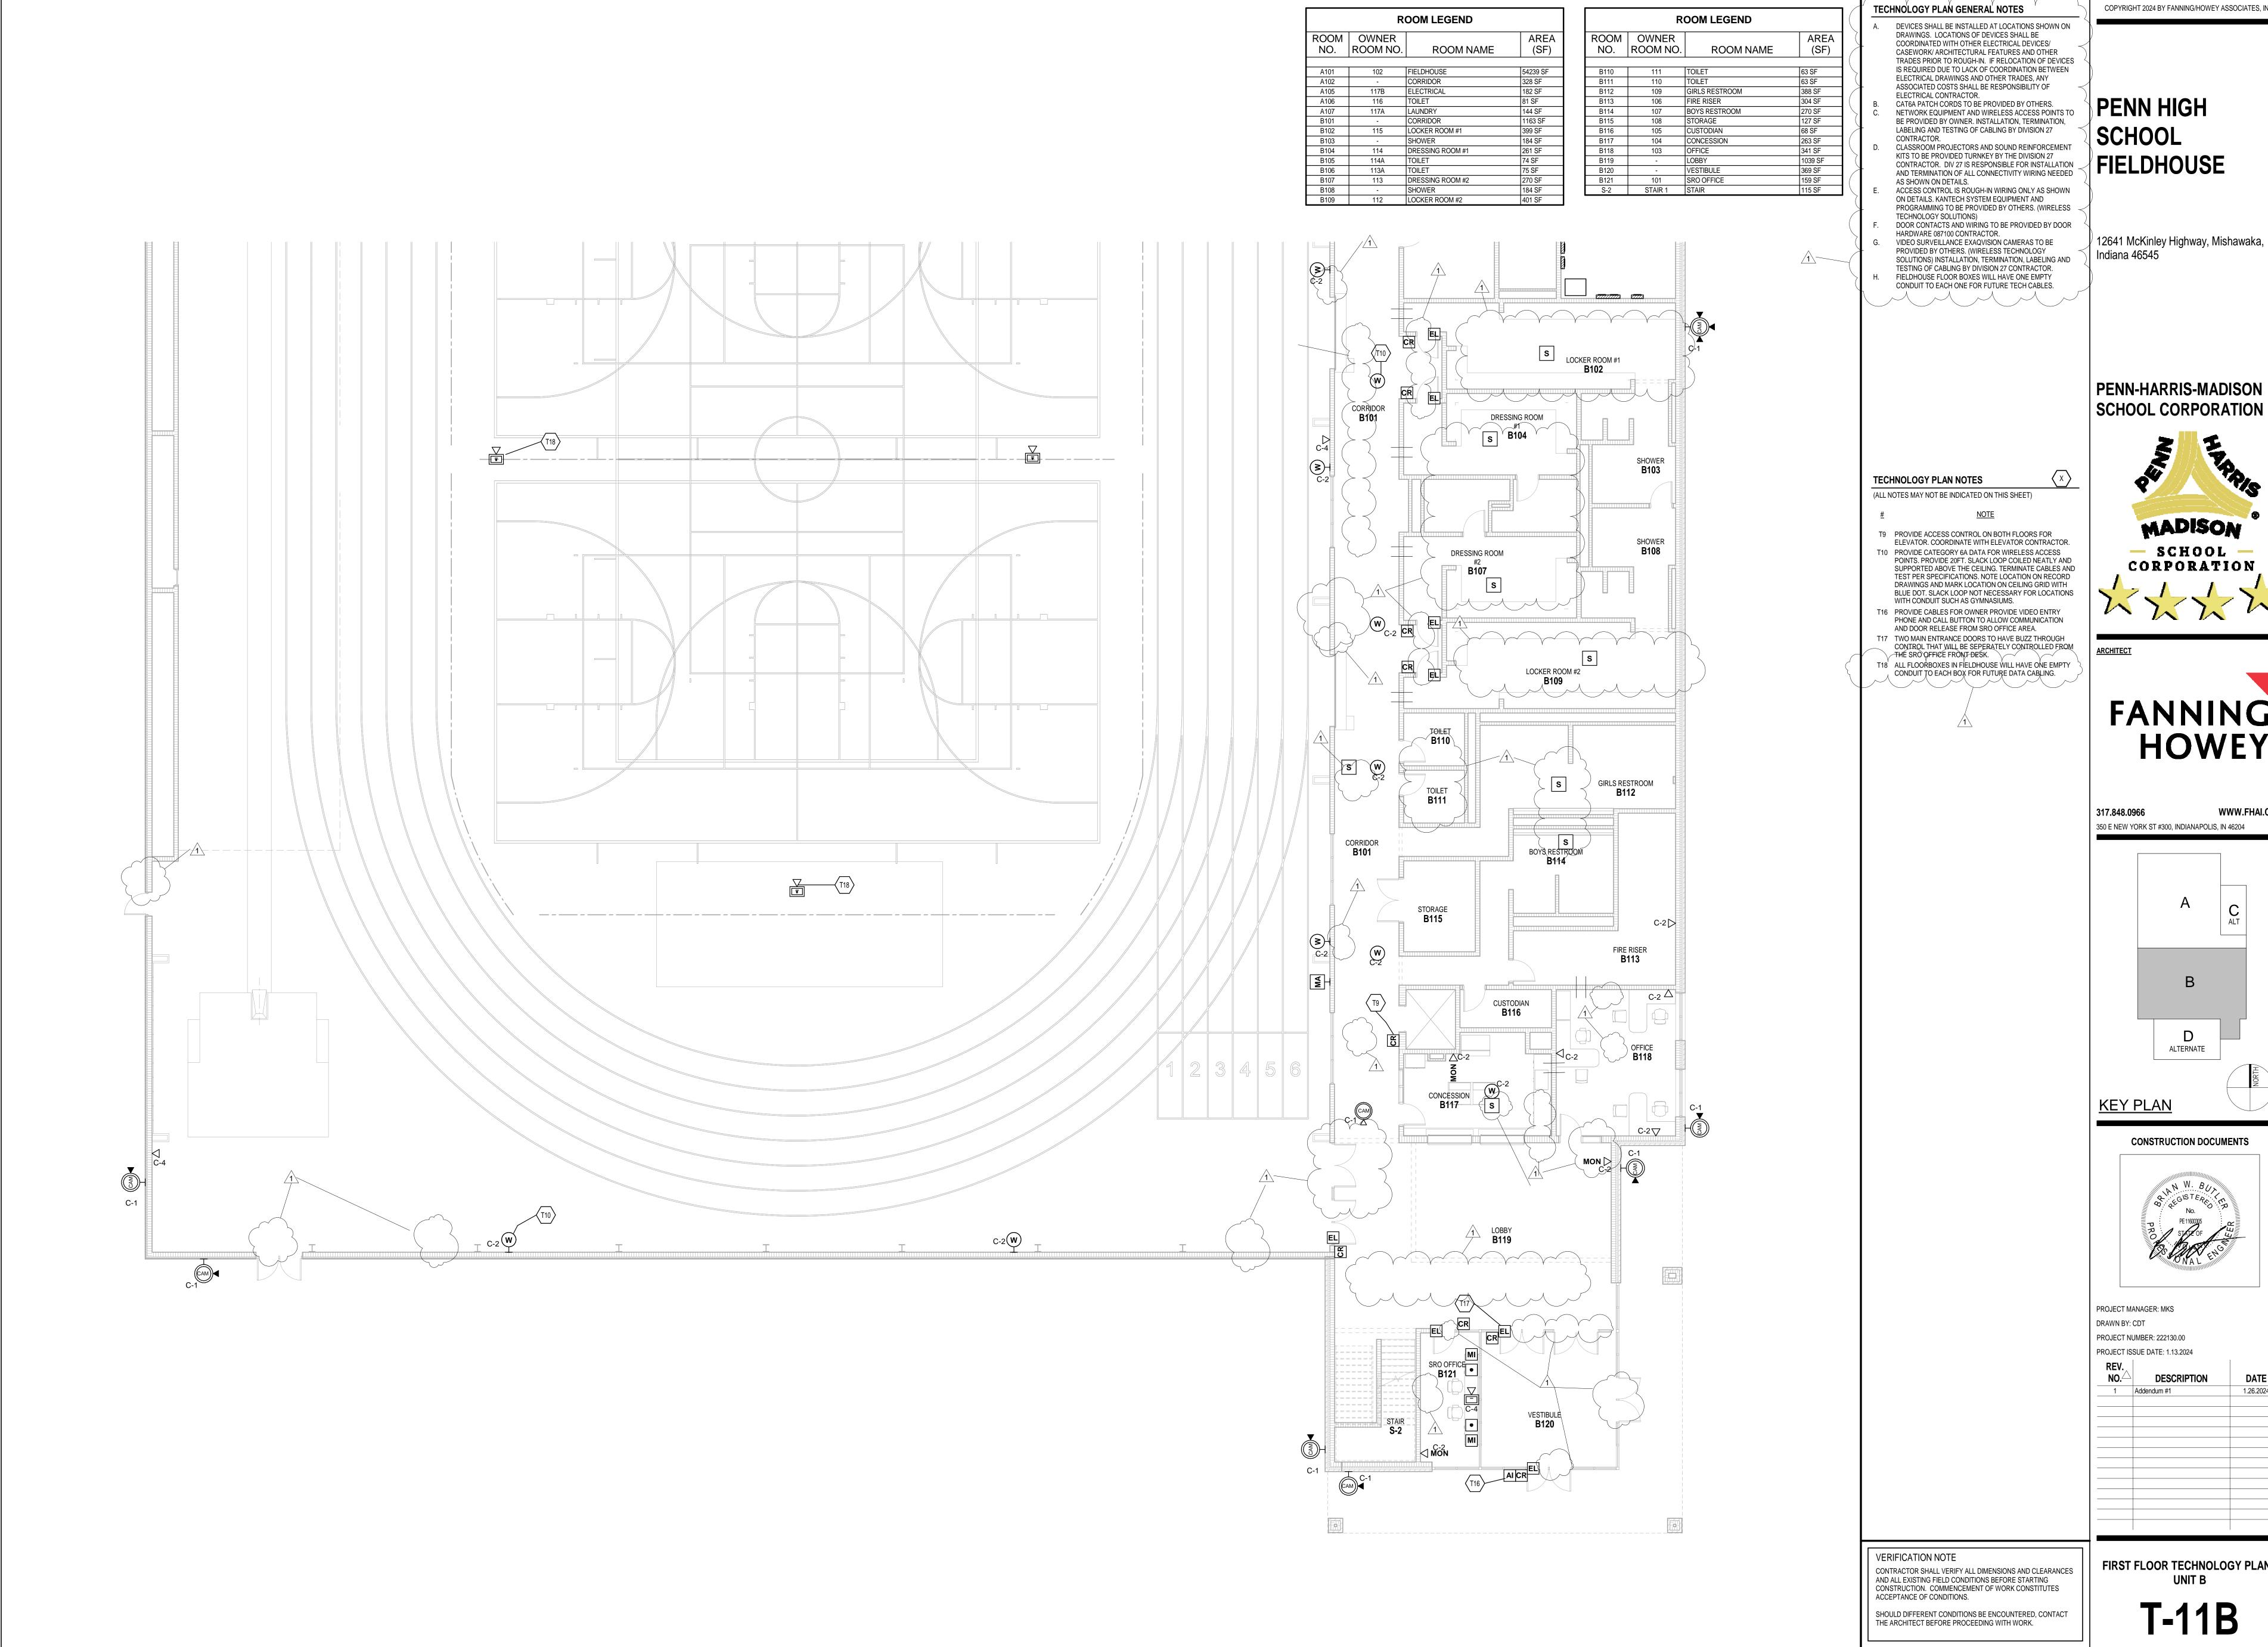

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PENN HIGH **FIELDHOUSE**

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CONSTRUCTION DOCUMENTS



REV. NO.	DESCRIPTION	DATE
1	Addendum #1	1.26.2024

FIRST FLOOR TECHNOLOGY PLAN **UNIT B**

ROOM LEGEND ROOM OWNER NO. ROOM NO. AREA (SF) **ROOM NAME** 296 SF 416 SF 1039 SF 81 SF 115 SF
 S-1
 STAIR 2
 STAIR

 S-2
 STAIR 1
 STAIR


ROOM LEGEND ROOM OWNER NO. ROOM NO.

TECHNOLOGY PLAN GENERAL NOTES AREA **ROOM NAME** (SF) TRADES PRIOR TO ROUGH-IN. IF RELOCATION OF DEVICES IS REQUIRED DUE TO LACK OF COORDINATION BETWEEN ELECTRICAL DRAWINGS AND OTHER TRADES, ANY ASSOCIATED COSTS SHALL BE RESPONSIBILITY OF ELECTRICAL CONTRACTOR.

FIELDHOUSE **A101** MA WC-2 VESTIBULE **D104** STAIR S-3 **S-2** MECHANICAL **D103** WRESTLING **D101** STORAGE **D102** C-2

FIRST FLOOR TECHNOLOGY PLAN - UNIT D ALTERNATE

SCALE: 1/8" = 1'-0"

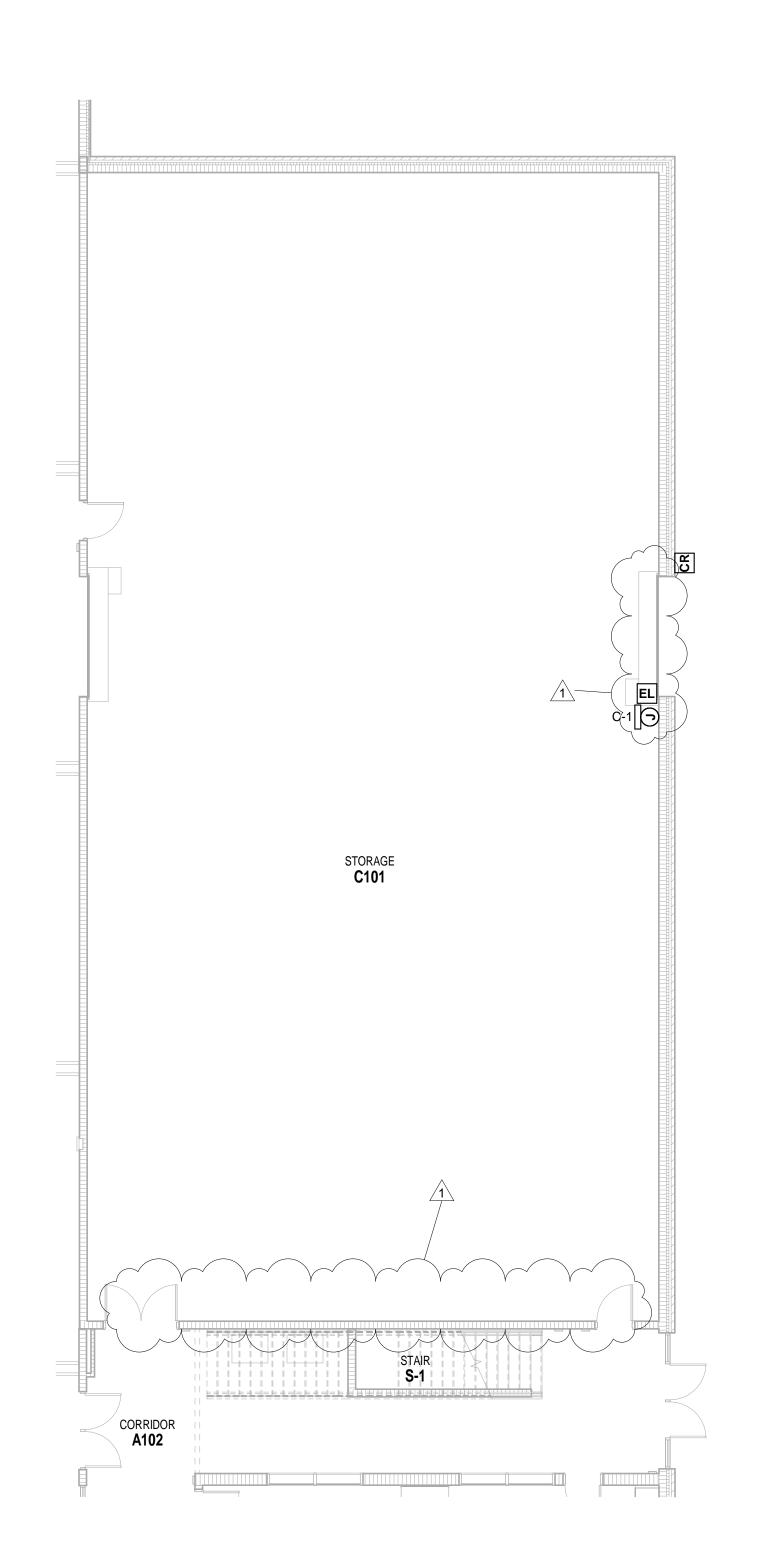

FIRST FLOOR TECHNOLOGY PLAN - UNIT C ALTERNATE

SCALE: 1/8" = 1'-0"

DEVICES SHALL BE INSTALLED AT LOCATIONS SHOWN ON DRAWINGS. LOCATIONS OF DEVICES SHALL BE COORDINATED WITH OTHER ELECTRICAL DEVICES/ CASEWORK/ ARCHITECTURAL FEATURES AND OTHER

LABELING AND TESTING OF CABLING BY DIVISION 27

KITS TO BE PROVIDED TURNKEY BY THE DIVISION 27

ACCESS CONTROL IS ROUGH-IN WIRING ONLY AS SHOWN ON DETAILS. KANTECH SYSTEM EQUIPMENT AND PROGRAMMING TO BE PROVIDED BY OTHERS. (WIRELESS

VIDEO SURVEILLANCE EXAQVISION CAMERAS TO BE PROVIDED BY OTHERS. (WIRELESS TECHNOLOGY

TESTING OF CABLING BY DIVISION 27 CONTRACTOR. FIELDHOUSE FLOOR BOXES WILL HAVE ONE EMPTY CONDUIT TO EACH ONE FOR FUTURE TECH CABLES.

CONTRACTOR.

AS SHOWN ON DETAILS.

TECHNOLOGY SOLUTIONS)

HARDWARE 087100 CONTRACTOR.

CAT6A PATCH CORDS TO BE PROVIDED BY OTHERS. NETWORK EQUIPMENT AND WIRELESS ACCESS POINTS TO BE PROVIDED BY OWNER. INSTALLATION, TERMINATION, SCHOOL CLASSROOM PROJECTORS AND SOUND REINFORCEMENT FIELDHOUSE CONTRACTOR. DIV 27 IS RESPONSIBLE FOR INSTALLATION AND TERMINATION OF ALL CONNECTIVITY WIRING NEEDED

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DOOR CONTACTS AND WIRING TO BE PROVIDED BY DOOR 12641 McKinley Highway, Mishawaka, SOLUTIONS) INSTALLATION, TERMINATION, LABELING AND

PENN-HARRIS-MADISON

TECHNOLOGY PLAN NOTES (ALL NOTES MAY NOT BE INDICATED ON THIS SHEET)

<u>NOTE</u>

T7 SEE DETAIL 2/T-503 FOR WRESTLING AND DANCE ROOM T19 COORDINATE WITH ELECTRICAL AND GENERAL CONTRACTOR ON SCOREBOARD CABLE TERMINATIONS.


SCHOOL CORPORATION





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CONSTRUCTION DOCUMENTS

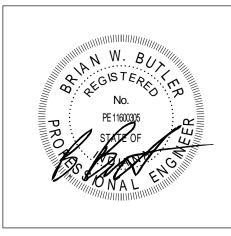

PROJECT MANAGER: MKS DRAWN BY: CDT PROJECT NUMBER: 222130.00 PROJECT ISSUE DATE: 1.13.2024


REV. NO. $ riangle$	DESCRIPTION	DATE
1	Addendum #1	1.26.2024

VERIFICATION NOTE

CONTRACTOR SHALL VERIFY ALL DIMENSIONS AND CLEARANCES AND ALL EXISTING FIELD CONDITIONS BEFORE STARTING CONSTRUCTION. COMMENCEMENT OF WORK CONSTITUTES ACCEPTANCE OF CONDITIONS.

SHOULD DIFFERENT CONDITIONS BE ENCOUNTERED, CONTACT THE ARCHITECT BEFORE PROCEEDING WITH WORK.

FIRST FLOOR TECHNOLOGY PLAN -**UNIT C & D ALT**

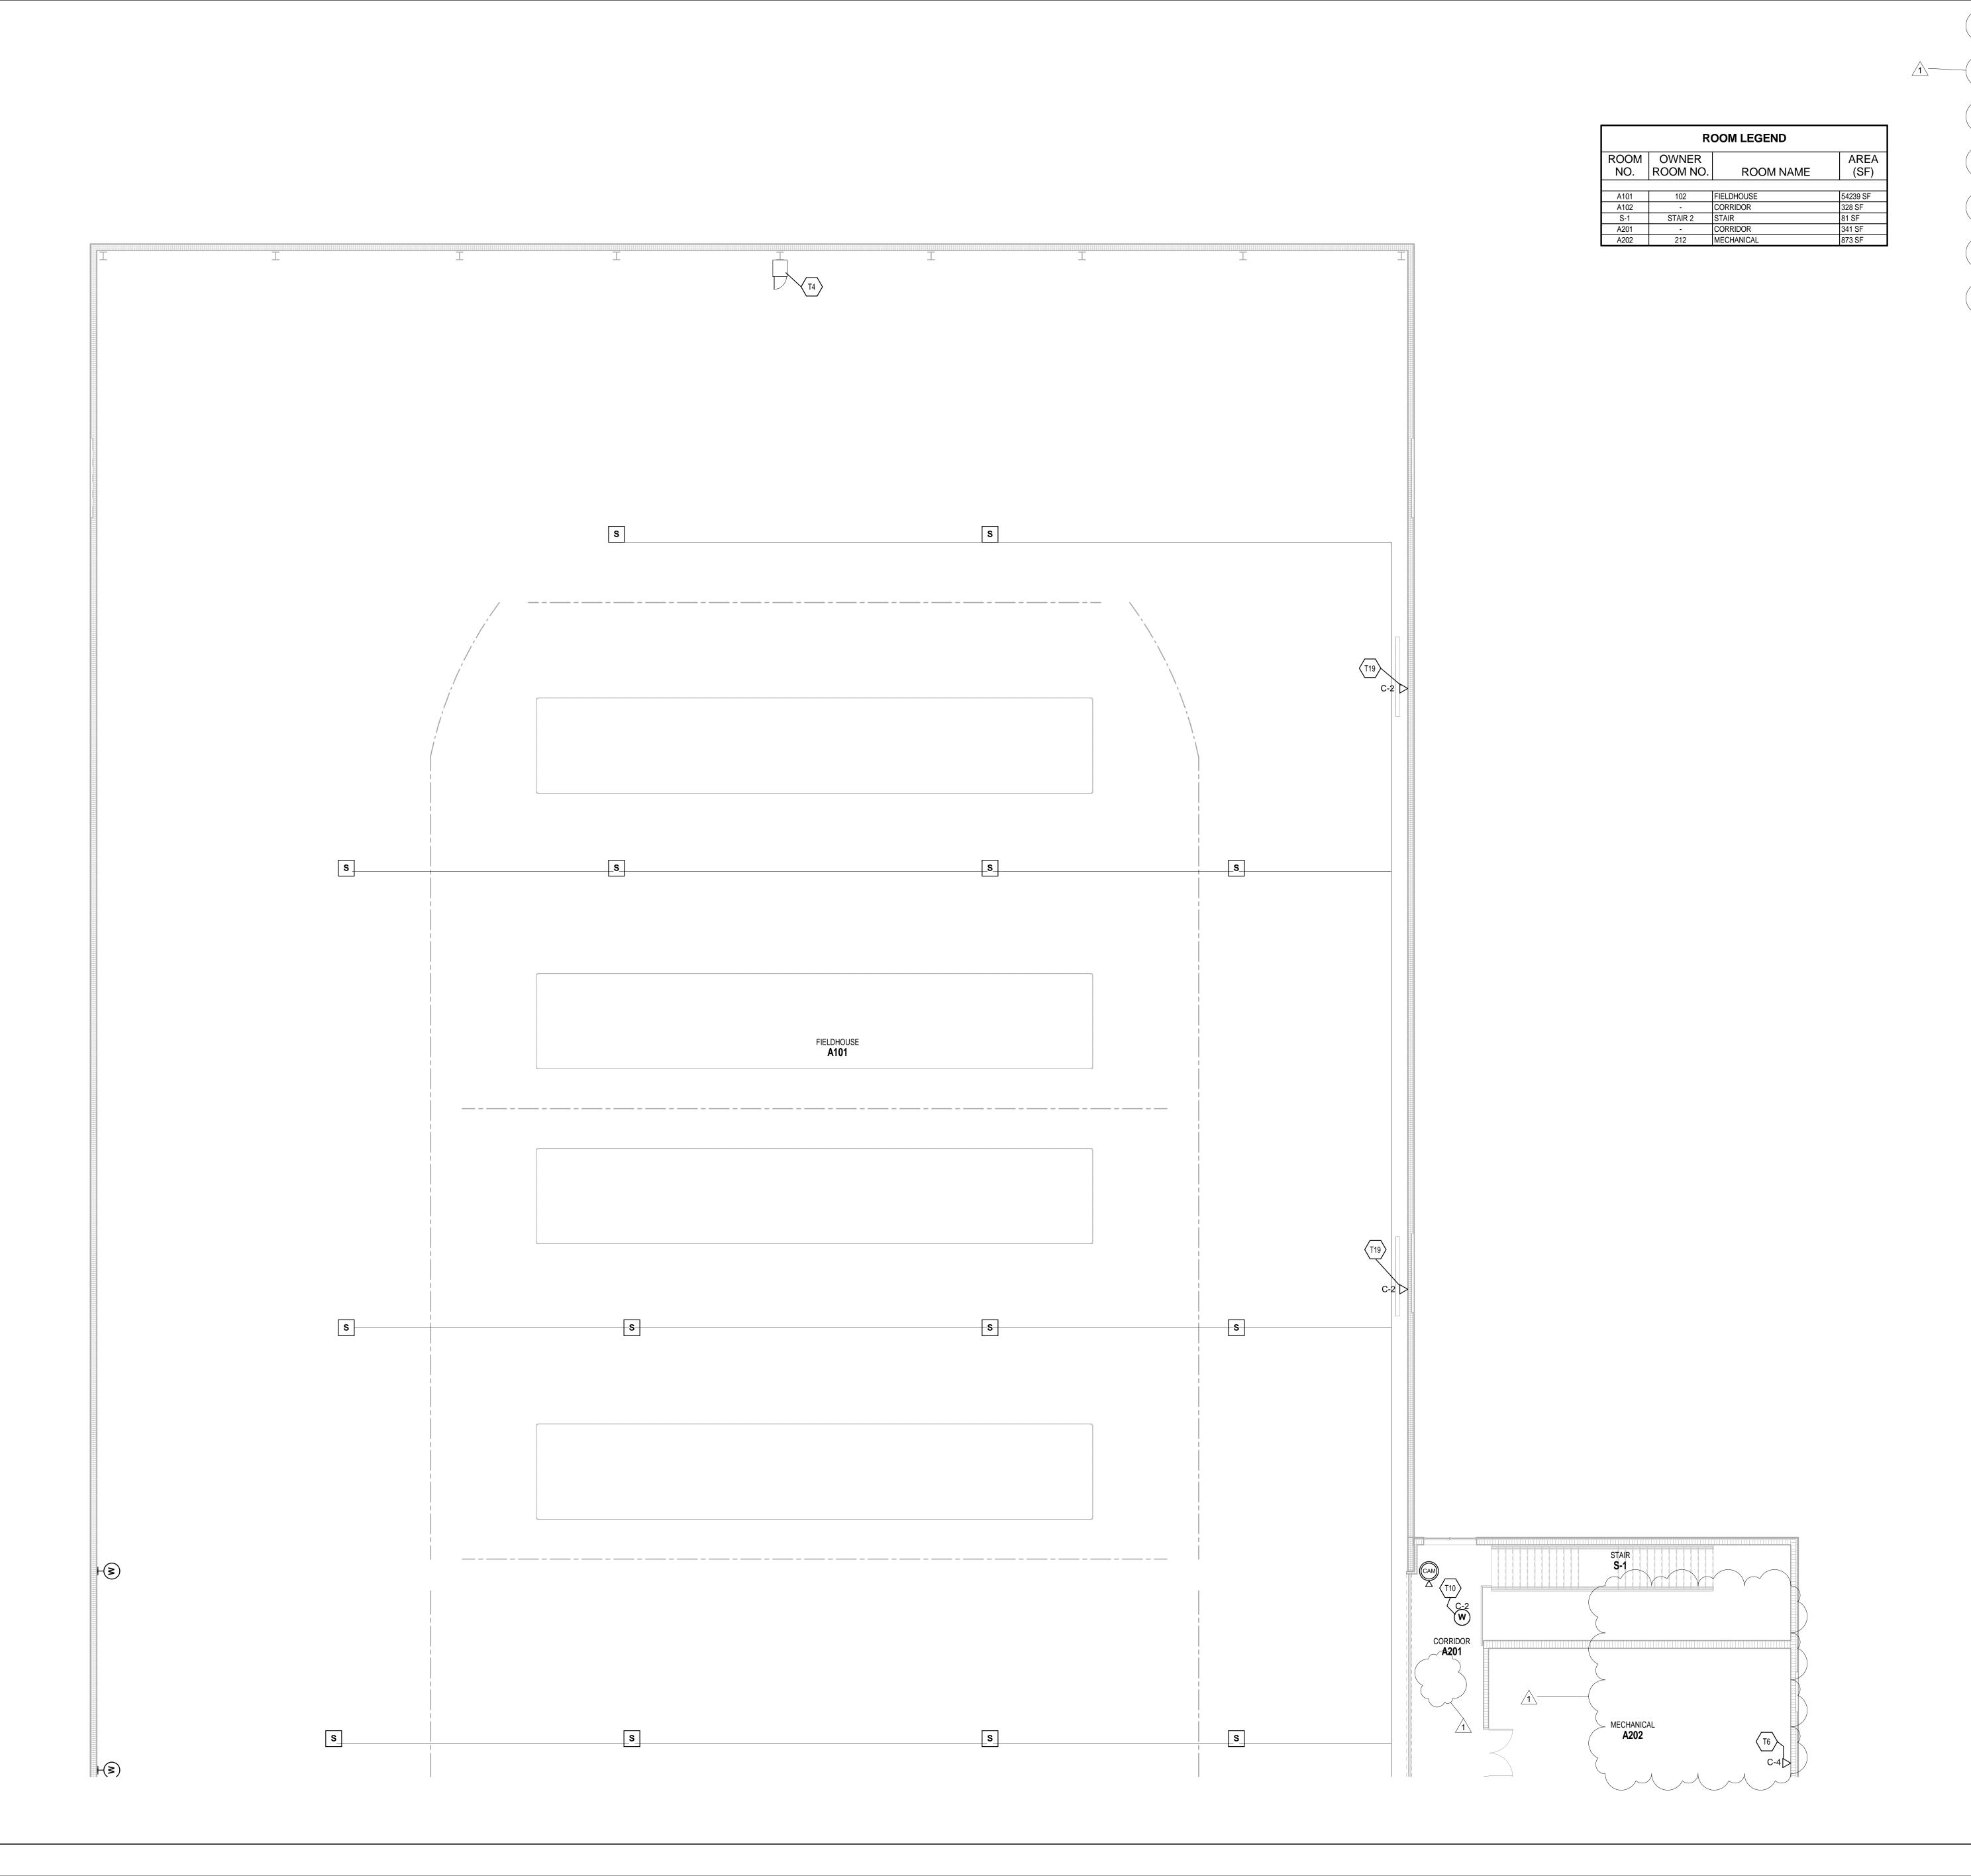

TECHNOLOGY PLAN GENERAL NOTES

A. DEVICES SHALL BE INSTALLED AT LOCATIONS SHOWN ON DRAWINGS. LOCATIONS OF DEVICES SHALL BE COORDINATED WITH OTHER ELECTRICAL DEVICES/ CASEWORK/ ARCHITECTURAL FEATURES AND OTHER TRADES PRIOR TO ROUGH-IN. IF RELOCATION OF DEVICES IS REQUIRED DUE TO LACK OF COORDINATION BETWEEN ELECTRICAL DRAWINGS AND OTHER TRADES, ANY ASSOCIATED COSTS SHALL BE RESPONSIBILITY OF ELECTRICAL CONTRACTOR.

B. CAT6A PATCH CORDS TO BE PROVIDED BY OTHERS.
C. NETWORK EQUIPMENT AND WIRELESS ACCESS POINTS TO BE PROVIDED BY OWNER. INSTALLATION, TERMINATION, LABELING AND TESTING OF CABLING BY DIVISION 27 CONTRACTOR.
C. CLASSROOM PROJECTORS AND SOUND REINFORCEMENT KITS TO BE PROVIDED TURNKEY BY THE DIVISION 27 CONTRACTOR. DIV 27 IS RESPONSIBLE FOR INSTALLATION

AS SHOWN ON DETAILS.

ACCESS CONTROL IS ROUGH-IN WIRING ONLY AS SHOWN ON DETAILS. KANTECH SYSTEM EQUIPMENT AND PROGRAMMING TO BE PROVIDED BY OTHERS. (WIRELESS TECHNOLOGY SOLUTIONS)

DOOR CONTACTS AND WIRING TO BE PROVIDED BY DOOR HARDWARE 087100 CONTRACTOR.

VIDEO SURVEIL ANCE EXACVISION CAMERAS TO BE

AND TERMINATION OF ALL CONNECTIVITY WIRING NEEDED

G. VIDEO SURVEILLANCE EXAQVISION CAMERAS TO BE PROVIDED BY OTHERS. (WIRELESS TECHNOLOGY SOLUTIONS) INSTALLATION, TERMINATION, LABELING AND TESTING OF CABLING BY DIVISION 27 CONTRACTOR.

H. FIELDHOUSE FLOOR BOXES WILL HAVE ONE EMPTY CONDUIT TO EACH ONE FOR FUTURE TECH CABLES.

TECHNOLOGY PLAN NOTES

(ALL NOTES MAY NOT BE INDICATED ON THIS SHEET)

WITH CONDUIT SUCH AS GYMNASIUMS.

T19 COORDINATE WITH ELECTRICAL AND GENERAL

<u>NOTE</u>

T4 LOCATION OF TR EQUIPMENT CABINET(S), SWITCHES AND

UPS ETC. REFERENCE TO DETAIL 2/T-503 FOR MORE INFORMATION.

T6 PROVIDE CABLES FOR TEMP. CONTROL PANELS. VERIFY

EXACT LOCATION WITH TEMP. CONTROL CONTRACTOR.

T10 PROVIDE CATEGORY 6A DATA FOR WIRELESS ACCESS
POINTS. PROVIDE 20FT. SLACK LOOP COILED NEATLY AND
SUPPORTED ABOVE THE CEILING. TERMINATE CABLES AND
TEST PER SPECIFICATIONS. NOTE LOCATION ON RECORD
DRAWINGS AND MARK LOCATION ON CEILING GRID WITH
BLUE DOT. SLACK LOOP NOT NECESSARY FOR LOCATIONS

CONTRACTOR ON SCOREBOARD CABLE TERMINATIONS.

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ADOLUTEOT

FANNING HOWEY

A C ALT B

KEY PLAN

CONSTRUCTION DOCUMENTS



PROJECT MANAGER: MKS

DRAWN BY: CDT

PROJECT NUMBER: 222130.00

PROJECT ISSUE DATE: 1.13.2024

REV.

DESCRIPTION	DATE
Addendum #1	1.26.2024

VERIFICATION NOTE

CONTRACTOR SHALL VERIFY ALL DIMENSIONS AND CLEARANCES AND ALL EXISTING FIELD CONDITIONS BEFORE STARTING CONSTRUCTION. COMMENCEMENT OF WORK CONSTITUTES ACCEPTANCE OF CONDITIONS.


SHOULD DIFFERENT CONDITIONS BE ENCOUNTERED, CONTACT THE ARCHITECT BEFORE PROCEEDING WITH WORK.

SECOND FLOOR TECHNOLOGY PLAN
- UNIT A

T-12A

ROOM LEGEND			
ROOM NO.	OWNER ROOM NO.	ROOM NAME	AREA (SF)
A101	102	FIELDHOUSE	54239 SF
A201	-	CORRIDOR	341 SF
A202	212	MECHANICAL	873 SF
B201	-	CORRIDOR	1444 SF
B202	211	LOCKER ROOM #3	399 SF
B203	-	SHOWER	184 SF
B204	210	DRESSING ROOM #3	261 SF
B205	210A	TOILET	74 SF
B206	209A	TOILET	75 SF
B207	209	DRESSING ROOM #4	270 SF
B208	-	SHOWER	184 SF

ROOM	OWNER		AREA
NO.	ROOM NO.	ROOM NAME	(SF)
	•		•
B209	208	LOCKER ROOM #4	402 SF
B210	207	CLASSROOM	842 SF
B211	206	CUSTODIAN	67 SF
B212	205	TOILET	63 SF
B213	204	TOILET	63 SF
B214	203	ELECTRICAL / TECHNOLOGY	58 SF
B215	202	ELEVATOR EQUIPMENT	55 SF
B216	201	CLASSROOM	840 SF
B217	-	COMMONS	984 SF
S-2	STAIR 1	STAIR	175 SF

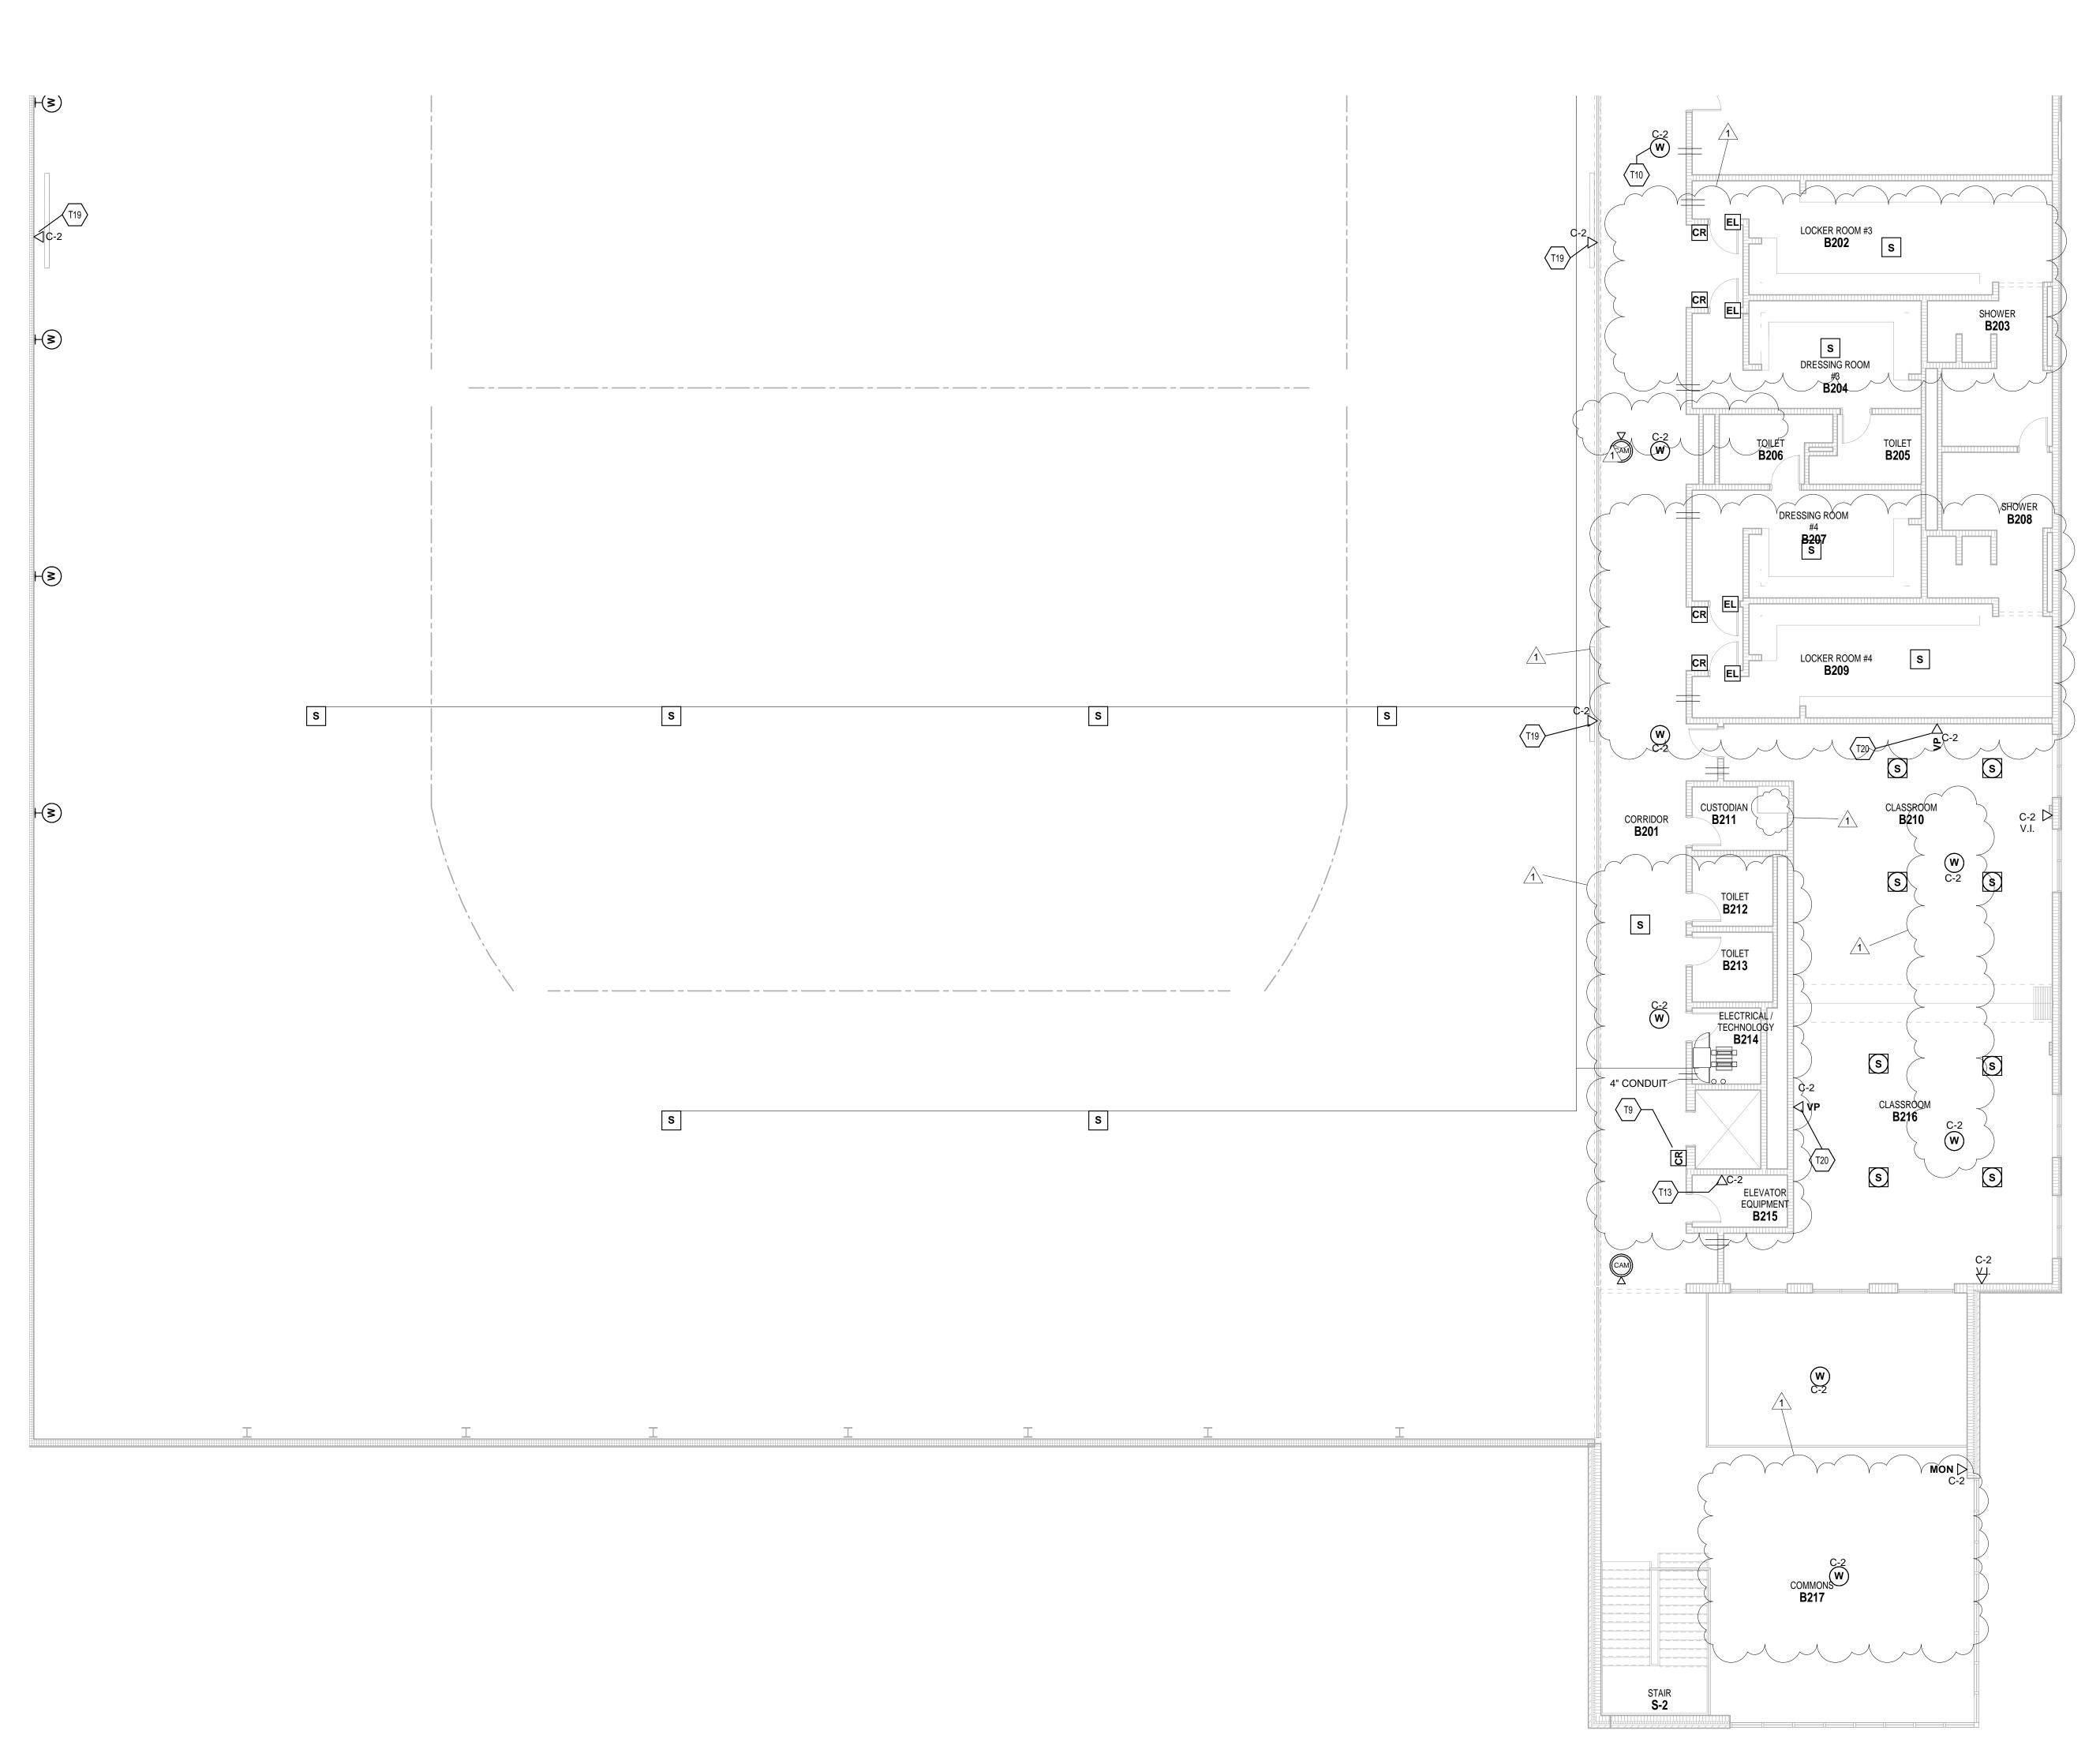

TECHNOLOGY PLAN GENERAL NOTES

A. DEVICES SHALL BE INSTALLED AT LOCATIONS SHOWN ON DRAWINGS. LOCATIONS OF DEVICES SHALL BE COORDINATED WITH OTHER ELECTRICAL DEVICES/ CASEWORK/ ARCHITECTURAL FEATURES AND OTHER TRADES PRIOR TO ROUGH-IN. IF RELOCATION OF DEVICES IS REQUIRED DUE TO LACK OF COORDINATION BETWEEN

ELECTRICAL DRAWINGS AND OTHER TRADES, ANY ASSOCIATED COSTS SHALL BE RESPONSIBILITY OF ELECTRICAL CONTRACTOR. CAT6A PATCH CORDS TO BE PROVIDED BY OTHERS.
NETWORK EQUIPMENT AND WIRELESS ACCESS POINTS TO BE PROVIDED BY OWNER. INSTALLATION, TERMINATION, LABELING AND TESTING OF CABLING BY DIVISION 27

CONTRACTOR. CLASSROOM PROJECTORS AND SOUND REINFORCEMENT KITS TO BE PROVIDED TURNKEY BY THE DIVISION 27 CONTRACTOR. DIV 27 IS RESPONSIBLE FOR INSTALLATION AND TERMINATION OF ALL CONNECTIVITY WIRING NEEDED AS SHOWN ON DETAILS. ACCESS CONTROL IS ROUGH-IN WIRING ONLY AS SHOWN

ON DETAILS. KANTECH SYSTEM EQUIPMENT AND PROGRAMMING TO BE PROVIDED BY OTHERS. (WIRELESS TECHNOLOGY SOLUTIONS) DOOR CONTACTS AND WIRING TO BE PROVIDED BY DOOR HARDWARE 087100 CONTRACTOR. VIDEO SURVEILLANCE EXAQVISION CAMERAS TO BE

PROVIDED BY OTHERS. (WIRELESS TECHNOLOGY SOLUTIONS) INSTALLATION, TERMINATION, LABELING AND TESTING OF CABLING BY DIVISION 27 CONTRACTOR. FIELDHOUSE FLOOR BOXES WILL HAVE ONE EMPTY CONDUIT TO EACH ONE FOR FUTURE TECH CABLES.

TECHNOLOGY PLAN NOTES

CONTRACTOR.

(ALL NOTES MAY NOT BE INDICATED ON THIS SHEET)

WITH CONDUIT SUCH AS GYMNASIUMS.

T9 PROVIDE ACCESS CONTROL ON BOTH FLOORS FOR

T10 PROVIDE CATEGORY 6A DATA FOR WIRELESS ACCESS POINTS. PROVIDE 20FT. SLACK LOOP COILED NEATLY AND

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T13 PROVIDE CABLES FOR ELEVATOR EQUIPMENT. VERIFY EXACT LOCATION WITH ELEVATOR EQUIPMENT

T19 COORDINATE WITH ELECTRICAL AND GENERAL CONTRACTOR ON SCOREBOARD CABLE TERMINATIONS. T20 CLASSROOM SOUND SYSTEMS SHALL BE CONNECTED BY CABLE TO GIVE THE OPTION OF USING AS ONE OR SEPERATE SYSTEMS.

<u>NOTE</u>

ELEVATOR. COORDINATE WITH ELEVATOR CONTRACTOR.

SUPPORTED ABOVE THE CEILING. TERMINATE CABLES AND TEST PER SPECIFICATIONS. NOTE LOCATION ON RECORD DRAWINGS AND MARK LOCATION ON CEILING GRID WITH BLUE DOT. SLACK LOOP NOT NECESSARY FOR LOCATIONS

FANNING HOWEY

WWW.FHAI.COM 350 E NEW YORK ST #300, INDIANAPOLIS, IN 46204 ALTERNATE **KEY PLAN**

CONSTRUCTION DOCUMENTS



PROJECT MANAGER: MKS DRAWN BY: CDT PROJECT NUMBER: 222130.00 PROJECT ISSUE DATE: 1.13.2024 REV.

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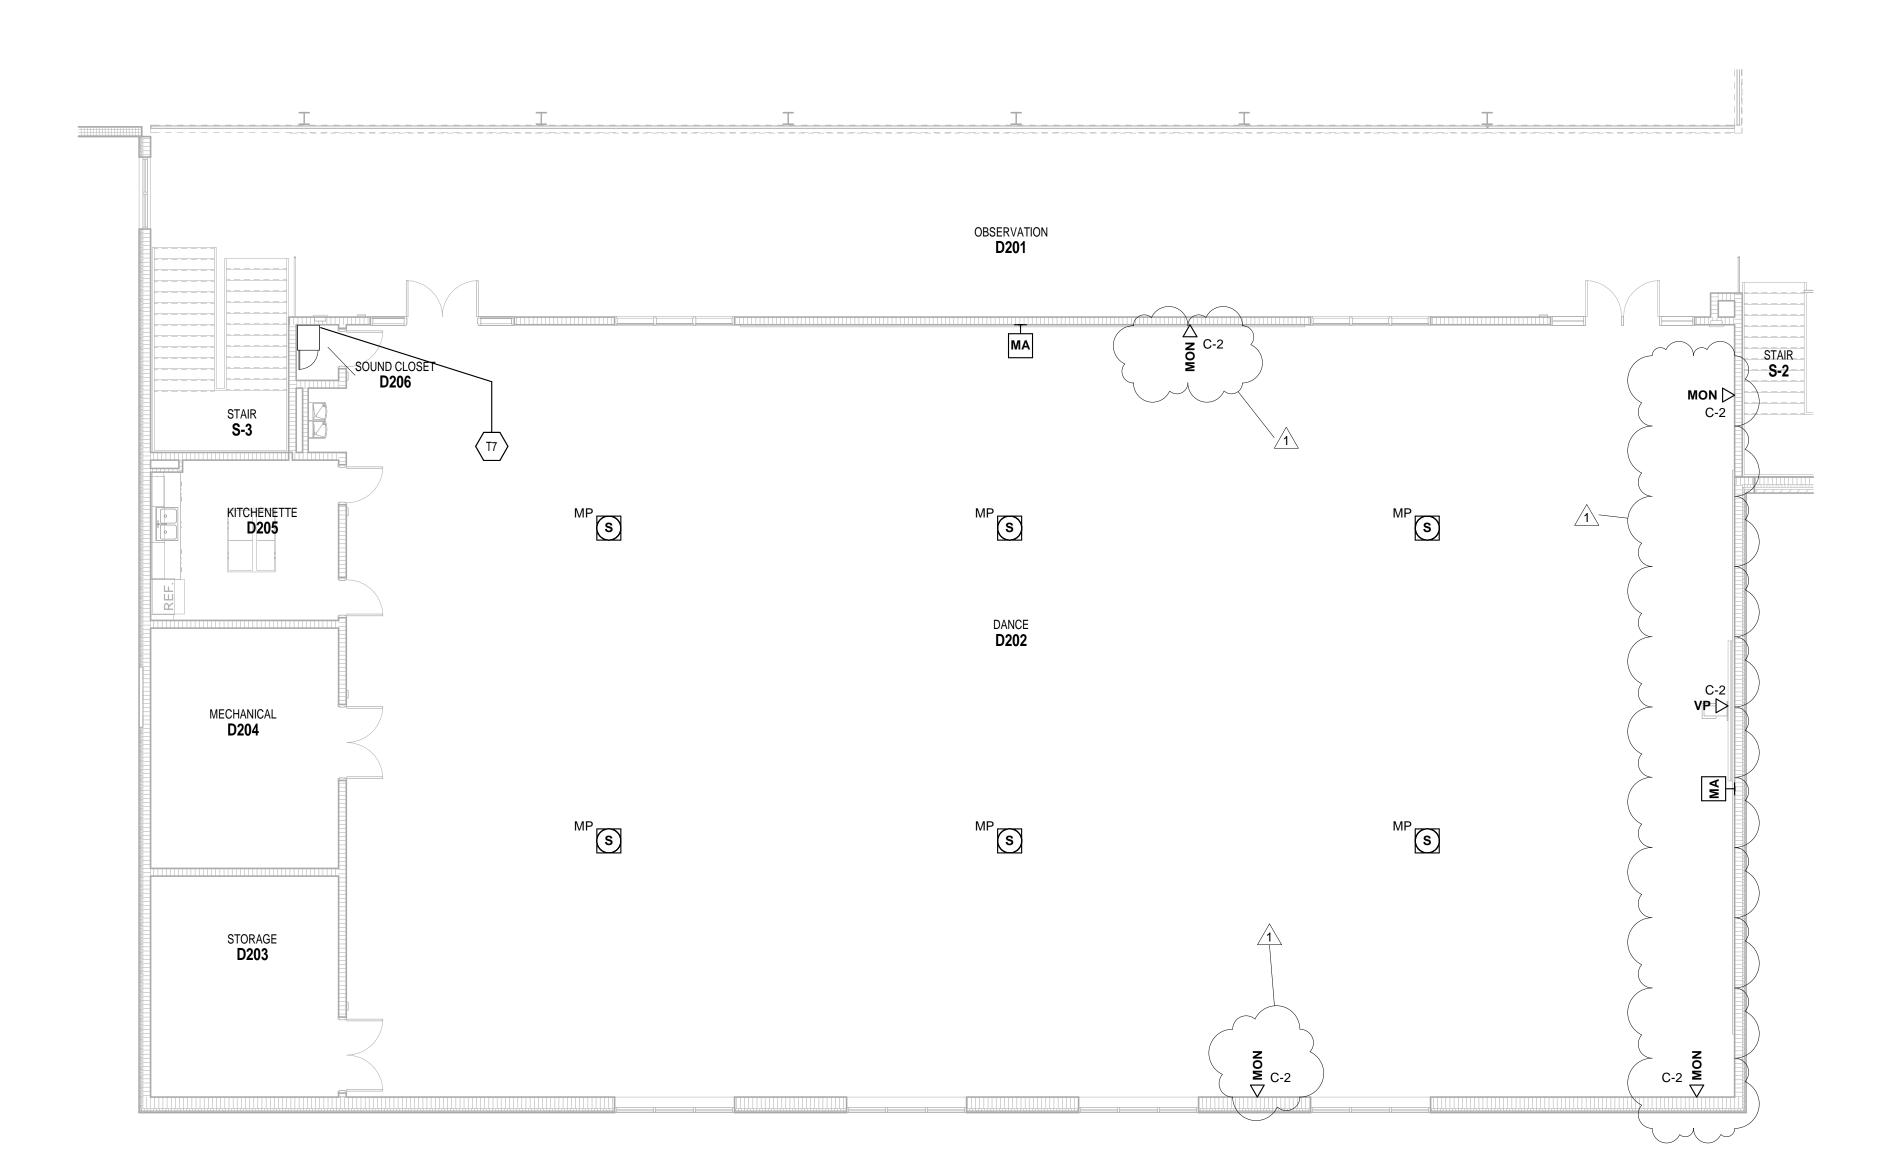
VERIFICATION NOTE

CONTRACTOR SHALL VERIFY ALL DIMENSIONS AND CLEARANCES AND ALL EXISTING FIELD CONDITIONS BEFORE STARTING CONSTRUCTION. COMMENCEMENT OF WORK CONSTITUTES ACCEPTANCE OF CONDITIONS.

SHOULD DIFFERENT CONDITIONS BE ENCOUNTERED, CONTACT THE ARCHITECT BEFORE PROCEEDING WITH WORK.

SECOND FLOOR TECHNOLOGY PLAN - UNIT B

ROOM LEGEND				
ROOM NO.	OWNER ROOM NO.	ROOM NAME	ARE.	
A101	102	FIELDHOUSE	54239 SF	
B201	-	CORRIDOR	1444 SF	
B217	-	COMMONS	984 SF	
S-2	STAIR 1	STAIR	175 SF	



SECOND FLOOR TECHNOLOGY PLAN - UNIT D ALTERNATE

SCALE: 1/8" = 1'-0"

TECHNOLOGY PLAN GENERAL NOTES

A. DEVICES SHALL BE INSTALLED AT LOCATIONS SHOWN ON DRAWINGS. LOCATIONS OF DEVICES SHALL BE COORDINATED WITH OTHER ELECTRICAL DEVICES/ CASEWORK/ ARCHITECTURAL FEATURES AND OTHER TRADES PRIOR TO ROUGH-IN. IF RELOCATION OF DEVICES IS REQUIRED DUE TO LACK OF COORDINATION BETWEEN ELECTRICAL DRAWINGS AND OTHER TRADES, ANY ASSOCIATED COSTS SHALL BE RESPONSIBILITY OF ELECTRICAL CONTRACTOR.

ELECTRICAL CONTRACTOR.

CAT6A PATCH CORDS TO BE PROVIDED BY OTHERS.

NETWORK EQUIPMENT AND WIRELESS ACCESS POINTS TO BE PROVIDED BY OWNER. INSTALLATION, TERMINATION, LABELING AND TESTING OF CABLING BY DIVISION 27 CONTRACTOR.

CONTRACTOR.

D. CLASSROOM PROJECTORS AND SOUND REINFORCEMENT KITS TO BE PROVIDED TURNKEY BY THE DIVISION 27 CONTRACTOR. DIV 27 IS RESPONSIBLE FOR INSTALLATION AND TERMINATION OF ALL CONNECTIVITY WIRING NEEDED AS SHOWN ON DETAILS.

E. ACCESS CONTROL IS ROUGH-IN WIRING ONLY AS SHOWN

E. ACCESS CONTROL IS ROUGH-IN WIRING ONLY AS SHOWN ON DETAILS. KANTECH SYSTEM EQUIPMENT AND PROGRAMMING TO BE PROVIDED BY OTHERS. (WIRELESS TECHNOLOGY SOLUTIONS)

F. DOOR CONTACTS AND WIRING TO BE PROVIDED BY DOOR HARDWARE 087100 CONTRACTOR.

VIDEO SURVEILLANCE EXAQVISION CAMERAS TO BE PROVIDED BY OTHERS. (WIRELESS TECHNOLOGY

PROVIDED BY OTHERS. (WIRELESS TECHNOLOGY SOLUTIONS) INSTALLATION, TERMINATION, LABELING AND TESTING OF CABLING BY DIVISION 27 CONTRACTOR.

H. FIELDHOUSE FLOOR BOXES WILL HAVE ONE EMPTY CONDUIT TO EACH ONE FOR FUTURE TECH CABLES.

PENN HIGH
SCHOOL
FIELDHOUSE

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12641 McKinley Highway, Mishawaka, Indiana 46545

PENN-HARRIS-MADISON SCHOOL CORPORATION

TECHNOLOGY PLAN NOTES

(ALL NOTES MAY NOT BE INDICATED ON THIS SHEET)

<u>NOTE</u>

T7 SEE DETAIL 2/T-503 FOR WRESTLING AND DANCE ROOM SOUND SYSTEMS.

MADISON

SCHOOL

CORPORATION

ARCHITECT

FANNING HOWEY

317.848.0966

WWW.FHAI.COM

350 E NEW YORK ST #300, INDIANAPOLIS, IN 46204

A

C
ALT

B

D
ALTERNATE

CONSTRUCTION DOCUMENTS



PROJECT MANAGER: MKS

DRAWN BY: CDT

PROJECT NUMBER: 222130.00

PROJECT ISSUE DATE: 1.13.2024

KEY PLAN

REV. NO. $ riangle$	DESCRIPTION	DATE
1	Addendum #1	1.26.2024


VERIFICATION NOTE

CONTRACTOR SHALL VERIFY ALL DIMENSIONS AND CLEARANCES AND ALL EXISTING FIELD CONDITIONS BEFORE STARTING CONSTRUCTION. COMMENCEMENT OF WORK CONSTITUTES ACCEPTANCE OF CONDITIONS.

SHOULD DIFFERENT CONDITIONS BE ENCOUNTERED, CONTACT THE ARCHITECT BEFORE PROCEEDING WITH WORK.

SECOND FLOOR TECHNOLOGY PLAN
- UNIT D ALT

T-12D

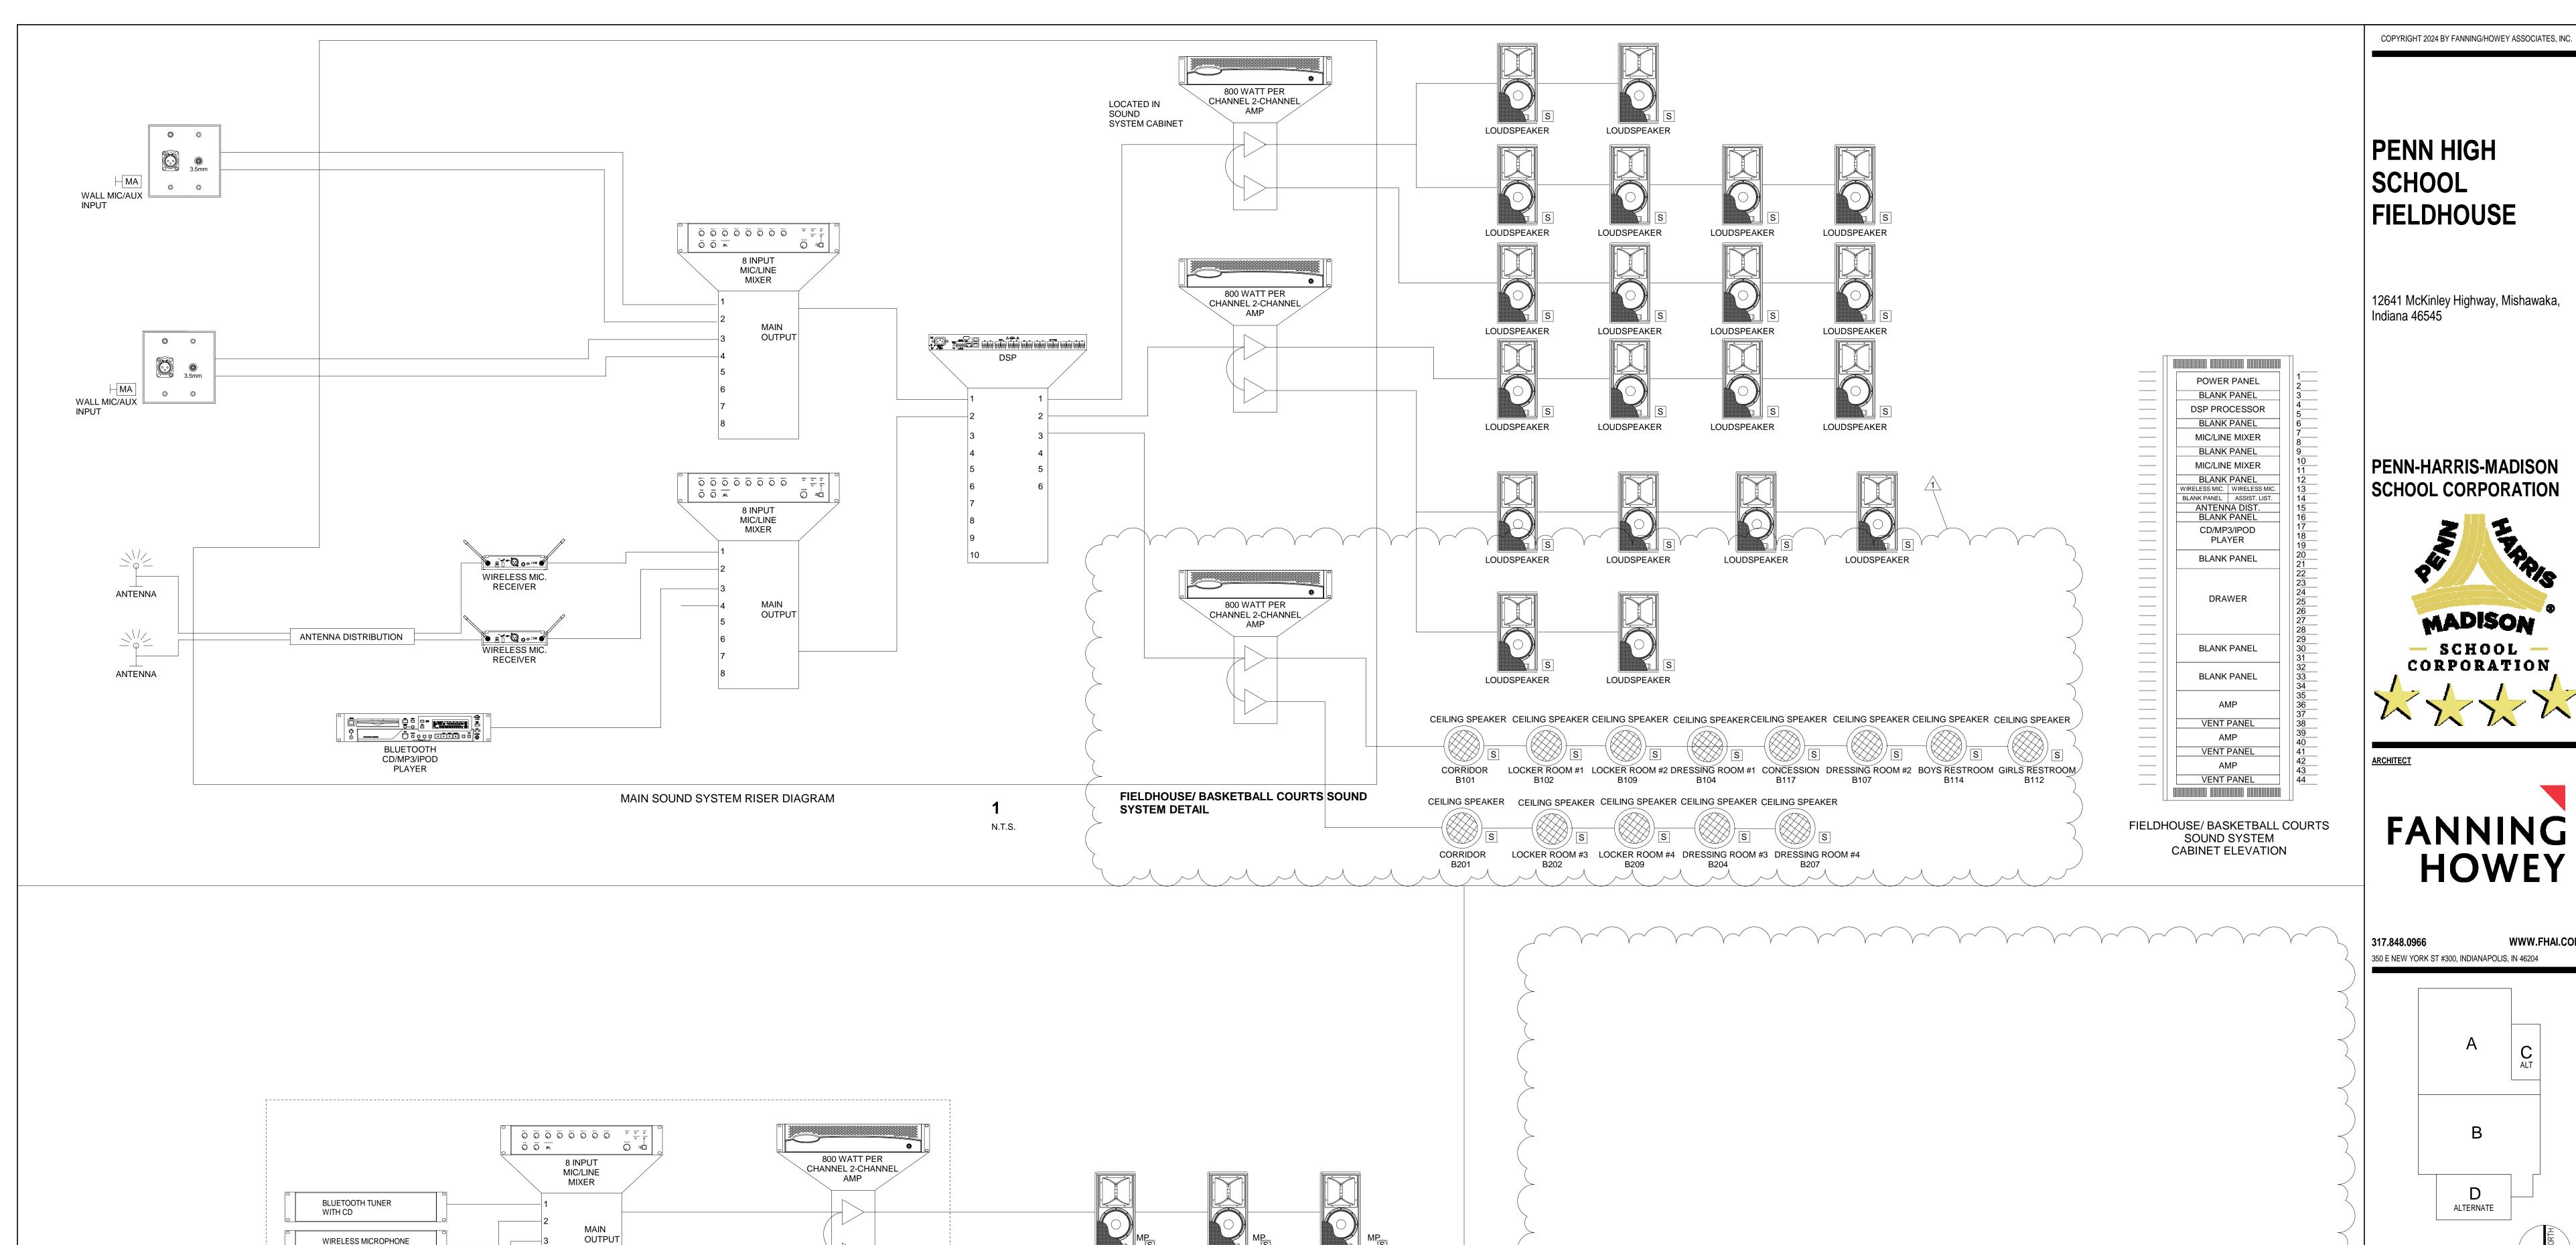

LOUDSPEAKER

LOUDSPEAKER

WRESTLING & DANCE ROOMS SOUND SYSTEM

N.T.S.

LOUDSPEAKER

LOUDSPEAKER

LOUDSPEAKER

LOUDSPEAKER

RECEIVER

IN SOUND CABINET

HARDWIRED XLR MICROPHONE & 3.5 SOUND CABLES

MADISON - SCHOOL - CORPORATION **FANNING HOWEY** WWW.FHAI.COM 350 E NEW YORK ST #300, INDIANAPOLIS, IN 46204 ALTERNATE KEY PLAN CONSTRUCTION DOCUMENTS

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TECHNOLOGY DETAILS

T-503