



RUSH COUNTY SCHOOL CORPORATION

Rushville Elementary School Renovations

ADDENDUM NO. 1

To: ALL BIDDERS OF RECORD

Date of Issue: May 20th, 2024

This Addendum is issued before Award of Contract to inform the Bidders of revisions to the Bidding Documents, of which includes Multiple Prime Contract Bids.

All requirements contained in the Bidding Documents shall apply to this Addendum. The general character of the work called for in this Addendum shall be the same as originally set forth in the applicable portions of the Bidding Documents for similar work, unless otherwise specified under this Addendum. All incidental work necessitated by this Addendum, as required to complete the work, shall be included in the bid even though not particularly mentioned in this Addendum.

This Addendum modifies the Bidding and Contract Requirements of the specifications and drawings dated May 2024 for bidding. This Addendum is hereby made a part of the Bidding Documents and shall be included in the Contract.

Acknowledge receipt of this Addendum in the appropriate space on the Bid Form. Failure to do so may subject the Bidder to disqualification.

PROJECT MANUAL CLARIFICATIONS AND REVISIONS

- DIVISION 00 SECTION “00 30 00: Available Information”
 - Phase One: Temporary Walls - **REVISED**
 - Phase Two: Temporary Walls - **REVISED**
- DIVISION 01 SECTION “01 23 00: Alternates” – **BIDDER CLARIFICATIONS**
- DIVISION 27 SECTION “27 51 27: Classroom AV Systems” – **DELETED and REPLACED**

DRAWING(S) CLARIFICATIONS AND REVISIONS

- AD100-OVERALL DEMOLITION PLAN
- AD101- DEMOLITION FLOOR PLAN - UNIT A
- AD102-DEMOLITION FLOOR PLAN - UNIT B
- AD103-DEMOLITION FLOOR PLAN - UNIT C
- AD104-DEMOLITION FLOOR PLAN - UNIT D
- AD105-DEMOLITION FLOOR PLAN - UNIT E
- AD201-DEMOLITION CEILING PLAN
- A100-OVERALL FLOOR PLAN
- A101-ARCHITECTURAL FLOOR PLAN - UNIT A
- A102-ARCHITECTURAL FLOOR PLAN - UNIT B
- A103-ARCHITECTURAL FLOOR PLAN - UNIT C
- A104-ARCHITECTURAL FLOOR PLAN - UNIT D
- A105-ARCHITECTURAL FLOOR PLAN - UNIT E
- A201-OVERALL REFLECTED CEILING PLAN
- A202-REFLECTED CEILING PLAN - UNIT A
- A203-REFLECTED CEILING PLAN - UNIT B

- A204-REFLECTED CEILING PLAN - UNIT C
- A205-REFLECTED CEILING PLAN - UNIT D
- A206-REFLECTED CEILING PLAN - UNIT E
- A207-ROOF PLAN AND DETAILS
- A503-TOILET & MEDIA CENTER ENLARGED PLAN & DETAILS
- A504-CLASSROOM ENLARGED PLAN & DETAILS
- A505-INTERIOR ELEVATIONS
- A701-DOOR SCHEDULES AND DETAILS
- A703-ROOM FINISH SCHEDULE
- M-601-MECHANICAL SCHEDULES
- MD101-MECHANICAL DEMOLITION FIRST FLOOR PLAN -UNIT C
- MD103 -MECHANICAL DEMOLITION ROOF PLAN -UNIT C
- MH102-MECHANICAL HVAC FIRST FLOOR PLAN -UNIT B
- MH103-MECHANICAL HVAC FIRST FLOOR PLAN -UNIT C
- MP-101-MECHANICAL HVAC ROOF PLAN -UNIT C
- MR101- MECHANICAL HVAC ROOF PLAN -UNIT C

ADDENDA # 1

SECTION 01 23 00 – ALTERNATES

PART 1 – GENERAL

1.1 RELATED DOCUMENTS

- A. Drawings and general provisions of the Contract, including General and Supplementary Conditions and other Division 01 Specification Sections, apply to this Section.

1.2 SUMMARY

- A. This Section includes administrative and procedural requirements for alternates.

1.3 DEFINITIONS

- A. Alternate: An amount proposed by bidders and stated on the Bid Form for certain work defined in the Bidding Requirements that may be added to or deducted from the Base Bid amount if Owner decides to accept a corresponding change either in the amount of construction to be completed or in the products, materials, equipment, systems, or installation methods described in the Contract Documents.
 - i. The cost or credit for each alternate is the net addition to or deduction from the Contract Sum to incorporate alternate into the Work. No other adjustments are made to the Contract Sum.

1.4 PROCEDURES

- A. Coordination: Modify or adjust affected adjacent work as necessary to completely integrate work of the alternate into Project.
 - i. Include as part of each alternate, miscellaneous devices, accessory objects, and similar items incidental to or required for a complete installation whether indicated as part of alternate.
- B. Notification: Immediately following award of the Contract, notify each party involved, in writing, of the status of each alternate. Indicate if alternates have been accepted, rejected, or deferred for later consideration. Include a complete description of negotiated modifications to alternates.
- C. Execute accepted alternates under the same conditions as other work of the Contract.
- D. Schedule: A Schedule of Alternates is included at the end of this Section. Specification Sections referenced in schedule contain requirements for materials necessary to achieve the work described under each alternate.

PART 2 – PRODUCTS (Not Used)


PART 3 – EXECUTION

2.1 SCHEDULE OF ALTERNATES

- A. Alternate No. 1: Provide price to renovate the **Life Skills rooms (E102 and E103); Pre-K Rooms (E104 and E105).**
- B. Alternate No. 2: Provide price to complete the finished work in Cafeteria B101.
- C. Alternate No. 3: Provide price to furnish and install a new synthetic floor and finishes in Gymnasium B102.
- D. Alternate No. 4: Provide price to construct the **Staff Restrooms (A106 and D106); Workrooms (A107 and D107).**
- E. Alternate No. 5: Provide price to construct Workrooms A113 and D113.

- F. Alternate No. 6: Provide price to renovate Restrooms C115 and C116 **[Phase One]**.
- G. Alternate No. 7: Provide pricing for the renovation and reorganization of the Kitchen Prep Area.
 - i. Included in this work is the reuse of existing equipment, as well as furnishing new equipment.
- H. Alternate No. 8: Provide price to install LVT wallcoverings in Main Corridors as indicated in the drawings.

END OF SECTION 01 23 00

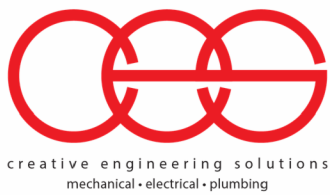

PROJECT NAME: RENOVATIONS TO RUSHVILLE ELEMENTARY SCHOOL
OWNER NAME: RUSH COUNTY SCHOOLS
CM PROJECT NO. 23-101-001-02
ARCHITECT PROJECT NO. 2023021.00
CES PROJECT NO. 2023-017.RER
ADDENDUM NO. 1
DATED: 5/17/24

This Addendum consists of 1 Addendum page(s) and 12 attachment pages totaling 13 pages. This Addendum shall supplement, amend, and become part of the Bid Documents. All Bids shall be based on these modifications. Bidders shall acknowledge the receipt of this addendum on their Bid Form.

PART 1: Changes to the Project Manual

Modifications described herein shall be incorporated in the Project Manual. All other Work shall remain unchanged.

DIVISION 27 – COMMUNICATIONS

Section 275127 “CLASSROOM AV SYSTEMS”

DELETE AND REPLACE Section in its entirety.

PART 2: Changes to the Drawings

DRAWING SHEETS: ADDITIONS, DELETIONS AND REPLACEMENTS

M-SERIES DRAWINGS

M-601 – MECHANICAL SCHEDULES	DELETE AND REPLACE
MD101 – MECHANICAL DEMOLITION FIRST FLOOR PLAN – UNIT C	DELETE AND REPLACE
MD103 – MECHANICAL DEMOLITION ROOF PLAN – UNIT C	DELETE AND REPLACE
MH102 – MECHANICAL HVAC FIRST FLOOR PLAN – UNIT B	DELETE AND REPLACE
MH103 – MECHANICAL HVAC FIRST FLOOR PLAN – UNIT C	DELETE AND REPLACE
MP-101 – MECHANICAL HVAC ROOF PLAN – UNIT C	DELETE AND REPLACE
MR101- MECHANICAL HVAC ROOF PLAN – UNIT C	DELETE AND REPLACE

End of Addendum Number 1

PART 1 - GENERAL

1.1 SCOPE OF WORK

- A. This section includes the minimum requirements for the installation, configuration, and training of the audio visual components as depicted on the Drawings and required by these specifications.
- B. These Specifications, together with the Drawings accompanying them, are intended to depict the installation requirements necessary to support this Project. Contractor shall furnish materials shown and/or called for on the Drawings but not mentioned in the Specifications, or vice versa, that are necessary for the installation and support of communications cabling, whether or not specifically called for in both. In addition, Contractor shall provide incidental equipment and materials required for the completion of systems included in this contract whether or not specified or shown on the drawings.
- C. This section includes minimum requirements for the following:
 - 1. Owner provided A/V station.
- D. Related Sections include the following:
 - 1. Division 26 – Electrical
 - 2. 27 05 00 – Common Work Results for Communications
 - 3. 27 05 28 – Pathways for Communications Systems
 - 4. 27 15 13 – Communications Copper Horizontal Cabling
 - 5. 27 15 00.23 - Audio-Video Communications Horizontal Cabling
 - 6. 27 51 23 – Central Sound and Paging System
 - 7. 27 53 13 – Clock Systems

1.2 QUALITY ASSURANCE

- A. The following industry Standards are the basis for the audio-visual system described herein. The list is incorporated by this reference to them.
 - 1. ANSI - American National Safety Institute
 - 2. ASTM - American Society of Testing and Materials
 - 3. EIA - Electronics Industries Association
 - 4. FCC - Federal Communications Commission
 - 5. NEMA - National Electrical Manufacturer's Association
 - 6. OSHA - Occupational Safety and Health Administration
 - 7. NEC - National Electric Code.
 - 8. NFPA - National Fire Protection Association.
 - 9. IEEE - Institute of Electrical and Electronics Engineers.
 - 10. ISO - International Standards Organization.
 - 11. UL - Underwriters Laboratories
 - 12. Davis and Davis, Sound System Engineering (2nd Edition), Howard W. Sams, 1987
 - 13. Giddings, Audio System Design and Installation (ASDI), Howard W. Sams, 1990
- B. All cable and equipment shall be installed in a neat and workmanlike manner. All methods of construction that are not specifically described or indicated in the contract documents shall be subject to the control and approval of the Architect. Equipment and materials shall be of the quality and manufacturer indicated. The equipment specified is based upon the acceptable manufacturers listed. Where "Or equal" is stated, equipment shall be equivalent in every way to that of the equipment specified and subject to approval.

- C. Materials and work specified herein shall comply with the requirements of the local Authority Having Jurisdiction.
- D. Contractor should have the following qualifications:
 - 1. Experienced in the installation of systems similar in complexity and scale to those included within the scope of work. If requested, the Contractor shall provide the names, locations, and points of contact for at least three installations of the type and complexity specified herein.
 - 2. Within the last two (2) years, installed an audio-visual system with similar equipment and functionality.
 - 3. Have at least one (1) person on staff with CTS-I certification.

1.3 SUBMITTALS

- A. Contractor shall submit manufacturers' catalog sheets, specifications and installation instructions for all products to be installed within the scope of work to verify that submitted components comply with Contract Documents.
- B. Contractor shall submit one (1) set of electronic shop drawings for approval.
 - 1. Provide the following within the shop drawings:
 - a. Floor plans, RCPs, section views, and details illustrating equipment location including, but not limited to, equipment racks, projection screens, connection panels, flat panel displays, and loudspeakers. Drawings should be at no less than 1/8"=1'-0" scale.
 - b. Detail wiring diagrams showing interconnection between equipment devices. Include cable labeling, cable types, connector types and termination details, wiring color codes, and equipment manufacturer and models.
 - c. Loudspeaker, video projector, projector lift, and projection screen mounting details including hardware type, material, and load capacity. For all equipment mounted overhead, mounting details and design calculations shall be signed and sealed by a professional structural engineer licensed to practice in the State of Indiana.
 - d. Dimensioned plate and panel details that are custom for the project. Details to include dimensioned locations of components, component type, engraving information, bill of materials, and plate finish and color.
 - e. Rack elevations showing equipment layout within racks with dimensions.
 - f. Wiring schedule showing source and destination of wiring and indicating whether wire is in conduit or cable tray.

1.4 DELIVERY, STORAGE, AND HANDLING

- A. Equipment and components shall arrive onsite properly protected and undamaged with containers, packaging and labels intact.
- B. Store, handle and protect materials and equipment in accordance with Manufacturer's recommendations.
- C. Store materials and equipment in dry, environmentally controlled space. Do not install equipment and materials until spaces are enclosed, watertight, and dry. Protect equipment from dust and other airborne materials.
- D. Provide additional protection during handling as necessary to prevent breaking, scraping, marring, or otherwise damaging products or surrounding areas.
- E. Protect all equipment and components that are to be installed within this project from theft, vandalism, and exposure to rain, freezing temperatures and direct sunlight.
- F. Protect installed equipment and components from damage and prevent use by unauthorized persons.

1.5 WARRANTY

- A. The Contractor shall warrant the completed work for a period of one (1) year, from the date of acceptance of the work, to be free of defect in design, workmanship, or material.
- B. Contractor shall repair, adjust, and/or replace, whichever the Owner determines to be in its best interests, any defective equipment, materials, or workmanship, as well as such parts of the work damaged or destroyed by such defect, during the warranty period, at the Contractor's sole cost and expense. If parts or components need to be repaired, then a loaner will be supplied and installed until the part or component can be repaired and reinstalled.
- C. All service work shall be performed by manufacturer certified technicians.
- D. Contractor to provide Owner a phone number for technical support. All support calls shall be answered within twenty-four (24) hours. All repairs shall be underway within forty-eight (48) hours and completed (or loaner supplied) within seven (7) days.
- E. At the end of the warranty period, the Contractor shall complete one (1) site visit to evaluate the status of the audio-visual systems. All equipment within this scope of work found to be defective shall be replaced at no cost to the Owner.
- F. Guarantees of material, equipment, and workmanship running in favor of the Contractor shall be transferred and assigned to the Owner on completion of the work and acceptance of said work by the Owner.

PART 2 - PRODUCTS

2.1 GENERAL

- A. Contractor provided Owner A/V station ordering specification: CLEARTOUCH 75" CTI-6075A+ (Interactive Panel) with CLEARTOUCH ADJUSTABLE MOBILE STAND-CTI-STAND-ADJM-B4, CTI-STAND-ADJM-C4 and CTI-STAND-ADJM-T4 motorized stand to attach the interactive panel. Notify Owner and general contractor of any potential long lead time that may affect the construction deadline.
- B. Interactive panel and stand for each classroom indicated on the T-series drawings.
- C. Confirm with Owner representative quantity and location prior to procurement.
- D. All products to be new and shipped in accordance with manufacturer recommendations.
- E. Replace, without costs to the Owner, any products damaged during shipping or installation.

PART 3 - EXECUTION

3.1 GENERAL

- A. Coordinate incorporation of the Work specified herein with other project work so as to facilitate a cohesive final product.
- B. The installation recommendations contained within ASDI and Telecommunications Distribution Methods Manual are mandatory minimum standards and requirements.
- C. Mount equipment and enclosures plumb and level.

- D. Permanently installed equipment to be firmly and safely held in place. Design equipment supports to support loads imposed with a safety factor of at least five. Seismic bracing shall be installed on appropriate equipment where local codes require such installation.
- E. Verify all locations of equipment in all rooms with Owner's Representative, Owner, and Consultant.

3.3 TRAINING

- A. After final completion, provide instruction to Owner designated personnel.
- B. Provide a minimum of twenty-four (24) hours of training to the Owner. Plan for multiple training trips to the site. Training session(s) shall cover the following topics at a minimum:
 - 1. System Equipment Connectivity
 - 2. Device Configurations
 - 3. Operation, maintenance, and upgrade procedures.
- C. Training to be arranged with Owner personnel. Training schedule shall be coordinated with Owner personnel and their needs.
- D. Training to occur in maximum of 4 hour increments per personnel or groups of personnel.
- E. Training plan, time line, and agenda shall be provided to Owner and signed off by Owner and Contractor.
- F. Warranty certificate and agreement shall be provided to Owner at initial training session.
- G. Provide a digital video copy of the training sessions.
- H. Contractor to be present at first two (2) uses of the facility.



3.4 SYSTEM ACCEPTANCE

- A. Contractor shall demonstrate to the Owner that all systems have been installed per the plans and specifications and that all programming functions, display functions, control functions and all interfaced equipment operate as expected.
- B. Contractor shall demonstrate to the Owner that all the end user staff has a working knowledge of how to operate the installed equipment and that the facilities staff also has a working knowledge of the troubleshooting methods for non-critical service problems.
- C. Contractor shall have a Delivery and Acceptance form signed by the Owner representative, agreeing that the installation is complete and its operation is acceptable except as noted on the Delivery and Acceptance form. This will also serve as the start of the warranty period.
- D. Contractor shall work with the General Contractor to complete all punch lists and work required to allow the General Contractor to close out his project in a timely manner. This will include but not limited to any work that would impact any final inspection for turnover of the building.

END OF SECTION

PHASE ONE
TEMPORARY WALLS

ADDENDA #1

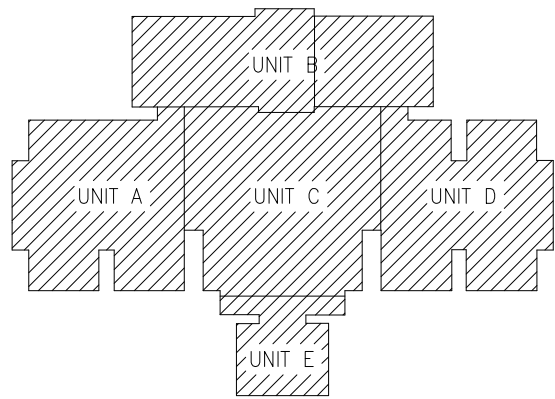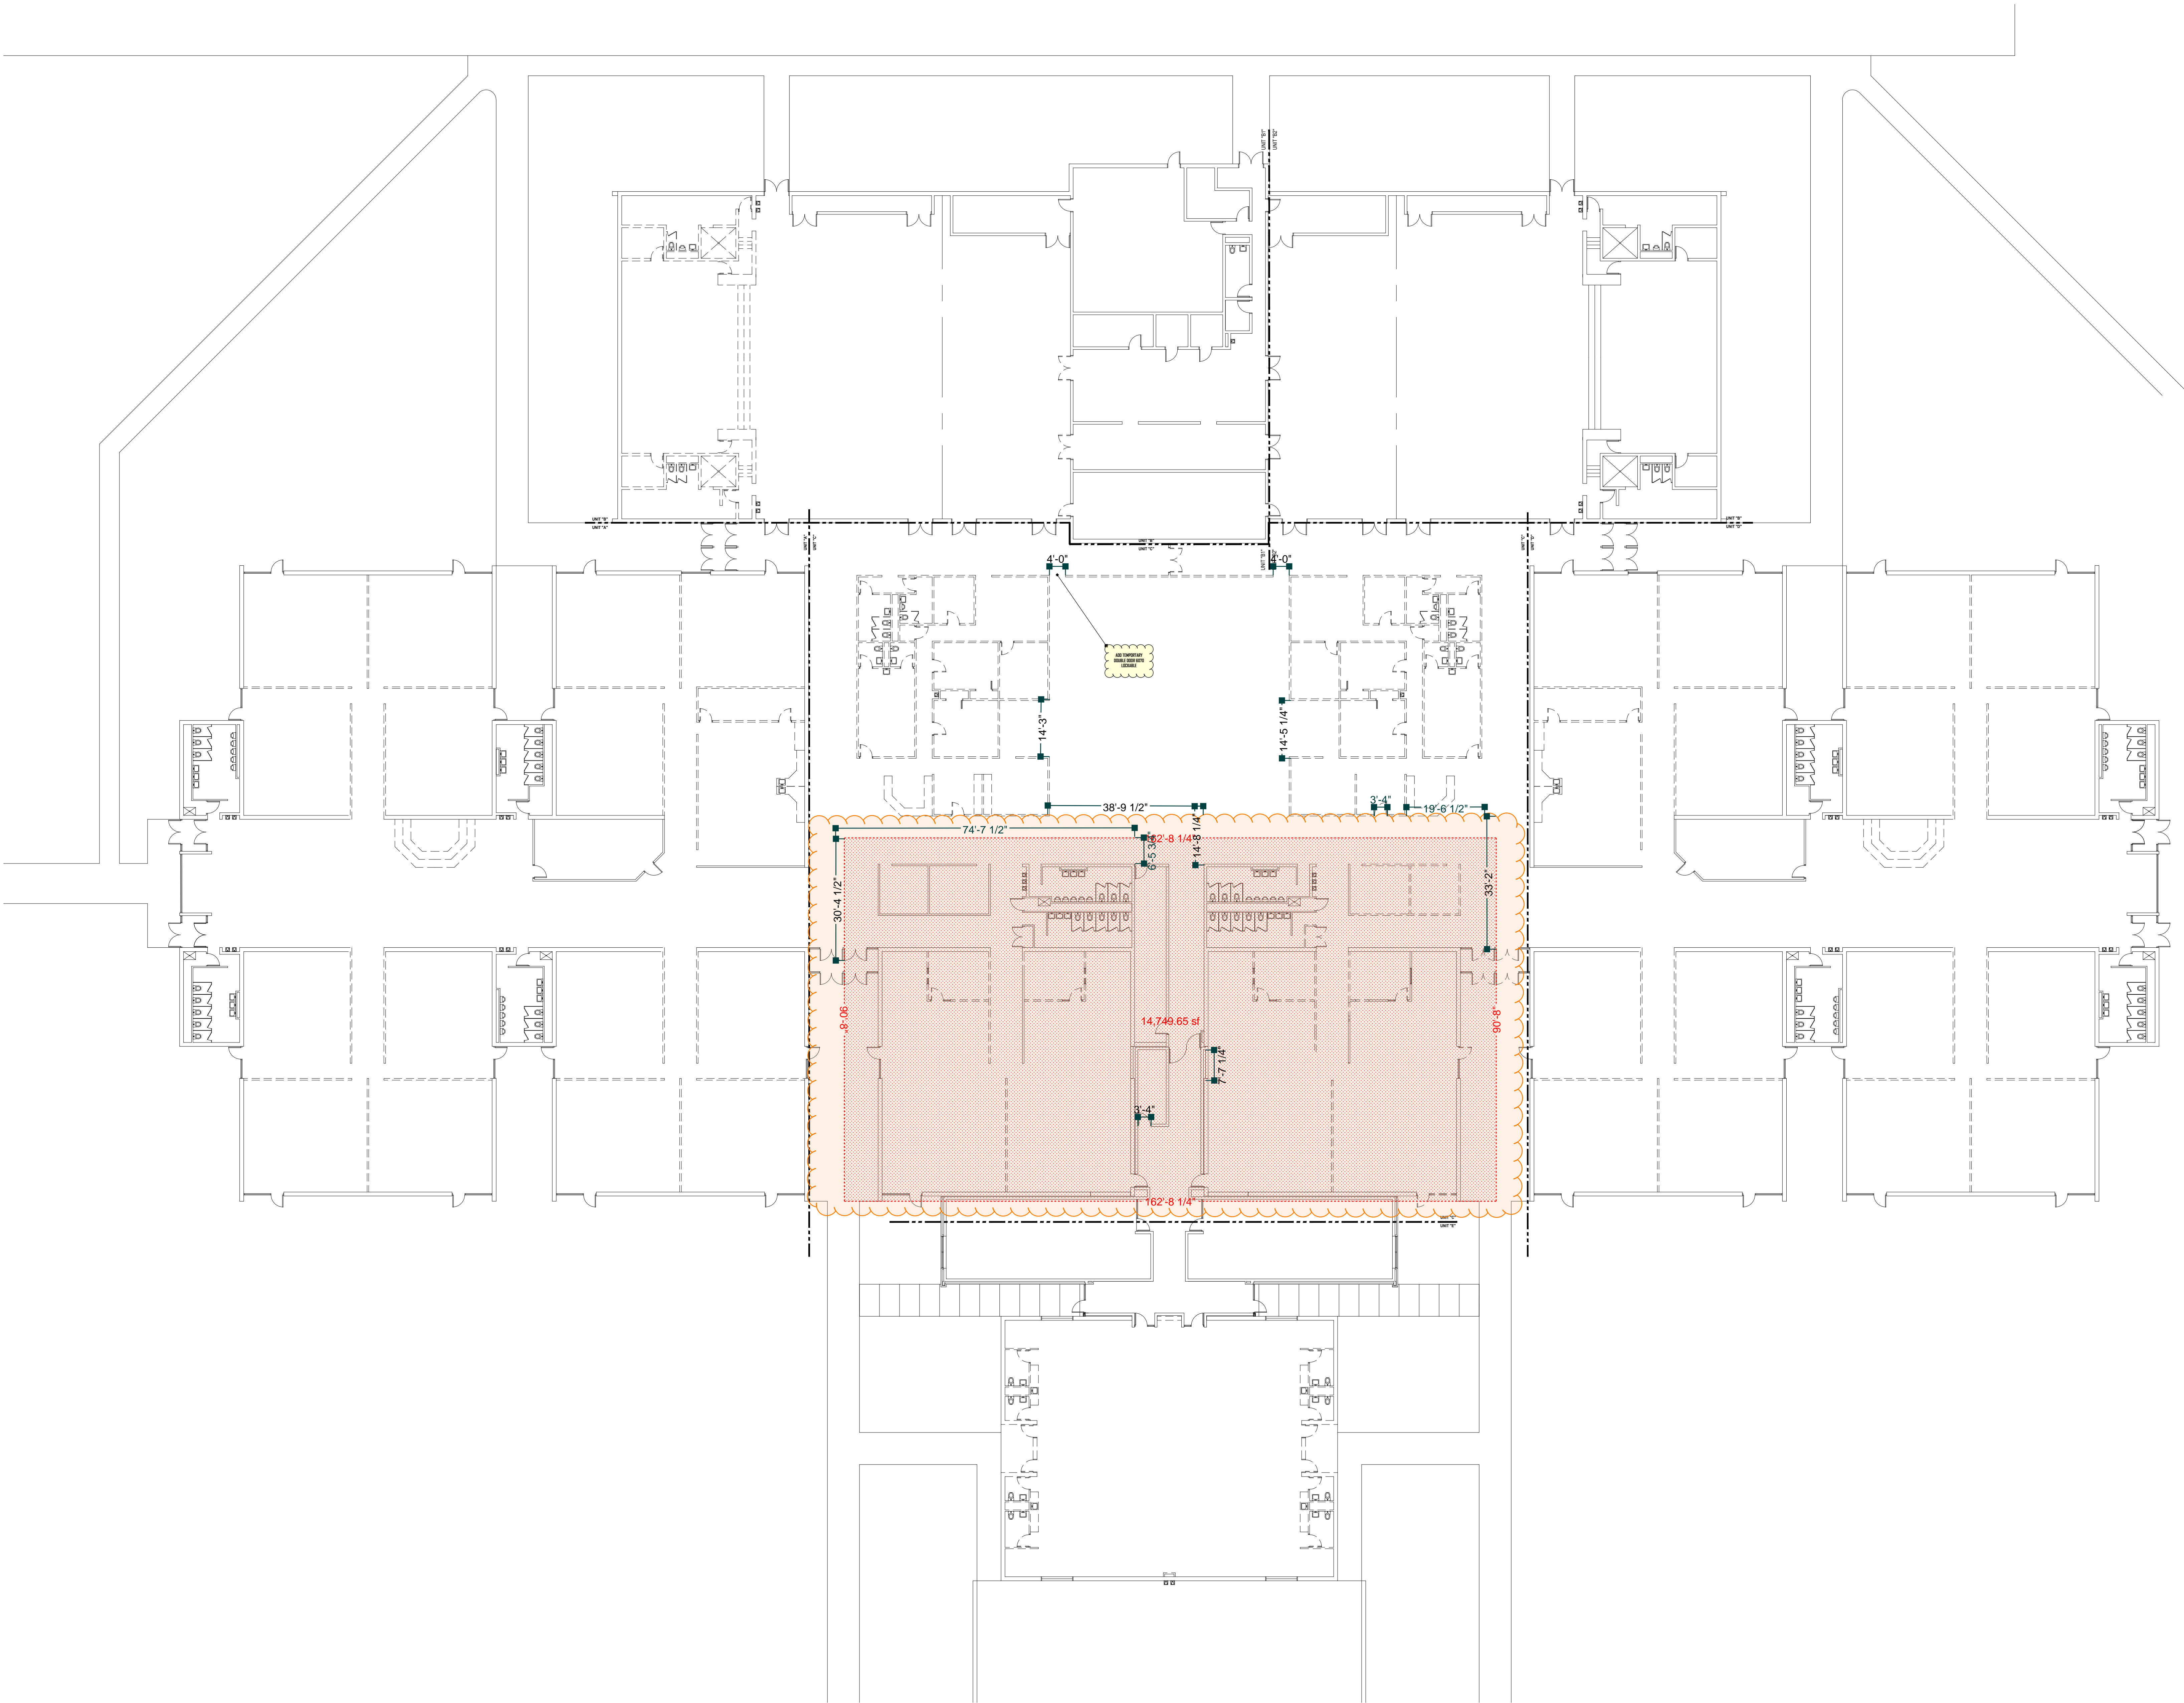

KEY PLAN



VPS ARCHITECTURE

528 Main Street - Suite 400 Evansville Indiana 47708
P (812) 423-7729 F (812) 425-4561

www.VPSARCH.com

FLOOR PLAN:

RUSHVILLE ELEMENTARY

RUSHVILLE ELEMENTARY SCHOOL
RUSHVILLE, INDIANA

Drawing Title:

Project No:

Project Date:

CAD File Data

file name:

plot date:



Drawing No:

ADDENDA #1

SCALE: 1/16" = 1'-0"

PHASE TWO
TEMPORARY WALLS

ADDENDA # 1

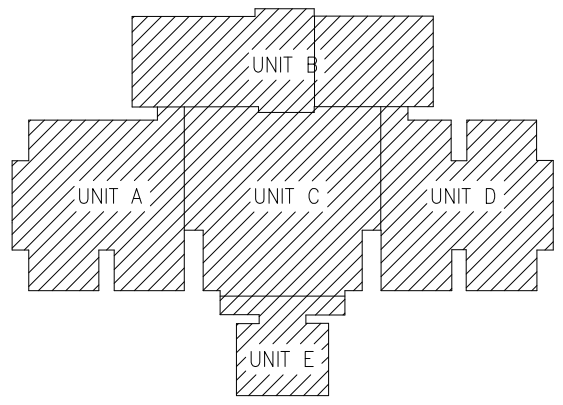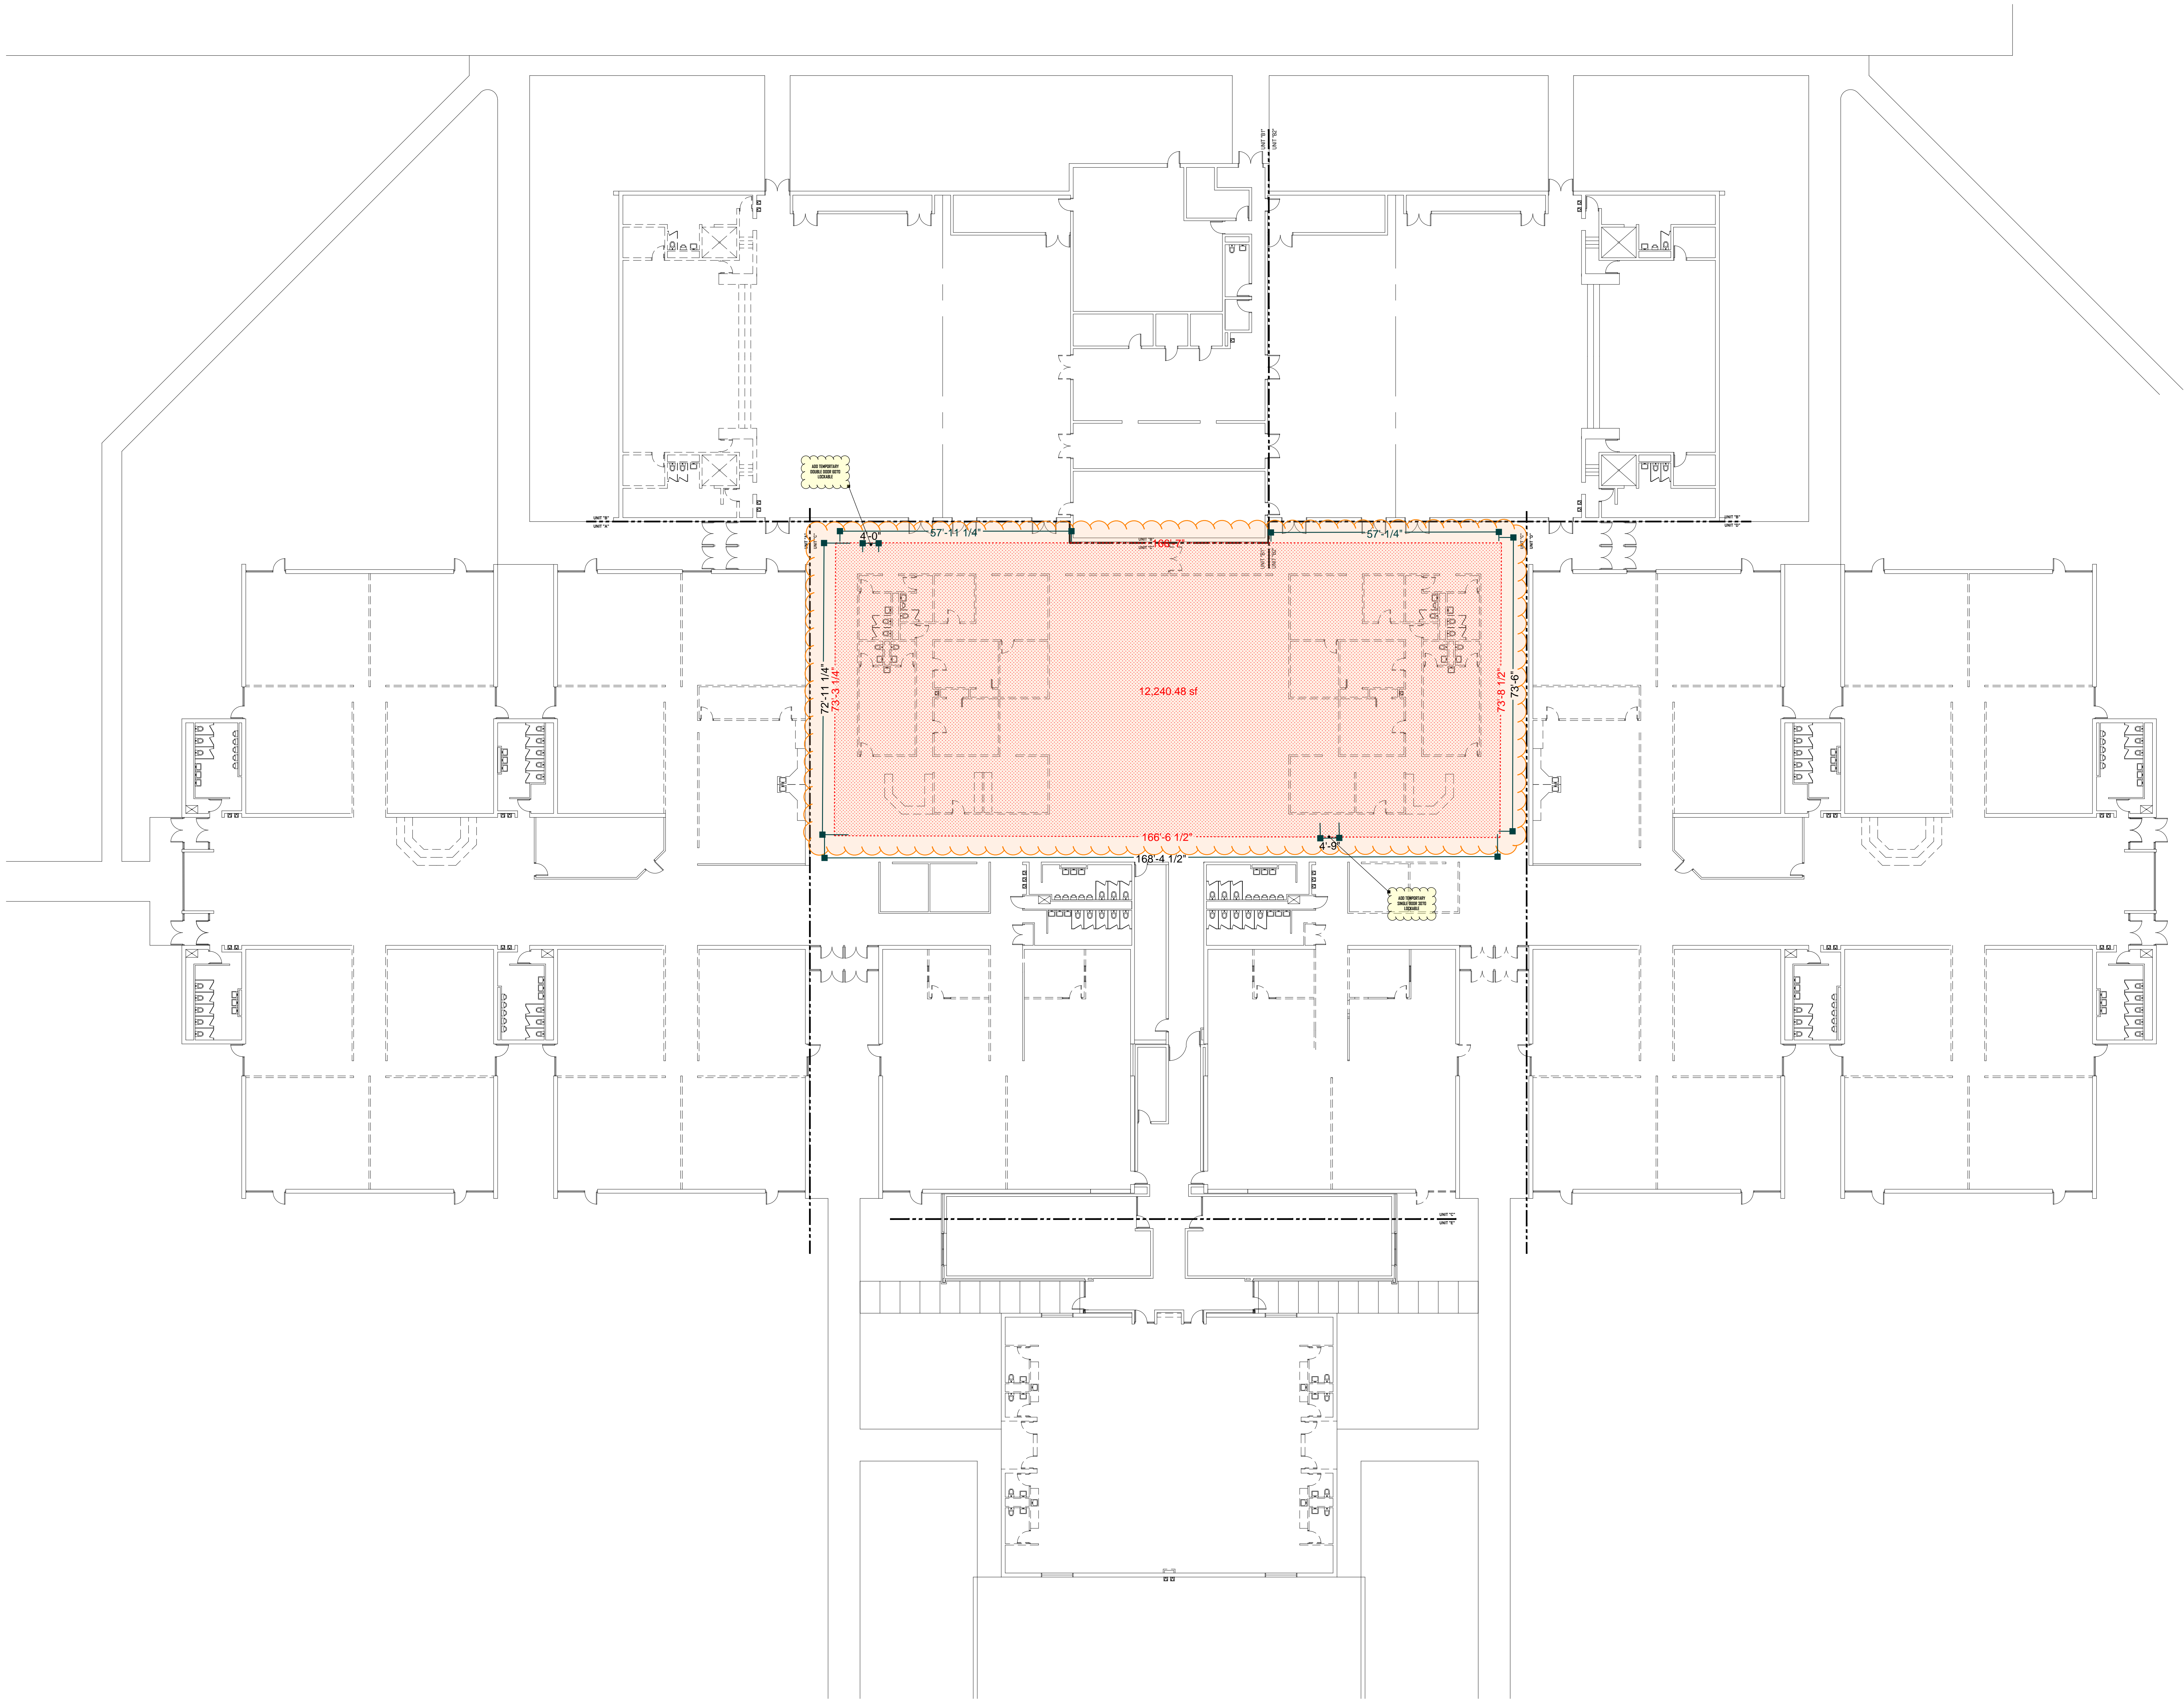

KEY PLAN



VPS ARCHITECTURE
528 Main Street — Suite 400 Evansville Indiana 47708
P (812) 423-7729 F (812) 425-4561
www.VPSARCH.com

FLOOR PLAN:	
RUSHVILLE ELEMENTARY	
RUSHVILLE ELEMENTARY SCHOOL RUSHVILLE, INDIANA	
Drawing Title:	
	Project No:
	Project Date:
	CAD File Data
	file name:
	plot date:
Drawing No:	

ADDENDA # 1

SCALE: 1/16" = 1'-0"

RUSH COUNTY SCHOOLS

RENOVATIONS TO RUSHVILLE ELEMENTARY SCHOOL

400 W 16TH ST, RUSHVILLE, IN

DATE: 04/17/2024

VPS PROJECT NO. 2023021.00

CONSTRUCTION DOCUMENTS

ARCHITECTS

VPS ARCHITECTURE
528 MAIN ST., SUITE 400
EVANSVILLE, IN 47708
PH. 812-423-7729
FX. 812-425-4561

ENGINEERS

CREATIVE ENGINEERING SOLUTIONS
201 S. RURAL STREET, SUITE 210
CITY, STATE, 12345
PH. 317-525-1716

CONSTRUCTION MANAGER

SCS CONSTRUCTION SERVICES, INC
173 E BROADWAY ST SUITE 100
GREENWOOD, IN, 46143
PH. 317-882-0100

KITCHEN CONSULTANTS

VORNDRAN & ASSOCIATES
7670 SHASTA DRIVE
INDIANAPOLIS, IN, 46217
PH. 260-496-9992

ARCHITECTURAL SHEET SCHEDULE

SHEET NUMBER	SHEET NAME
C001	PROJECT COVER PAGE
AD100	OVERALL DEMOLITION PLAN
AD101	DEMOLITION FLOOR PLAN - UNIT A
AD102	DEMOLITION FLOOR PLAN - UNIT B
AD103	DEMOLITION FLOOR PLAN - UNIT C
AD104	DEMOLITION FLOOR PLAN - UNIT D
AD105	DEMOLITION FLOOR PLAN - UNIT E
AD201	DEMOLITION CEILING PLAN
A100	OVERALL FLOOR PLAN
A101	ARCHITECTURAL FLOOR PLAN - UNIT A
A102	ARCHITECTURAL FLOOR PLAN - UNIT B
A103	ARCHITECTURAL FLOOR PLAN - UNIT C
A104	ARCHITECTURAL FLOOR PLAN - UNIT D
A105	ARCHITECTURAL FLOOR PLAN - UNIT E
A201	OVERALL REFLECTED CEILING PLAN
A202	REFLECTED CEILING PLAN - UNIT A
A203	REFLECTED CEILING PLAN - UNIT B
A204	REFLECTED CEILING PLAN - UNIT C
A205	REFLECTED CEILING PLAN - UNIT D
A206	REFLECTED CEILING PLAN - UNIT E
A207	ROOF PLAN AND DETAILS
A503	TOILET & MEDIA CENTER ENLARGED PLAN & DETAILS
A504	CLASSROOM ENLARGED PLAN & DETAILS
A505	INTERIOR ELEVATIONS
A701	DOOR SCHEDULES AND DETAILS
A703	ROOM FINISH SCHEDULE
FS1.0	FOODSERVICE NOTES, SYMBOLS & LEGENDS
FS1.1	FOODSERVICE EQUIPMENT DEMOLITION LAYOUT
FS1.2	FOODSERVICE EQUIPMENT LAYOUT & SCHEDULE
FS2.0	FOODSERVICE EQUIPMENT SPOT LOCATION LAYOUT
FS2.1	FOODSERVICE EQUIPMENT SPOT LOCATION LAYOUT
FS5.0	FOODSERVICE EQUIPMENT DETAILS & ELEVATIONS
FP101	OVERALL FIRE PROTECTION PLAN
P001	PLUMBING SYMBOLS AND ABBREVIATIONS
PD101	PLUMBING DEMOLITION FOUNDATION PLAN - UNIT B
PD102	PLUMBING DEMOLITION FOUNDATION PLAN - UNIT C
PD103	PLUMBING DEMOLITION FOUNDATION PLAN - UNIT E
PD104	PLUMBING DEMOLITION PLAN FIRST FLOOR - UNIT B
PD105	PLUMBING DEMOLITION PLAN FIRST FLOOR - UNIT C
PD106	PLUMBING DEMOLITION PLAN FIRST FLOOR - UNIT E
PF101	PLUMBING FOUNDATION PLAN - UNIT A
PF102	PLUMBING FOUNDATION PLAN - UNIT B
PF103	PLUMBING FOUNDATION PLAN - UNIT C
PF104	PLUMBING FOUNDATION PLAN - UNIT D
PF105	PLUMBING FOUNDATION PLAN - UNIT E
PP101	PLUMBING FIRST FLOOR PLAN - UNIT A
PP102	PLUMBING FIRST FLOOR PLAN - UNIT B

ARCHITECTURAL SHEET SCHEDULE

SHEET NUMBER	SHEET NAME
PP103	PLUMBING FIRST FLOOR PLAN - UNIT C
PP104	PLUMBING FIRST FLOOR PLAN - UNIT D
PP105	PLUMBING FIRST FLOOR PLAN - UNIT E
PR101	PLUMBING OVERALL ROOF PLAN
P-501	PLUMBING DETAILS
P-601	PLUMBING SCHEDULES
P-801	PLUMBING ISOMETRICS - UNITS A, B, AND D
P-902	PLUMBING ISOMETRICS - UNIT C
P-903	PLUMBING ISOMETRICS - UNIT E
M001	MECHANICAL SYMBOLS AND ABBREVIATIONS
MD101	MECHANICAL DEMOLITION PLAN FIRST FLOOR - UNIT A
MD102	MECHANICAL DEMOLITION PLAN FIRST FLOOR - UNIT B
MD103	MECHANICAL DEMOLITION PLAN FIRST FLOOR - UNIT C
MD104	MECHANICAL DEMOLITION PLAN FIRST FLOOR - UNIT D
MD105	MECHANICAL DEMOLITION PLAN FIRST FLOOR - UNIT E
MD106	MECHANICAL DEMOLITION ROOF PLAN - UNIT C
MH101	MECHANICAL HVAC FIRST FLOOR PLAN - UNIT A
MH102	MECHANICAL HVAC FIRST FLOOR PLAN - UNIT B
MH103	MECHANICAL HVAC FIRST FLOOR PLAN - UNIT C
MH104	MECHANICAL HVAC FIRST FLOOR PLAN - UNIT D
MH105	MECHANICAL HVAC FIRST FLOOR PLAN - UNIT E
MP101	MECHANICAL PIPING FIRST FLOOR PLAN - UNIT C
MP102	MECHANICAL PIPING FIRST FLOOR PLAN - UNIT E
MR101	MECHANICAL HVAC ROOF PLAN - UNIT C
M-501	MECHANICAL DETAILS
M-601	MECHANICAL SCHEDULES
M-701	TEMPERATURE CONTROLS SCHEMATICS
M-702	TEMPERATURE CONTROLS SCHEMATICS
E001	ELECTRICAL SYMBOLS AND ABBREVIATIONS
ED101	ELECTRICAL DEMOLITION FIRST FLOOR PLAN - UNIT A
ED102	ELECTRICAL DEMOLITION FIRST FLOOR PLAN - UNIT B
ED103	ELECTRICAL DEMOLITION FIRST FLOOR PLAN - UNIT C
ED104	ELECTRICAL DEMOLITION FIRST FLOOR PLAN - UNIT D
ED105	ELECTRICAL DEMOLITION FIRST FLOOR PLAN - UNIT E
ED106	ELECTRICAL DEMOLITION ROOF PLAN - UNIT C
ED701	ONE-LINE DIAGRAM DEMOLITION
EL101	ELECTRICAL FIRST FLOOR LIGHTING PLAN - UNIT A
EL102	ELECTRICAL FIRST FLOOR LIGHTING PLAN - UNIT C
EL103	ELECTRICAL FIRST FLOOR LIGHTING PLAN - UNIT D
EL104	ELECTRICAL FIRST FLOOR LIGHTING PLAN - UNIT E
EP101	ELECTRICAL FIRST FLOOR POWER PLAN - UNIT A
EP102	ELECTRICAL FIRST FLOOR POWER PLAN - UNIT B
EP103	ELECTRICAL FIRST FLOOR POWER PLAN - UNIT C
EP104	ELECTRICAL FIRST FLOOR POWER PLAN - UNIT D
EP105	ELECTRICAL FIRST FLOOR POWER PLAN - UNIT E
ER101	ELECTRICAL ROOF PLAN - UNIT C
EF101	ELECTRICAL FIRE ALARM PLAN - UNIT A
EF102	ELECTRICAL FIRE ALARM PLAN - UNIT B

ARCHITECTURAL SHEET SCHEDULE

SHEET NUMBER	SHEET NAME
EF103	ELECTRICAL FIRE ALARM PLAN - UNIT C
EF104	ELECTRICAL FIRE ALARM PLAN - UNIT D
EF105	ELECTRICAL FIRE ALARM PLAN - UNIT E
E501	GENERAL DETAILS
E502	LIGHTING DETAILS
E601	LIGHTING TRANSFORMER SCHEDULES
E602	PANEL BOARD SCHEDULES
E701	ONE-LINE DIAGRAM
T001	ELECTRICAL SYMBOLS AND ABBREVIATIONS
T101	OVERALL FIRST FLOOR DEMOLITION PLAN - SYSTEMS
T102	DEMOLITION FLOOR PLAN UNIT A - SYSTEMS
T103	DEMOLITION FLOOR PLAN UNIT B - SYSTEMS
T104	DEMOLITION FLOOR PLAN UNIT C - SYSTEMS
T105	DEMOLITION FLOOR PLAN UNIT D - SYSTEMS
T106	DEMOLITION FLOOR PLAN UNIT E - SYSTEMS
T201	OVERALL FIRST FLOOR PLAN - SYSTEMS
T202	FLOOR PLAN UNIT A - SYSTEMS
T203	FLOOR PLAN UNIT B - SYSTEMS
T204	FLOOR PLAN UNIT C - SYSTEMS
T205	FLOOR PLAN UNIT D - SYSTEMS
T206	FLOOR PLAN UNIT E - SYSTEMS
T901	ELECTRICAL DETAILS

SCHEDULE OF ALTERNATES

- ALT. 1. PROVIDE PRICE TO RENOVATE THE LIFE SKILLS ROOMS E102, E103, E104, AND E105
- ALT. 2. PROVIDE PRICE TO COMPLETE THE FINISH WORK IN CAFETERIA B101
- ALT. 3. PROVIDE PRICE TO FURNISH AND INSTALL A NEW SYNTHETIC FLOOR AND FINISHES IN GYMNASIUM B102
- ALT. 4. PROVIDE PRICE TO CONSTRUCT THE STAFF RESTROOMS A106, A107, D106, AND D107
- ALT. 5. PROVIDE PRICE TO CONSTRUCT WORKROOMS A113 AND D113
- ALT. 6. PROVIDE PRICE TO RENOVATE RESTROOMS C115 AND C116
- ALT. 7. PROVIDE PRICE TO RENOVATION AND REORGANIZATION OF THE KITCHEN PREP AREA. INCLUDED IN THIS WORK IS THE REUSE OF EXISTING EQUIPMENT, AS WELL AS FURNISHING NEW EQUIPMENT.
- ALT. 8. PROVIDE PRICE TO INSTALL LVT WALLCOVERING TO MAIN CORRIDORS AS INDICATED IN DRAWINGS



Construction Manager

VPS ARCHITECTURE



528 Main Street - Suite 400
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PH: (317) 353-3281

Evansville, Indiana 47708
Indianapolis, Indiana 46204
www.VPSARCH.com

DEMOLITION NOTES		
#	KEYNOTE INFORMATION	
1	REMOVE EXISTING WALL	
2	REMOVE PORTION OF EXISTING WALL AS REQUIRED FOR NEW CONSTRUCTION	
3	REMOVE EXISTING DOOR AND FRAME	
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GENERAL DEMOLITION NOTES

- CONTRACTOR SHALL VISIT JOB SITE AND VERIFY ALL CONDITIONS SHOWN ON PLAN.
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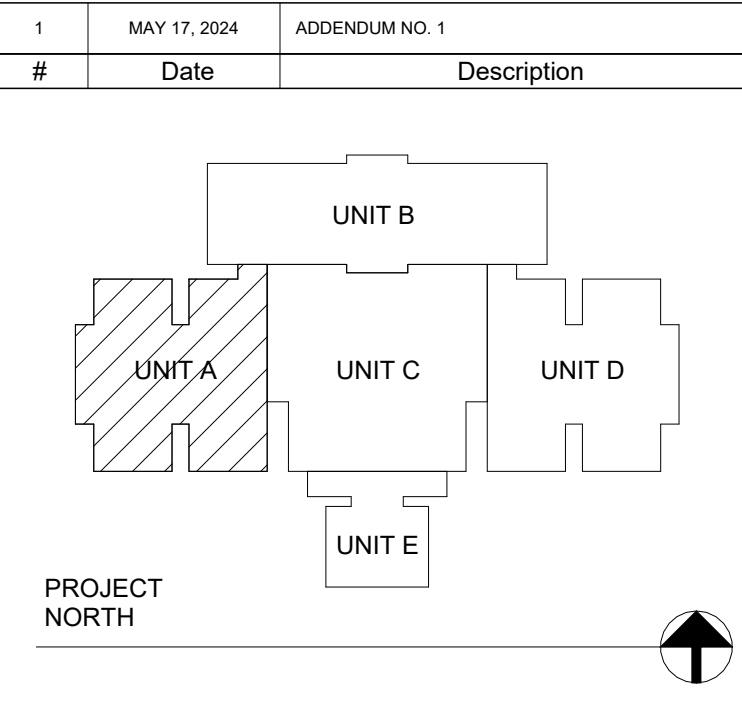
STRUCTURAL: ENGINEERS:

Project Name: RENOVATIONS TO RUSHVILLE ELEMENTARY SCHOOL	
Drawing Title: OVERALL DEMOLITION PLAN	
	Client Project No: VPS Project No: 2023021.00 Project Issue Date: 04/17/24 Drawing No: AD100

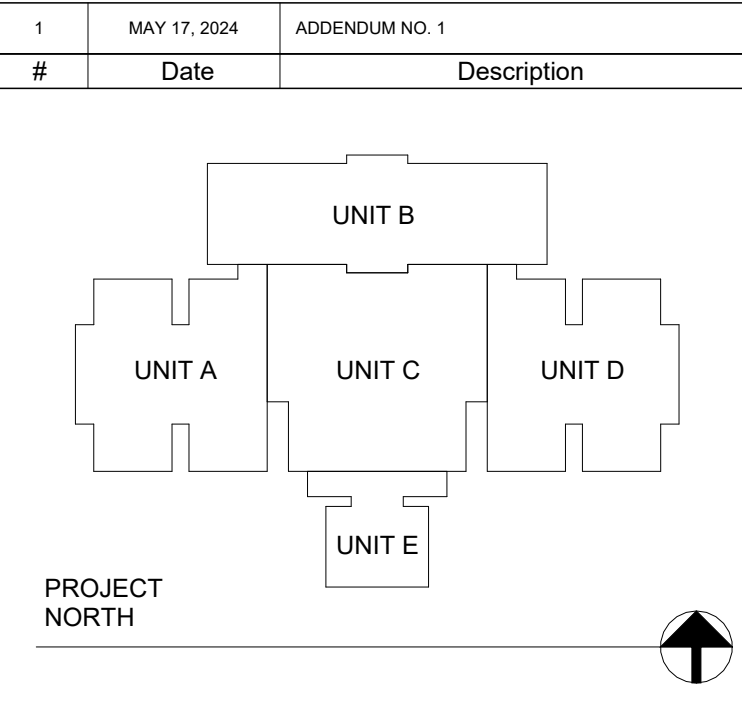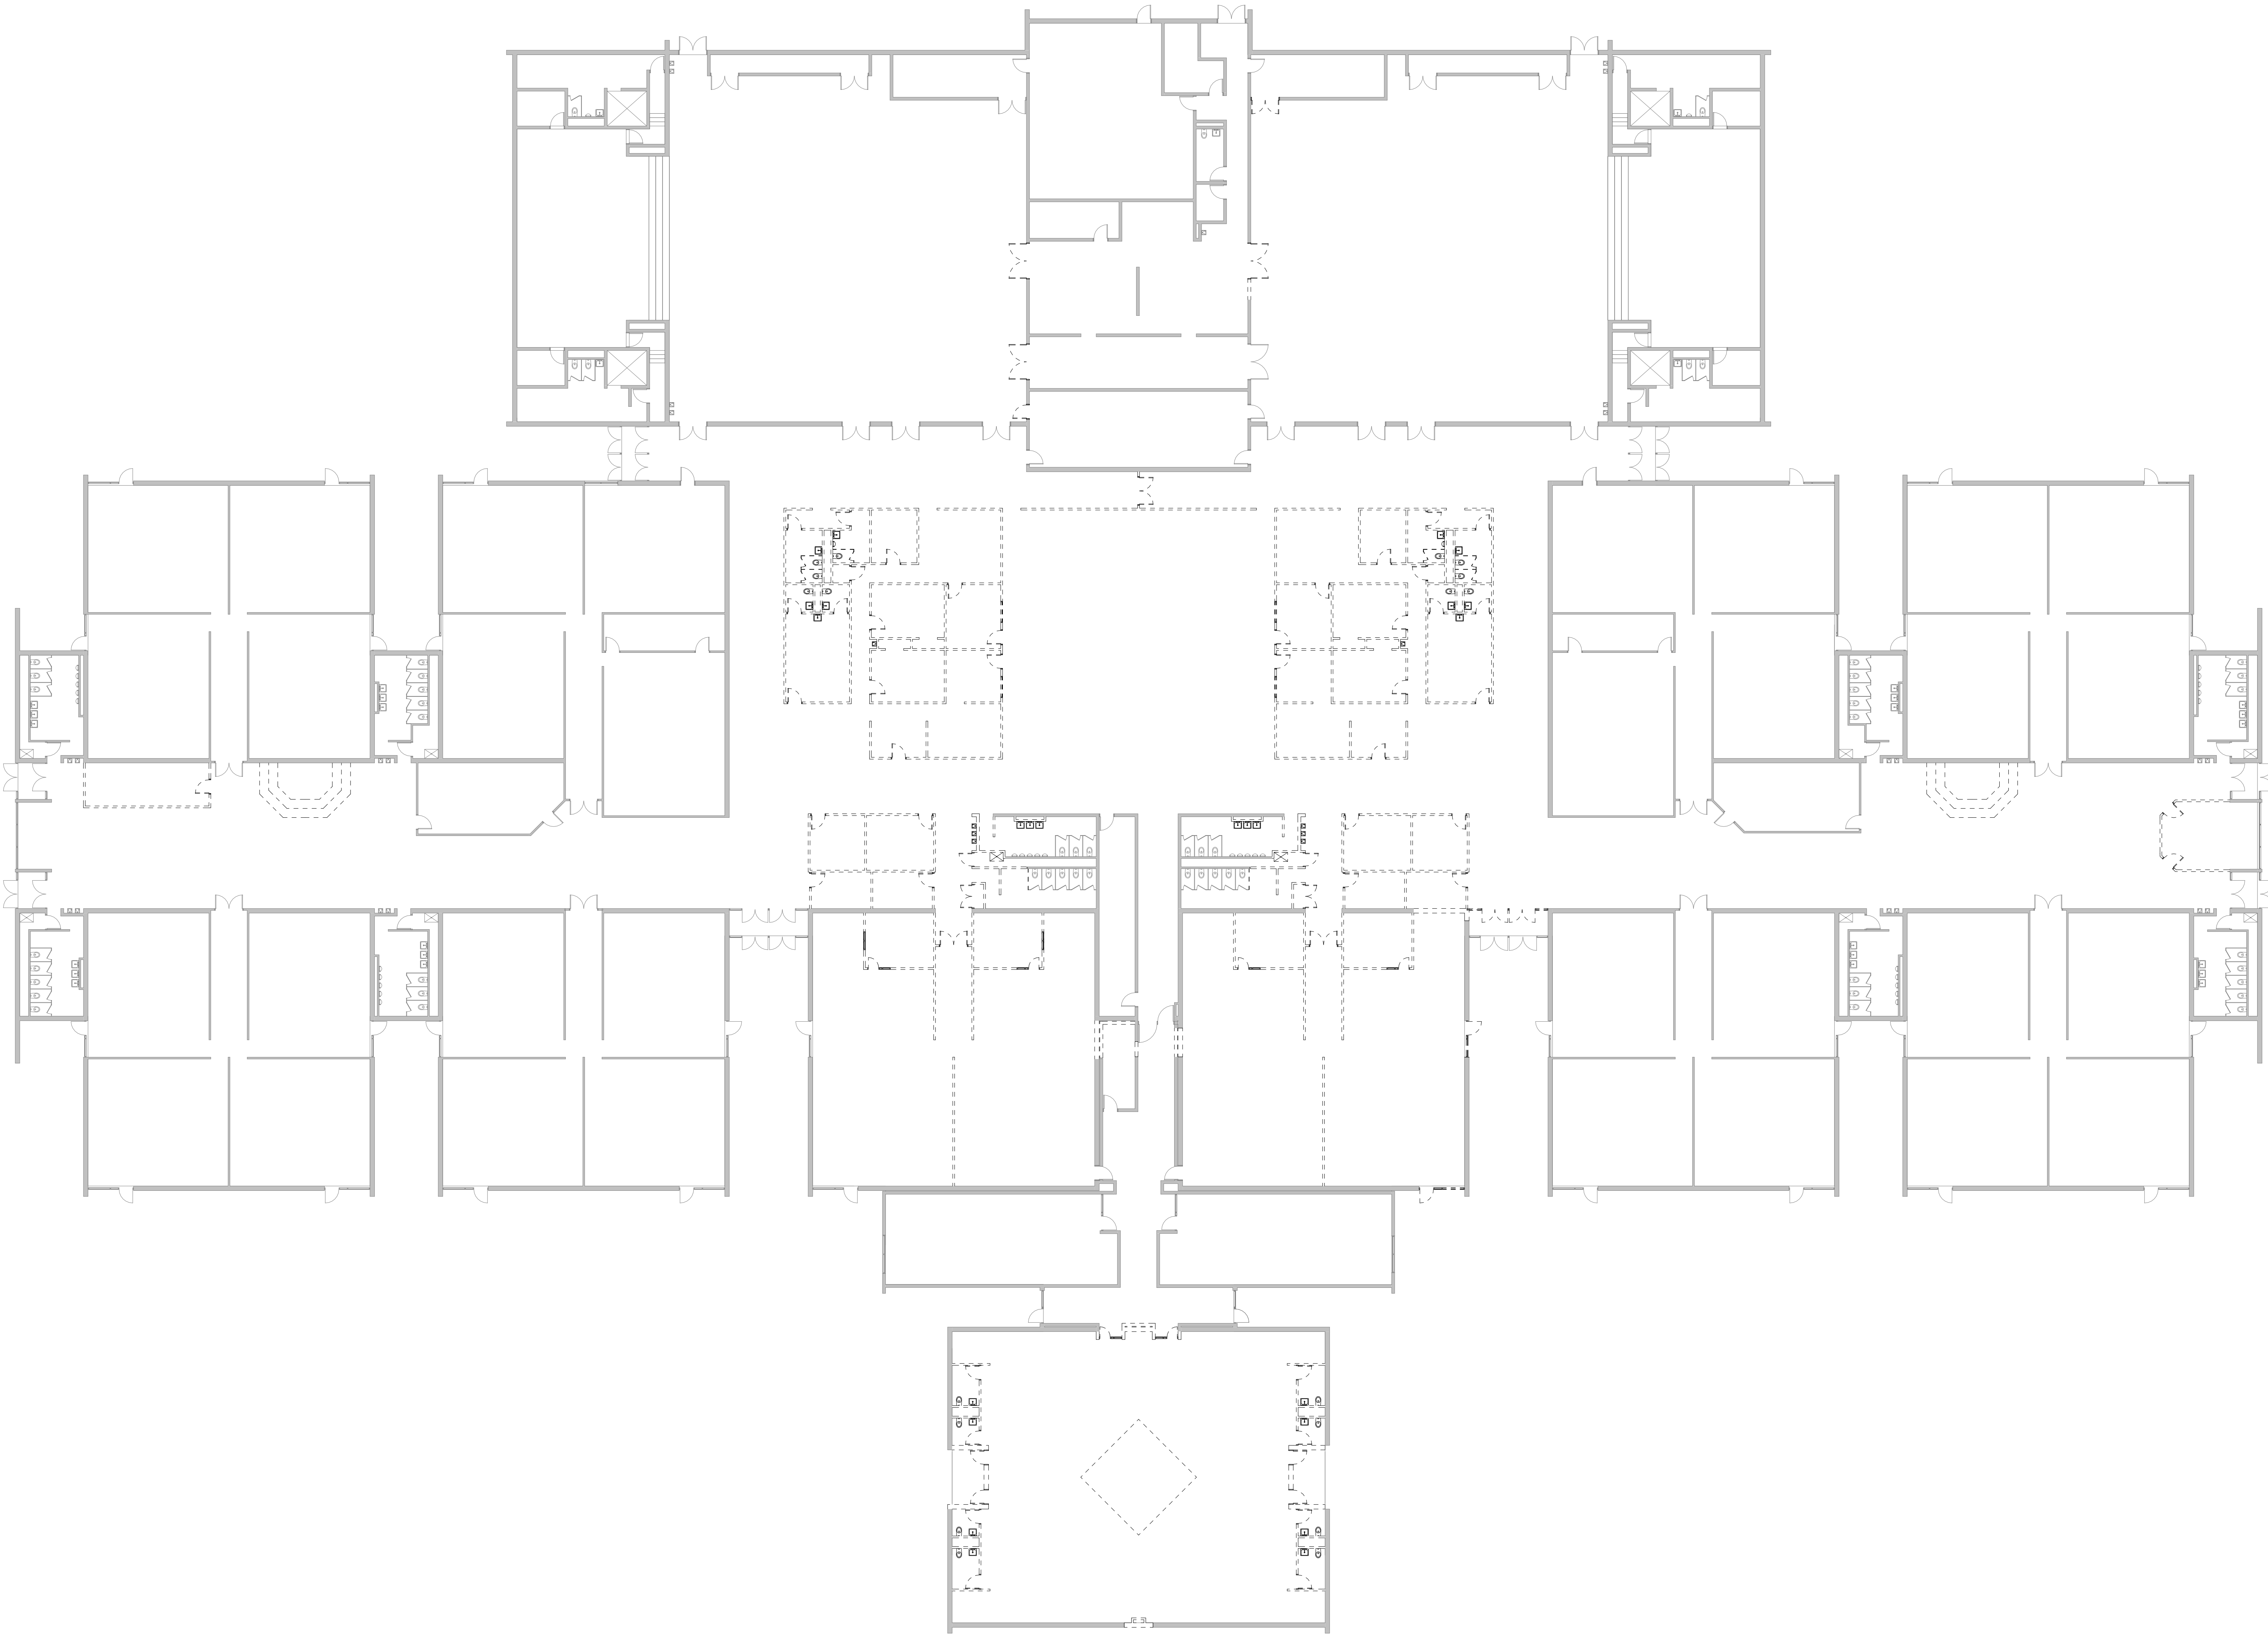DEMOLITION NOTES		<input type="checkbox"/>
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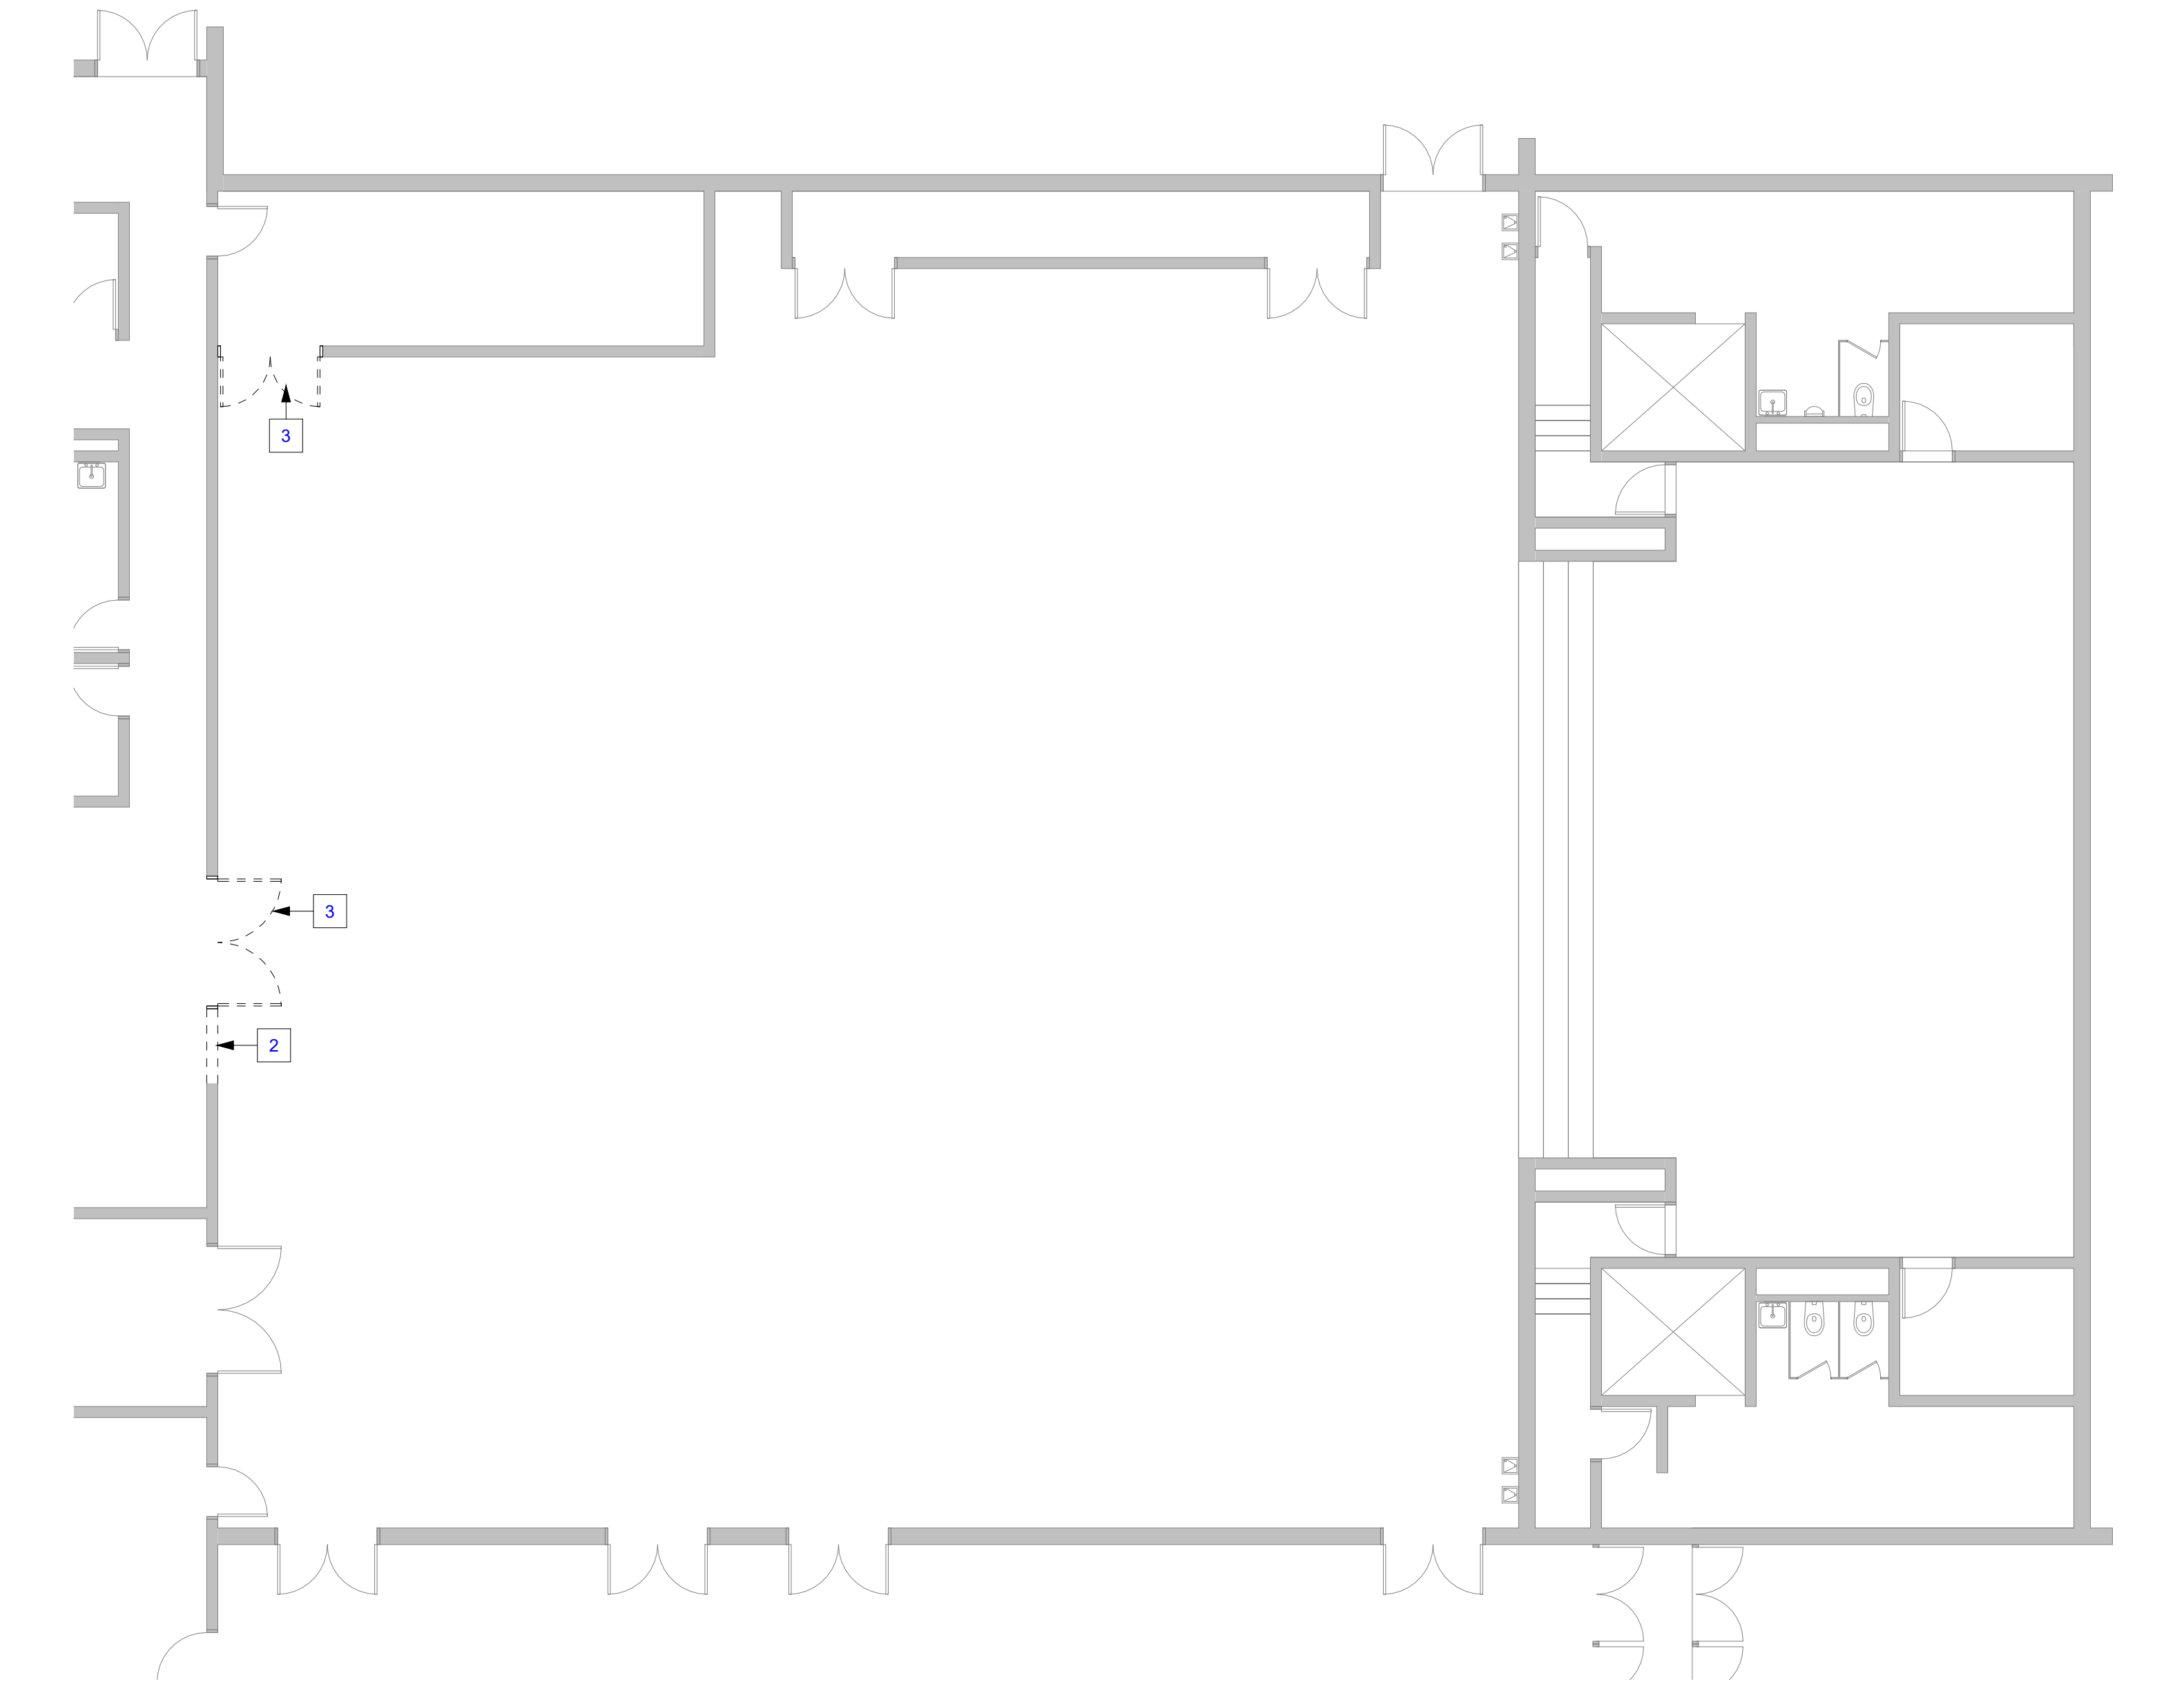
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STRUCTURAL: ENGINEERS:


Project Name:
RENOVATIONS TO RUSHVILLE ELEMENTARY SCHOOL

Drawing Title:
DEMOLITION FLOOR PLAN - UNIT A

Client Project No:	
VPS Project No:	2023021.00
Project Issue Date:	04/17/24
Drawing No:	AD101



2
AD102
FIRST FLOOR DEMOLITION PLAN UNIT B2
1/8" = 1'-0"

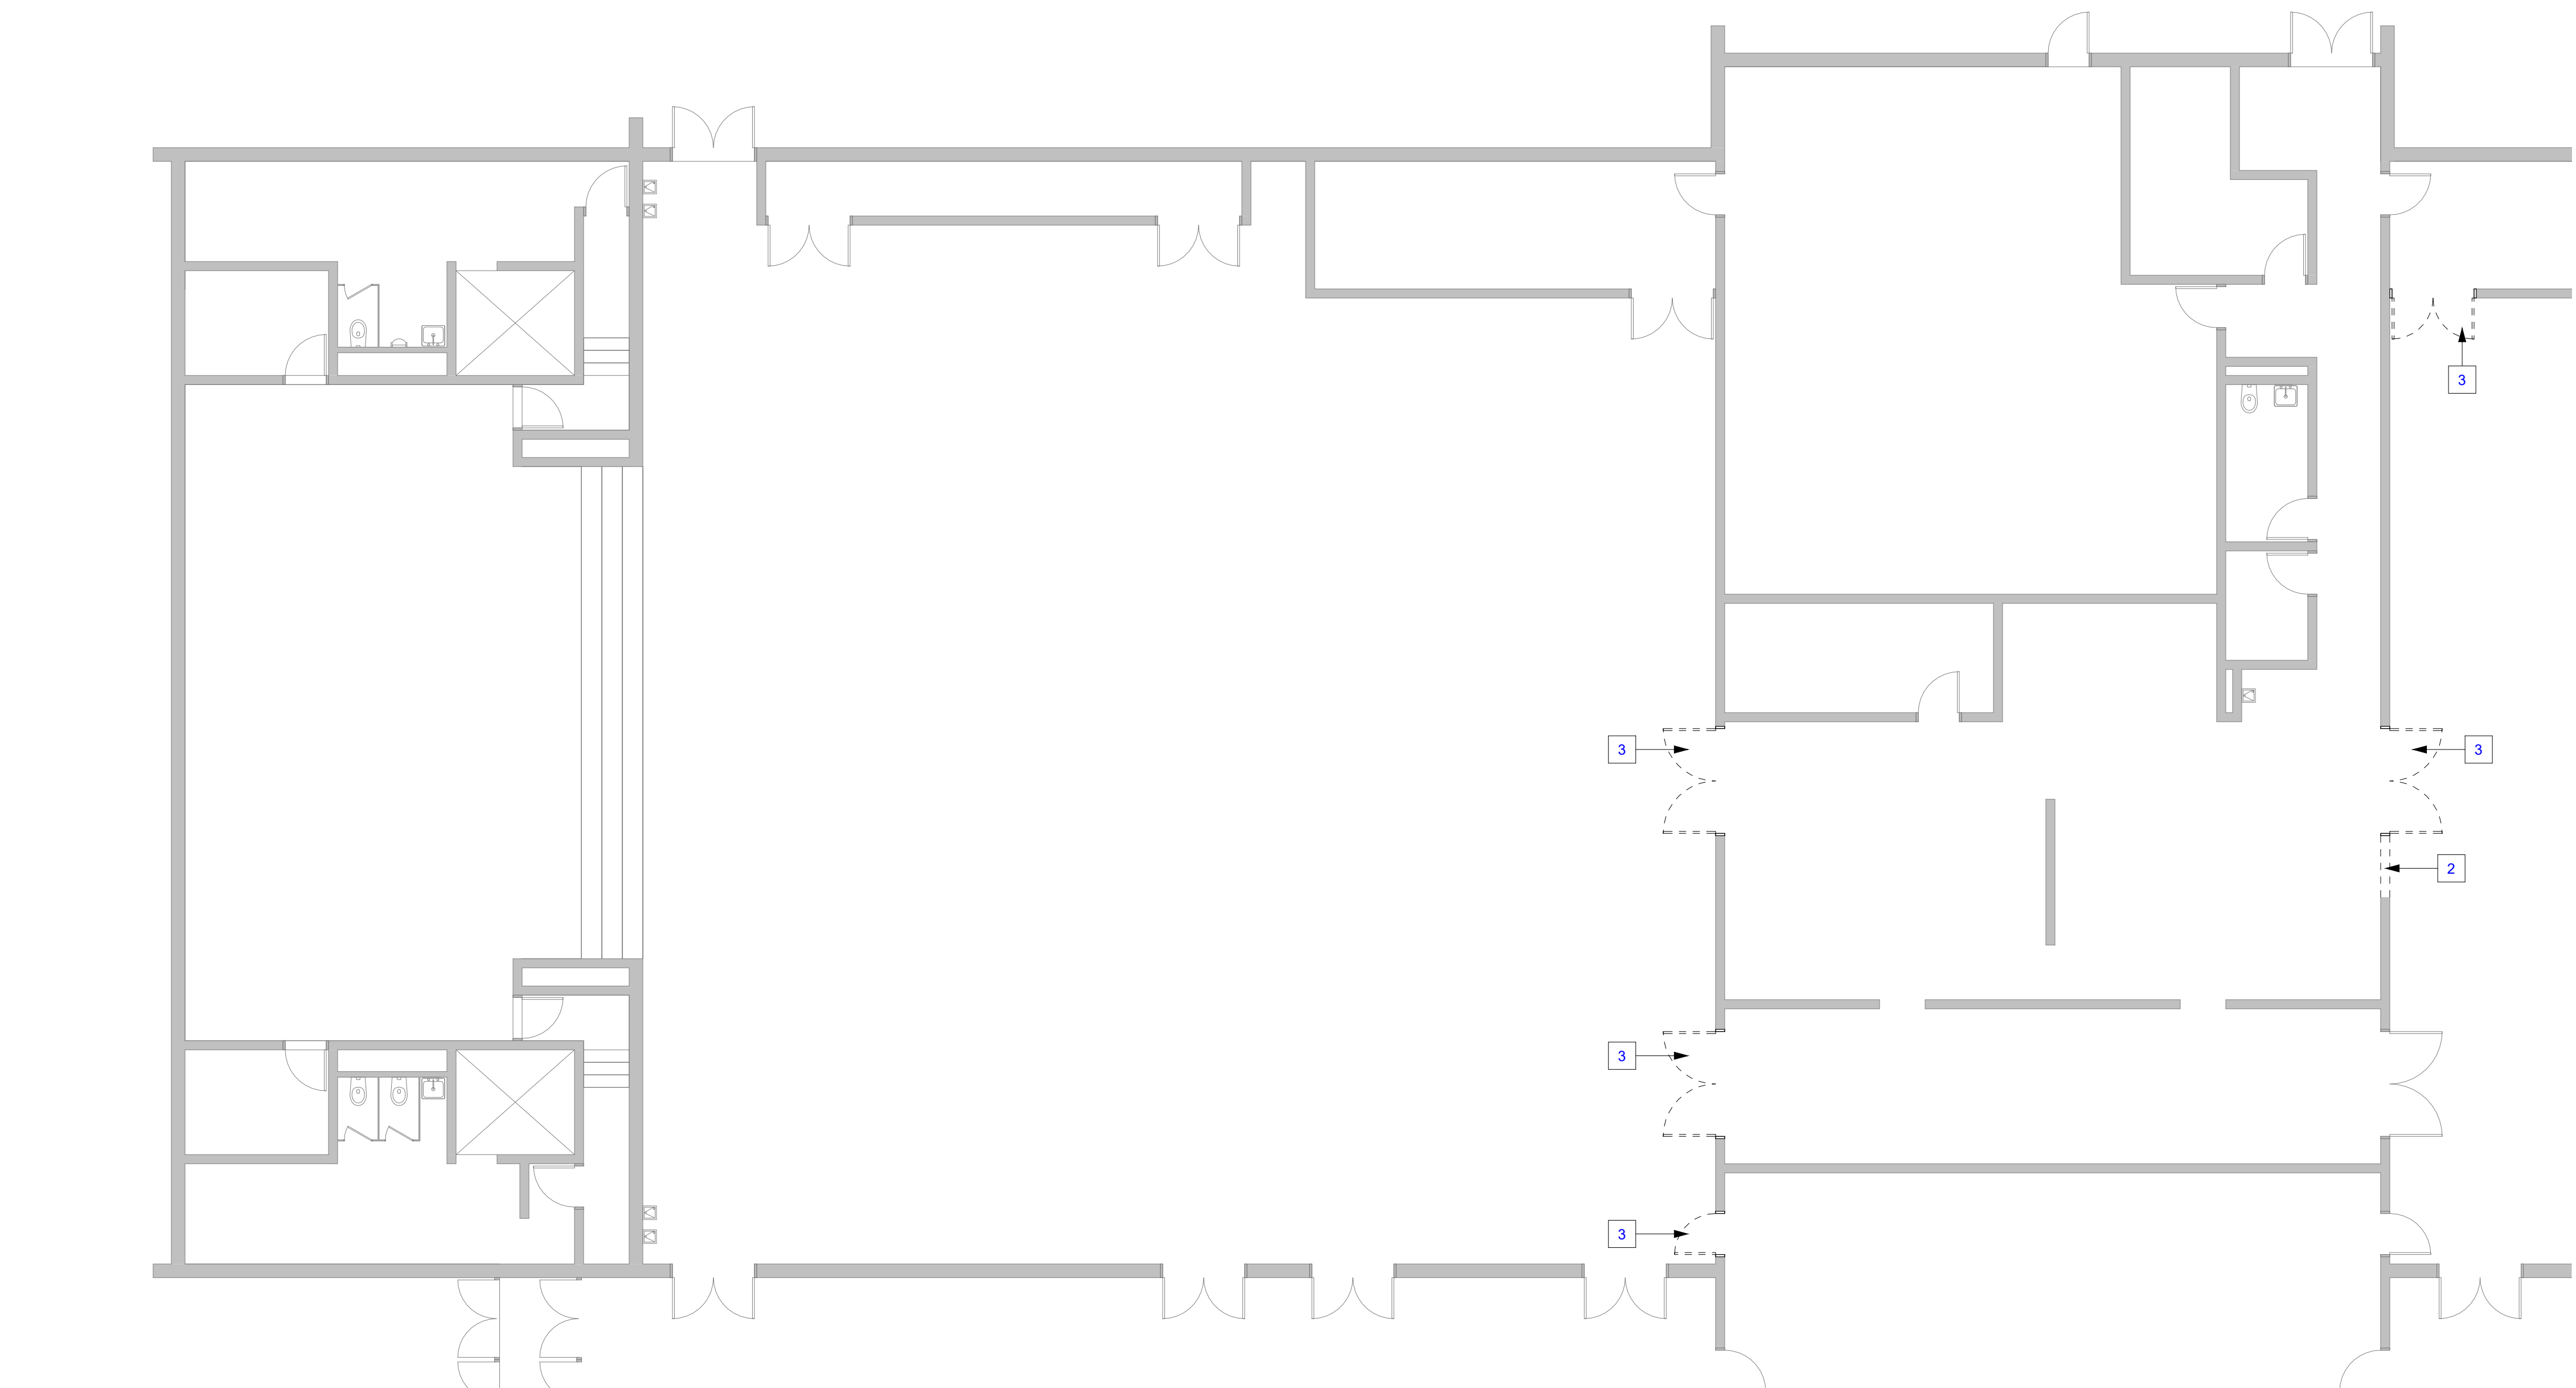


1
AD102
FIRST FLOOR DEMOLITION PLAN UNIT B1
1/8" = 1'-0"

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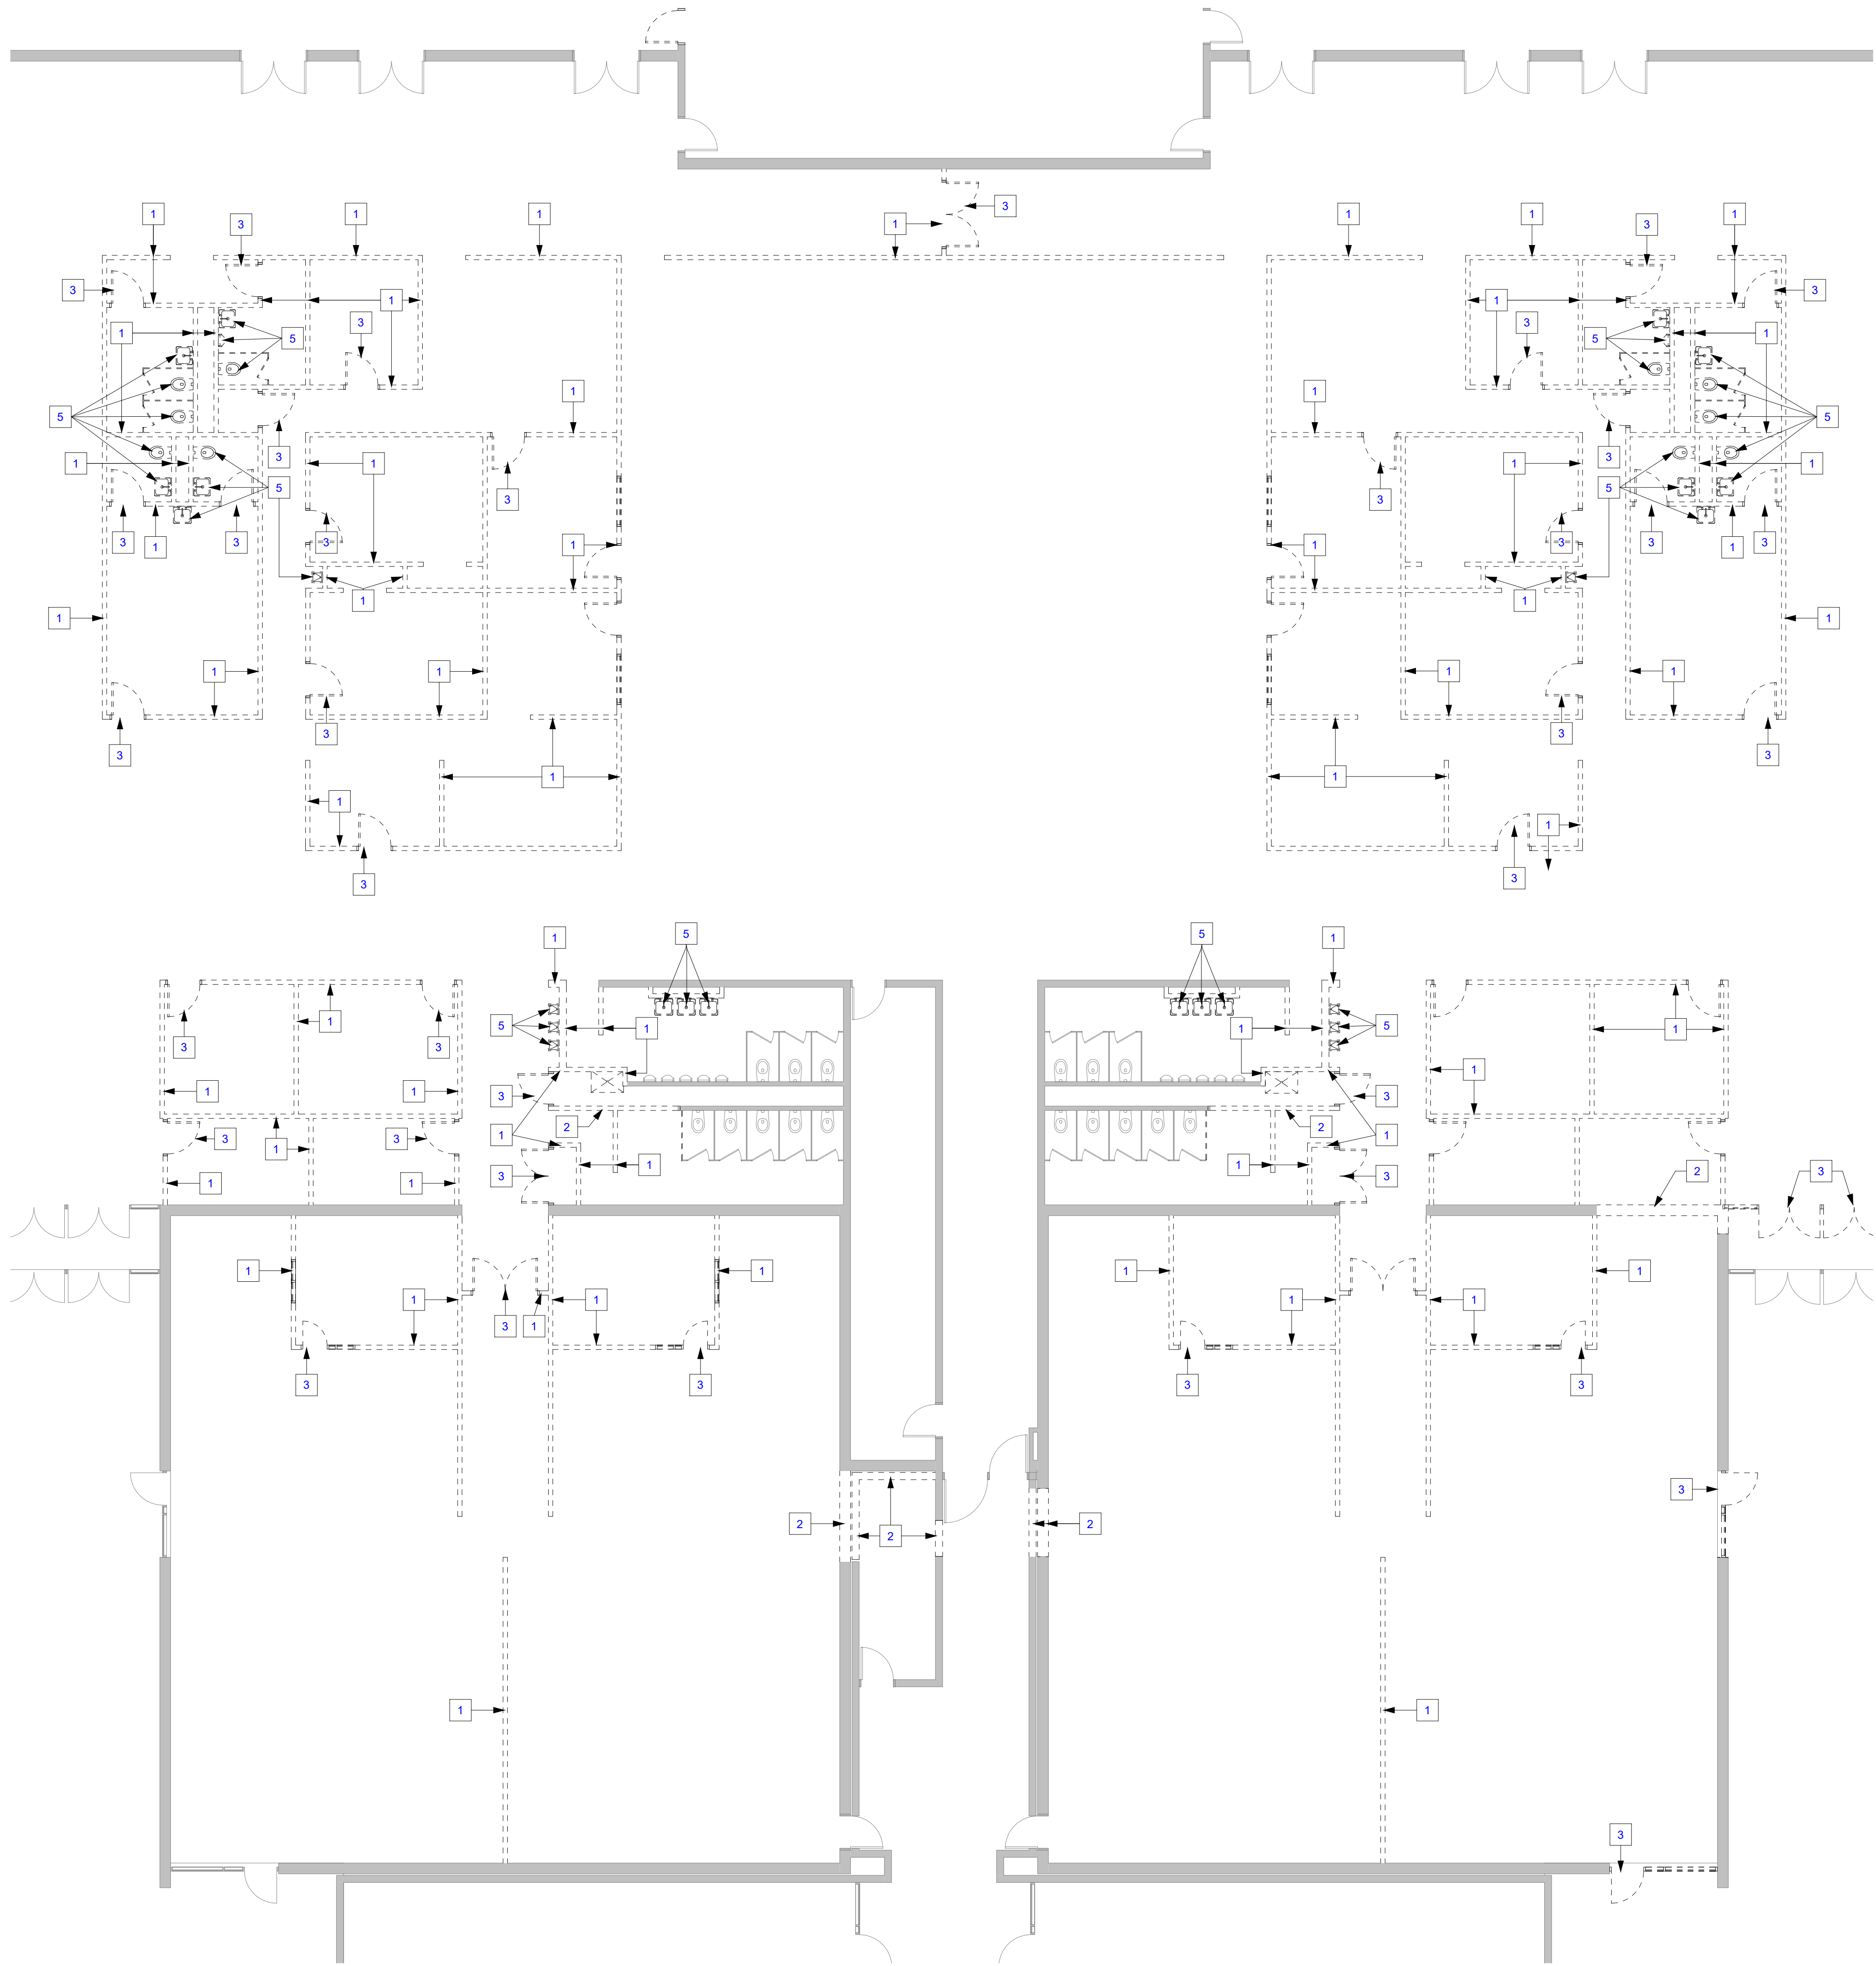


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STRUCTURAL: ENGINEERS:

Project Name: RENOVATIONS TO RUSHVILLE ELEMENTARY SCHOOL	
Drawing Title: DEMOLITION FLOOR PLAN - UNIT B	
	Client Project No:
	VPS Project No: 2023021.00
	Project Issue Date: 04/17/24
	Drawing No: AD102

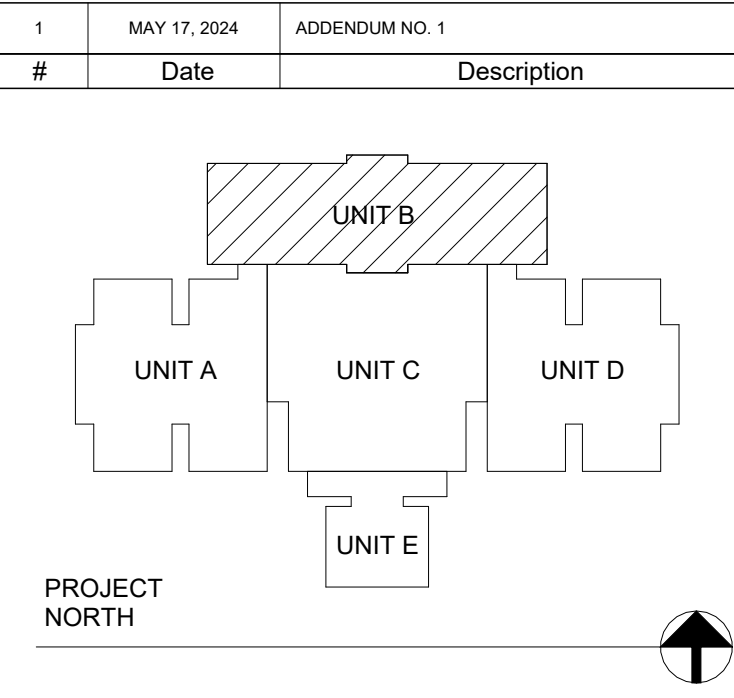


1 FIRST FLOOR DEMOLITION PLAN UNIT C
AD103 1/8" = 1'-0"

DEMOLITION NOTES	
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RENOVATIONS TO RUSHVILLE ELEMENTARY SCHOOL

Drawing Title:
DEMOLITION FLOOR PLAN - UNIT C


	Client Project No:
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- WHERE EXISTING FIRE HOSE ARE LOCATED, REMOVE THEM FROM THE CABINET AND RETURN THEM TO THE OWNER.
- WHERE NEW MILLWORK MATCHES EXISTING IS INDICATED, THE CONTRACTOR MAY INCORPORATE SALVAGE MILLWORK OF CONTRACTOR'S OPTION.
- MILLWORK DEMOLITION IS TO BE PERFORMED BY A QUALIFIED MILLWORK CARPENTER.

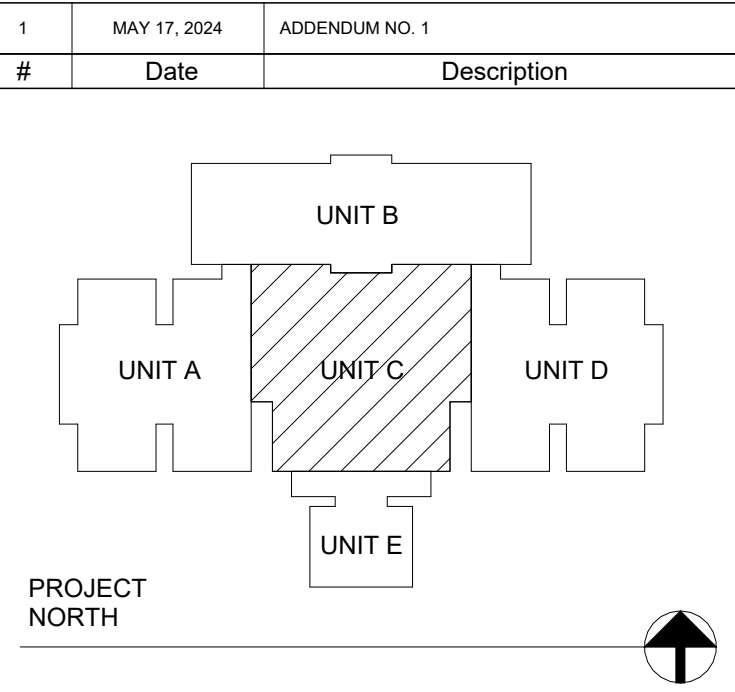

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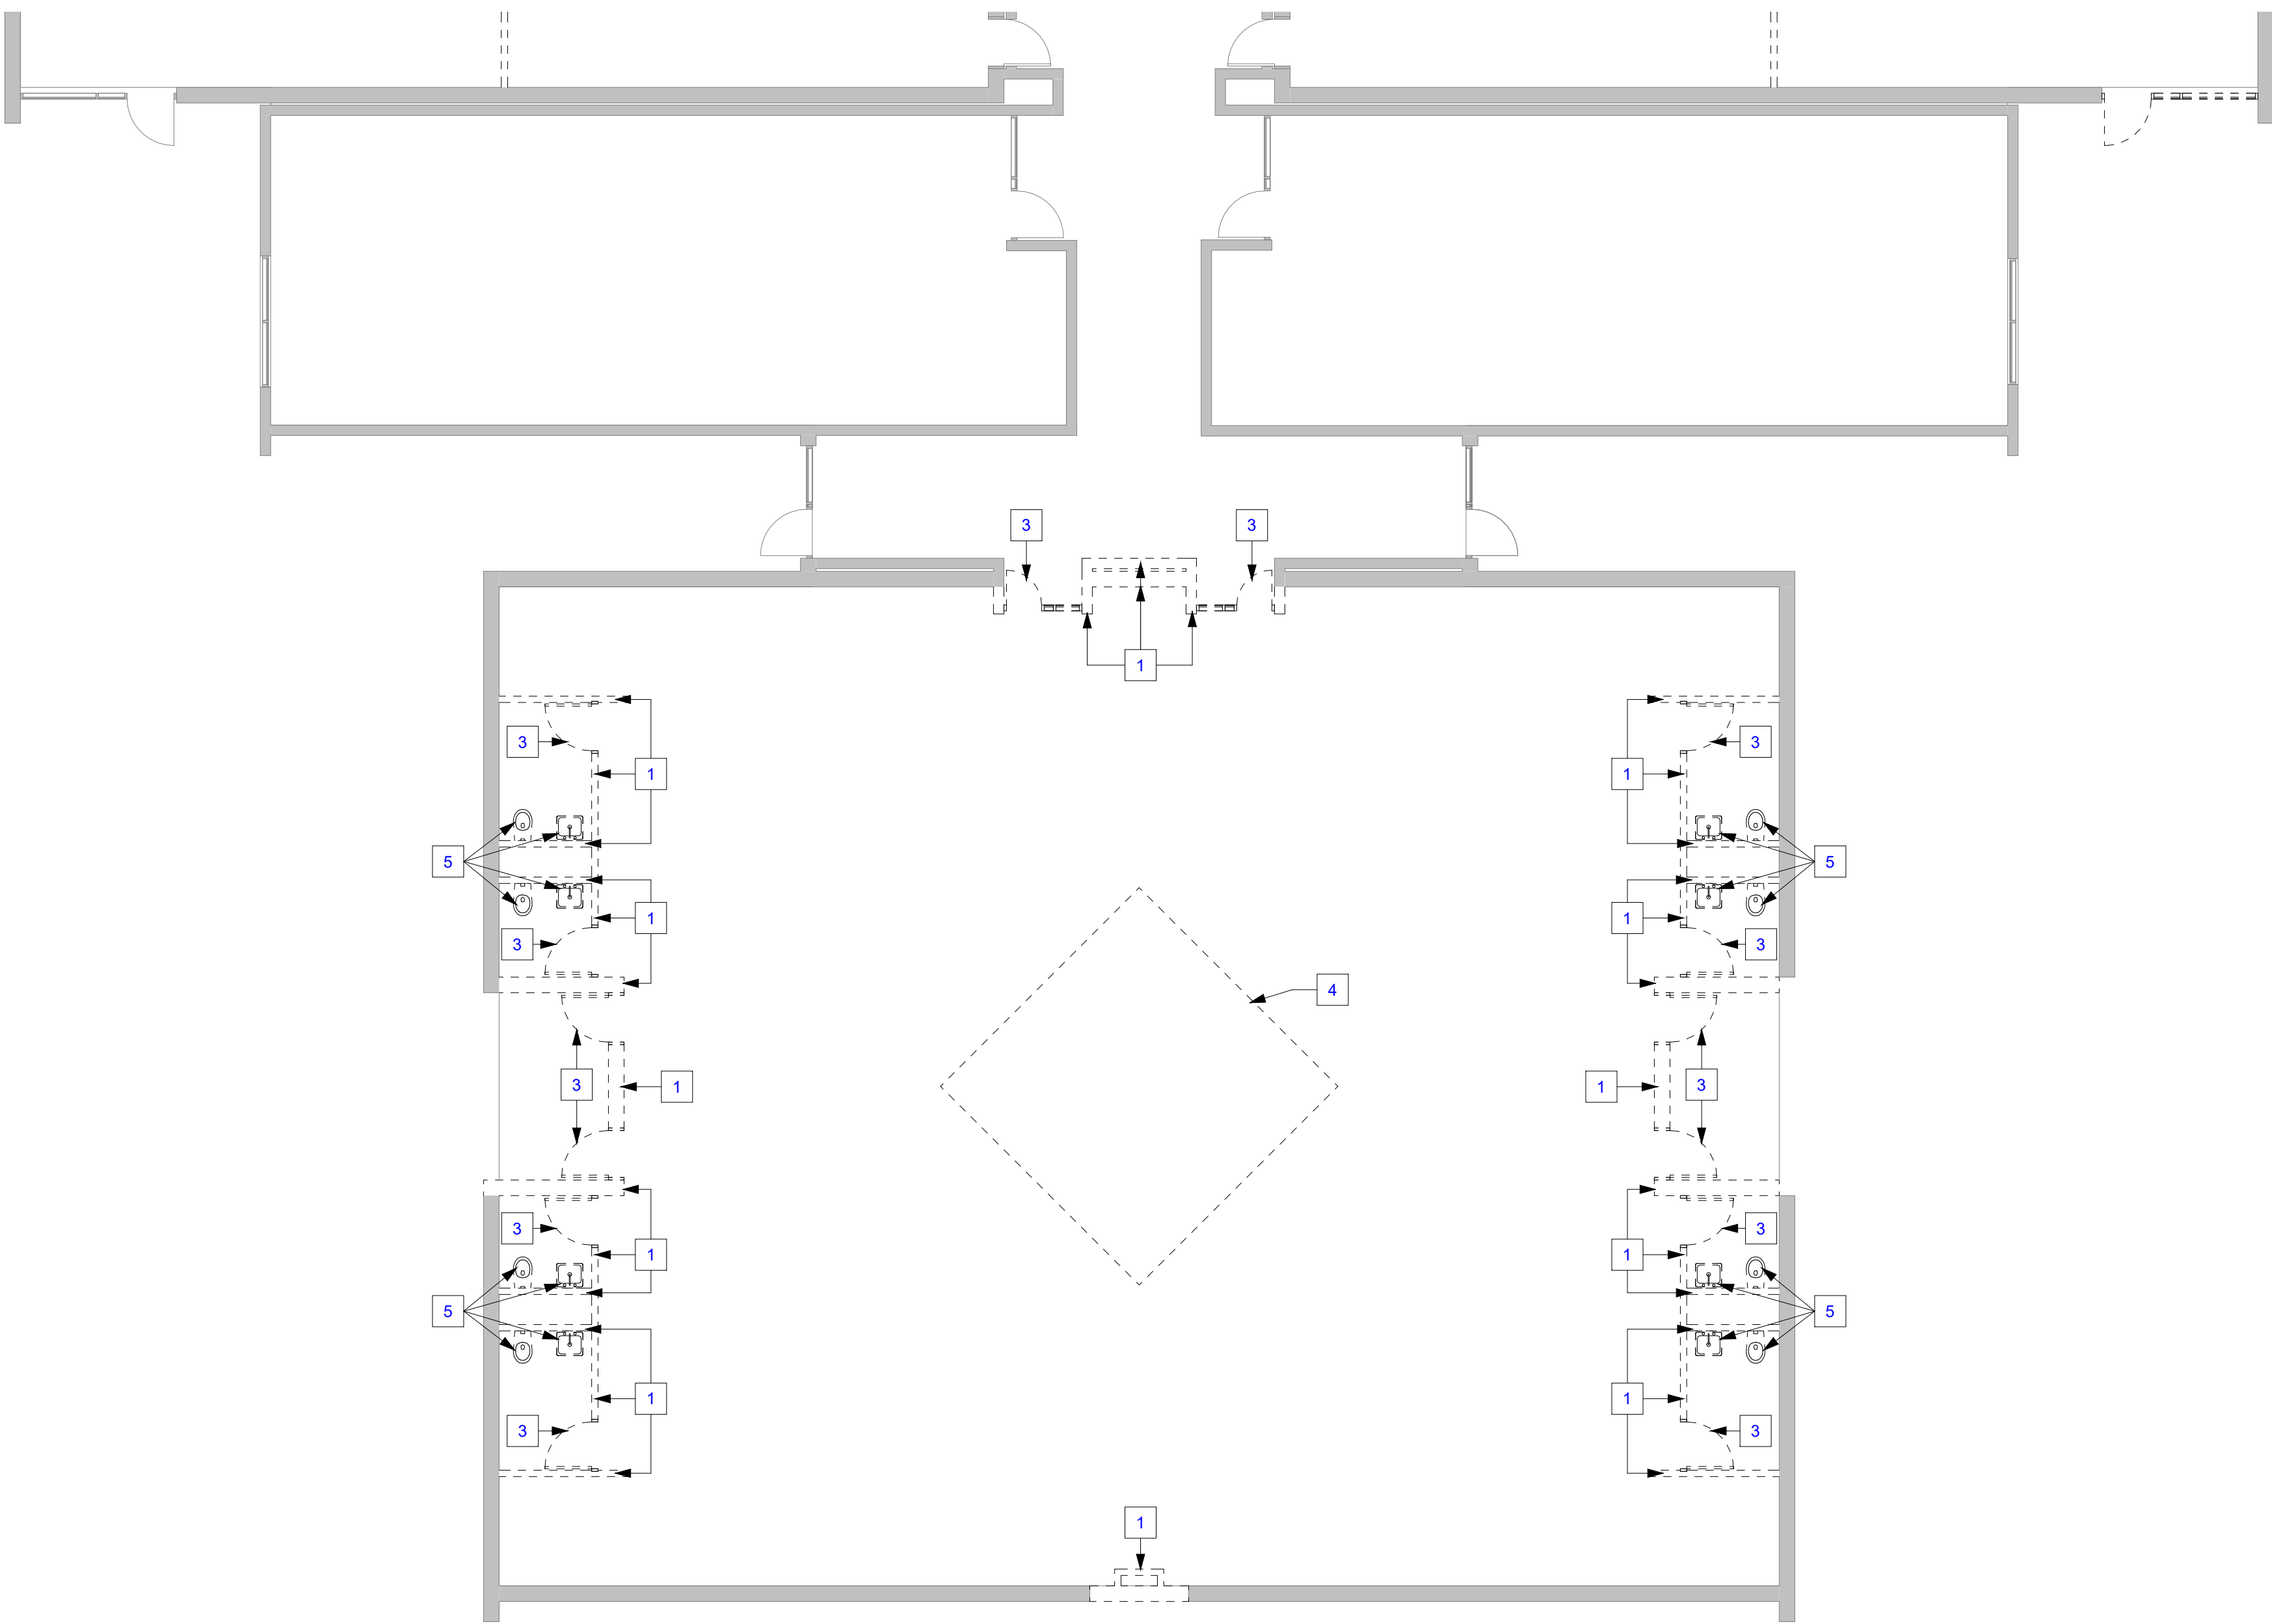
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Project Name: RENOVATIONS TO RUSHVILLE ELEMENTARY SCHOOL	
Drawing Title: DEMOLITION FLOOR PLAN - UNIT D	
	Client Project No:
	VPS Project No: 2023021.00
	Project Issue Date: 04/17/24
	Drawing No: AD104


DEMOLITION NOTES		<input type="checkbox"/>
#	KEYNOTE INFORMATION	
1	REMOVE EXISTING WALL	
2	REMOVE PORTION OF EXISTING WALL AS REQUIRED FOR NEW CONSTRUCTION	
3	REMOVE EXISTING DOOR AND FRAME	
4	REMOVE EXISTING STAGE	
5	REMOVE EXISTING PLUMBING	
7	REMOVE EXISTING CEILING	

GENERAL DEMOLITION NOTES

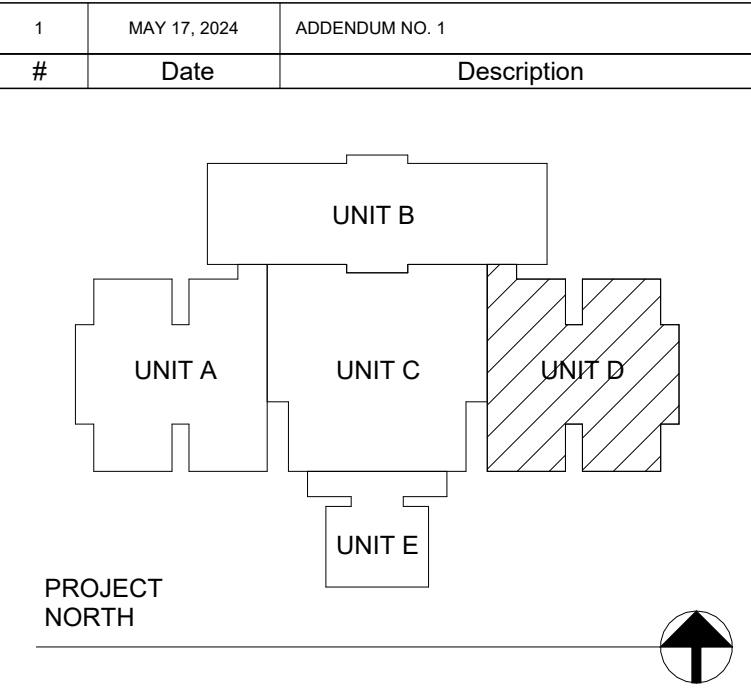- CONTRACTOR SHALL VISIT JOB SITE AND VERIFY ALL CONDITIONS SHOWN ON PLAN.
- COORDINATE DEMOLITION WITH NEW WORK INDICATED ON DRAWINGS AS WELL AS MEP DEMOLITION DRAWINGS.
- PROTECT EXISTING COLUMNS AND BEARING WALLS WHERE ADJACENT EXISTING CONSTRUCTION IS TO BE REMOVED.
- REFER TO DIVISION 1 - SECTION "CUTTING AND PATCHING" AND DECISION 2 - SECTION "SELECTIVE DEMOLITION" AS IT APPLIES TO THE WORK ON THIS DRAWING AND OTHER REMOVAL / DEMOLITION DRAWINGS.
- THE DRAWINGS ARE INTENDED TO SERVE AS A GENERAL GUIDE AND ARE NOT INTENDED TO BE INCLUSIVE OF ALL REQUIRED SELECTIVE DEMOLITION. ALL SELECTIVE DEMOLITION REQUIRED FOR COMPLETING THE NEW WORK IS PART OF THE REQUIREMENTS OF THE CONTRACT.
- REFER TO THE REMAINDER OF THE DRAWINGS FOR THE EXISTING STRUCTURAL OR BUILDING SYSTEM COMPONENTS WHICH ARE TO REMAIN OR ARE INCORPORATED INTO THE NEW WORK.
- WHERE INDICATED REMOVE FINISH DOWN TO SUBSTRATE. PREPARE SURFACE WHERE SCHEDULED TO RECEIVE NEW CONSTRUCTION AND/OR FINISHES.
- SEE MEP DRAWINGS FOR SPECIFIC DEMOLITION REQUIREMENTS. AT MINIMUM, ALL MEP INFRASTRUCTURE THAT IS NOT COMPLETELY REMOVED BACK TO THE NEAREST RESPECTIVE BRANCH, MAIN, RISER, JUNCTION BOX, PANEL, ETC. AND CAPPED. REMOVE AND PATCH WALLS AS REQUIRED FOR MEP GENERAL DEMOLITION. ALL GENERAL REQUIRED TO COMPLETE MEP IS PART OF THE WORK.
- WHERE EXISTING MATERIALS OR SYSTEMS ARE TO BE REUSED IN NEW CONSTRUCTION OR ARE TO REMAIN IN PLACE PROTECT SUCH MATERIALS AND SYSTEMS SO THAT THEY MAY BE CONTINUED IN OR RETURNED TO NORMAL SERVICE. RESTORE EXISTING "WORK TO REMAIN" TO NORMAL SERVICE. RESTORE EXISTING "WORK TO REMAIN" WHICH IS DAMAGED BY THE OPERATIONS OF THE CONTRACT TO THE LEVEL OF SERVICEABILITY AND APPEARANCE WHICH EXISTED BEFORE THE DAMAGE OCCURRED.
- THE OWNER HAS THE FIRST RIGHT OF REFUSAL ON ALL REMOVED ITEMS. SALVAGE AND DELIVER TO THE OWNER ITEM INDICATED ON THE PLANS OR REQUESTED BY OWNERS.
- EXISTING ELEVATOR SIGNAGE AND ANY ASSOCIATED SIGNAGE AT BOTH PASSENGER AND FREIGHT ELEVATORS SHALL REMAIN. PROTECT FROM DAMAGE THROUGH COMPLETION OF WORK.
- WHERE FEC ARE LOCATED IN PARTITION INDICATED TO BE DEMOLISHED, SALVAGED, AND RETURNED OVER TO THE OWNER.
- WHERE CUTTING, DEMOLITION, OR OTHER REMOVAL OF EXISTING FEATURES OCCURS, PATCH EXISTING SURFACES THAT REMAIN TO MATCH ADJACENT AND AS REQUIRED TO RECEIVE NEW WORK AND/OR NEW FINISHES.
- REMOVE EXISTING LAY-IN CEILINGS, LIGHTS, DIFFUSERS, GYPSUM BOARD CEILINGS, BULKHEADS CARPET, TILE, ETC. NOT REQUIRED IN COMPLETED NEW WORK OR NOT INDICATED TO REMAIN.
- WHERE CUTTING, DEMOLITION OR OTHER REMOVAL OF EXISTING FEATURES OCCUR, PATCH EXISTING SURFACES WHICH REMAIN TO RESTORE TO ORIGINAL CONDITION AND AS REQUIRED TO RECEIVE NEW WORK, AND/OR NEW FINISH.
- PATCH ALL HOLES IN FLOOR NOT NEEDED FOR NEW WORK TO MAINTAIN. SEE SPECIFICATION 017310 CUTTING AND PATCHING, SPECIFICATION 024119 SELECTIVE DEMOLITION AND SPECIFICATION 033053 MISC. CAST-IN-PLACE CONCRETE. WHERE EXISTING FLOOR FINISH OR FLOOR DRAINS ARE INDICATED TO BE REMOVED, PATCH EXISTING CONCRETE FLOORS WITH TROWABLE LEVELING AND PATCHING COMPOUNDS ARE REQUIRED TO PREPARE THE SURFACE TO RECEIVE A NEW FLOOR FINISH.
- WHEN THERE IS DEMOLITION OF EXISTING MASONRY PARTITIONS, SAW TOOTH NEW INTO EXISTING TO PROVIDE FINISHED SURFACE READY TO RECEIVE NEW CONSTRUCTION. PATCH PLASTER AS REQUIRED.
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- WHERE NEW MILLWORK MATCHES EXISTING IS INDICATED, THE CONTRACTOR MAY INCORPORATE SALVAGE MILLWORK OF CONTRACTOR'S OPTION.
- MILLWORK DEMOLITION IS TO BE PERFORMED BY A QUALIFIED MILLWORK CARPENTER.



1 FIRST FLOOR DEMOLITION PLAN UNIT E
AD105 1/8" = 1'-0"

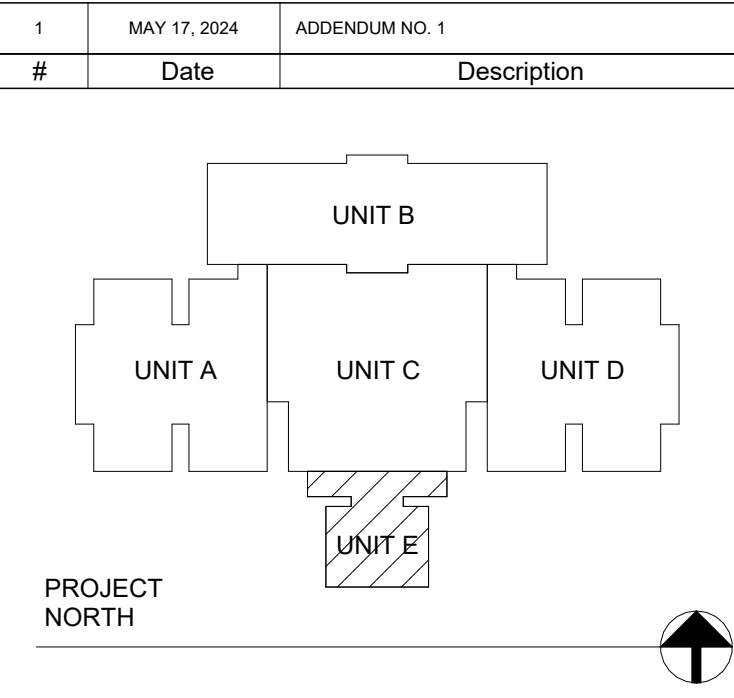

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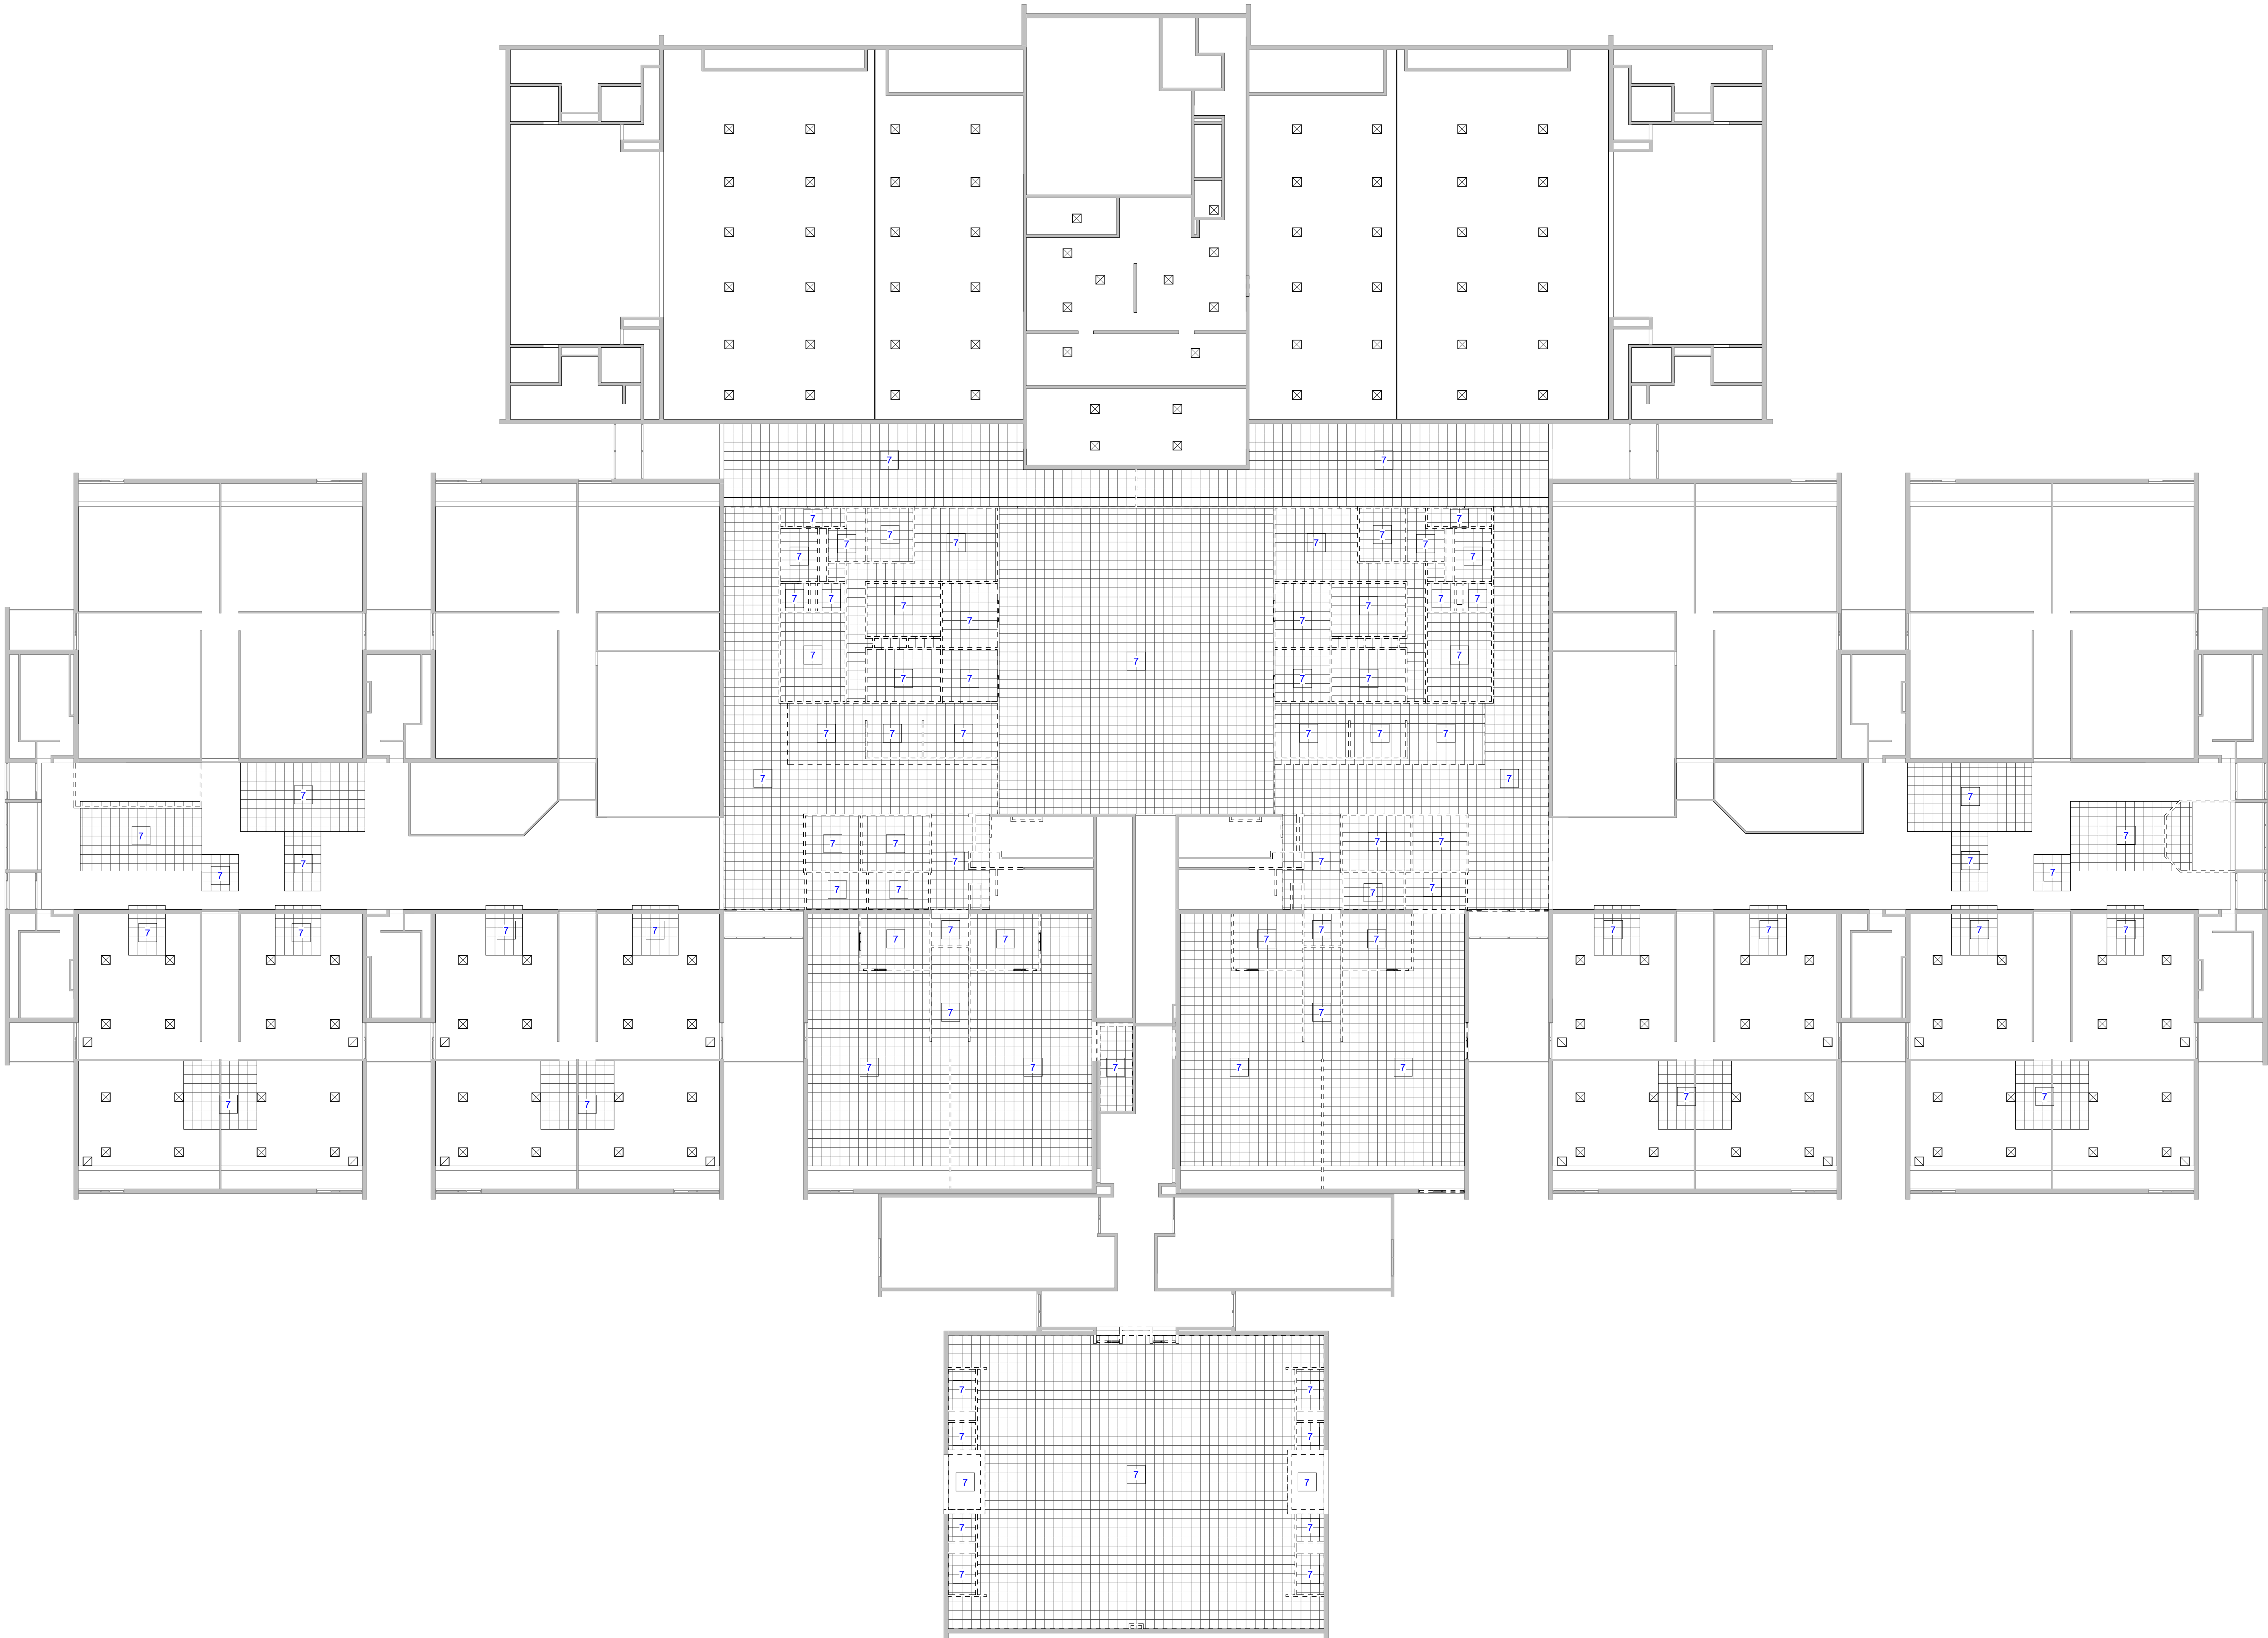
STRUCTURAL: ENGINEERS:

Project Name: RENOVATIONS TO RUSHVILLE ELEMENTARY SCHOOL	
Drawing Title: DEMOLITION FLOOR PLAN - UNIT E	
	Client Project No:
	VPS Project No: 2023021.00
	Project Issue Date: 04/17/24
	Drawing No: AD105


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#	KEYNOTE INFORMATION	
1	REMOVE EXISTING WALL	
2	REMOVE PORTION OF EXISTING WALL AS REQUIRED FOR NEW CONSTRUCTION	
3	REMOVE EXISTING DOOR AND FRAME	
4	REMOVE EXISTING STAGE	
5	REMOVE EXISTING PLUMBING	
7	REMOVE EXISTING CEILING	

GENERAL DEMOLITION NOTES

- CONTRACTOR SHALL VISIT JOB SITE AND VERIFY ALL CONDITIONS SHOWN ON PLAN.
- COORDINATE DEMOLITION WITH NEW WORK INDICATED ON DRAWINGS AS WELL AS MEP DEMOLITION DRAWINGS.
- PROTECT EXISTING COLUMNS AND BEARING WALLS WHERE ADJACENT EXISTING CONSTRUCTION IS TO BE REMOVED.
- REFER TO DIVISION 1 - SECTION "CUTTING AND PATCHING" AND DECISION 2 - SECTION "SELECTIVE DEMOLITION" AS IT APPLIES TO THE WORK ON THIS DRAWING AND OTHER REMOVAL / DEMOLITION DRAWINGS.
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- REFER TO THE REMAINDER OF THE DRAWINGS FOR THE EXISTING STRUCTURAL OR BUILDING SYSTEM COMPONENTS WHICH ARE TO REMAIN OR ARE INCORPORATED INTO THE NEW WORK.
- WHERE INDICATED REMOVE FINISH DOWN TO SUBSTRATE, PREPARE SURFACE WHERE SCHEDULED TO RECEIVE NEW CONSTRUCTION AND/OR FINISHES.
- SEE MEP DRAWINGS FOR SPECIFIC DEMOLITION REQUIREMENTS. AT MINIMUM, ALL MEP INFRASTRUCTURE THAT IS NOT COMPLETELY REMOVED BACK TO THE NEAREST RESPECTIVE BRANCH, MAIN, RISER, JUNCTION BOX, PANEL, ETC. AND CARPET, REMOVE AND PATCH WALLS AS REQUIRED FOR MEP GENERAL DEMOLITION. ALL GENERAL REQUIRED TO COMPLETE MEP IS PART OF THE WORK.
- WHERE EXISTING MATERIALS OR SYSTEMS ARE TO BE REUSED IN NEW CONSTRUCTION OR ARE TO REMAIN IN PLACE PROTECT SUCH MATERIALS AND SYSTEMS SO THAT THEY MAY BE CONTINUED IN OR RETURNED TO NORMAL SERVICE. RESTORE EXISTING "WORK TO REMAIN" WHICH IS DAMAGED BY THE OPERATIONS OF THE CONTRACT TO THE LEVEL OF SERVICEABILITY AND APPEARANCE WHICH EXISTED BEFORE THE DAMAGE OCCURRED.
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- REMOVE EXISTING LAY-IN CEILINGS, LIGHTS, DIFFUSERS, GYPSUM BOARD CEILINGS, BULKHEADS CARPET, TILE, ETC. NOT REQUIRED IN COMPLETED NEW WORK OR NOT INDICATED TO REMAIN.
- WHERE CUTTING, DEMOLITION OR OTHER REMOVAL OF EXISTING FEATURES OCCUR, PATCH EXISTING SURFACES WHICH REMAIN TO RESTORE TO ORIGINAL CONDITION AND AS REQUIRED TO RECEIVE NEW WORK, AND/OR NEW FINISH.
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- WHEN THERE IS DEMOLITION OF EXISTING MASONRY PARTITIONS, SAW TOOTH NEW INTO EXISTING TO PROVIDE FINISHED SURFACE READY TO RECEIVE NEW CONSTRUCTION. PATCH PLASTER AS REQUIRED.
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- WHERE NEW MILLWORK MATCHES EXISTING IS INDICATED, THE CONTRACTOR MAY INCORPORATE SALVAGE MILLWORK OF CONTRACTOR'S OPTION.
- MILLWORK DEMOLITION IS TO BE PERFORMED BY A QUALIFIED MILLWORK CARPENTER.



1 FIRST FLOOR DEMOLITION CEILING PLAN
AD201 1/16" = 1'-0"

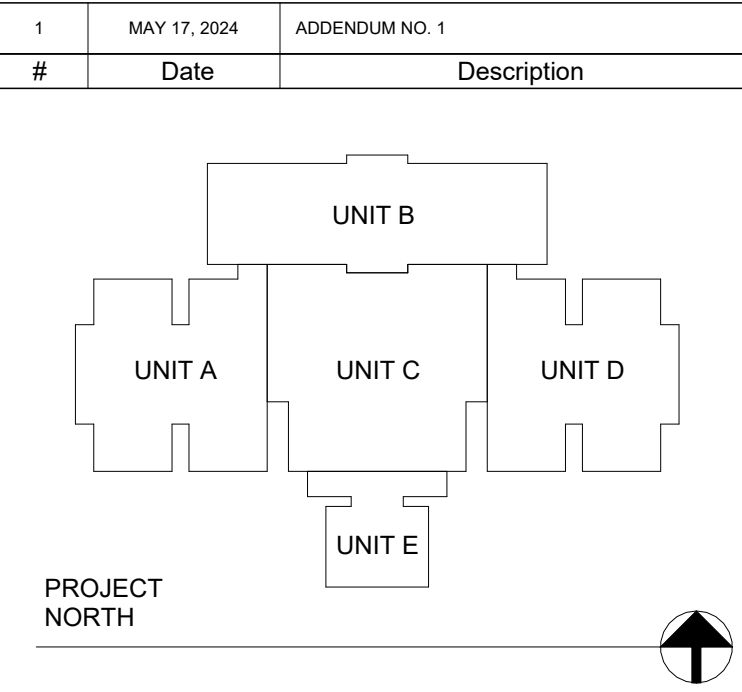

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STRUCTURAL: ENGINEERS:


Project Name:
RENOVATIONS TO RUSHVILLE ELEMENTARY SCHOOL

Drawing Title:
DEMOLITION CEILING PLAN

Client Project No:
VPS Project No: **2023021.00**
Project Issue Date: **04/17/24**
Drawing No: **AD201**


ARCHITECTURE PLAN NOTES	
#	KEYNOTE INFORMATION
1	ALT. 1. RENOVATE THE LIFE SKILLS ROOMS E102, E103, E104, AND E105
2	ALT. 2. COMPLETE THE FINISH WORK IN CAFETERIA B101
3	ALT. 3. FURNISH AND INSTALL A NEW SYNTHETIC FLOOR AND FINISHES IN GYMNASIUM B102
4	ALT. 4. CONSTRUCT THE STAFF RESTROOMS A106, A107, D106, AND D107
5	ALT. 5. CONSTRUCT WORKROOMS A113 AND D113
6	ALT. 6. RENOVATE RESTROOMS C115 AND C116
7	ALT. 7. RENOVATION AND REORGANIZATION OF THE KITCHEN PREP AREA, INCLUDED IN THIS WORK IS THE REUSE OF EXISTING EQUIPMENT, AS WELL AS FURNISHING NEW EQUIPMENT.
8	ALT. 8. INSTALL LVT WALL COVERING TO MAIN CORRIDORS AS INDICATED IN DRAWINGS

- GENERAL FLOOR PLAN NOTES**
- NOTE: GENERAL NOTES LISTED BELOW REFER TO ALL SHEETS CONTAINED IN THIS SET.
- FIELD VERIFY ALL EXISTING CONDITIONS, NOTIFY THE ARCHITECT/ENGINEER IMMEDIATELY OF ANY DISCREPANCIES THAT EXIST.
 - CONSTRUCTION AND INSTALLATIONS SHALL CONFORM, TO ALL FEDERAL, STATE, AND LOCAL ORDINANCES, CODES, ETC.
 - ALL DIMENSIONS ON FLOOR PLANS ARE FROM THE FACE OF FINISH GYPSUM BOARD, FACE OF MASONRY, FACE OF CONCRETE, FACE OF EXISTING WALL OR CENTERLINE OF COLUMNS, UNLESS NOTED OTHERWISE.
 - GYPSUM BOARD WALLS NOT REQUIRED TO EXTEND TO THE BOTTOM OF THE STRUCTURE ABOVE SHALL TERMINATE 6" ABOVE THE HIGHEST ADJOINING CEILING AND SHALL BE BRACED EITHER BY ATTACHING ALTERNATING DIAGONAL STUDS 48" O.C. FROM TOP OF WALL TO STRUCTURE OR BY EXISTING WALL STUDS TO STRUCTURE ABOVE.
 - PROVIDE WOOD BLOCKING IN WALLS AND CEILINGS AS REQUIRED FOR INSTALLATION OF CASEWORK OR OTHER SURFACE-MOUNTED ACCESSORIES.
 - ALL CHASE WALLS SHALL BE 3 5/8" METAL STUDS @ 16" O.C WITH 5/8" GYPSUM BOARD ON ONE SIDE UNLESS NOTED OTHERWISE.

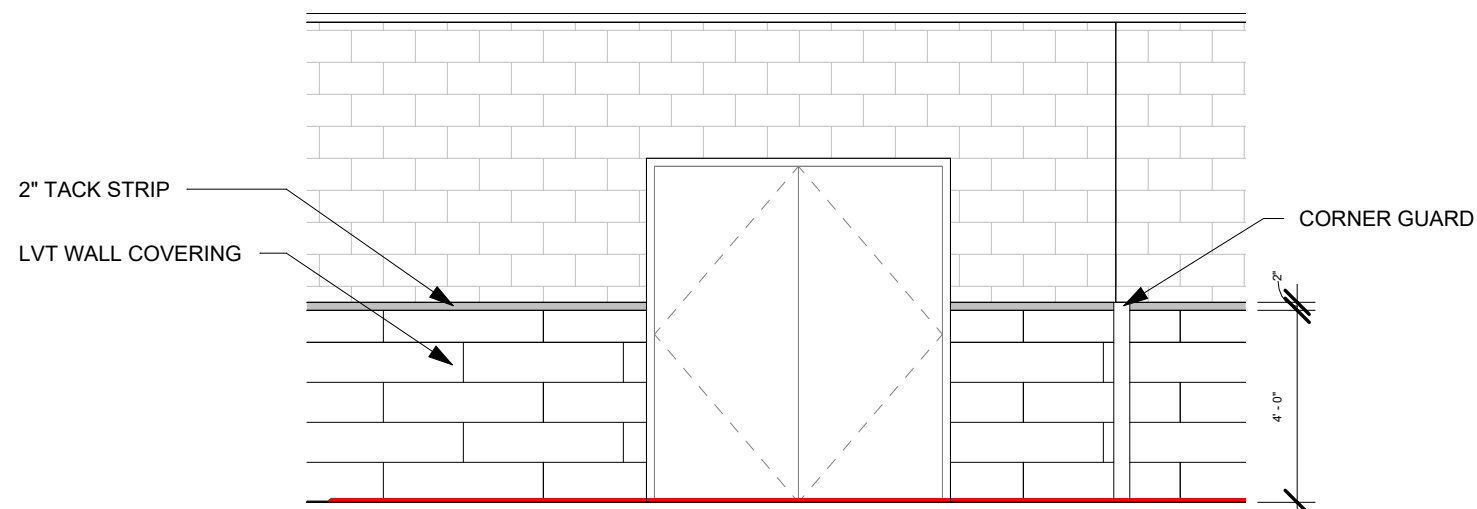

1 FIRST FLOOR OVERALL PLAN
1/16" = 1'-0"

2 ALT #10 LVT WALL COVERING ELEVATION
1/4" = 1'-0"

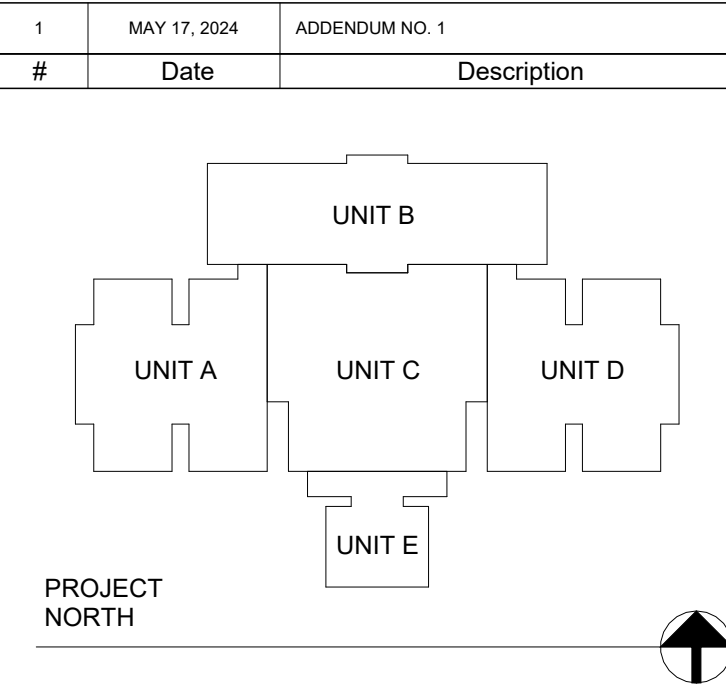

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STRUCTURAL: ENGINEERS:

Project Name:
RENOVATIONS TO RUSHVILLE ELEMENTARY SCHOOL

Drawing Title:
OVERALL FLOOR PLAN

Client Project No:
VPS Project No: 2023021.00
Project Issue Date: 04/17/24
Drawing No: A100

ARCHITECTURE PLAN NOTES	
#	KEYNOTE INFORMATION
1	ALT. 1. RENOVATE THE LIFE SKILLS ROOMS E102, E103, E104, AND E105
2	ALT. 2. COMPLETE THE FINISH WORK IN CAFETERIA B101
3	ALT. 3. FURNISH AND INSTALL A NEW SYNTHETIC FLOOR AND FINISHES IN GYMNASIUM B102
4	ALT. 4. CONSTRUCT THE STAFF RESTROOMS A106, A107, D106, AND D107
5	ALT. 5. CONSTRUCT WORKROOMS A113 AND D113
6	ALT. 6. RENOVATE RESTROOMS C115 AND C116
7	ALT. 7. RENOVATION AND REORGANIZATION OF THE KITCHEN PREP AREA. INCLUDED IN THIS WORK IS THE REUSE OF EXISTING EQUIPMENT, AS WELL AS FURNISHING NEW EQUIPMENT.
8	ALT. 8. INSTALL LVT WALL COVERING TO MAIN CORRIDORS AS INDICATED IN DRAWINGS


GENERAL FLOOR PLAN NOTES

NOTE: GENERAL NOTES LISTED BELOW REFER TO ALL SHEETS CONTAINED IN THIS SET.

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- GYPSUM BOARD WALLS NOT REQUIRED TO EXTEND TO THE BOTTOM OF THE STRUCTURE ABOVE SHALL TERMINATE 6" ABOVE THE HIGHEST ADJOINING CEILING AND SHALL BE BRACED EITHER BY ATTACHING ALTERNATING DIAGONAL STUDS 48" O.C. FROM TOP OF WALL TO STRUCTURE OR BY EXISTING WALL STUDS TO STRUCTURE ABOVE.
- PROVIDE WOOD BLOCKING IN WALLS AND CEILINGS AS REQUIRED FOR INSTALLATION OF CASEWORK OR OTHER SURFACE-MOUNTED ACCESSORIES.
- ALL CHASE WALLS SHALL BE 3 5/8" METAL STUDS @ 16" O.C WITH 5/8" GYPSUM BOARD ON ONE SIDE UNLESS NOTED OTHERWISE.



1 FIRST FLOOR NEW CONSTRUCTION PLAN UNIT A
A101 1/8" = 1'-0"

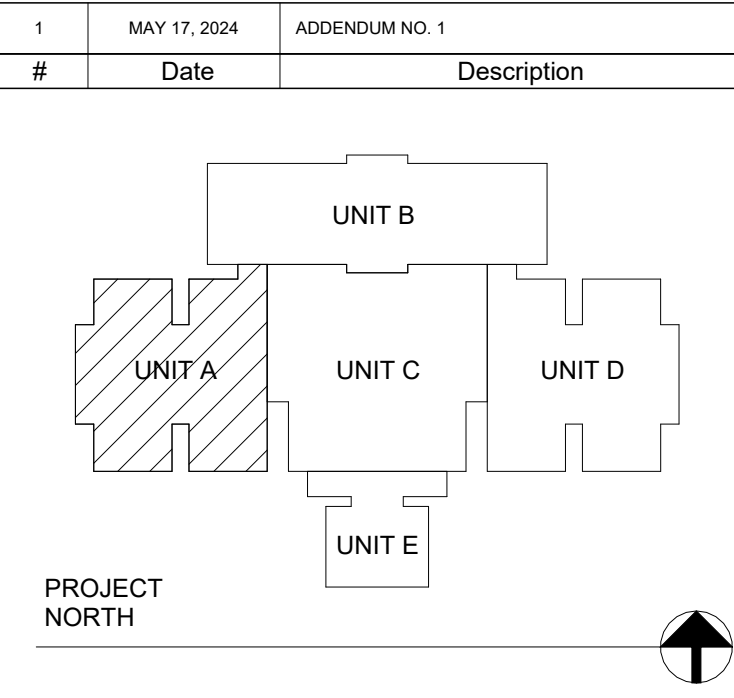


VPS ARCHITECTURE
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905 North Capitol Avenue - Suite 100 Indianapolis, Indiana 46204
PH: (317) 353-3281 www.VPSARCH.com

STRUCTURAL: ENGINEERS:


Project Name:
RENOVATIONS TO RUSHVILLE ELEMENTARY SCHOOL

Drawing Title:
ARCHITECTURAL FLOOR PLAN - UNIT A

	Client Project No:
	VPS Project No: 2023021.00
	Project Issue Date: 04/17/24
	Drawing No: A101

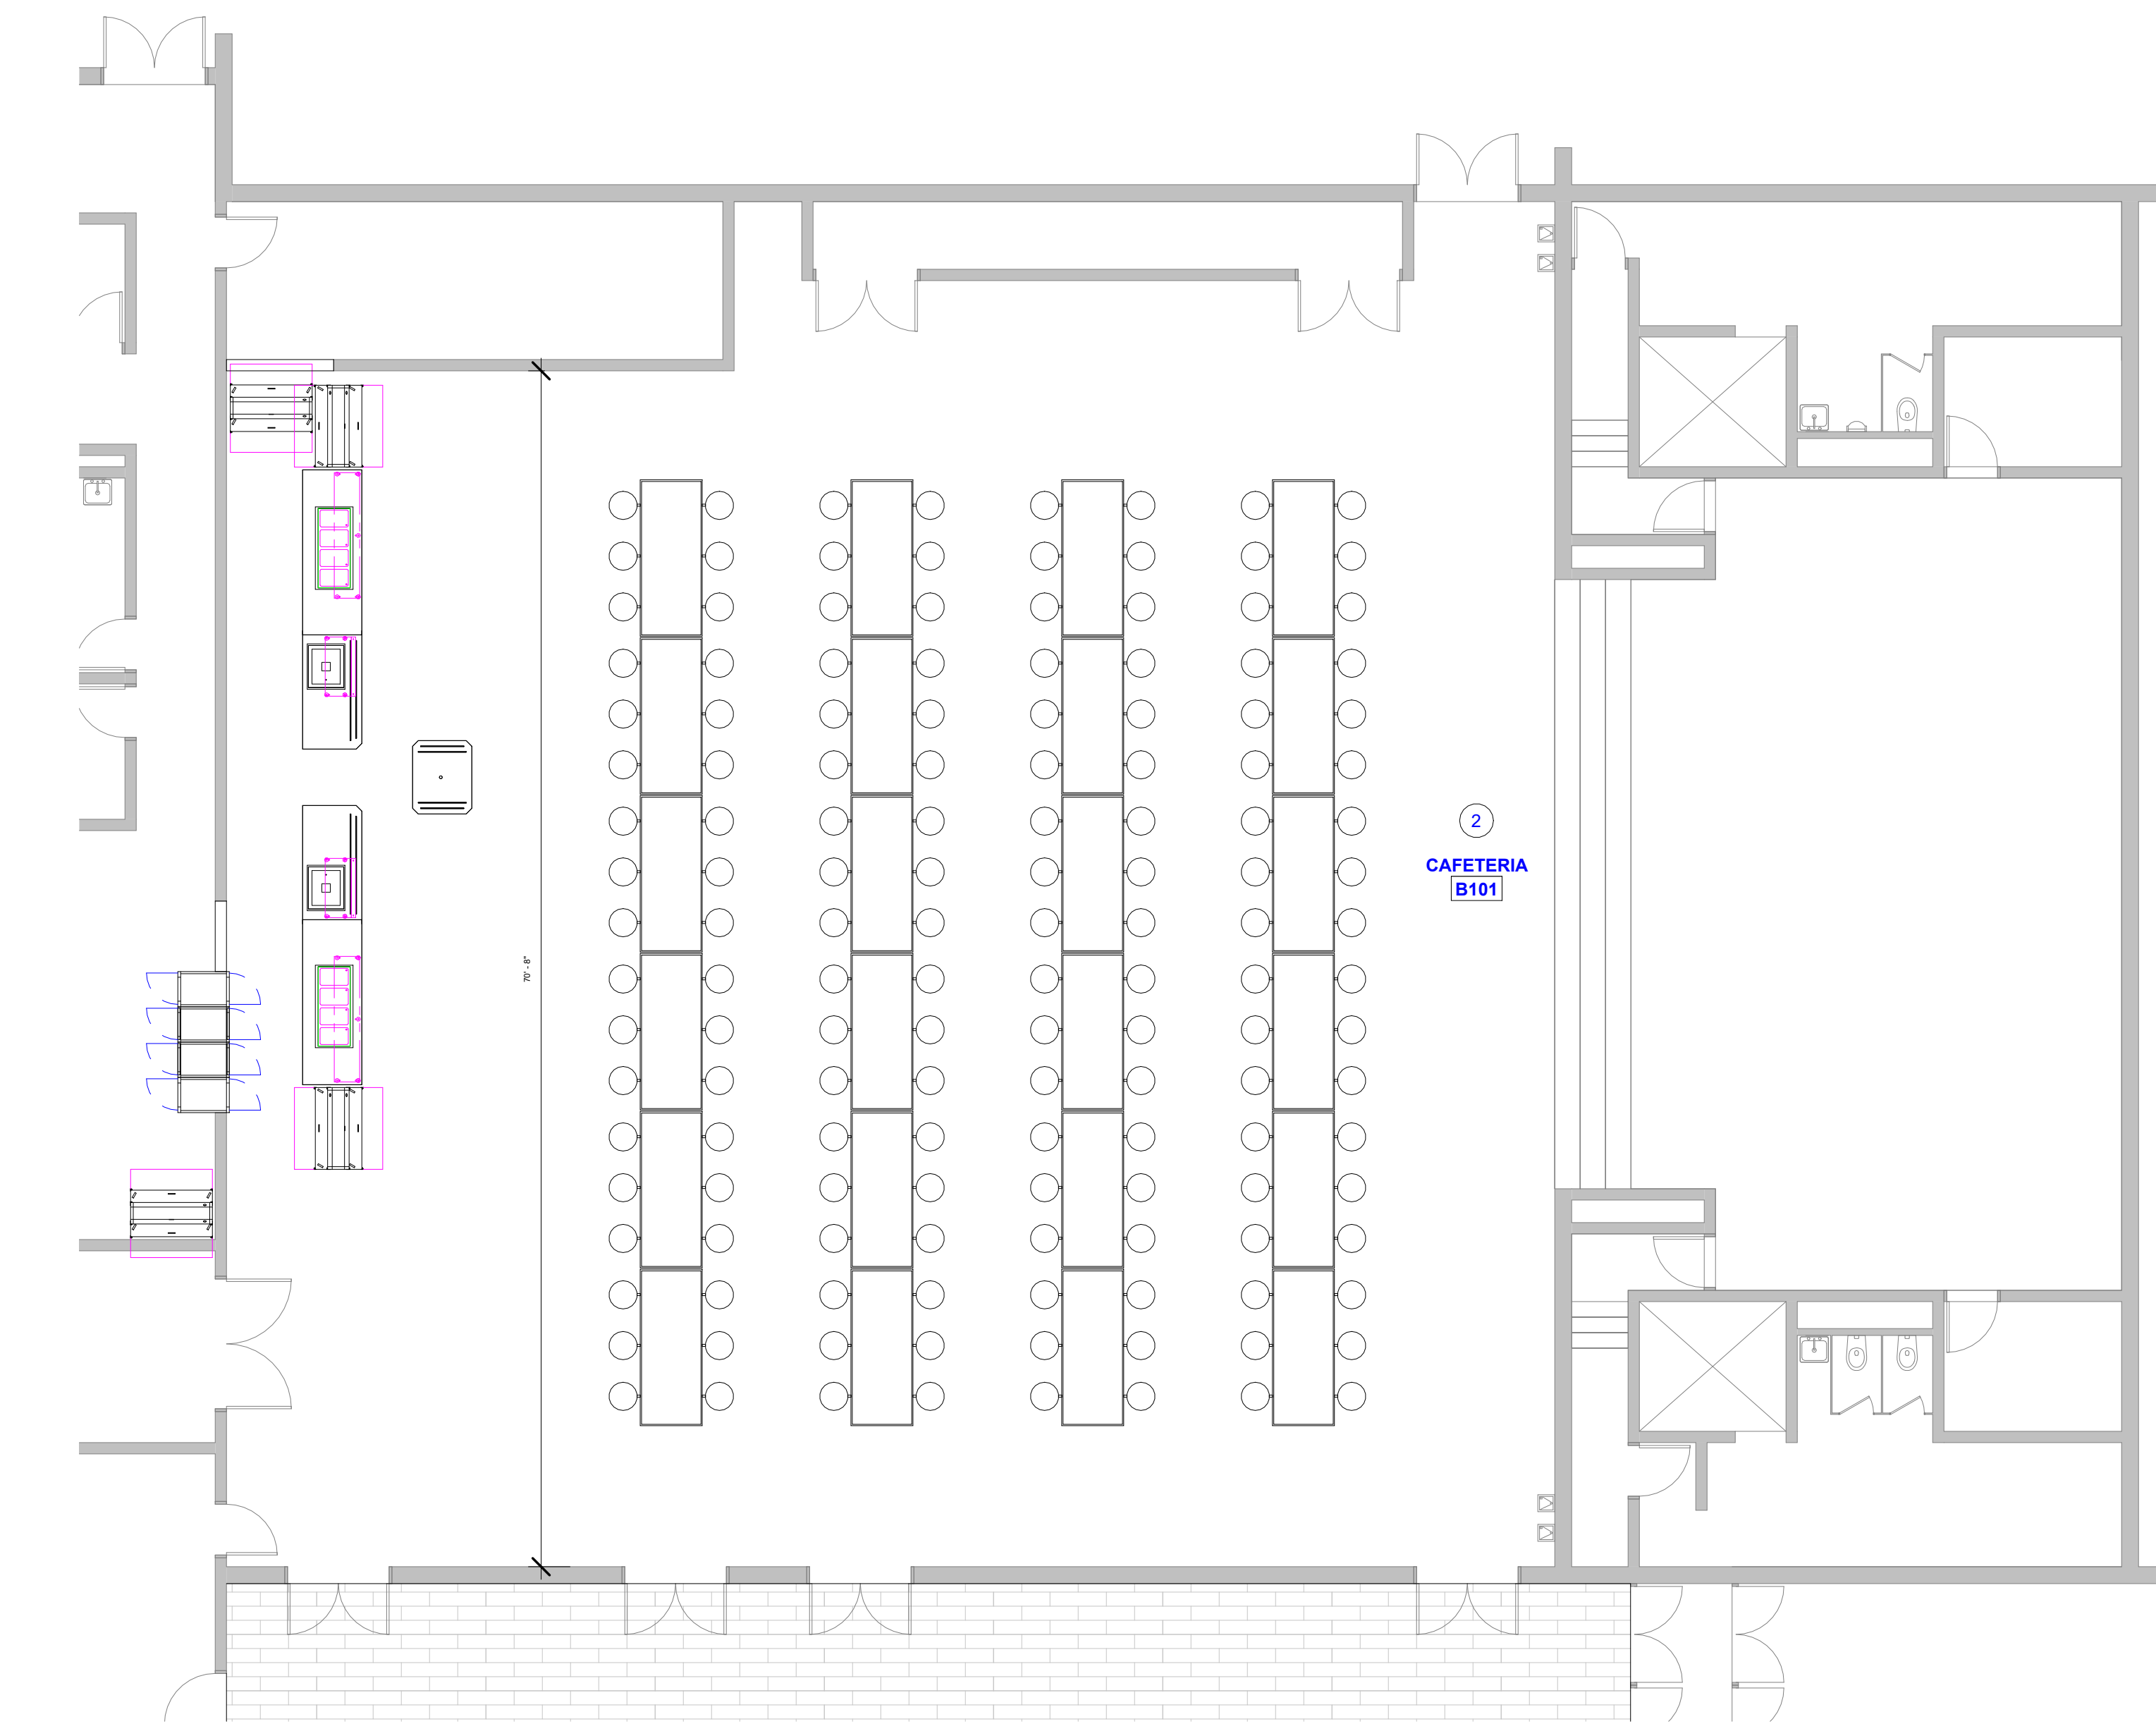

2 FIRST FLOOR NEW CONSTRUCTION PLAN UNIT B2
1/8" = 1'-0"

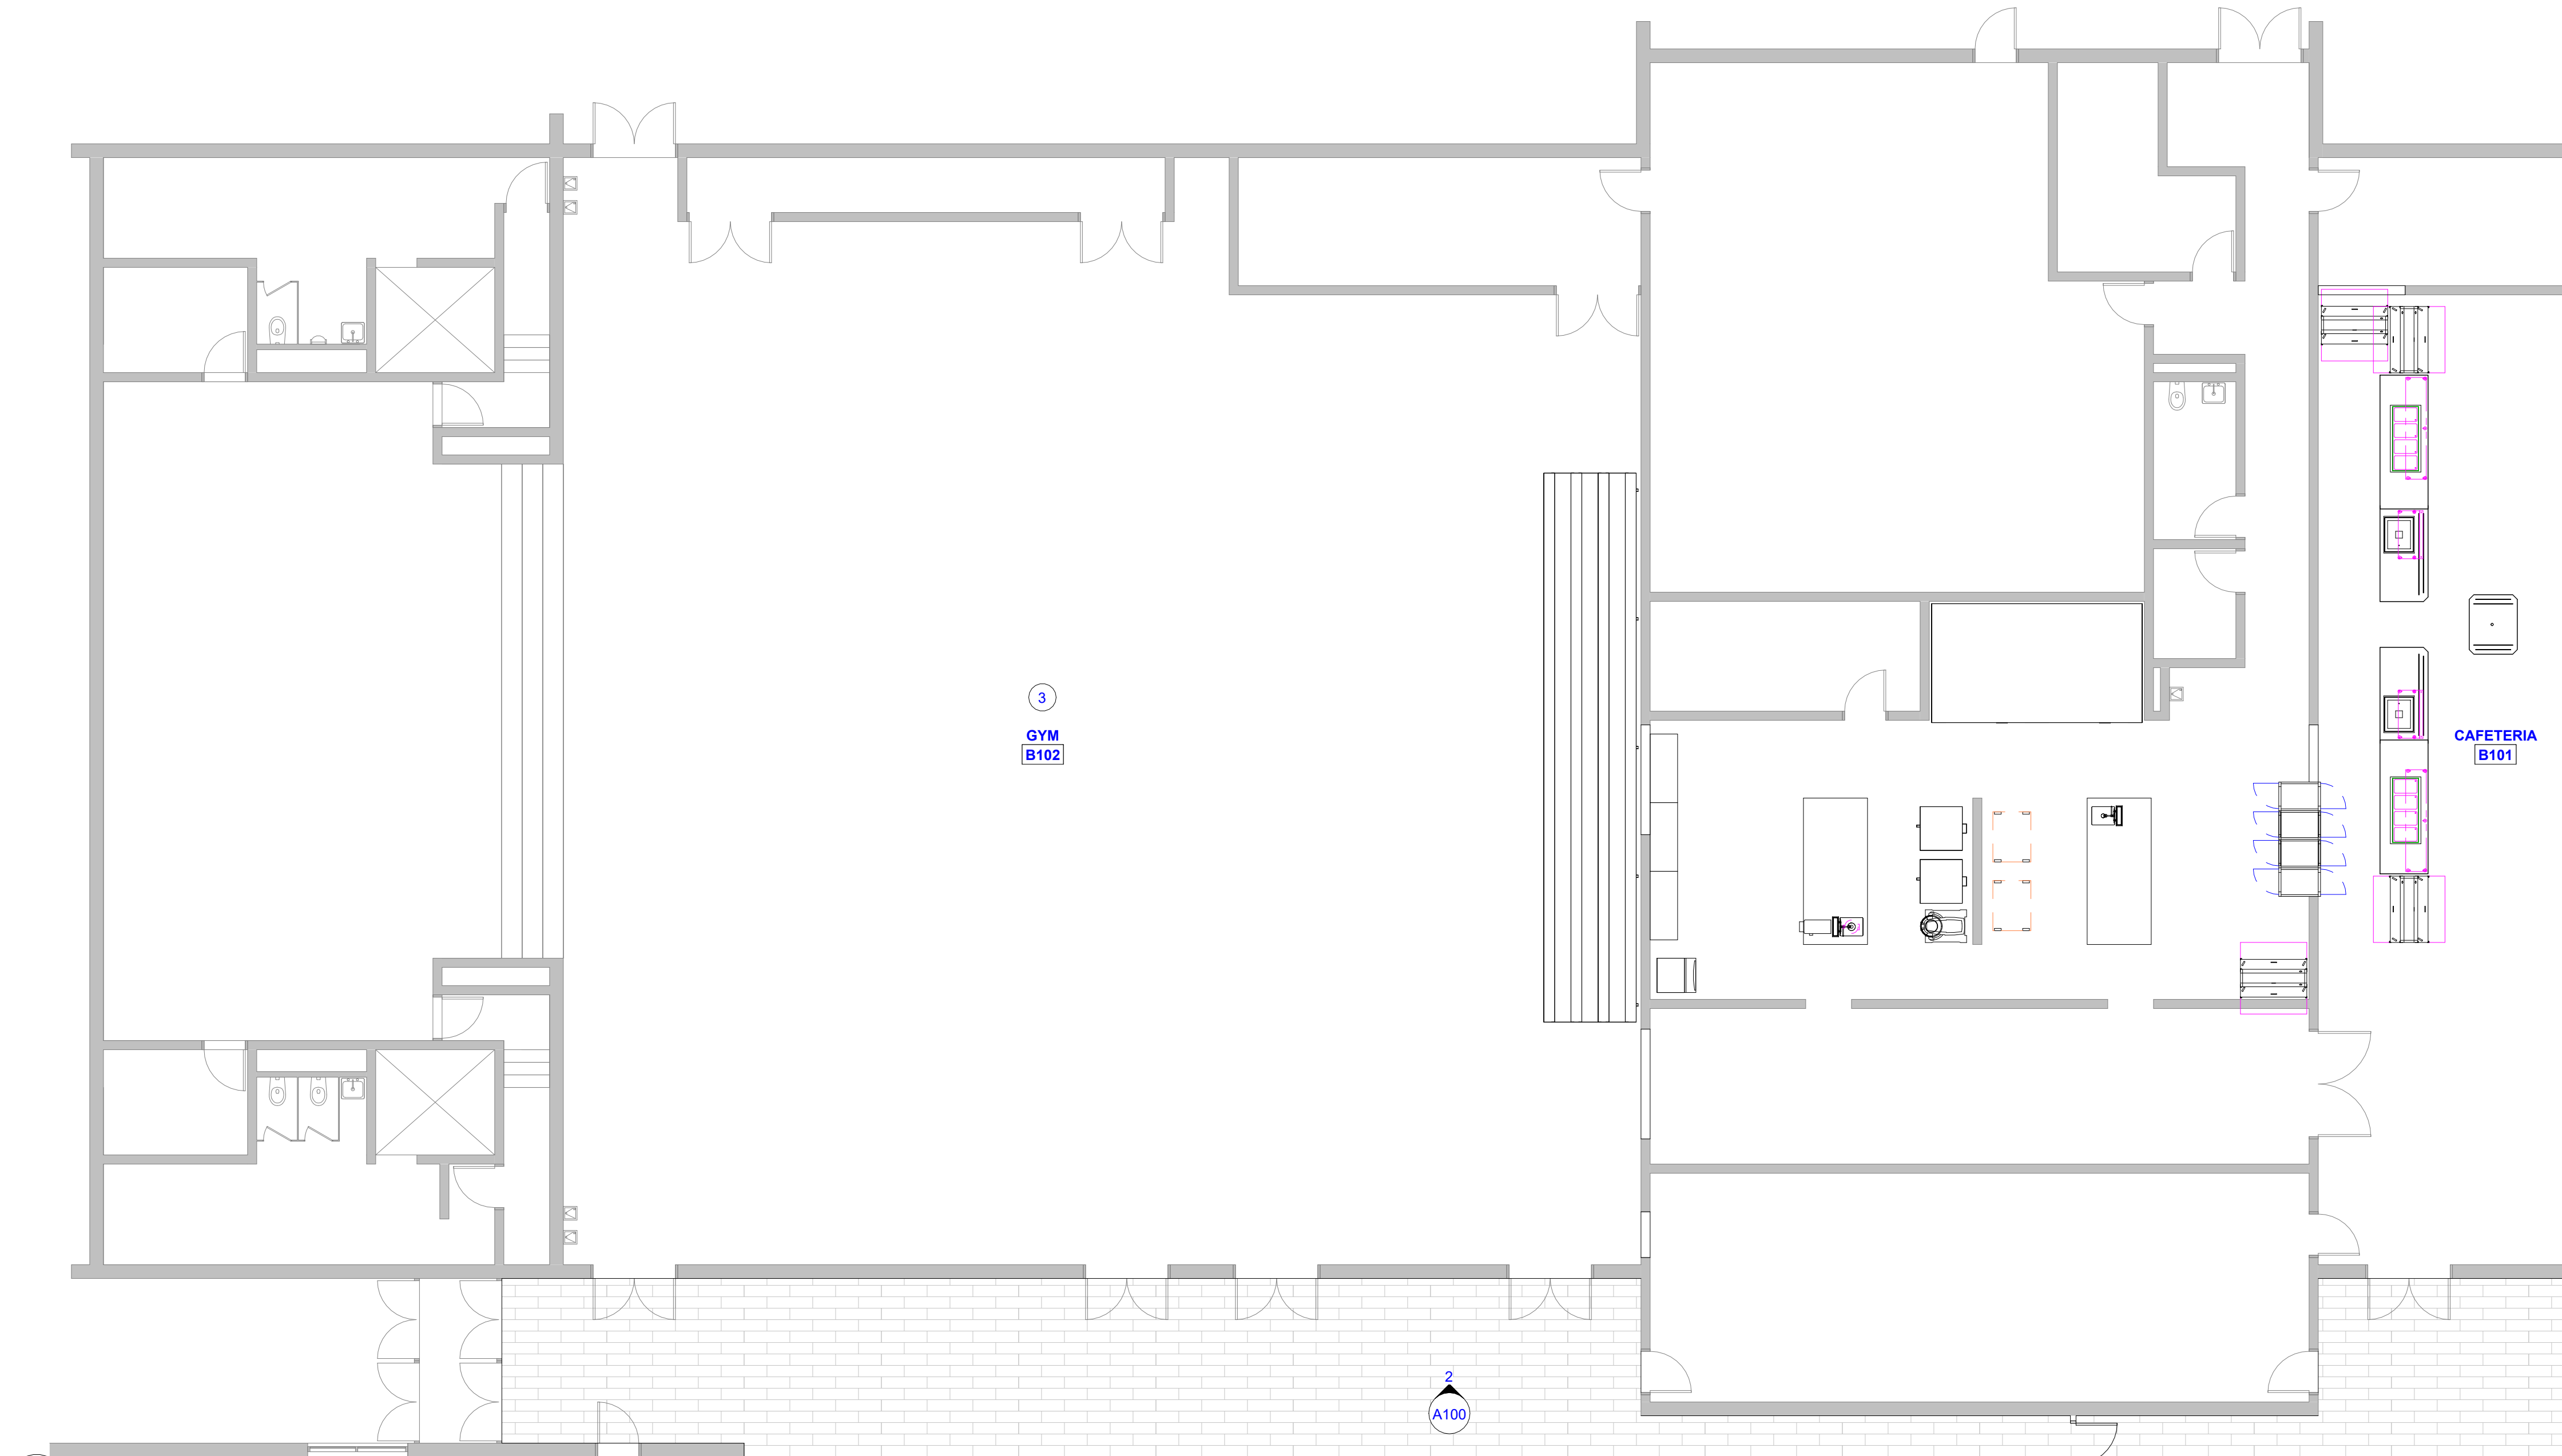



1 FIRST FLOOR NEW CONSTRUCTION PLAN UNIT B1
1/8" = 1'-0"

ARCHITECTURE PLAN NOTES	
#	KEYNOTE INFORMATION
1	ALT. 1. RENOVATE THE LIFE SKILLS ROOMS E102, E103, E104, AND E105
2	ALT. 2. COMPLETE THE FINISH WORK IN CAFETERIA B101
3	ALT. 3. FURNISH AND INSTALL A NEW SYNTHETIC FLOOR AND FINISHES IN GYMNASIUM B102
4	ALT. 4. CONSTRUCT THE STAFF RESTROOMS A106, A107, D106, AND D107
5	ALT. 5. CONSTRUCT WORKROOMS A113 AND D113
6	ALT. 6. RENOVATE RESTROOMS C115 AND C116
7	ALT. 7. RENOVATION AND REORGANIZATION OF THE KITCHEN PREP AREA. INCLUDED IN THIS WORK IS THE REUSE OF EXISTING EQUIPMENT, AS WELL AS FURNISHING NEW EQUIPMENT.
8	ALT. 8. INSTALL LVT WALL COVERING TO MAIN CORRIDORS AS INDICATED IN DRAWINGS

GENERAL FLOOR PLAN NOTES

NOTE: GENERAL NOTES LISTED BELOW REFER TO ALL SHEETS CONTAINED IN THIS SET.

- FIELD VERIFY ALL EXISTING CONDITIONS, NOTIFY THE ARCHITECT/ENGINEER IMMEDIATELY OF ANY DISCREPANCIES THAT EXIST.
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- GYPSUM BOARD WALLS NOT REQUIRED TO EXTEND TO THE BOTTOM OF THE STRUCTURE ABOVE SHALL TERMINATE 6" ABOVE THE HIGHEST ADJOINING CEILING AND SHALL BE BRACED EITHER BY ATTACHING ALTERNATING DIAGONAL STUDS 48" O.C. FROM TOP OF WALL TO STRUCTURE OR BY EXISTING WALL STUDS TO STRUCTURE ABOVE.
- PROVIDE WOOD BLOCKING IN WALLS AND CEILINGS AS REQUIRED FOR INSTALLATION OF CASEWORK OR OTHER SURFACE-MOUNTED ACCESSORIES.
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905 North Capitol Avenue - Suite 100
PH: (317) 353-3281

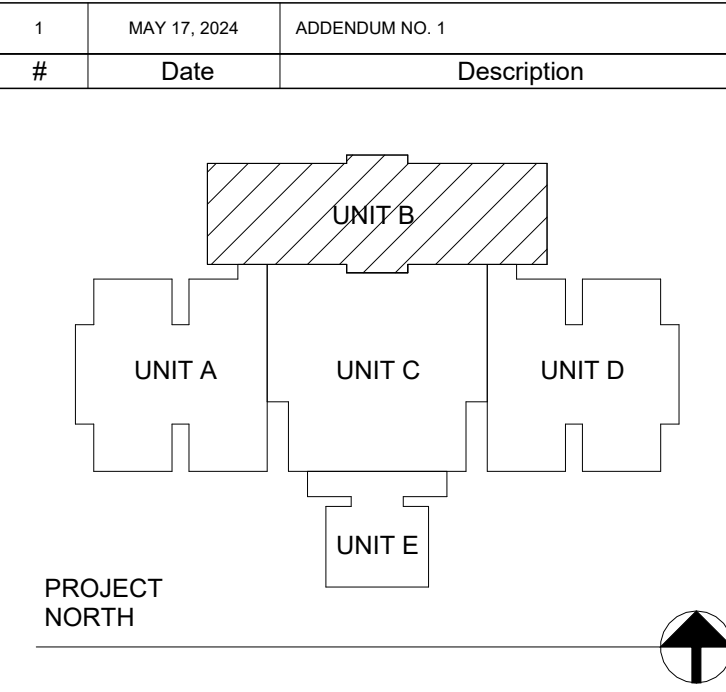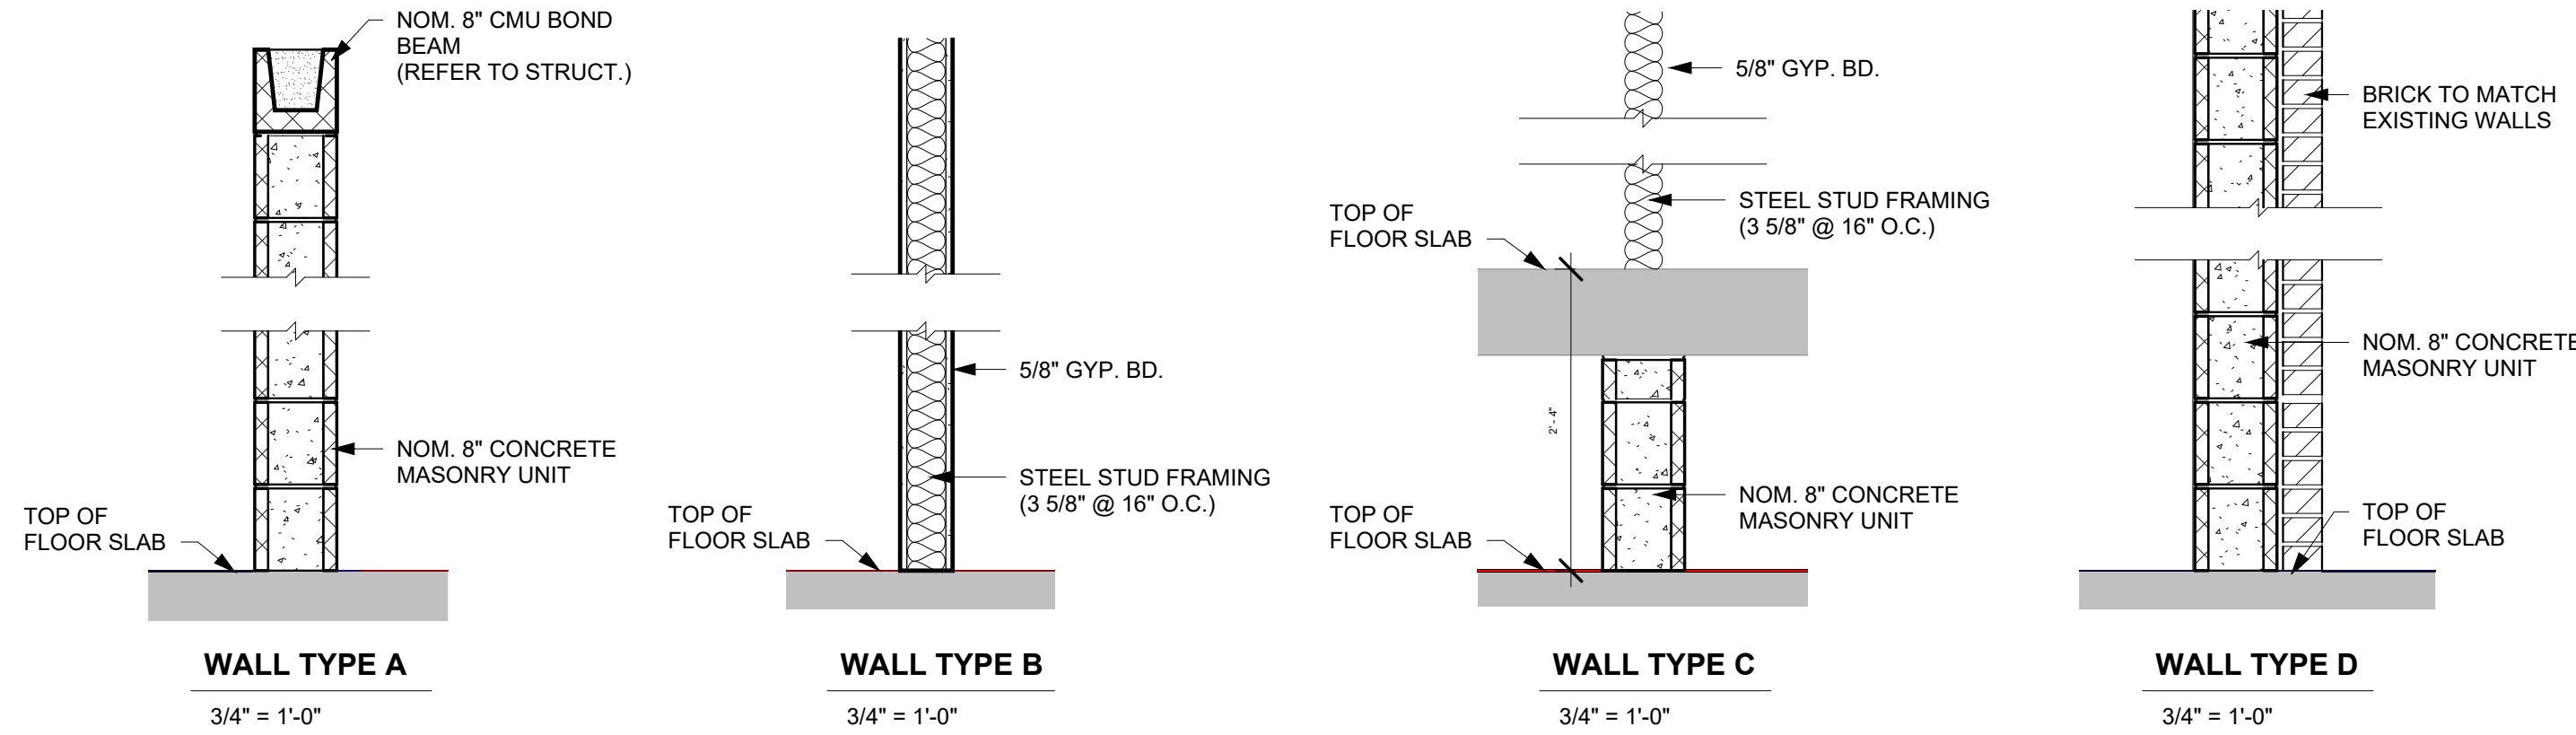Evansville, Indiana 47708
Indianapolis, Indiana 46204
www.VPSARCH.com

STRUCTURAL: ENGINEERS:

Project Name:
RENOVATIONS TO RUSHVILLE ELEMENTARY SCHOOL

Drawing Title:
ARCHITECTURAL FLOOR PLAN - UNIT B


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	VPS Project No:	2023021.00
	Project Issue Date:	04/17/24
	Drawing No:	

ARCHITECTURE PLAN NOTES	
#	KEYNOTE INFORMATION
1	ALT. 1. RENOVATE THE LIFE SKILLS ROOMS E102, E103, E104, AND E105
2	ALT. 2. COMPLETE THE FINISH WORK IN CAFETERIA B101
3	ALT. 3. FURNISH AND INSTALL A NEW SYNTHETIC FLOOR AND FINISHES IN GYMNASIUM B102
4	ALT. 4. CONSTRUCT THE STAFF RESTROOMS A106, A107, D106, AND D107
5	ALT. 5. CONSTRUCT WORKROOMS A113 AND D113
6	ALT. 6. RENOVATE RESTROOMS C115 AND C116
7	ALT. 7. RENOVATION AND REORGANIZATION OF THE KITCHEN PREP AREA. INCLUDED IN THIS WORK IS THE REUSE OF EXISTING EQUIPMENT, AS WELL AS FURNISHING NEW EQUIPMENT.
8	ALT. 8. INSTALL LVT WALL COVERING TO MAIN CORRIDORS AS INDICATED IN DRAWINGS


GENERAL FLOOR PLAN NOTES

NOTE: GENERAL NOTES LISTED BELOW REFER TO ALL SHEETS CONTAINED IN THIS SET.

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- PROVIDE WOOD BLOCKING IN WALLS AND CEILINGS AS REQUIRED FOR INSTALLATION OF CASEWORK OR OTHER SURFACE-MOUNTED ACCESSORIES.
- ALL CHASE WALLS SHALL BE 3 5/8" METAL STUDS @ 16" O.C WITH 5/8" GYPSUM BOARD ON ONE SIDE UNLESS NOTED OTHERWISE.

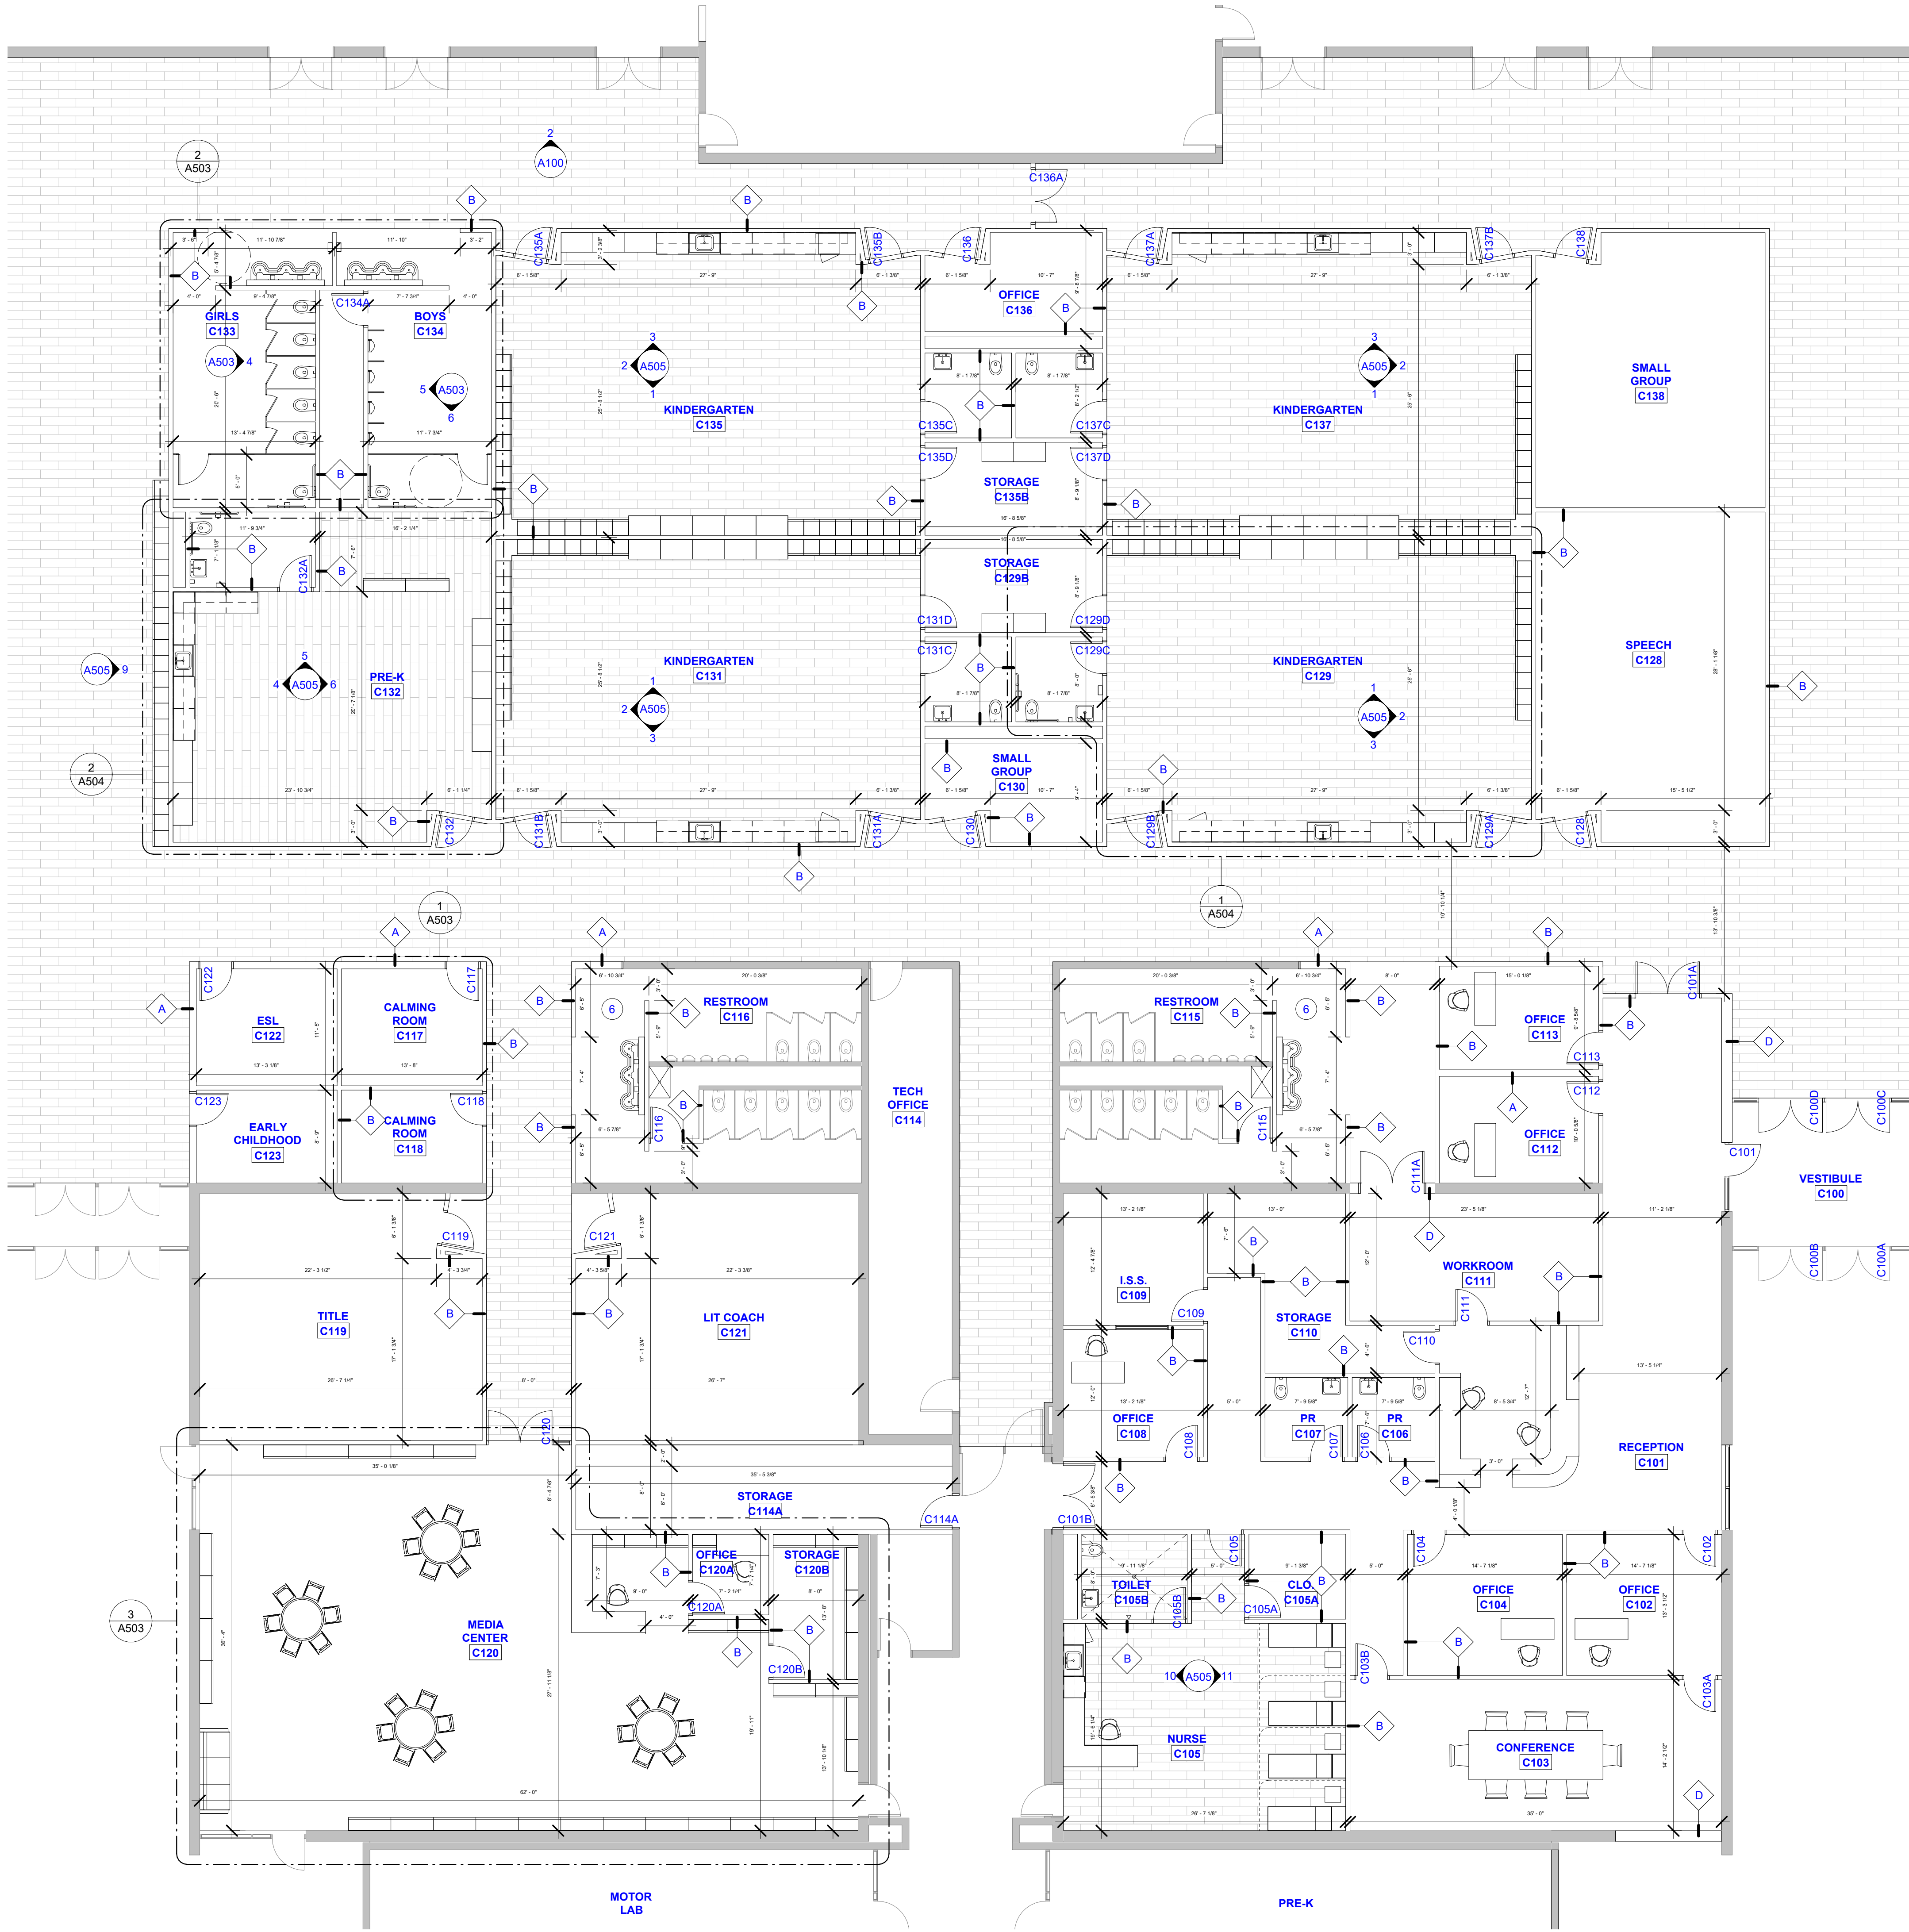

1 FIRST FLOOR NEW CONSTRUCTION PLAN UNIT C
A103 1/8" = 1'-0"

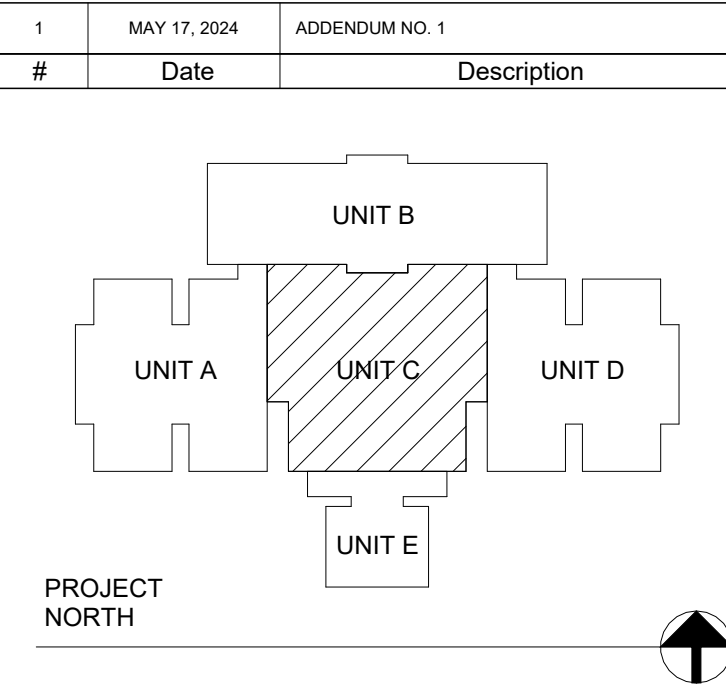

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905 North Capitol Avenue - Suite 100 Indianapolis, Indiana 46204
PH: (317) 353-3281 www.VPSARCH.com

STRUCTURAL: ENGINEERS:

Project Name:
**RENOVATIONS TO
RUSHVILLE ELEMENTARY
SCHOOL**

Drawing Title:
ARCHITECTURAL FLOOR PLAN - UNIT C

	Client Project No:	
	VPS Project No:	2023021.00
	Project Issue Date:	04/17/24
	Drawing No:	A103

ARCHITECTURE PLAN NOTES	
#	KEYNOTE INFORMATION
1	ALT. 1. RENOVATE THE LIFE SKILLS ROOMS E102, E103, E104, AND E105
2	ALT. 2. COMPLETE THE FINISH WORK IN CAFETERIA B101
3	ALT. 3. FURNISH AND INSTALL A NEW SYNTHETIC FLOOR AND FINISHES IN GYMNASIUM B102
4	ALT. 4. CONSTRUCT THE STAFF RESTROOMS A106, A107, D106, AND D107
5	ALT. 5. CONSTRUCT WORKROOMS A113 AND D113
6	ALT. 6. RENOVATE RESTROOMS C115 AND C116
7	ALT. 7. RENOVATION AND REORGANIZATION OF THE KITCHEN PREP AREA. INCLUDED IN THIS WORK IS THE REUSE OF EXISTING EQUIPMENT, AS WELL AS FURNISHING NEW EQUIPMENT.
8	ALT. 8. INSTALL LVT WALL COVERING TO MAIN CORRIDORS AS INDICATED IN DRAWINGS


GENERAL FLOOR PLAN NOTES

NOTE: GENERAL NOTES LISTED BELOW REFER TO ALL SHEETS CONTAINED IN THIS SET.

- FIELD VERIFY ALL EXISTING CONDITIONS. NOTIFY THE ARCHITECT/ENGINEER IMMEDIATELY OF ANY DISCREPANCIES THAT EXIST.
- CONSTRUCTION AND INSTALLATIONS SHALL CONFORM TO ALL FEDERAL, STATE, AND LOCAL ORDINANCES, CODES, ETC.
- ALL DIMENSIONS ON FLOOR PLANS ARE FROM THE FACE OF FINISH GYPSUM BOARD, FACE OF MASONRY, FACE OF CONCRETE, FACE OF EXISTING WALL OR CENTERLINE OF COLUMNS, UNLESS NOTED OTHERWISE.
- GYPSUM BOARD WALLS NOT REQUIRED TO EXTEND TO THE BOTTOM OF THE STRUCTURE ABOVE SHALL TERMINATE 6" ABOVE THE HIGHEST ADJOINING CEILING AND SHALL BE BRACED EITHER BY ATTACHING ALTERNATING DIAGONAL STUDS 48" O.C. FROM TOP OF WALL TO STRUCTURE OR BY EXISTING WALL STUDS TO STRUCTURE ABOVE.
- PROVIDE WOOD BLOCKING IN WALLS AND CEILINGS AS REQUIRED FOR INSTALLATION OF CASEWORK OR OTHER SURFACE-MOUNTED ACCESSORIES.
- ALL CHASE WALLS SHALL BE 3 5/8" METAL STUDS @ 16" O.C WITH 5/8" GYPSUM BOARD ON ONE SIDE UNLESS NOTED OTHERWISE.



1 FIRST FLOOR NEW CONSTRUCTION PLAN UNIT D
A104 1/8" = 1'-0"

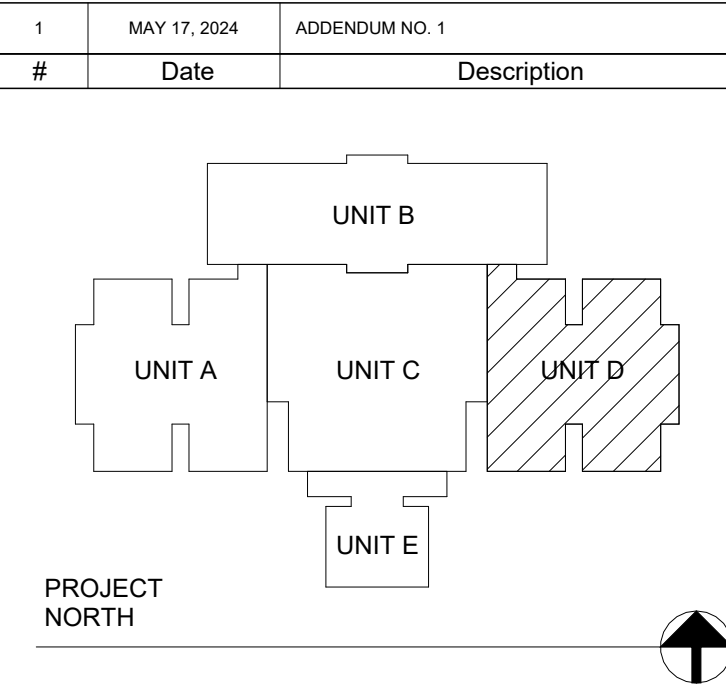

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STRUCTURAL: ENGINEERS:

Project Name:
RENOVATIONS TO RUSHVILLE ELEMENTARY SCHOOL

Drawing Title:
ARCHITECTURAL FLOOR PLAN - UNIT D


	Client Project No:
	VPS Project No: 2023021.00
	Project Issue Date: 04/17/24
	Drawing No: A104

ARCHITECTURE PLAN NOTES	
#	KEYNOTE INFORMATION
1	ALT. 1. RENOVATE THE LIFE SKILLS ROOMS E102, E103, E104, AND E105
2	ALT. 2. COMPLETE THE FINISH WORK IN CAFETERIA B101
3	ALT. 3. FURNISH AND INSTALL A NEW SYNTHETIC FLOOR AND FINISHES IN GYMNASIUM B102
4	ALT. 4. CONSTRUCT THE STAFF RESTROOMS A106, A107, D106, AND D107
5	ALT. 5. CONSTRUCT WORKROOMS A113 AND D113
6	ALT. 6. RENOVATE RESTROOMS C115 AND C116
7	ALT. 7. RENOVATION AND REORGANIZATION OF THE KITCHEN PREP AREA. INCLUDED IN THIS WORK IS THE REUSE OF EXISTING EQUIPMENT, AS WELL AS FURNISHING NEW EQUIPMENT.
8	ALT. 8. INSTALL LVT WALL COVERING TO MAIN CORRIDORS AS INDICATED IN DRAWINGS


GENERAL FLOOR PLAN NOTES

NOTE: GENERAL NOTES LISTED BELOW REFER TO ALL SHEETS CONTAINED IN THIS SET.

- FIELD VERIFY ALL EXISTING CONDITIONS, NOTIFY THE ARCHITECT/ENGINEER IMMEDIATELY OF ANY DISCREPANCIES THAT EXIST.
- CONSTRUCTION AND INSTALLATIONS SHALL CONFORM TO ALL FEDERAL, STATE, AND LOCAL ORDINANCES, CODES, ETC.
- ALL DIMENSIONS ON FLOOR PLANS ARE FROM THE FACE OF FINISH GYPSUM BOARD, FACE OF MASONRY, FACE OF CONCRETE, FACE OF EXISTING WALL OR CENTERLINE OF COLUMNS, UNLESS NOTED OTHERWISE.
- GYPSUM BOARD WALLS NOT REQUIRED TO EXTEND TO THE BOTTOM OF THE STRUCTURE ABOVE SHALL TERMINATE 6" ABOVE THE HIGHEST ADJOINING CEILING AND SHALL BE BRACED EITHER BY ATTACHING ALTERNATING DIAGONAL STUDS 48" O.C. FROM TOP OF WALL TO STRUCTURE OR BY EXISTING WALL STUDS TO STRUCTURE ABOVE.
- PROVIDE WOOD BLOCKING IN WALLS AND CEILINGS AS REQUIRED FOR INSTALLATION OF CASEWORK OR OTHER SURFACE-MOUNTED ACCESSORIES.
- ALL CHASE WALLS SHALL BE 3 5/8" METAL STUDS @ 16" O.C WITH 5/8" GYPSUM BOARD ON ONE SIDE UNLESS NOTED OTHERWISE.

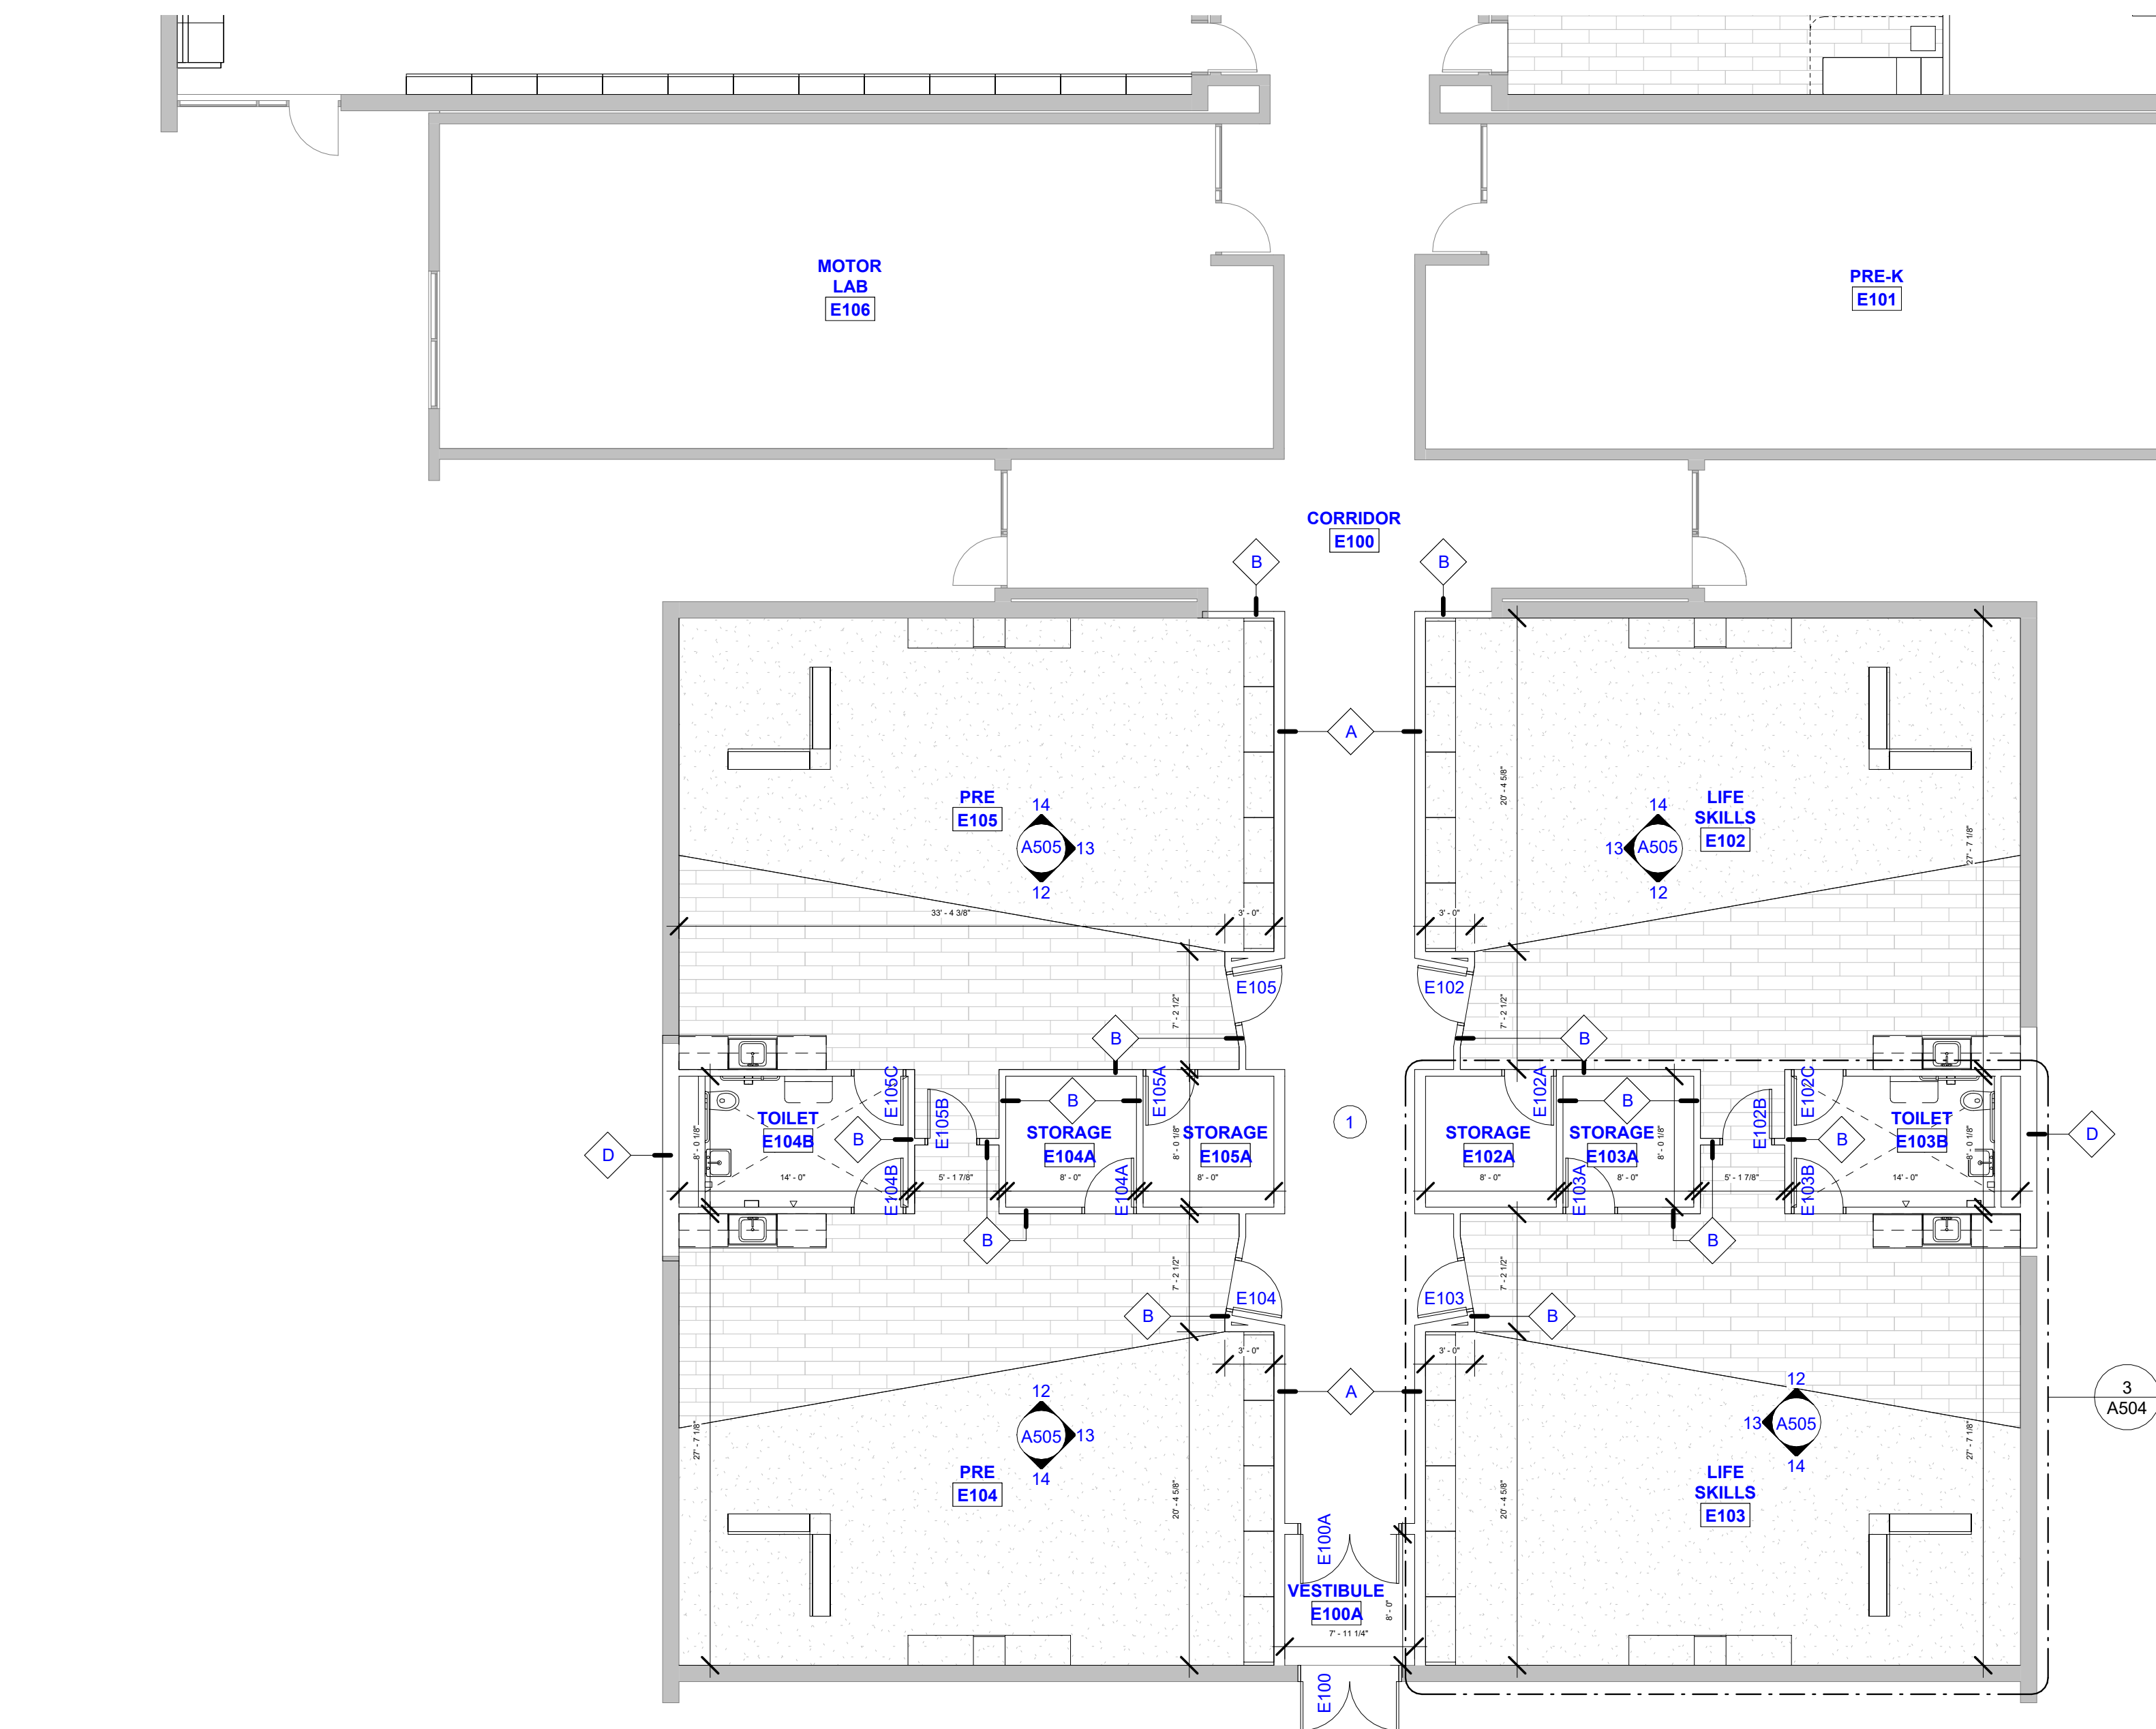

1 FIRST FLOOR NEW CONSTRUCTION PLAN UNIT E
A105 1/8" = 1'-0"

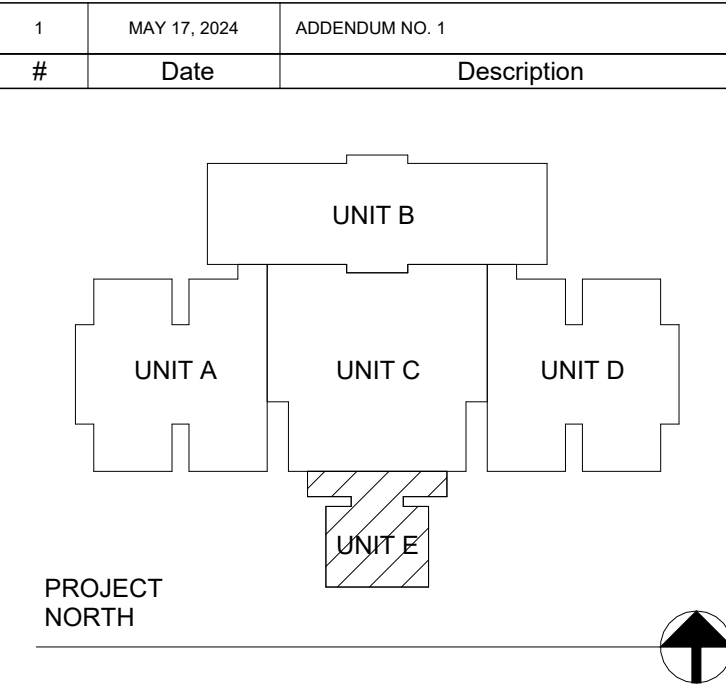

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PH: (317) 353-3281 www.VPSARCH.com

STRUCTURAL: ENGINEERS:

Project Name: RENOVATIONS TO RUSHVILLE ELEMENTARY SCHOOL	
Drawing Title: ARCHITECTURAL FLOOR PLAN - UNIT E	
	Client Project No:
	VPS Project No: 2023021.00
	Project Issue Date: 04/17/24
	Drawing No: A105

REFLECTED CEILING PLAN NOTES	
#	KEYNOTE INFORMATION

REFLECTED CEILING PLAN LEGEND

REFER TO MECHANICAL, ELECTRICAL AND/OR PLUMBING DRAWINGS FOR SPECIFICATIONS OF ITEMS

- INDICATES AREA OF 5/8" GYPSUM BOARD CEILING/SOFFIT/BULKHEAD ON 3 5/8" METAL STUDS @ 16" O.C. (U.N.O.) PAINT
- INDICATES 2' X 2' LAY-IN CEILING TILE WITH METAL GRID
- 2' X 4' RECESSED LIGHT FIXTURE
- 2' X 2' RECESSED LIGHT FIXTURE
- 1' X 4' RECESSED LIGHT FIXTURE
- STRIP FIXTURE WITH WIRE GUARD
- RECESSED CAN TYPE LIGHT FIXTURE
- 2' X 2' SUPPLY AIR
- 2' X 2' RETURN AIR
- EXHAUST FAN
- E.S.

EXPOSED STRUCTURE
- M.E.

MATCH EXISTING
- E.T.R.

EXISTING TO REMAIN

GENERAL REFLECTED CEILING PLAN NOTES

- CEILING ELEVATION TAGS REFER TO HEIGHT ABOVE EITHER FINISHED SLAB IN AREAS OF NEW CONSTRUCTION & RENOVATION OR ABOVE EXISTING FINISH FLOOR IN AREAS TO REMAIN.
- CENTER PENETRATIONS IN ACOUSTICAL CEILING SYSTEMS WITHIN INDIVIDUAL CEILING PANELS, SUCH AS SPRINKLER HEADS, DIFFUSERS, LIGHT FIXTURES, ETC., UNLESS NOTED OTHERWISE.
- PAINT ALL EXPOSED GYP. BD FROM SPECIFIC SURFACES U.N.O.
- REFER TO ELECTRICAL DRAWINGS FOR CEILING-MOUNTED LIGHT FIXTURE TYPES & QUANTITIES.
- REFER TO MECHANICAL DRAWINGS FOR CEILING-MOUNTED DIFFUSERS, GRILLE TYPES & QUANTITIES.
- THE REFLECTED CEILING PLANS SHOW THE DESIGN INTENT OF MECHANICAL & ELECTRICAL BUILDING SYSTEMS TO BE INTEGRATED INTO CEILINGS. REFLECTED CEILING PLANS SHALL TAKE PRECEDENCE OVER MECHANICAL & ELECTRICAL DRAWINGS. REFER DISCOVERED DISCREPANCIES TO THE ARCHITECT FOR DIRECTION.
- SHALL CONTINUE UP ADJACENT VERTICAL FACES.
- ALL GAPS BETWEEN WALL MOULD ANGLES & WALL FACE SHALL BE FILLED WITH SEALANT.



1 FIRST FLOOR REFLECTED CEILING PLAN
A201 1/16" = 1'-0"



1	MAY 17, 2024	ADDENDUM NO. 1
#	Date	Description
<div><div>UNIT A</div><div>UNIT B</div><div>UNIT C</div><div>UNIT D</div><div>UNIT E</div></div> <div>PROJECT NORTH</div>		

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www.VPSARCH.com

STRUCTURAL: ENGINEERS:

Project Name:
RENOVATIONS TO RUSHVILLE ELEMENTARY SCHOOL

Drawing Title:
OVERALL REFLECTED CEILING PLAN

	Client Project No:	
	VPS Project No:	2023021.00
	Project Issue Date:	04/17/24
	Drawing No:	A201



REFLECTED CEILING PLAN NOTES	
#	KEYNOTE INFORMATION


REFLECTED CEILING PLAN LEGEND

REFER TO MECHANICAL, ELECTRICAL AND/OR PLUMBING DRAWINGS FOR SPECIFICATIONS OF ITEMS

- INDICATES AREA OF 5/8" GYPSUM BOARD CEILING/SOFFIT/BULKHEAD ON 3 5/8" METAL STUDS @ 16" O.C. (U.N.O.) PAINT
- INDICATES 2' X 2' LAY-IN CEILING TILE WITH METAL GRID
- 2' x 4' RECESSED LIGHT FIXTURE
- 2' x 2' RECESSED LIGHT FIXTURE
- 1' x 4' RECESSED LIGHT FIXTURE
- STRIP FIXTURE WITH WIRE GUARD
- RECESSED CAN TYPE LIGHT FIXTURE
- 2' X 2' SUPPLY AIR
- 2' X 2' RETURN AIR
- EXHAUST FAN
- E.S. EXPOSED STRUCTURE
- M.E. MATCH EXISTING
- E.T.R. EXISTING TO REMAIN

GENERAL REFLECTED CEILING PLAN NOTES

- CEILING ELEVATION TAGS REFER TO HEIGHT ABOVE EITHER FINISHED SLAB IN AREAS OF NEW CONSTRUCTION & RENOVATION OR ABOVE EXISTING FINISH FLOOR IN AREAS TO REMAIN.
- CENTER PENETRATIONS IN ACOUSTICAL CEILING SYSTEMS WITHIN INDIVIDUAL CEILING PANELS, SUCH AS SPRINKLER HEADS, DIFFUSERS, LIGHT FIXTURES, ETC., UNLESS NOTED OTHERWISE.
- PAINT ALL EXPOSED GYP. BD FROM SPECIFIC SURFACES U.N.O.
- REFER TO ELECTRICAL DRAWINGS FOR CEILING-MOUNTED LIGHT FIXTURE TYPES & QUANTITIES.
- REFER TO MECHANICAL DRAWINGS FOR CEILING-MOUNTED DIFFUSERS, GRILLE TYPES & QUANTITIES.
- THE REFLECTED CEILING PLANS SHOW THE DESIGN INTENT OF MECHANICAL & ELECTRICAL BUILDING SYSTEMS TO BE INTEGRATED INTO CEILINGS. REFLECTED CEILING PLANS SHALL TAKE PRECEDENCE OVER MECHANICAL & ELECTRICAL DRAWINGS. REFER DISCOVERED DISCREPANCIES TO THE ARCHITECT FOR DIRECTION.
- SHALL CONTINUE UP ADJACENT VERTICAL FACES.
- ALL GAPS BETWEEN WALL MOULD ANGLES & WALL FACE SHALL BE FILLED WITH SEALANT.

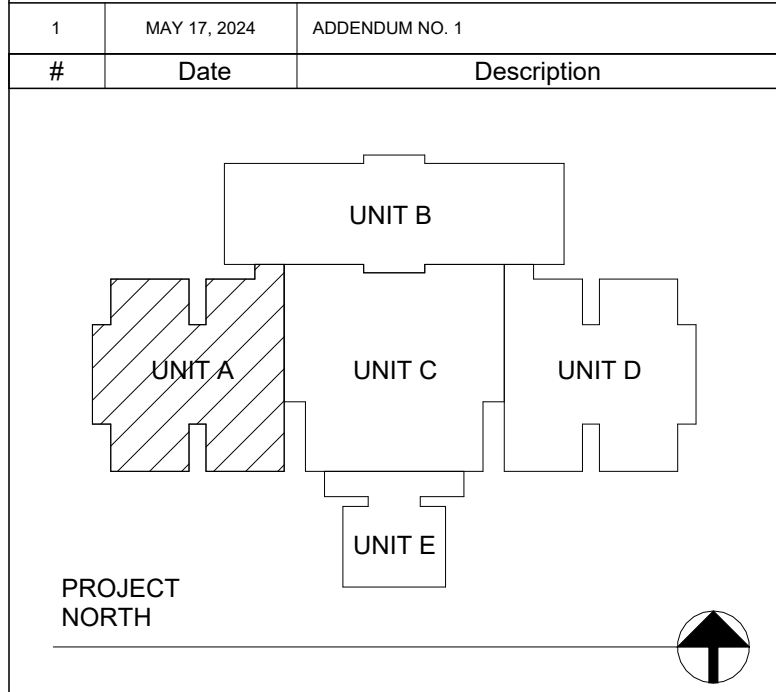


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Evansville, Indiana 47708
Indianapolis, Indiana 46204
www.VPSARCH.com

STRUCTURAL: ENGINEERS:

Project Name:
RENOVATIONS TO RUSHVILLE ELEMENTARY SCHOOL

Drawing Title:
REFLECTED CEILING PLAN - UNIT A

	Client Project No:
	VPS Project No: 2023021.00
	Project Issue Date: 04/17/24
	Drawing No: A202

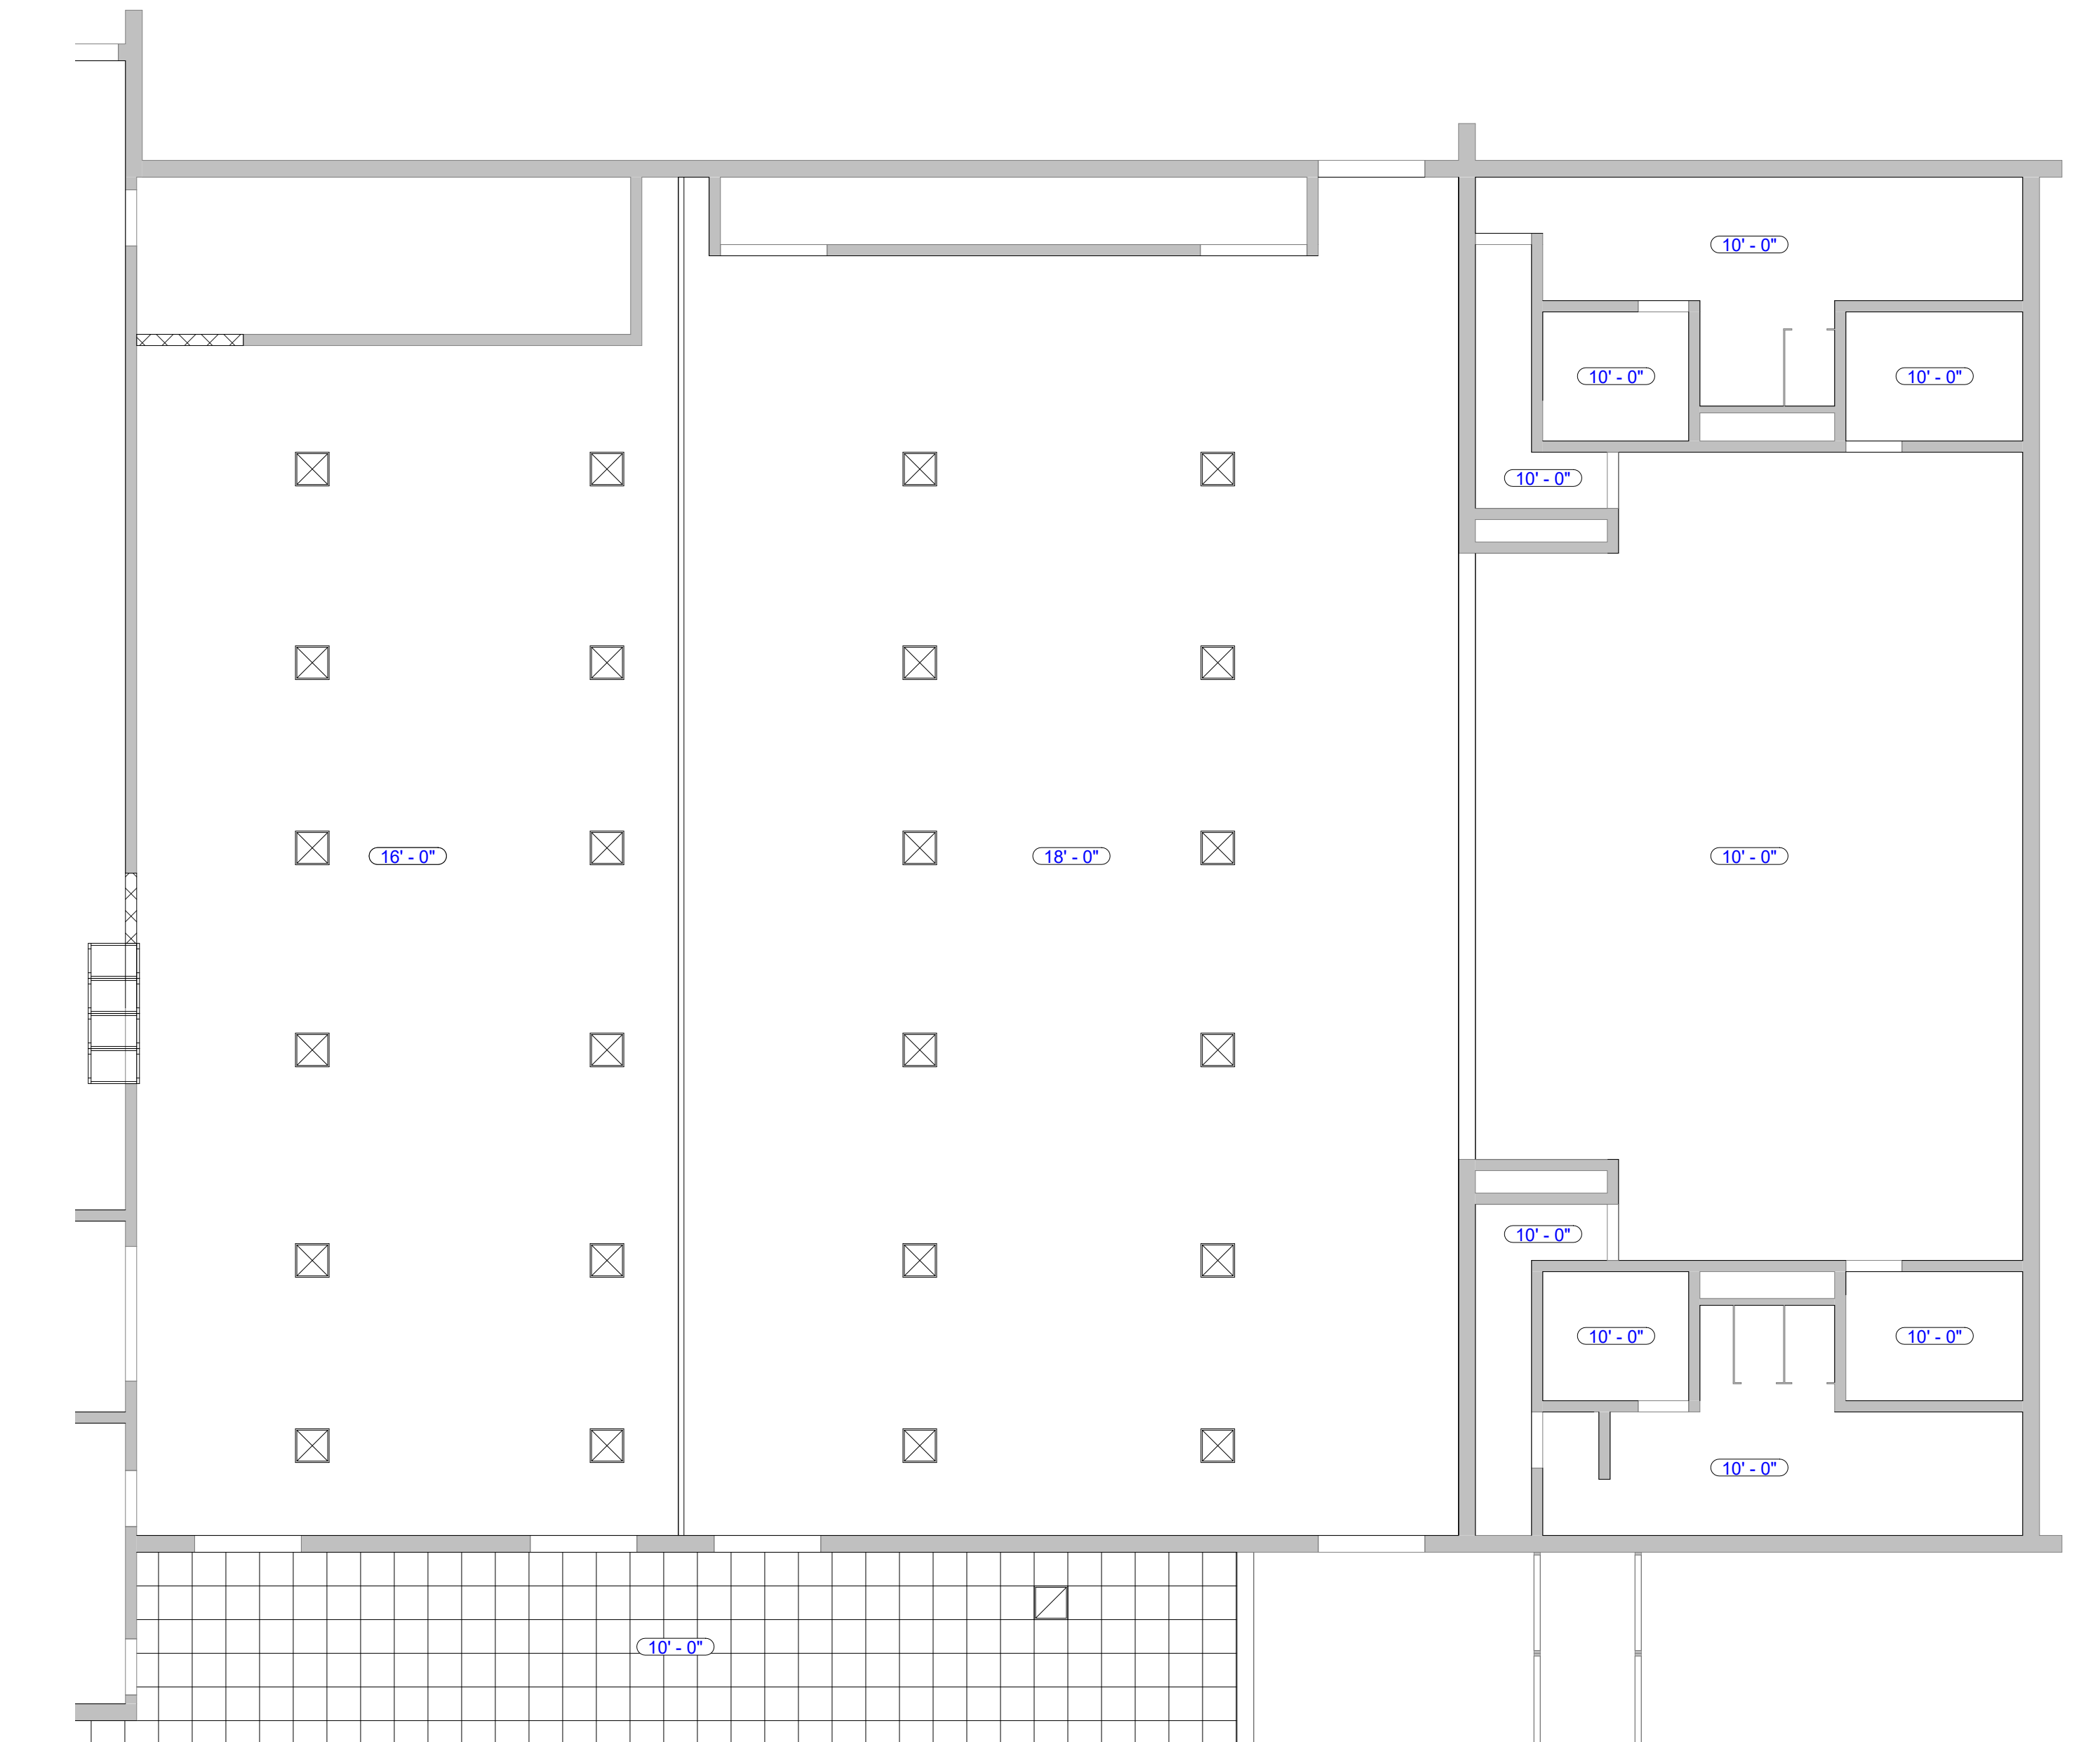

2 REFLECTED CEILING PLAN - UNIT B2
1/8" = 1'-0"




1 REFLECTED CEILING PLAN - UNIT B1
1/8" = 1'-0"

REFLECTED CEILING PLAN NOTES	
#	KEYNOTE INFORMATION

REFLECTED CEILING PLAN LEGEND	
REFER TO MECHANICAL, ELECTRICAL AND/OR PLUMBING DRAWINGS FOR SPECIFICATIONS OF ITEMS	
	INDICATES AREA OF 5/8" GYPSUM BOARD CEILING/SOFFT/BULKHEAD ON 3/8" METAL STUDS @ 16" O.C. (U.N.O.) PAINT
	INDICATES 2' X 2' LAY-IN CEILING TILE WITH METAL GRID
	2' X 4' RECESSED LIGHT FIXTURE
	2' X 2' RECESSED LIGHT FIXTURE
	1' X 4' RECESSED LIGHT FIXTURE
	STRIP FIXTURE WITH WIRE GUARD
	RECESSED CAN TYPE LIGHT FIXTURE
	2' X 2' SUPPLY AIR
	2' X 2' RETURN AIR
	EXHAUST FAN
E.S.	EXPOSED STRUCTURE
M.E.	MATCH EXISTING
E.T.R.	EXISTING TO REMAIN

- GENERAL REFLECTED CEILING PLAN NOTES**
- CEILING ELEVATION TAGS REFER TO HEIGHT ABOVE EITHER FINISHED SLAB IN AREAS OF NEW CONSTRUCTION & RENOVATION OR ABOVE EXISTING FINISH FLOOR IN AREAS TO REMAIN.
 - CENTER PENETRATIONS IN ACOUSTICAL CEILING SYSTEMS WITHIN INDIVIDUAL CEILING PANELS, SUCH AS SPRINKLER HEADS, DIFFUSERS, LIGHT FIXTURES, ETC., UNLESS NOTED OTHERWISE.
 - PAINT ALL EXPOSED GYP. BD FROM SPECIFIC SURFACES U.N.O.
 - REFER TO ELECTRICAL DRAWINGS FOR CEILING-MOUNTED LIGHT FIXTURE TYPES & QUANTITIES.
 - REFER TO MECHANICAL DRAWINGS FOR CEILING-MOUNTED DIFFUSERS, GRILLE TYPES & QUANTITIES.
 - THE REFLECTED CEILING PLANS SHOW THE DESIGN INTENT OF MECHANICAL & ELECTRICAL BUILDING SYSTEMS TO BE INTEGRATED INTO CEILINGS. REFLECTED CEILING PLANS SHALL TAKE PRECEDENCE OVER MECHANICAL & ELECTRICAL DRAWINGS. REFER DISCOVERED DISCREPANCIES TO THE ARCHITECT FOR DIRECTION.
 - SHALL CONTINUE UP ADJACENT VERTICAL FACES.
 - ALL GAPS BETWEEN WALL MOULD ANGLES & WALL FACE SHALL BE FILLED WITH SEALANT.

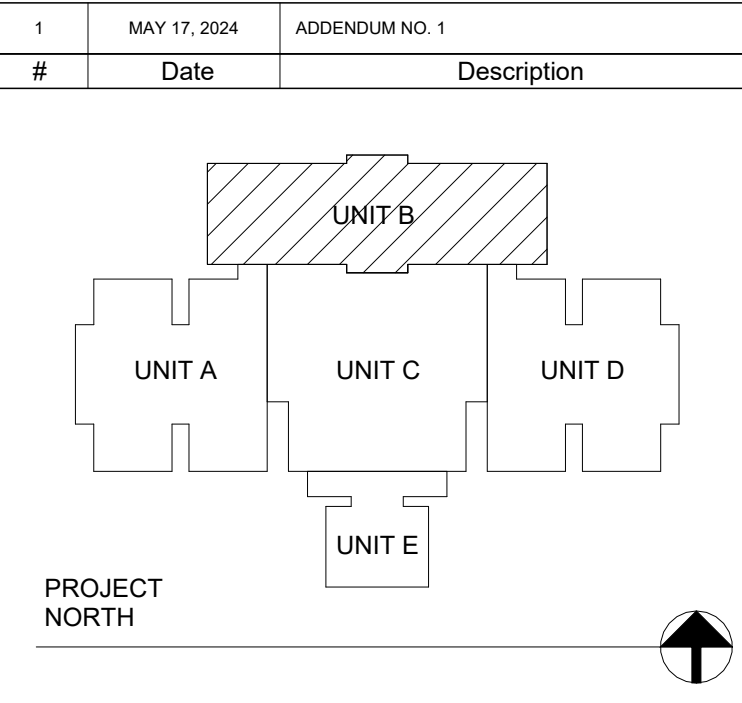

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STRUCTURAL: ENGINEERS:

Project Name:
RENOVATIONS TO RUSHVILLE ELEMENTARY SCHOOL

Drawing Title:
REFLECTED CEILING PLAN - UNIT B

	Client Project No:
	VPS Project No: 2023021.00
	Project Issue Date: 04/17/24
	Drawing No: A203



REFLECTED CEILING PLAN NOTES	
#	KEYNOTE INFORMATION

REFLECTED CEILING PLAN LEGEND

REFER TO MECHANICAL, ELECTRICAL AND/OR PLUMBING DRAWINGS FOR SPECIFICATIONS OF ITEMS

- INDICATES AREA OF 5/8" GYPSUM BOARD CEILING/SOFFIT/BULKHEAD ON 3 5/8" METAL STUDS @ 16" O.C. (U.N.O.) PAINT
- INDICATES 2' X 2' LAY-IN CEILING TILE WITH METAL GRID
- 2' x 4' RECESSED LIGHT FIXTURE
- 2' x 2' RECESSED LIGHT FIXTURE
- 1' x 4' RECESSED LIGHT FIXTURE
- STRIP FIXTURE WITH WIRE GUARD
- RECESSED CAN TYPE LIGHT FIXTURE
- 2' X 2' SUPPLY AIR
- 2' X 2' RETURN AIR
- EXHAUST FAN
- E.S. EXPOSED STRUCTURE
- M.E. MATCH EXISTING
- E.T.R. EXISTING TO REMAIN

GENERAL REFLECTED CEILING PLAN NOTES

- CEILING ELEVATION TAGS REFER TO HEIGHT ABOVE EITHER FINISHED SLAB IN AREAS OF NEW CONSTRUCTION & RENOVATION OR ABOVE EXISTING FINISH FLOOR IN AREAS TO REMAIN.
- CENTER PENETRATIONS IN ACOUSTICAL CEILING SYSTEMS WITHIN INDIVIDUAL CEILING PANELS, SUCH AS SPRINKLER HEADS, DIFFUSERS, LIGHT FIXTURES, ETC., UNLESS NOTED OTHERWISE.
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- REFER TO ELECTRICAL DRAWINGS FOR CEILING-MOUNTED LIGHT FIXTURE TYPES & QUANTITIES.
- REFER TO MECHANICAL DRAWINGS FOR CEILING-MOUNTED DIFFUSERS, GRILLE TYPES & QUANTITIES.
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- SHALL CONTINUE UP ADJACENT VERTICAL FACES.
- ALL GAPS BETWEEN WALL MOULD ANGLES & WALL FACE SHALL BE FILLED WITH SEALANT.



1	MAY 17, 2024	ADDENDUM NO. 1
#	Date	Description
PROJECT NORTH		

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Evansville, Indiana 47708
Indianapolis, Indiana 46204
www.VPSARCH.com

STRUCTURAL: ENGINEERS:

Project Name:
RENOVATIONS TO RUSHVILLE ELEMENTARY SCHOOL

Drawing Title:
REFLECTED CEILING PLAN - UNIT C

	Client Project No:	
	VPS Project No:	2023021.00
	Project Issue Date:	04/17/24
	Drawing No:	A204



REFLECTED CEILING PLAN NOTES	
#	KEYNOTE INFORMATION

REFLECTED CEILING PLAN LEGEND


REFER TO MECHANICAL, ELECTRICAL AND/OR PLUMBING DRAWINGS FOR SPECIFICATIONS OF ITEMS

- INDICATES AREA OF 5/8" GYPSUM BOARD CEILING/SOFFIT/BULKHEAD ON 3 5/8" METAL STUDS @ 16" O.C. (U.N.O.) PAINT
- INDICATES 2' X 2' LAY-IN CEILING TILE WITH METAL GRID
- 2' x 4' RECESSED LIGHT FIXTURE
- 2' x 2' RECESSED LIGHT FIXTURE
- 1' x 4' RECESSED LIGHT FIXTURE
- STRIP FIXTURE WITH WIRE GUARD
- RECESSED CAN TYPE LIGHT FIXTURE
- 2' X 2' SUPPLY AIR
- 2' X 2' RETURN AIR
- EXHAUST FAN
- E.S. EXPOSED STRUCTURE
- M.E. MATCH EXISTING
- E.T.R. EXISTING TO REMAIN

GENERAL REFLECTED CEILING PLAN NOTES

- CEILING ELEVATION TAGS REFER TO HEIGHT ABOVE EITHER FINISHED SLAB IN AREAS OF NEW CONSTRUCTION & RENOVATION OR ABOVE EXISTING FINISH FLOOR IN AREAS TO REMAIN.
- CENTER PENETRATIONS IN ACOUSTICAL CEILING SYSTEMS WITHIN INDIVIDUAL CEILING PANELS, SUCH AS SPRINKLER HEADS, DIFFUSERS, LIGHT FIXTURES, ETC., UNLESS NOTED OTHERWISE.
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- REFER TO MECHANICAL DRAWINGS FOR CEILING-MOUNTED DIFFUSERS, GRILLE TYPES & QUANTITIES.
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- SHALL CONTINUE UP ADJACENT VERTICAL FACES.
- ALL GAPS BETWEEN WALL MOULD ANGLES & WALL FACE SHALL BE FILLED WITH SEALANT.

1
A205
REFLECTED CEILING PLAN - UNIT D
1/8" = 1'-0"

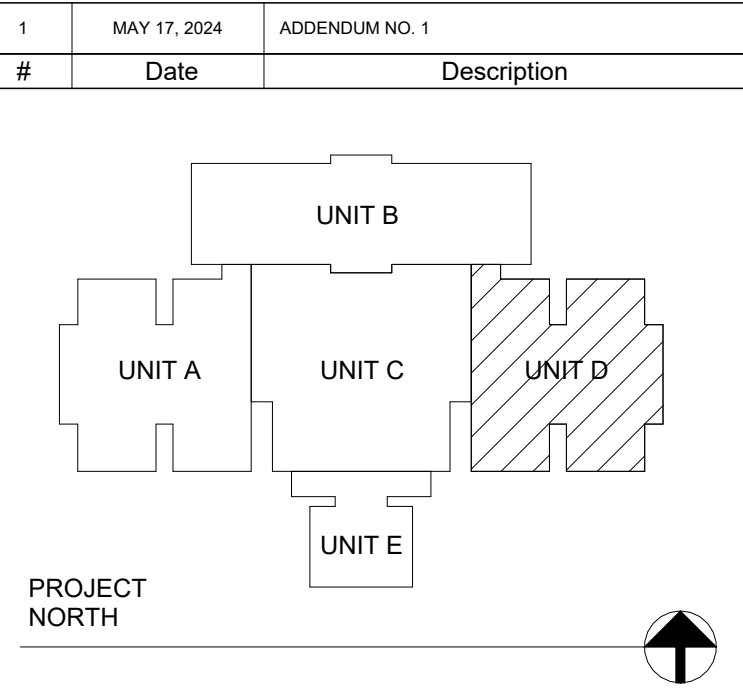

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Indianapolis, Indiana 46204
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STRUCTURAL: ENGINEERS:

Project Name:
**RENOVATIONS TO
RUSHVILLE ELEMENTARY
SCHOOL**

Drawing Title:
REFLECTED CEILING PLAN - UNIT D

	Client Project No:
	VPS Project No: 2023021.00
	Project Issue Date: 04/17/24
	Drawing No: A205

REFLECTED CEILING PLAN NOTES	
#	KEYNOTE INFORMATION

REFLECTED CEILING PLAN LEGEND

REFER TO MECHANICAL, ELECTRICAL AND/OR PLUMBING DRAWINGS FOR SPECIFICATIONS OF ITEMS

- INDICATES AREA OF 5/8" GYPSUM BOARD CEILING/SOFFIT/BULKHEAD ON 3 5/8" METAL STUDS @ 16" O.C. (U.N.O.) PAINT
- INDICATES 2' X 2' LAY-IN CEILING TILE WITH METAL GRID
- 2' x 4' RECESSED LIGHT FIXTURE
- 2' x 2' RECESSED LIGHT FIXTURE
- 1' x 4' RECESSED LIGHT FIXTURE
- STRIP FIXTURE WITH WIRE GUARD
- RECESSED CAN TYPE LIGHT FIXTURE
- 2' X 2' SUPPLY AIR
- 2' X 2' RETURN AIR
- EXHAUST FAN
- E.S.


EXPOSED STRUCTURE
- M.E.

MATCH EXISTING
- E.T.R.


EXISTING TO REMAIN

GENERAL REFLECTED CEILING PLAN NOTES

- CEILING ELEVATION TAGS REFER TO HEIGHT ABOVE EITHER FINISHED SLAB IN AREAS OF NEW CONSTRUCTION & RENOVATION OR ABOVE EXISTING FINISH FLOOR IN AREAS TO REMAIN.
- CENTER PENETRATIONS IN ACOUSTICAL CEILING SYSTEMS WITHIN INDIVIDUAL CEILING PANELS, SUCH AS SPRINKLER HEADS, DIFFUSERS, LIGHT FIXTURES, ETC., UNLESS NOTED OTHERWISE.
- PAINT ALL EXPOSED GYP. BD FROM SPECIFIC SURFACES U.N.O.
- REFER TO ELECTRICAL DRAWINGS FOR CEILING-MOUNTED LIGHT FIXTURE TYPES & QUANTITIES.
- REFER TO MECHANICAL DRAWINGS FOR CEILING-MOUNTED DIFFUSERS, GRILLE TYPES & QUANTITIES.
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- SHALL CONTINUE UP ADJACENT VERTICAL FACES.
- ALL GAPS BETWEEN WALL MOULD ANGLES & WALL FACE SHALL BE FILLED WITH SEALANT.

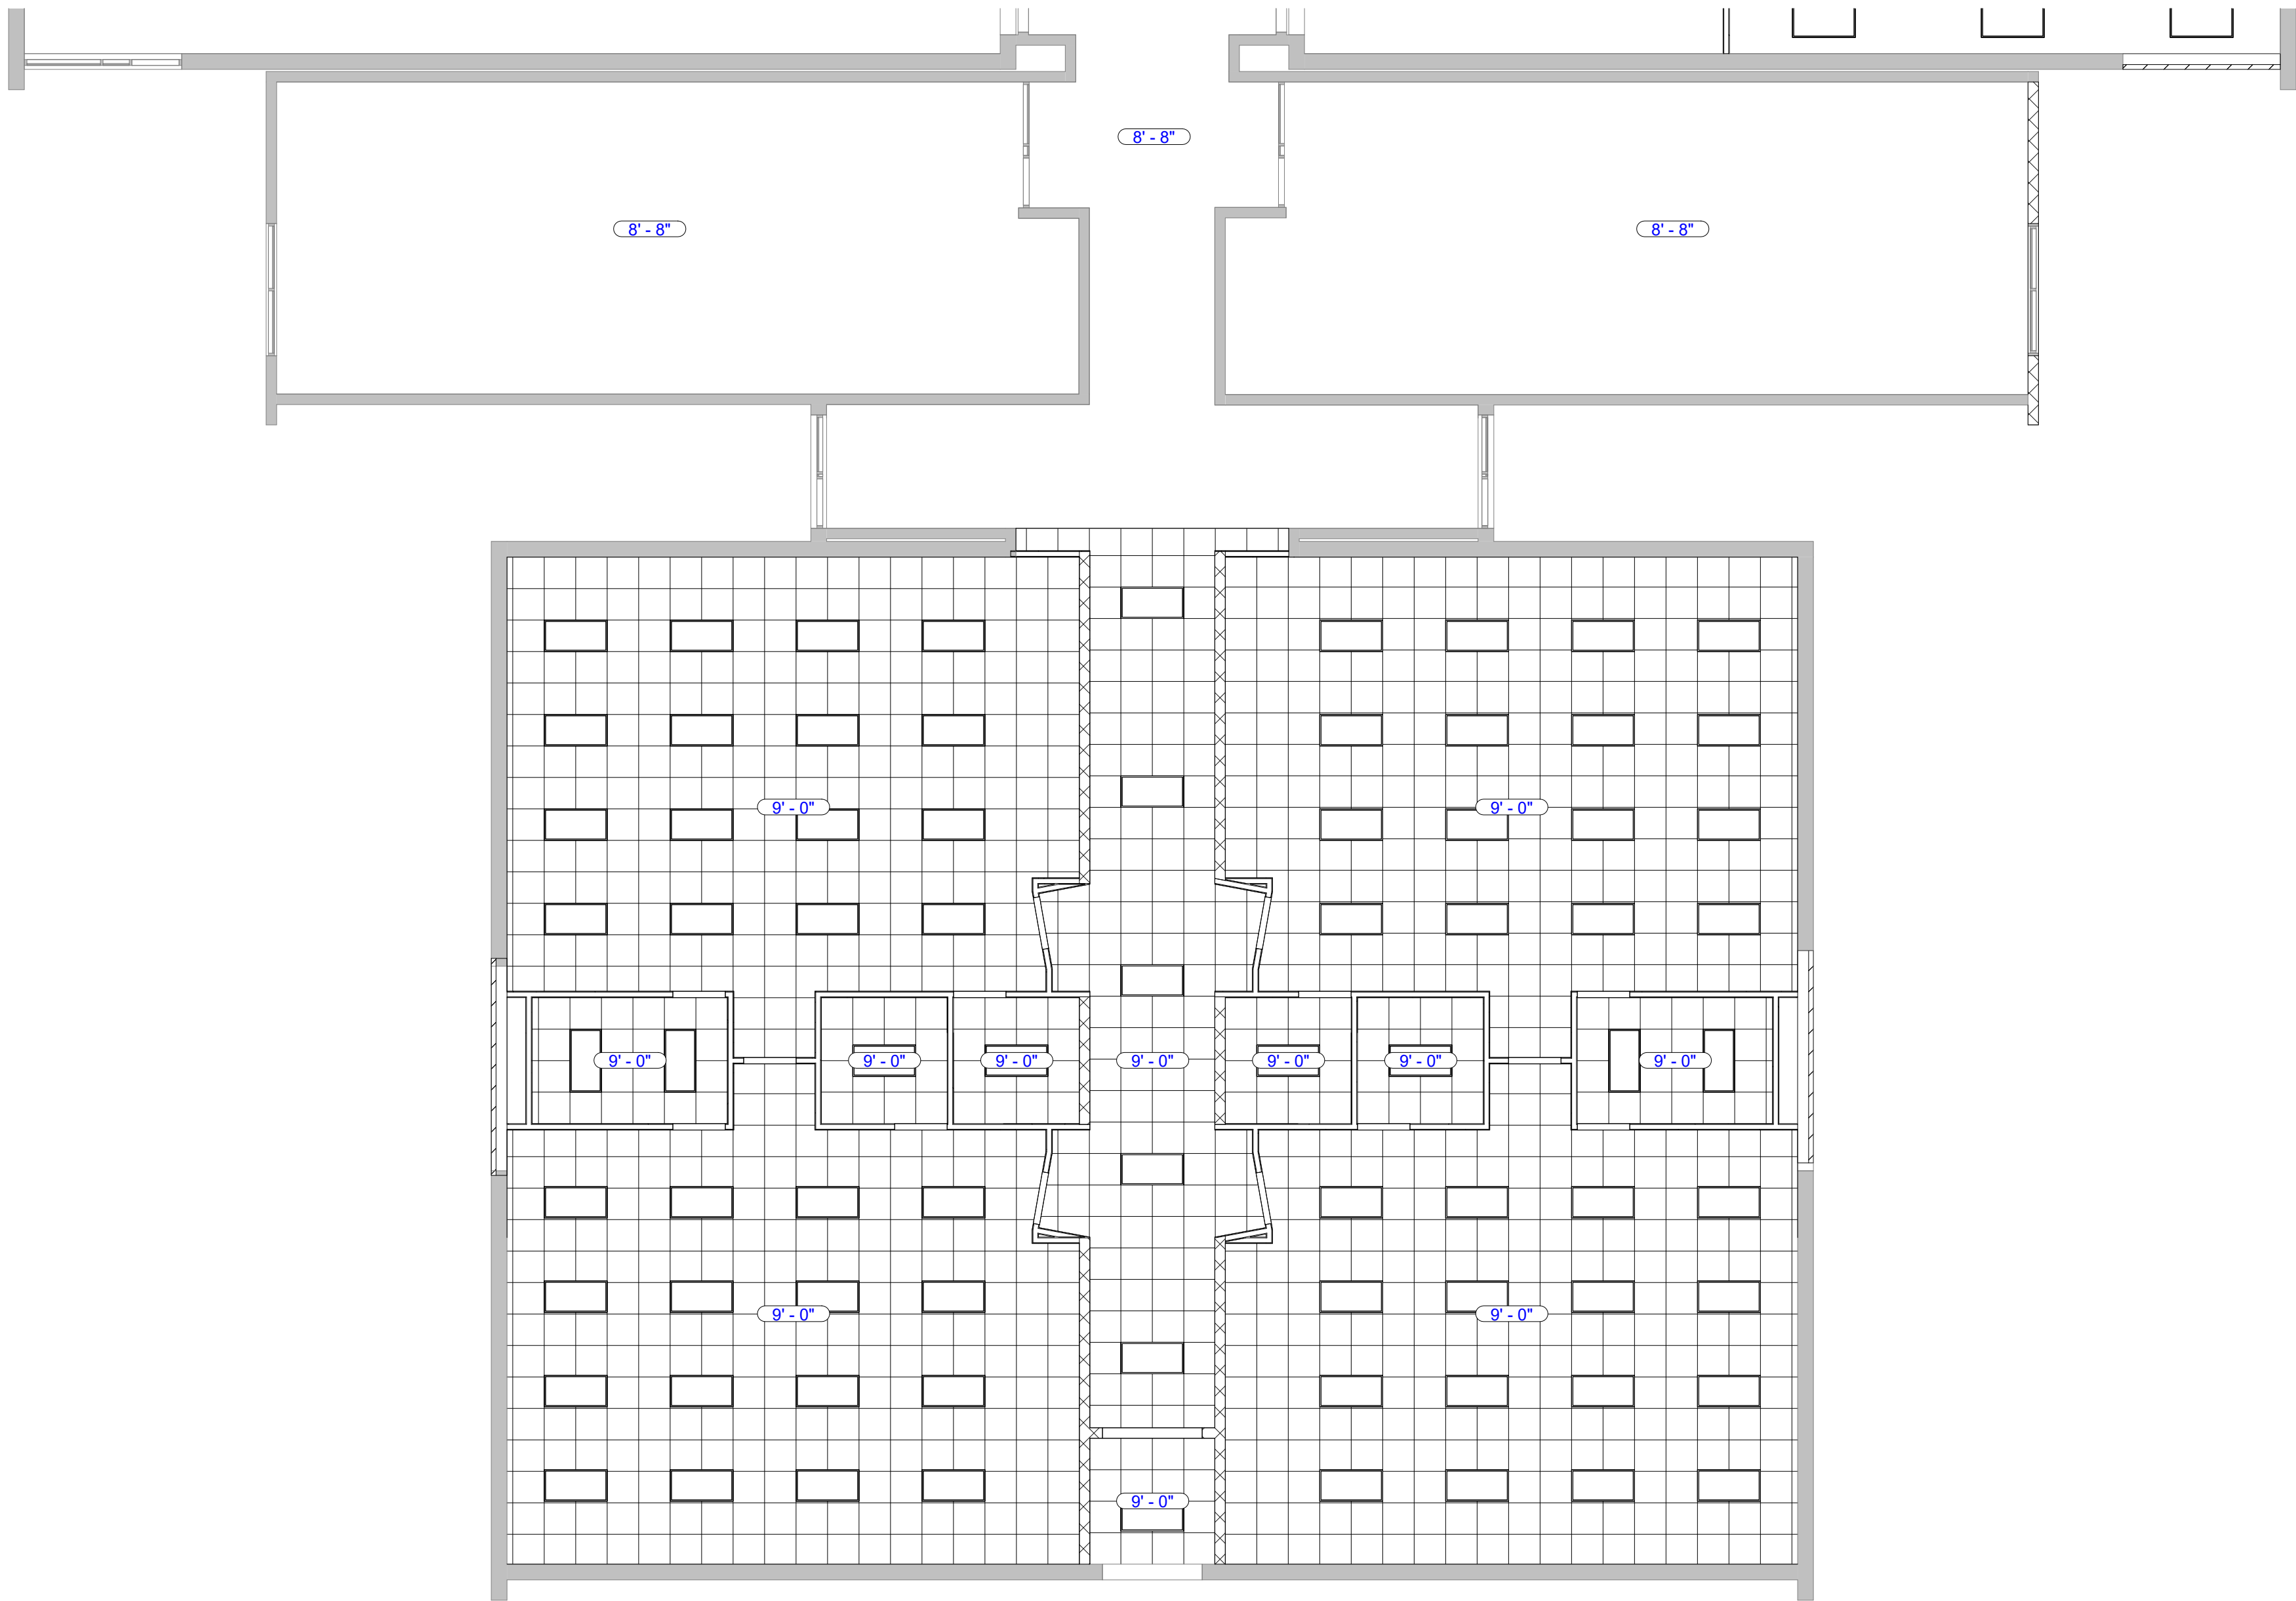

1 REFLECTED CEILING PLAN - UNIT E
A206 1/8" = 1'-0"

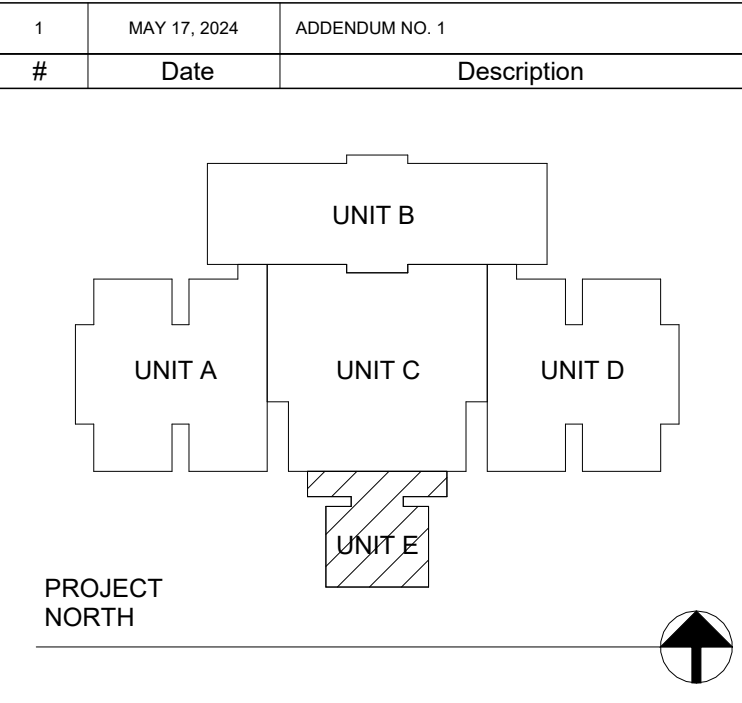

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PH: (317) 353-3281 www.VPSARCH.com

STRUCTURAL: ENGINEERS:

Project Name:
**RENOVATIONS TO
RUSHVILLE ELEMENTARY
SCHOOL**

Drawing Title:
REFLECTED CEILING PLAN - UNIT E


Client Project No:
VPS Project No:
Project Issue Date:
Drawing No:

2023021.00


04/17/24

A206


#	KEYNOTE INFORMATION
1	WALL HUNG WATER CLOSET
2	ACCESSABLE URINAL
3	TOILET PARTITION SYSTEM (SOLID PLASTIC)
4	SOLID PLASTIC URINAL SCREEN (18" DP.)
5	THREE STATION HANDWASHING LAVATORY
6	SINGLE HANDWASHING LAVATORY
7	SOAP DISPENSER (BY OWNER)
8	16"W. x 30"H.T. MIRROR
9	PAPER TOWEL DISPENSER (BY OWNER)
10	GRAB BAR (LENGTH INDICATED)
11	VERTICAL GRAB BAR (18"H.T.)
12	TOILET PAPER DISPENSER (BY OWNER)
13	CHANGING TABLE
14	SHOWER
15	BOOK SHELF 72"H.T. (LENGTH INDICATED)
16	BOOK SHELF 60"H.T. (LENGTH INDICATED)
17	BOOK SHELF 36"H.T. (LENGTH INDICATED)
18	NEW WALL PADDING. SEE SPECIFICATIONS. PROVIDE ADDITIONAL ACOUSTICAL BATT INSULATION IN ADJACENT WALLS AND ABOVE CEILING.

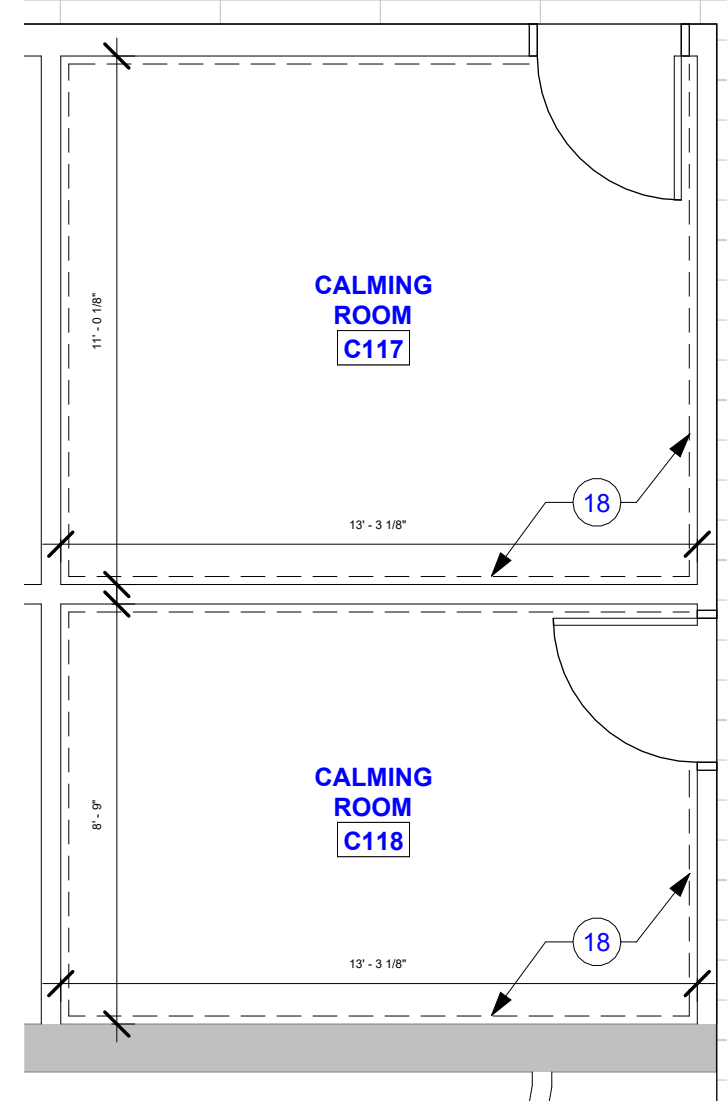


1 ENLARGED PLAN - CALMING ROOMS
1/4" = 1'-0"

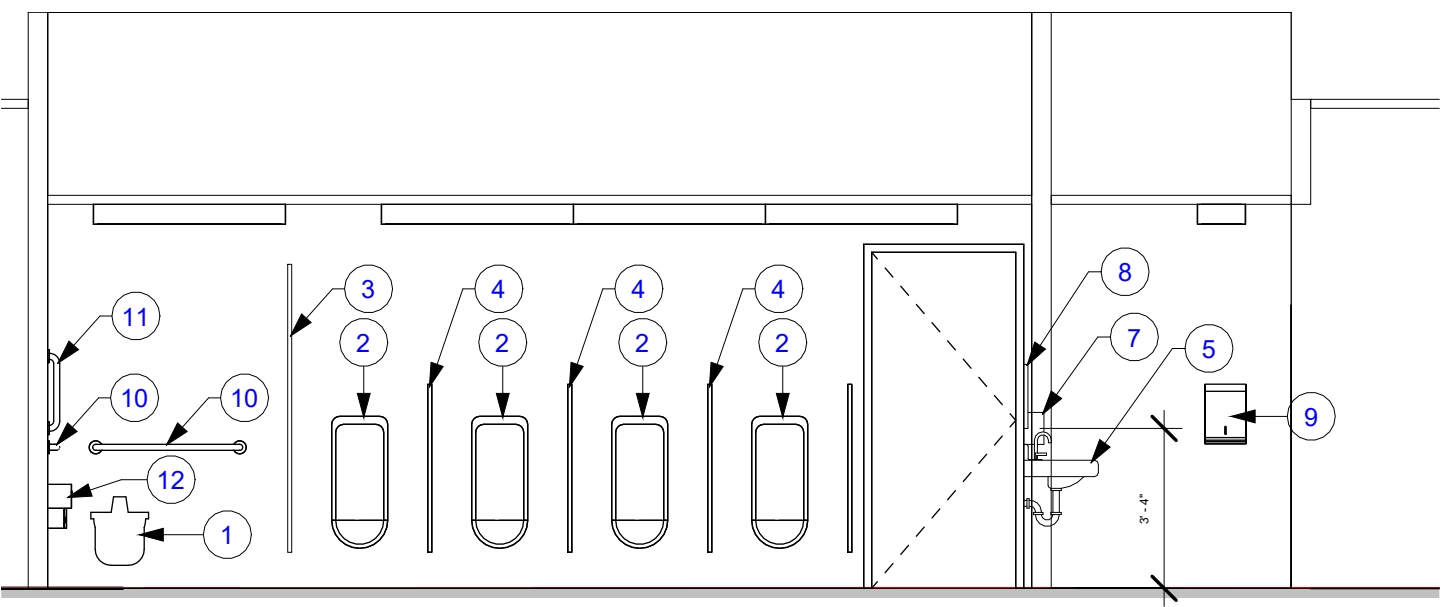


5 ENLARGED TOILET ELEVATION
A503 1/4" = 1'-0"

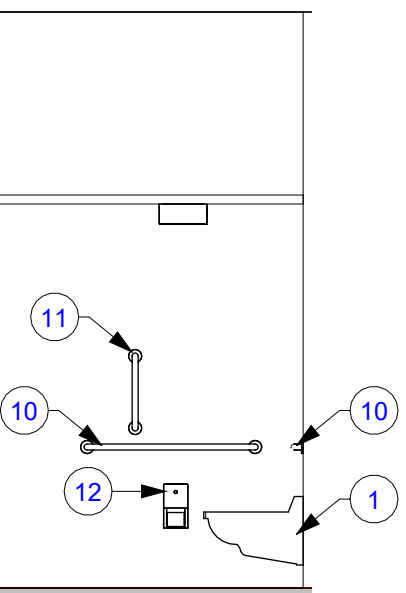


6 ENLARGED TOILET ELEVATION
A503 1/4" = 1'-0"

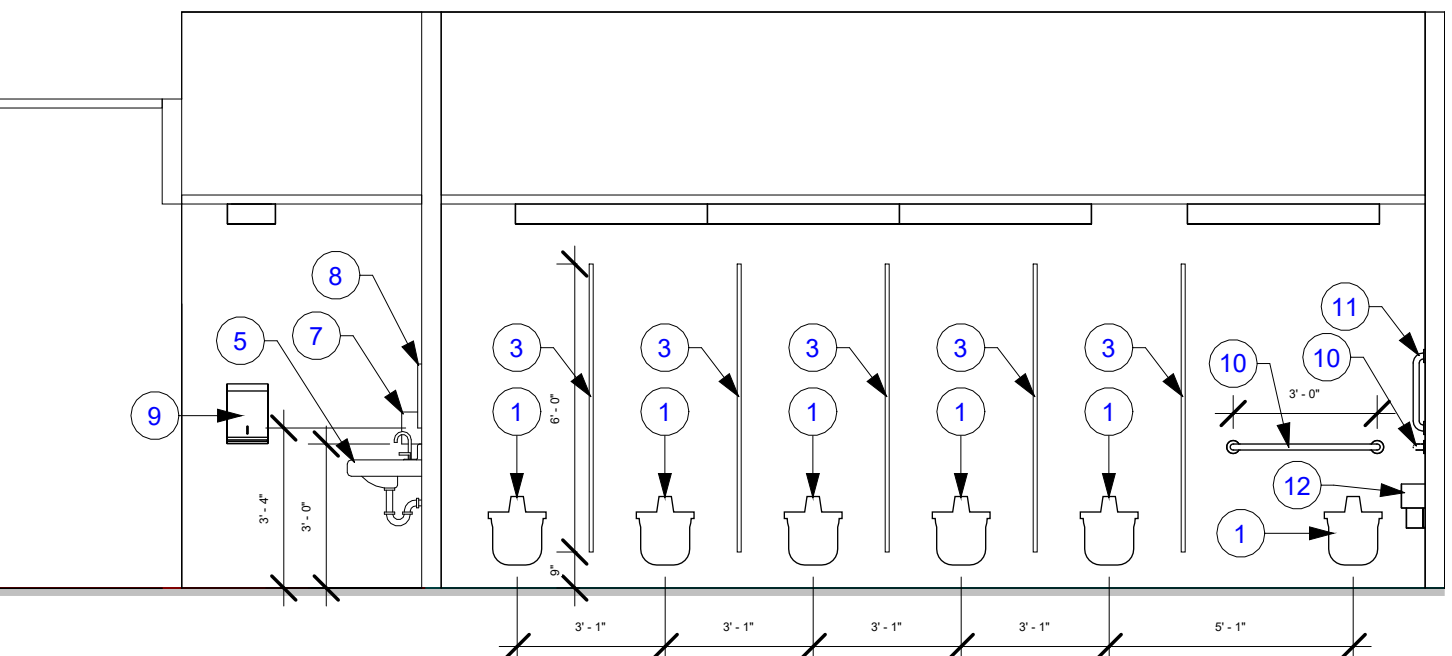

4 ENLARGED TOILET ELEVATION
A503 1/4" = 1'-0"

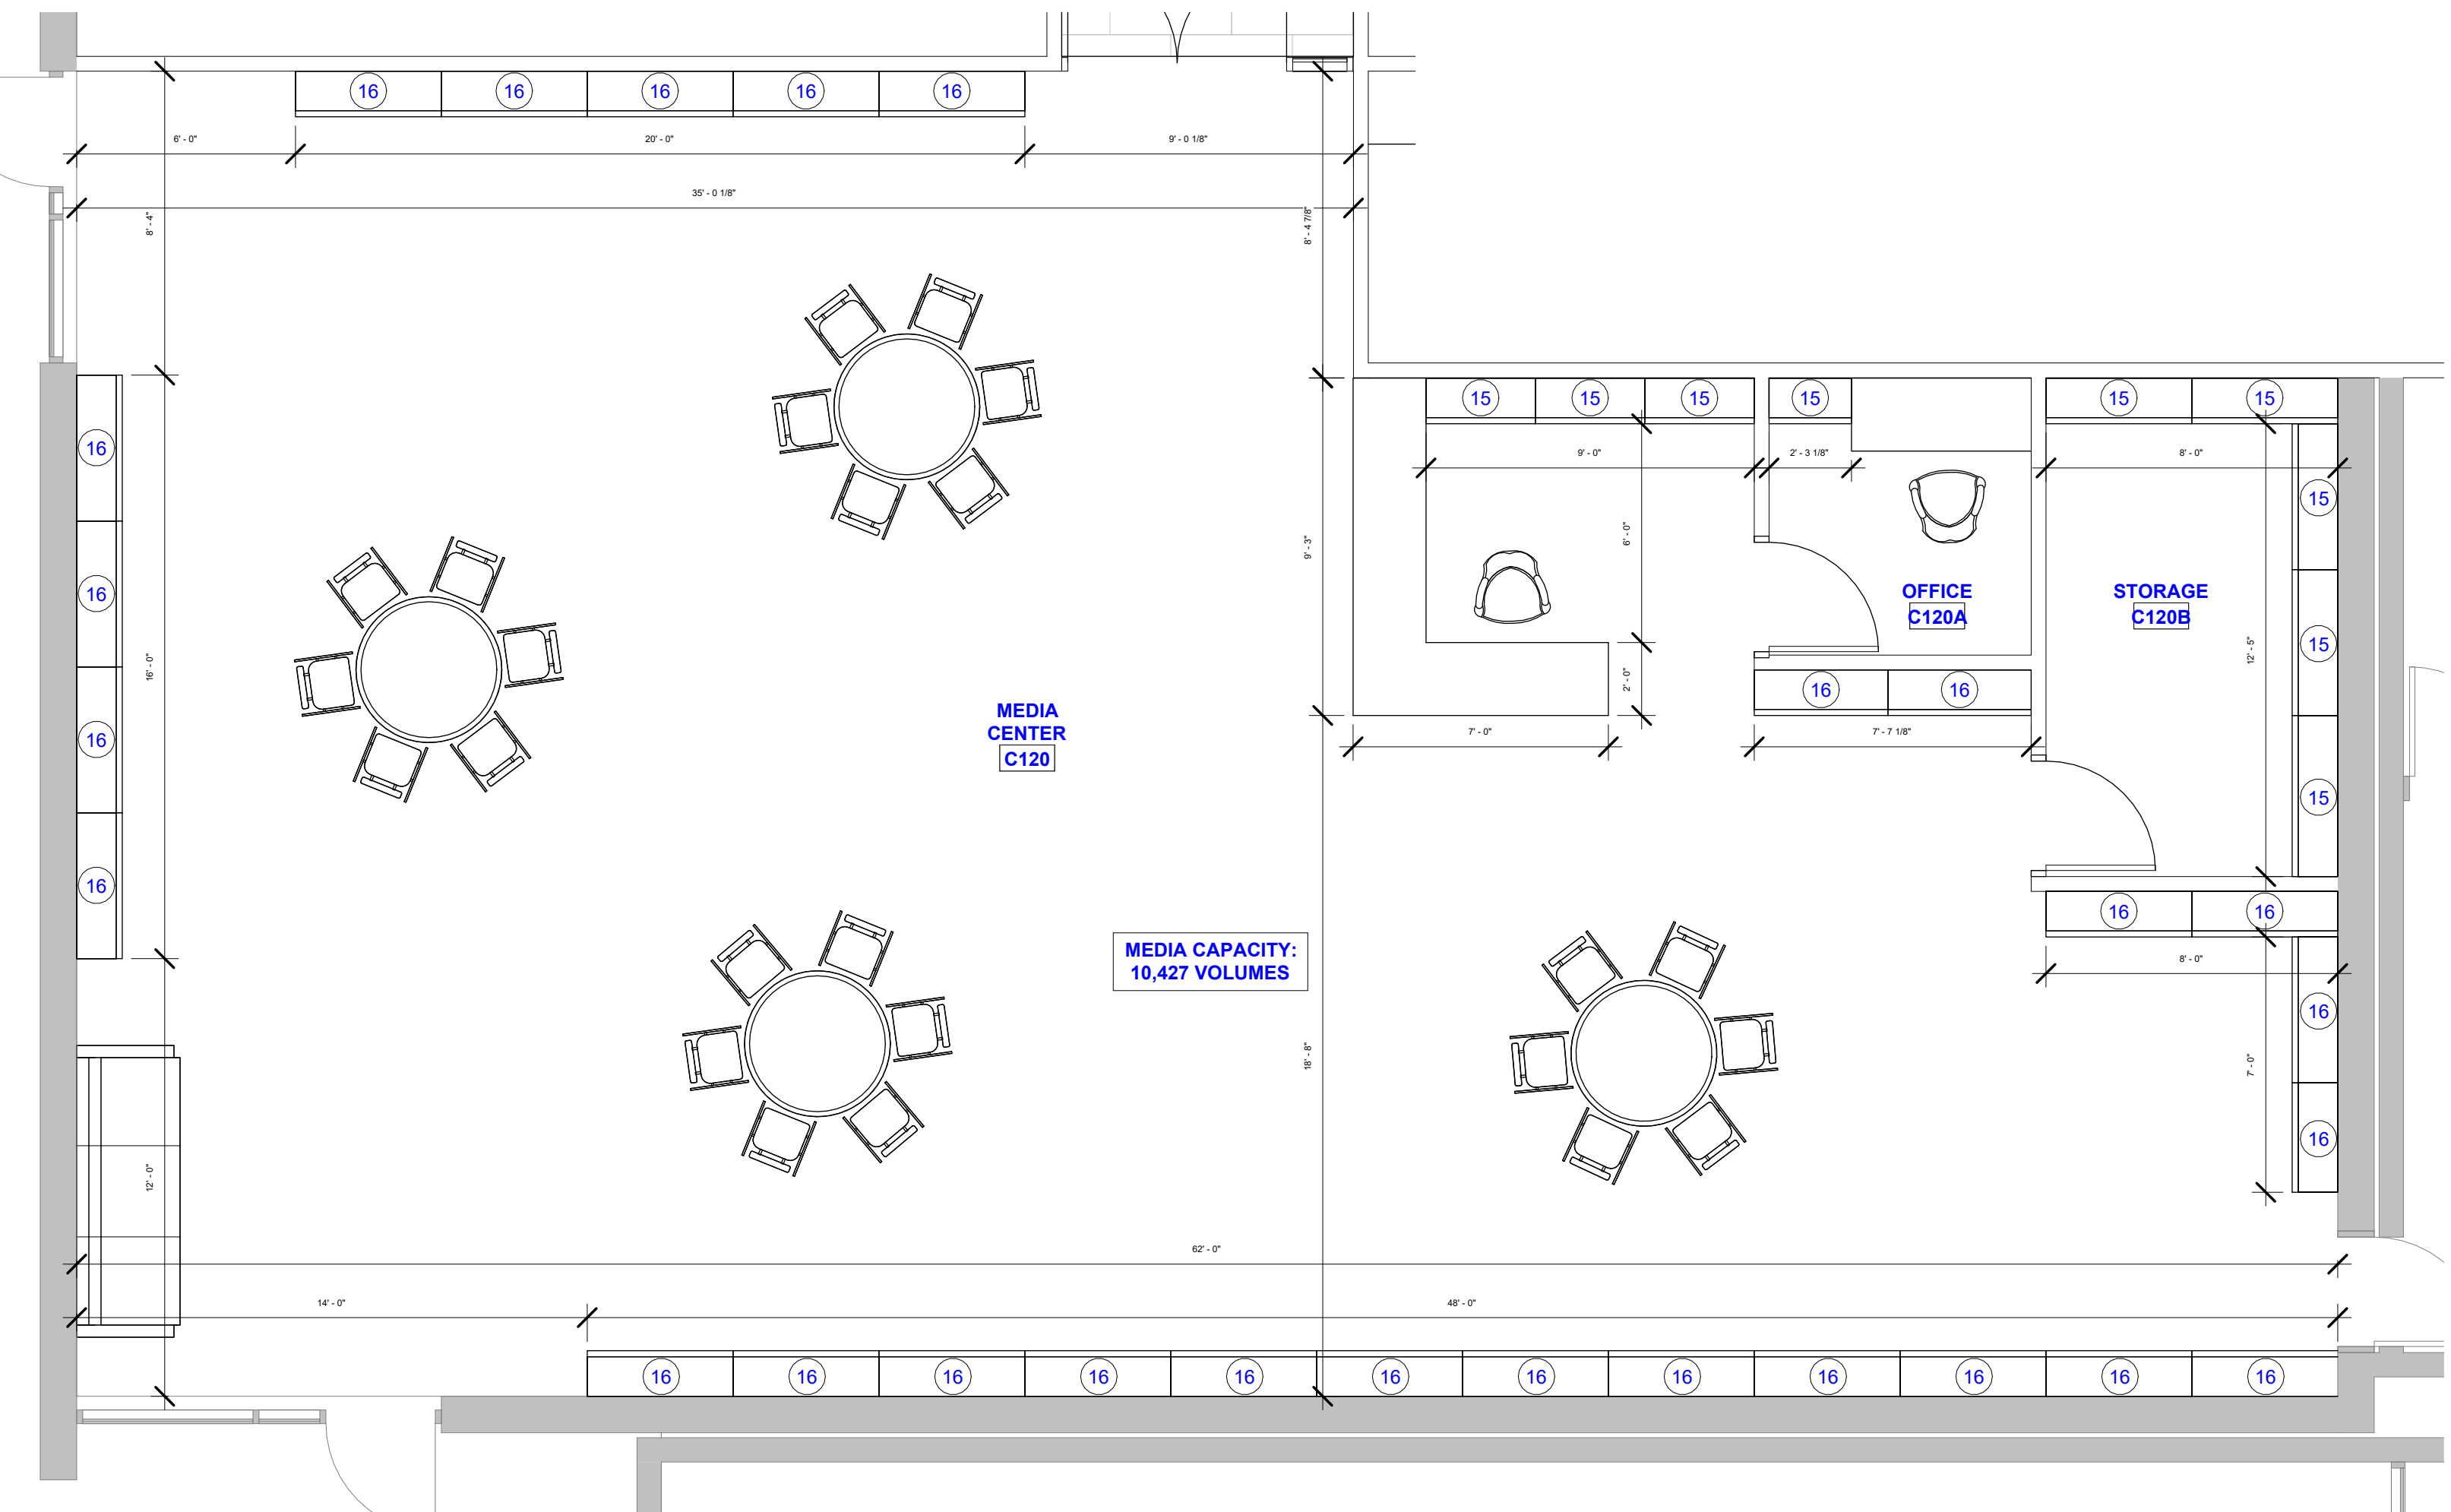

3 ENLARGED PLAN - MEDIA CENTER
A503 1/4" = 1'-0"

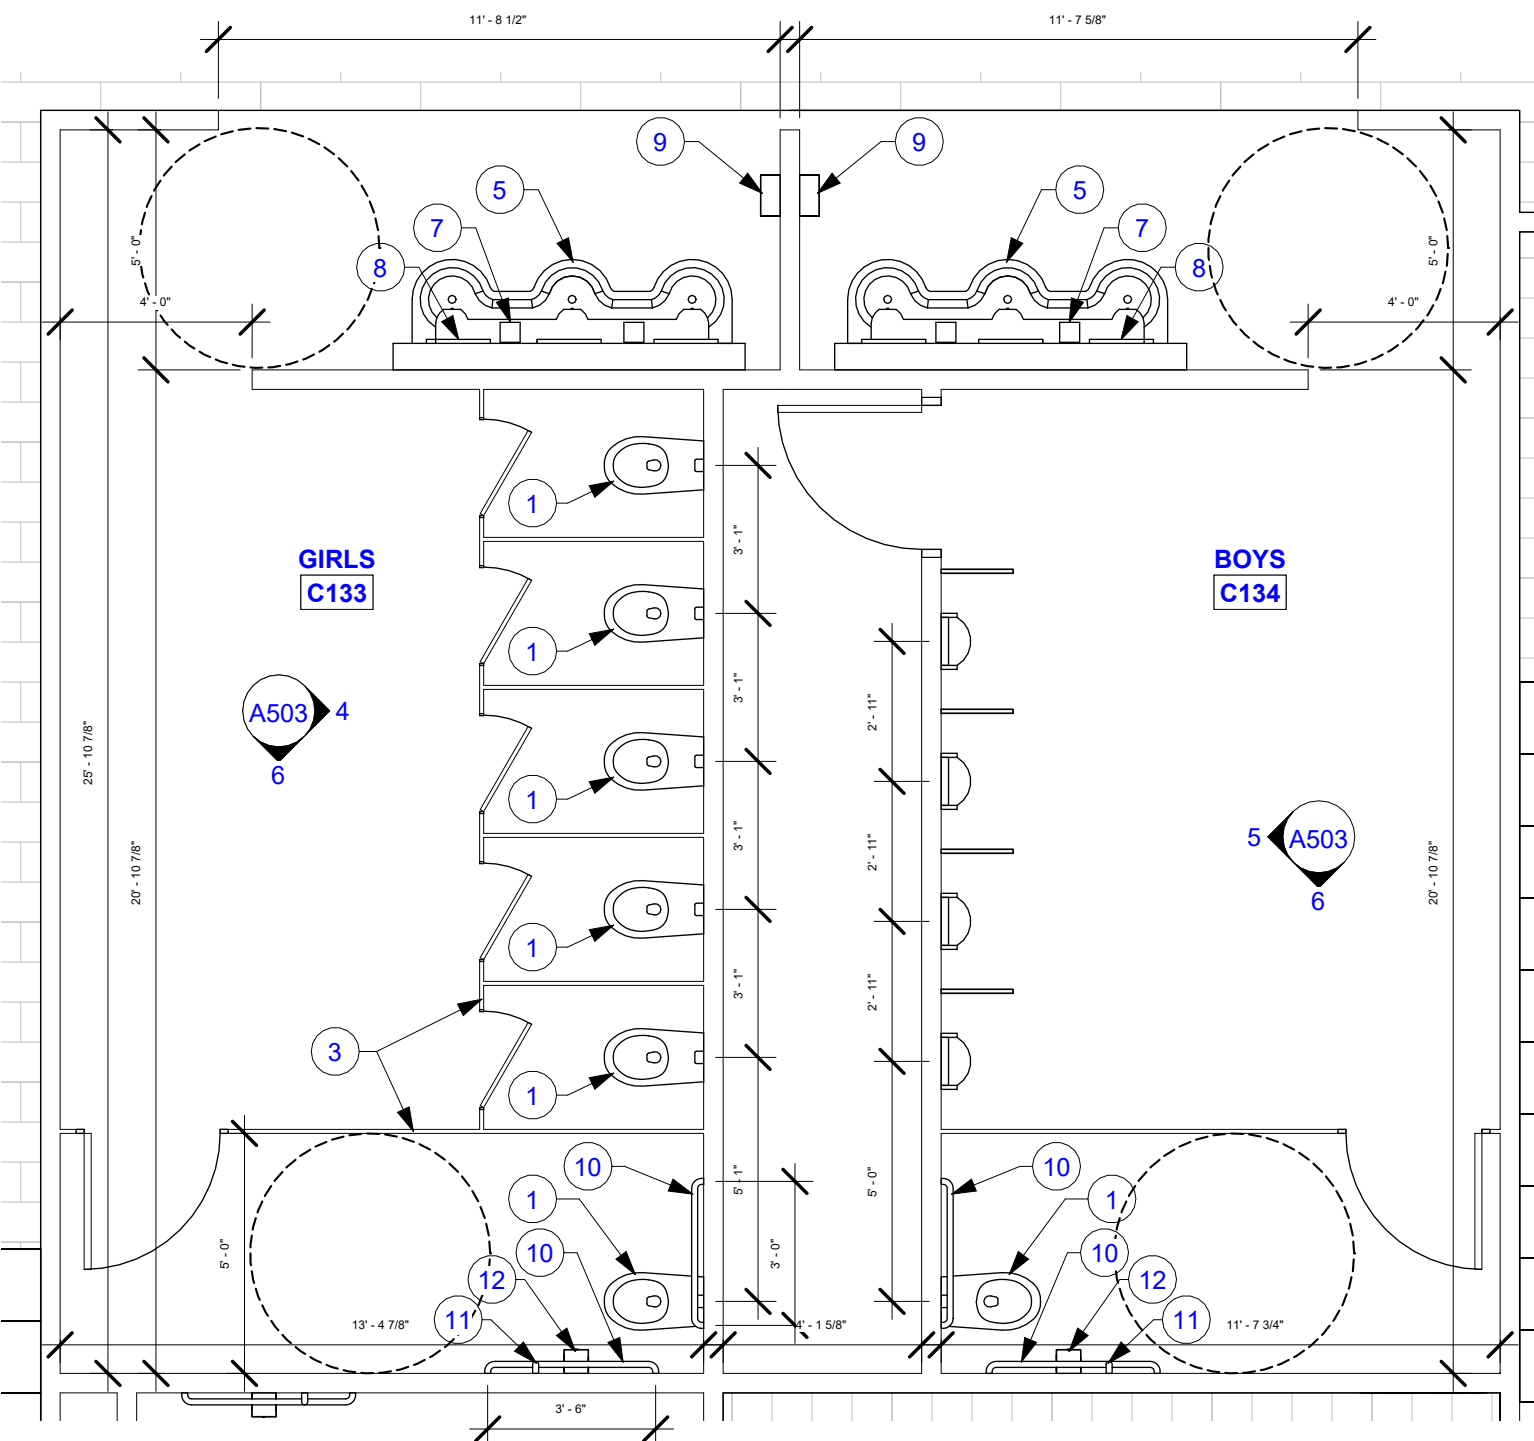

2 ENLARGED PLAN - GIRLS TOILET UNIT C
A503 1/4" = 1'-0"



#	Date	ADDENDUM NO. 1	Description
1	MAY 17, 2024		

UNIT A

UNIT B

UNIT C

UNIT D

UNIT E

PROJECT NORTH

VPS ARCHITECTURE
528 Main Street - Suite 400
905 North Capitol Avenue - Suite 100
PH: (317) 353-3281

Evansville, Indiana 47708
Indianapolis, Indiana 46204
www.VPSARCH.com


STRUCTURAL ENGINEERS:

Project Name:
RENOVATIONS TO RUSHVILLE ELEMENTARY SCHOOL


Drawing Title:
TOILET & MEDIA CENTER ENLARGED PLAN & DETAILS

	Client Project No:
	VPS Project No: 2023021.00
	Project Issue Date: 04/17/24
	Drawing No: A503


ENLARGED PLAN NOTES	
#	KEYNOTE INFORMATION
1	WALL HUNG WATER CLOSET
2	ACCESSABLE URINAL
3	TOILET PARTITION SYSTEM (SOLID PLASTIC)
4	SOLID PLASTIC URINAL SCREEN (18" DP.)
5	THREE STATION HANDWASHING LAVATORY
6	SINGLE HANDWASHING LAVATORY
7	SOAP DISPENSER (BY OWNER)
8	16"W. x 30"H.T. MIRROR
9	PAPER TOWEL DISPENSER (BY OWNER)
10	GRAB BAR (LENGTH INDICATED)
11	VERTICAL GRAB BAR (18"H.T.)
12	TOILET PAPER DISPENSER (BY OWNER)
13	CHANGING TABLE
14	SHOWER
15	BOOK SHELF 72"H.T. (LENGTH INDICATED)
16	BOOK SHELF 60"H.T. (LENGTH INDICATED)
17	BOOK SHELF 36"H.T. (LENGTH INDICATED)
18	NEW WALL PADDING. SEE SPECIFICATIONS. PROVIDE ADDITIONAL ACOUSTICAL BATT INSULATION IN ADJACENT WALLS AND ABOVE CEILING.

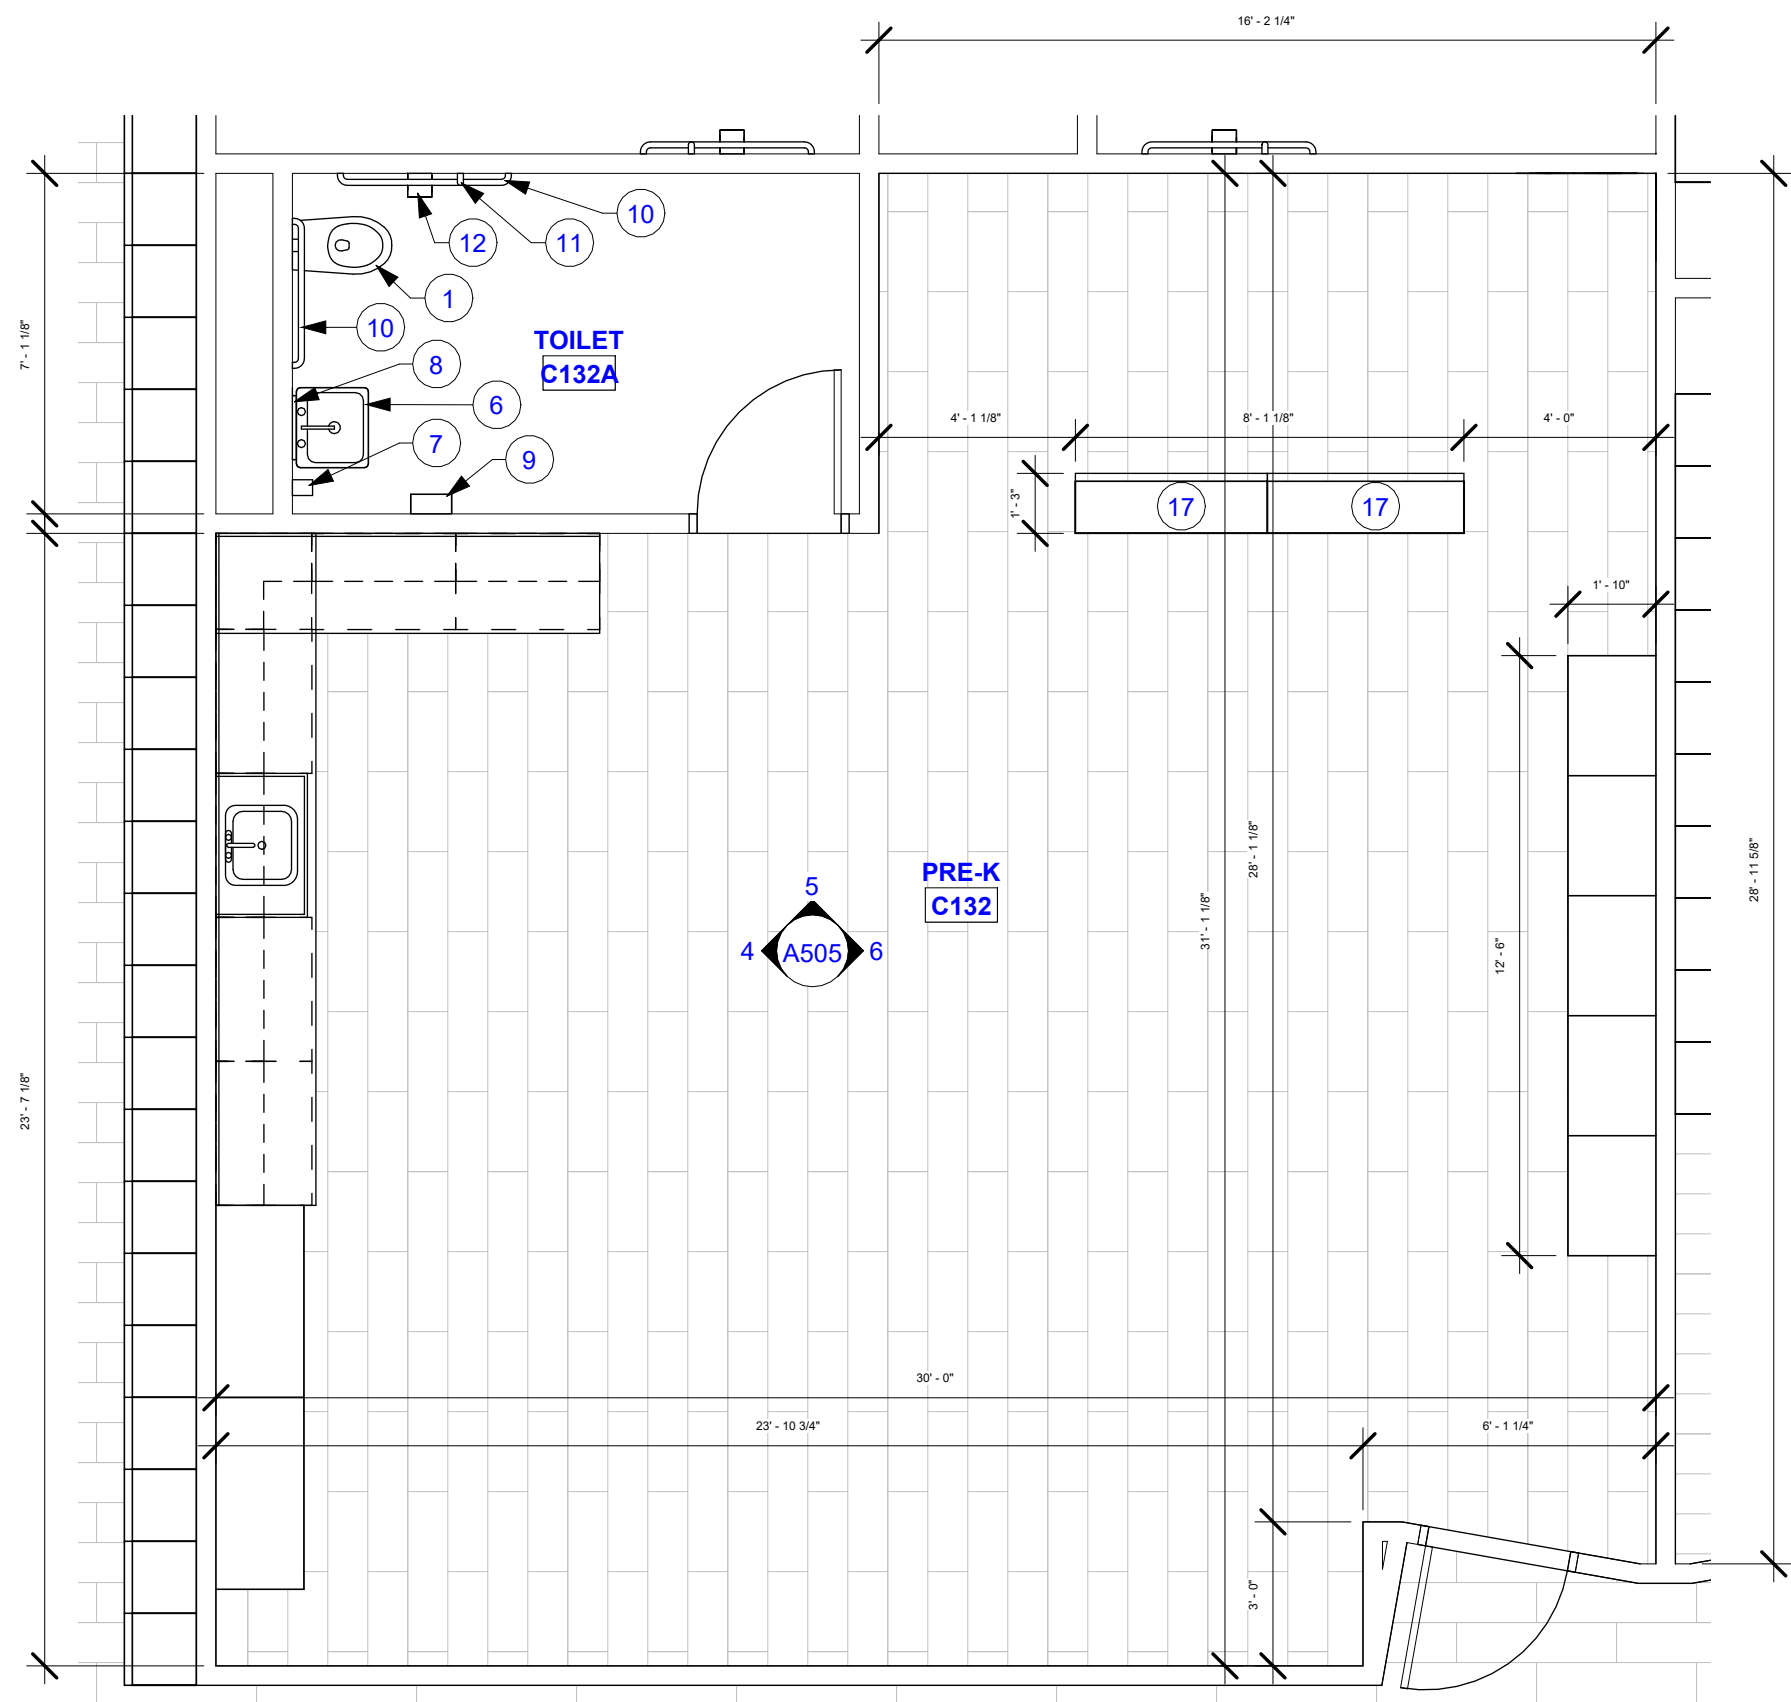

2 ENLARGED PLAN - GENERAL PRE-K
A504 / 1/4" = 1'-0"

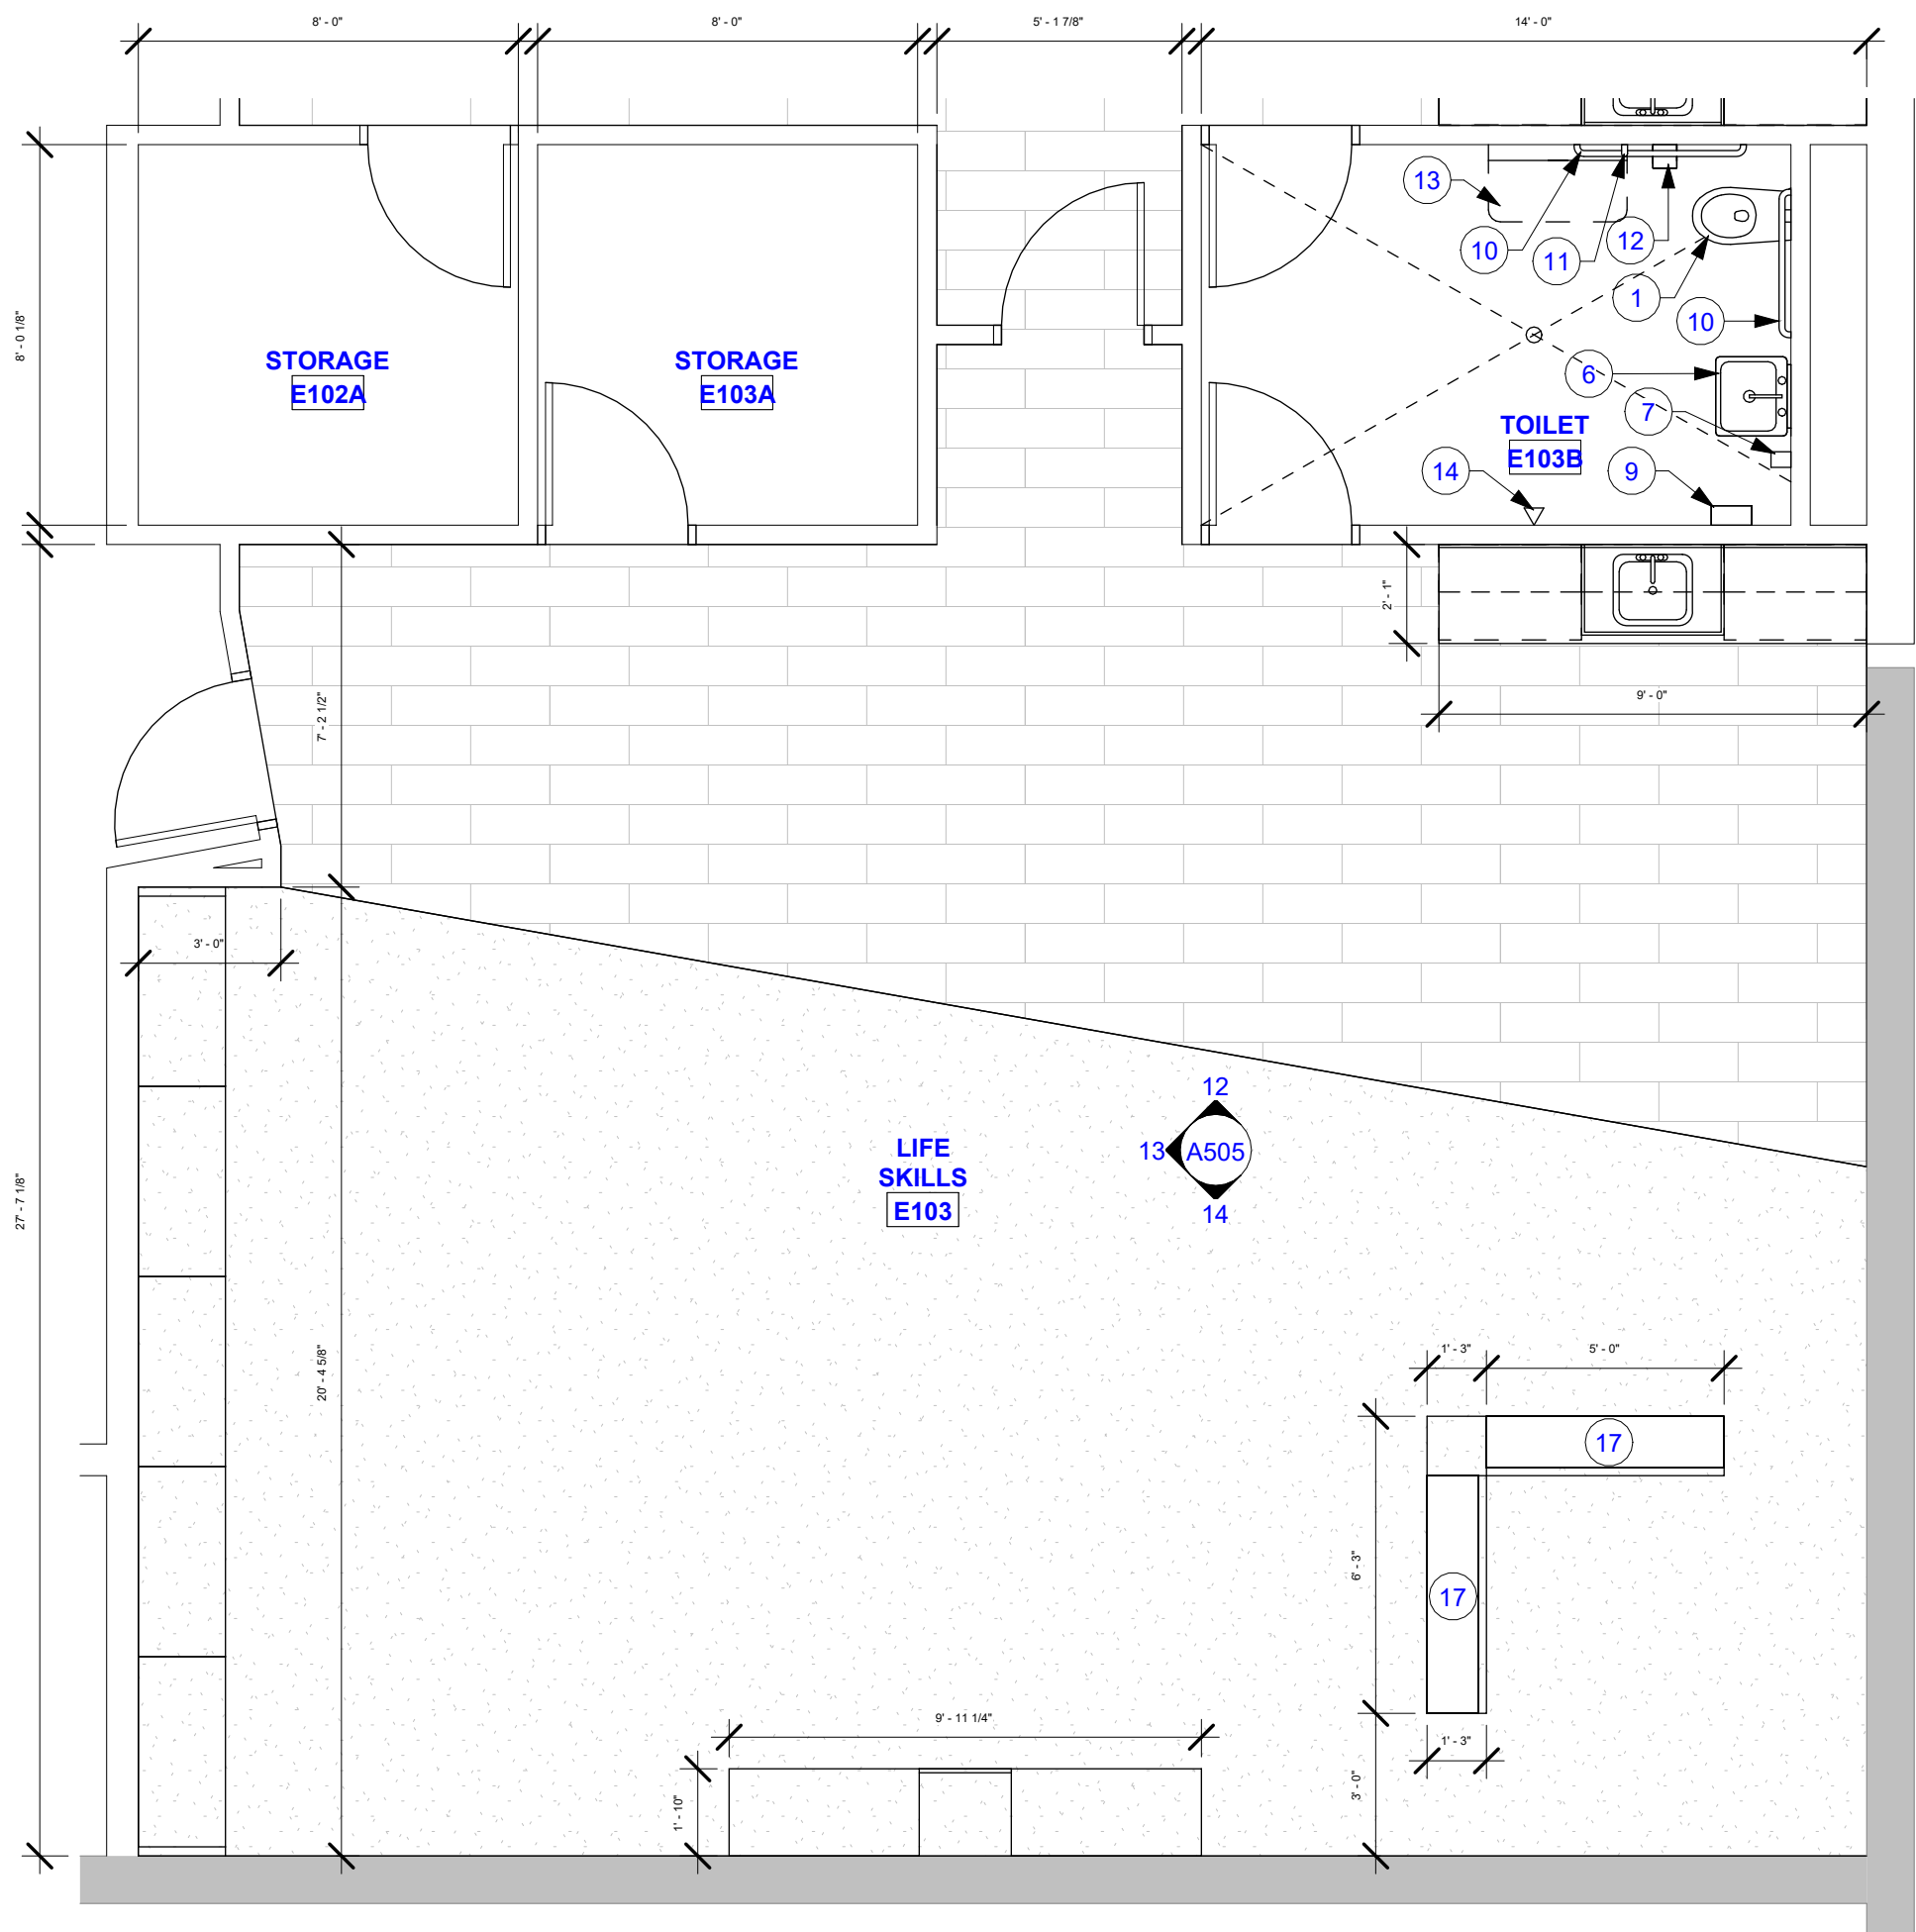

3 ENLARGED PLAN - LIFE SKILLS / PRE
A504 / 1/4" = 1'-0"

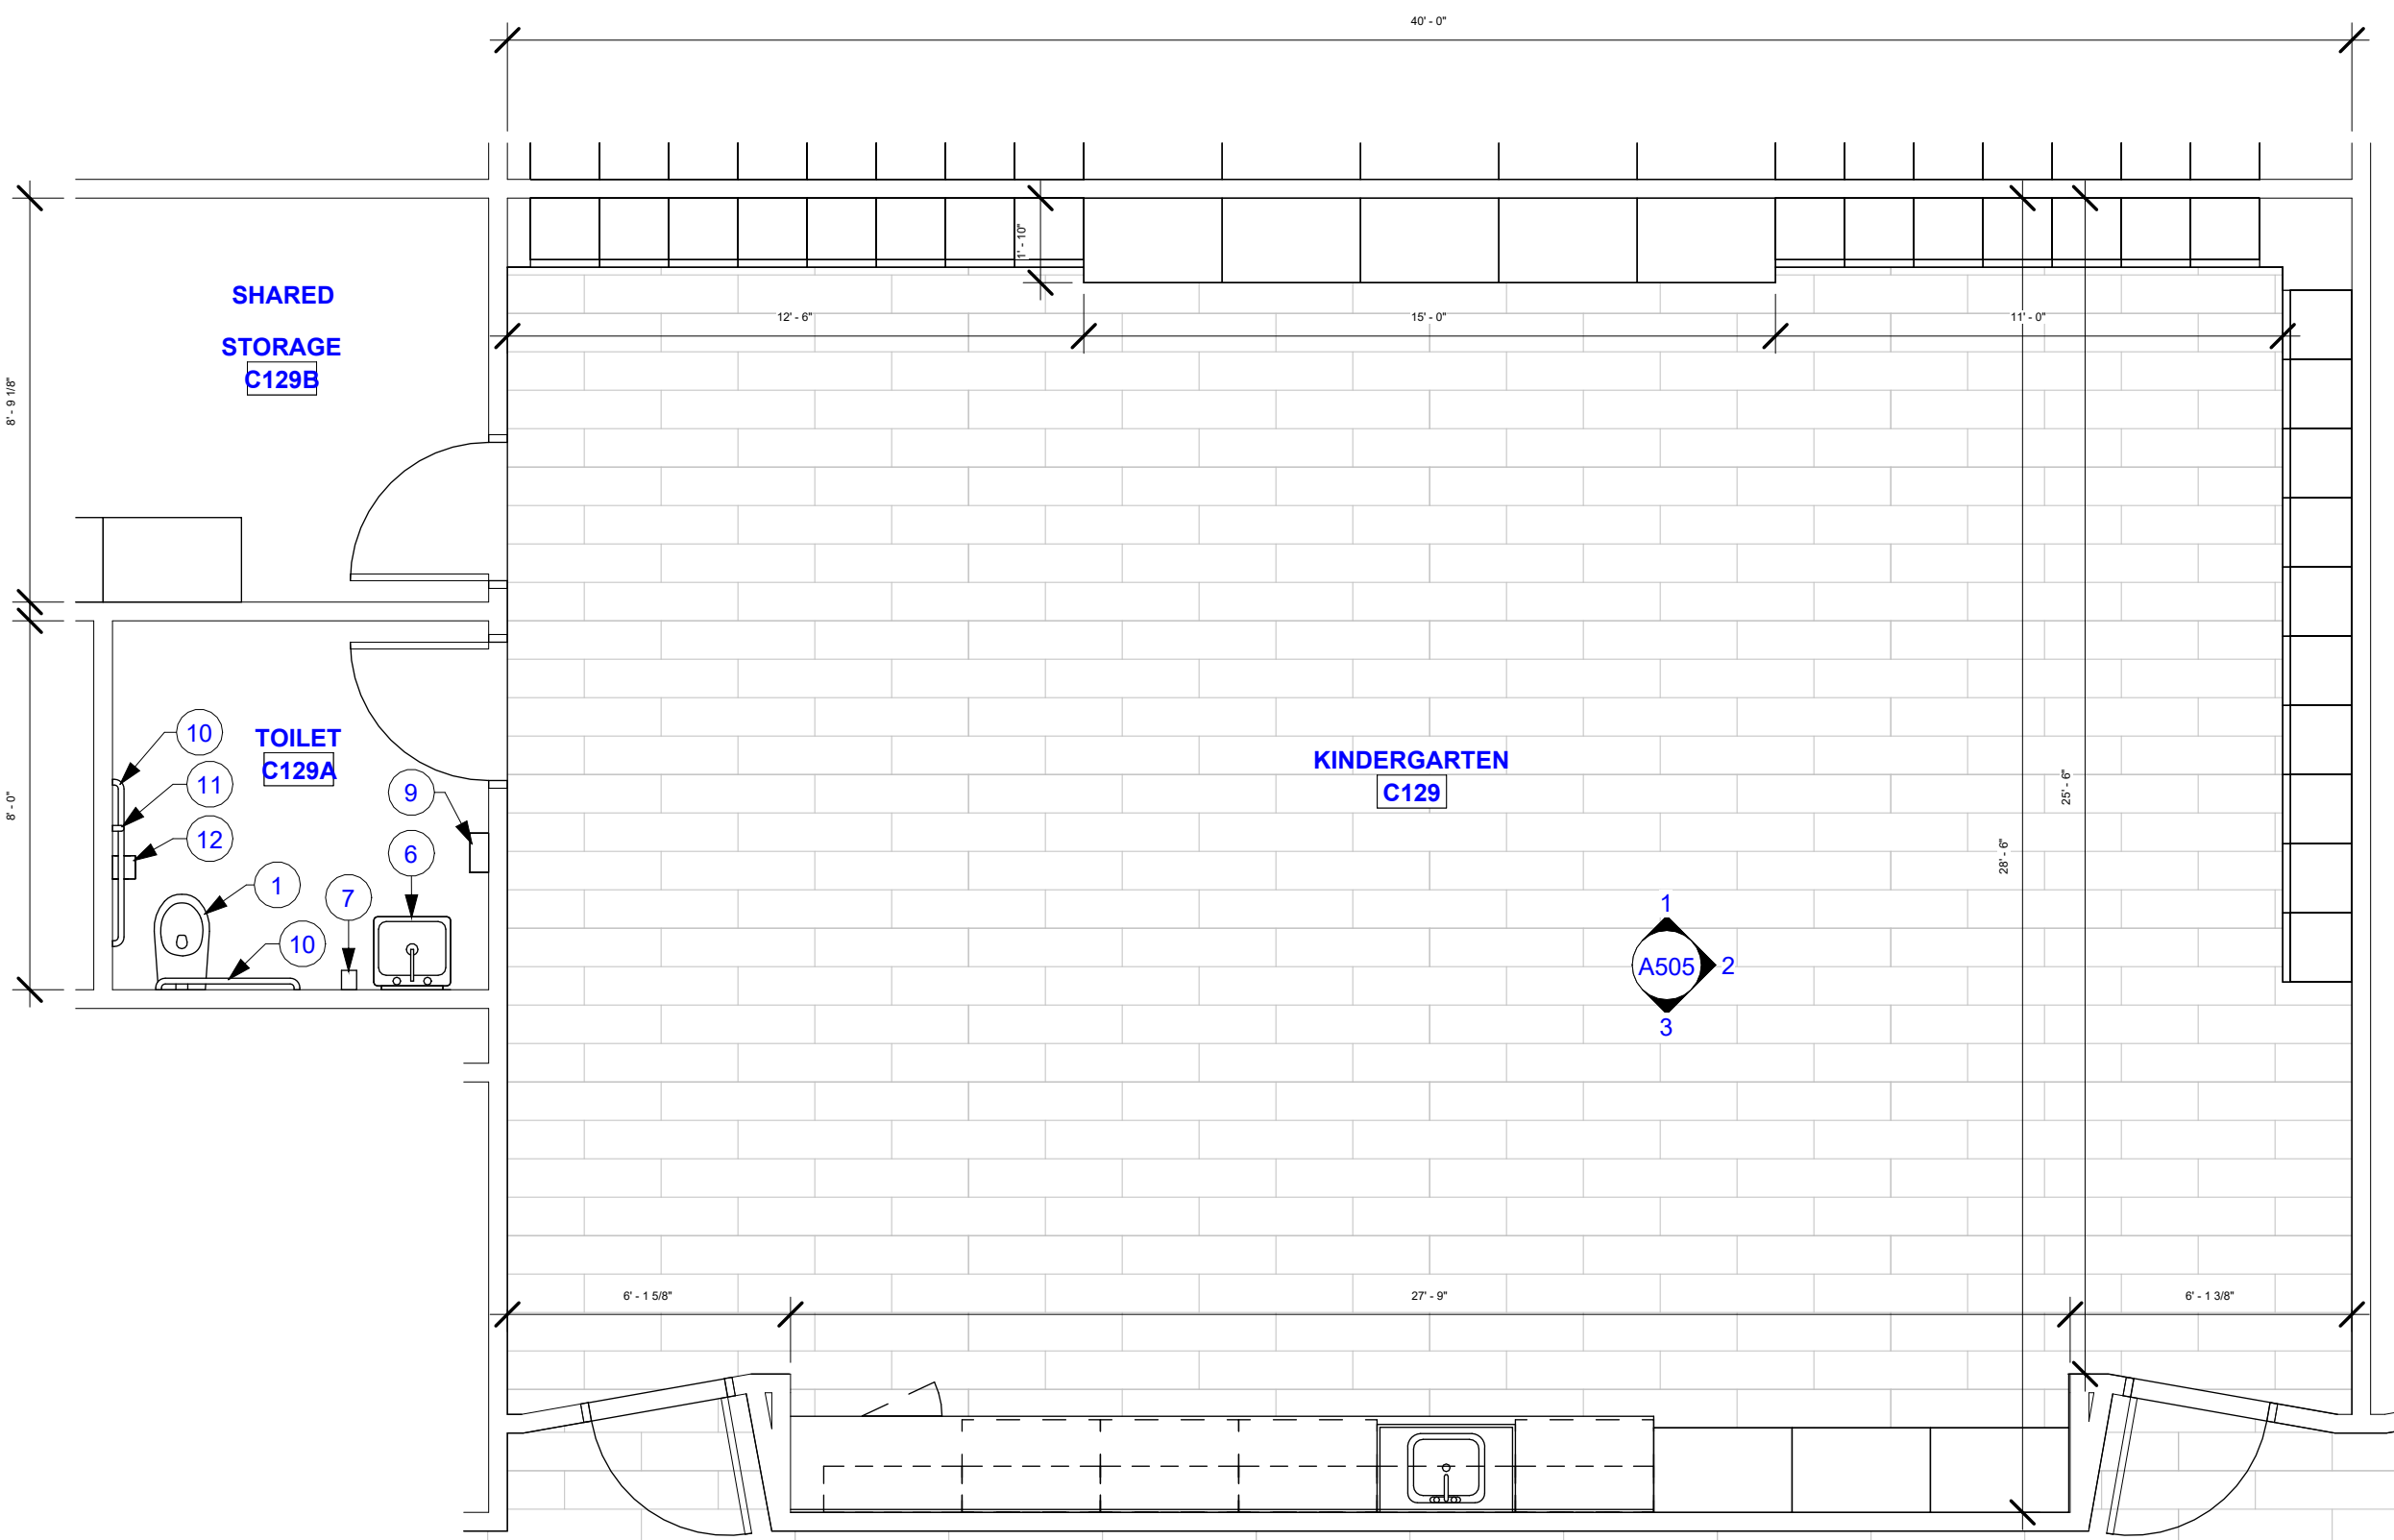

1 ENLARGED PLAN - KINDERGARTEN
A504 / 1/4" = 1'-0"



#	Date	ADDENDUM NO. 1	Description
1	MAY 17, 2024		

UNIT A

UNIT B

UNIT C

UNIT D

UNIT E

PROJECT NORTH

VPS ARCHITECTURE
528 Main Street - Suite 400 Evansville, Indiana 47708
905 North Capitol Avenue - Suite 100 Indianapolis, Indiana 46204
PH: (317) 353-3281 www.VPSARCH.com

STRUCTURAL: ENGINEERS:

Project Name:
RENOVATIONS TO RUSHVILLE ELEMENTARY SCHOOL

Drawing Title:
CLASSROOM ENLARGED PLAN & DETAILS


Client Project No: VPS Project No: 2023021.00 Project Issue Date: 04/17/24 Drawing No: A504

INTERIOR ELEVATION NOTES	
#	KEYNOTE INFORMATION
1	FINISHED BASE. REFER TO FINISH PLAN
2	25" DEEP (UNO) PLASTIC LAMINATE (UNO) COUNTERTOP WITH SIDE AND BACK SPLASH, AS INDICATED
3	25" DEEP (UNO) SOLID SURFACE (UNO) COUNTERTOP WITH SIDE AND BACK SPLASH, AS INDICATED
4	24" DEEP (UNO) BASE CABINET, COUNFIGURE DOOR(S), DRAWER(S), AND SHELVES(S) AS INDICATED
5	14" DEEP (UNO) WALL CABINET, COUNFIGURE DOOR(S), SHELVES(S) AND LIGHT SKIRT(S) AS INDICATED
6	ACCESSIBLE (BARRIER FREE) SINK SKIRT ASSEMBLY
7	FINISHED END PANEL
8	COUNTER SUPPORT BRACKET
9	GYPSUM BULKHEAD CONSTRUCTION, REFER TO REFLECTIVE CEILING PLAN
10	PROVIDE LOCKS WHERE SHOWN
11	2" HIGH LIGHT SKIRT TO BE FLUSH WITH CABINET FACE AND RETIEN TO WALL AT ALL OPEN CABINET ENDS. REFRENCING TO ELECTRICAL DRAWINGS FOR LIGHT FIXTURE LOCATIONS
12	FILE DRAWER (UNLESS NOTED OTHERWISE)
13	22" DEEP (UNO) TALL CABINET, COUNFIGURE DOOR(S), DRAWER(S), AND SHELVES(S) AS INDICATED
14	18" DEEP OPEN CUBBY, COUNFIGURE SHELVES(S) AS INDICATED


INDICATES CASEWORK STORAGE UNITS WHICH SHALL RECEIVE WHITE MAGNETIC MARKERBOARD SURFACE ON FULL FACE OF DOORS IN LIEU OF PLASTIC LAMINATE. PROVIDE MAGNETIC CATCHES AT THESE DOORS IN LIEU OF DOOR PULLS.

TYPICAL INTERIOR ELEVATION


* NOTES ARE TYPICAL UNLESS NOTES OTHERWISE

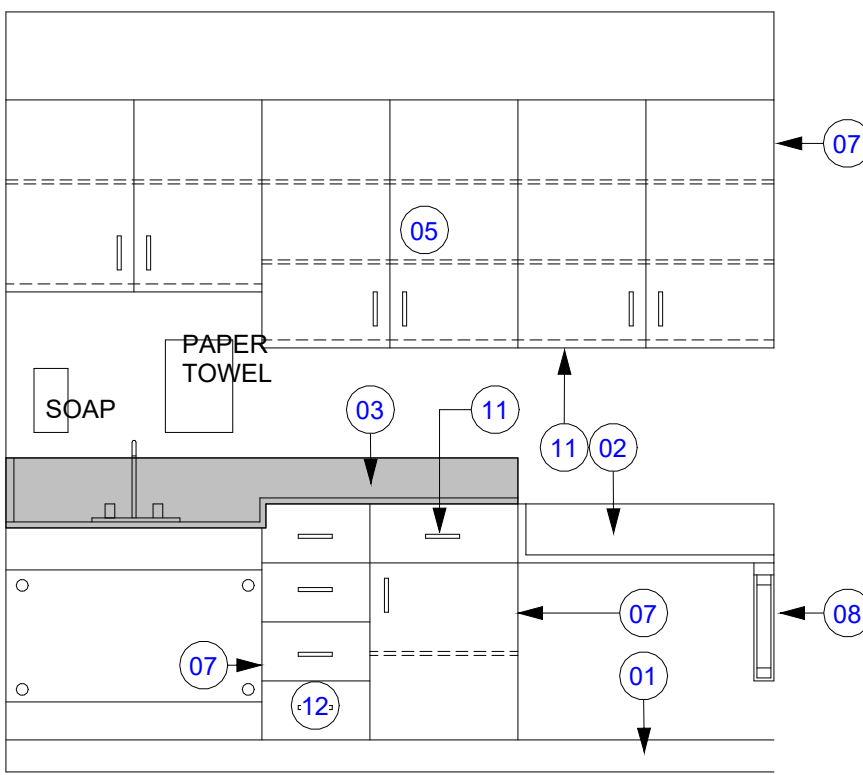


* LEGEND INDICATES GRAPHIC REPRESENTATION CASEWORK ELEMENTS, NOT A TYPICAL LAYOUT
* ALL NOTES ARE TYPICAL UNLESS OTHERWISE NOTED AND EVERY INSTANCE MAY NOT BE NOTED ON INTERIOR ELEVATIONS

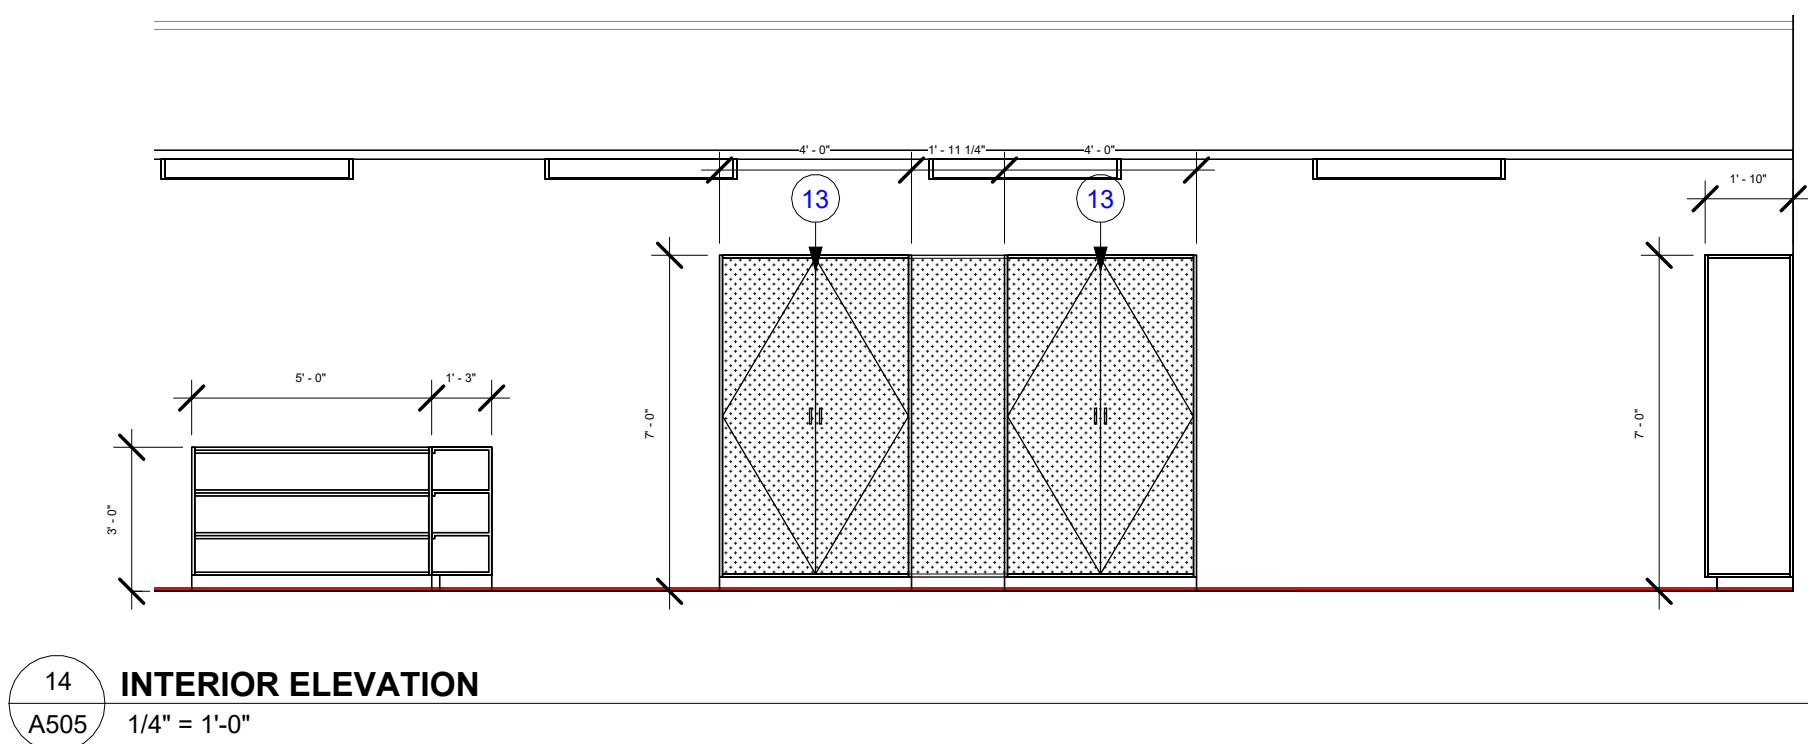


14 INTERIOR ELEVATION
A505 1/4" = 1'-0"

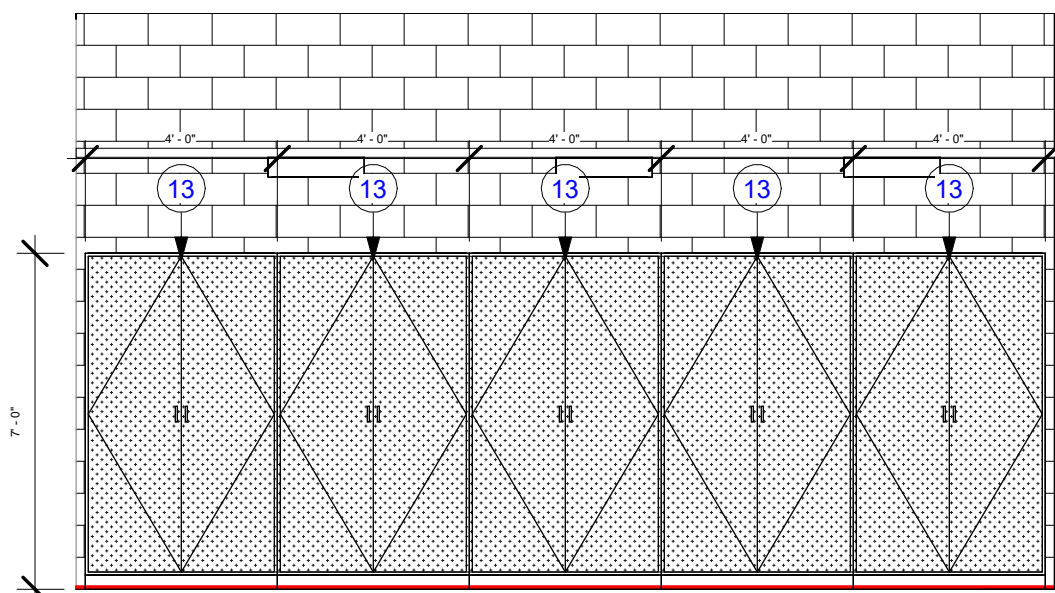


13 INTERIOR ELEVATION
A505 1/4" = 1'-0"

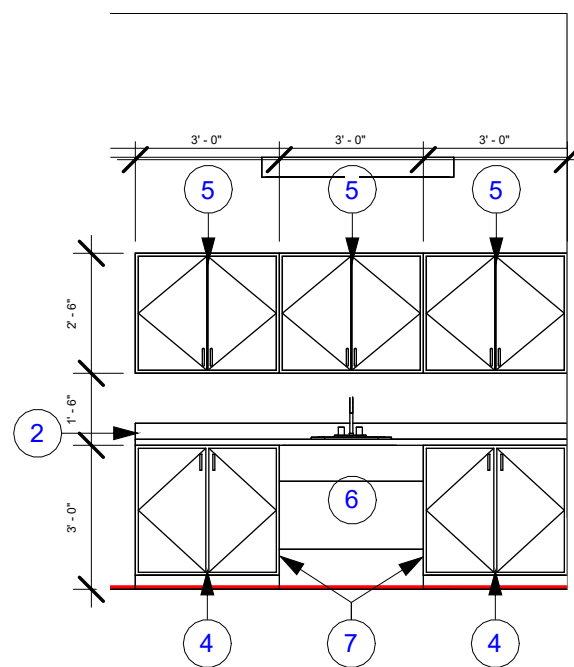


12 INTERIOR ELEVATION
A505 1/4" = 1'-0"

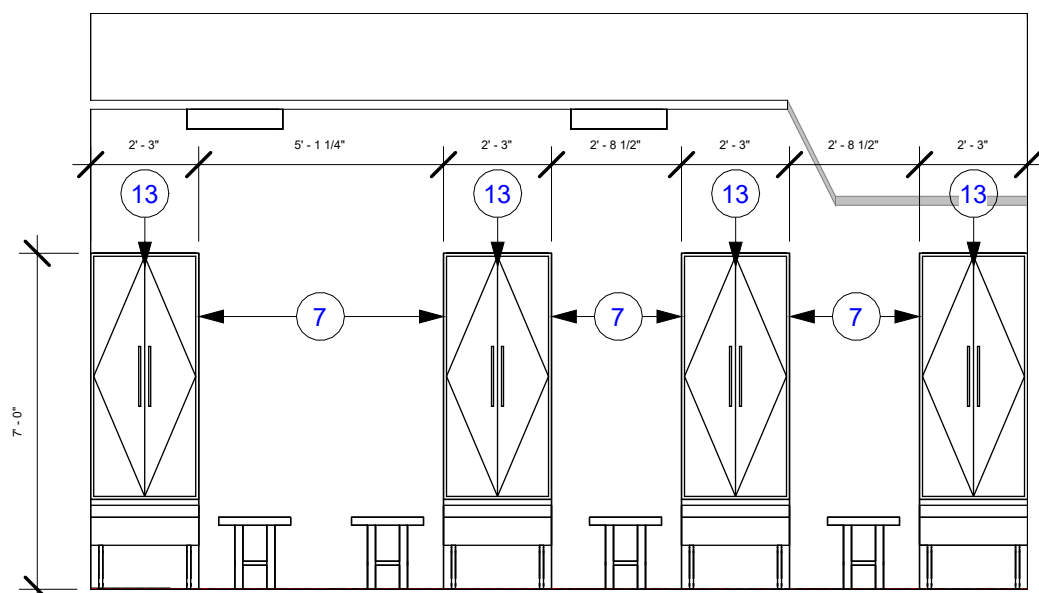


11 INTERIOR ELEVATION
A505 1/4" = 1'-0"

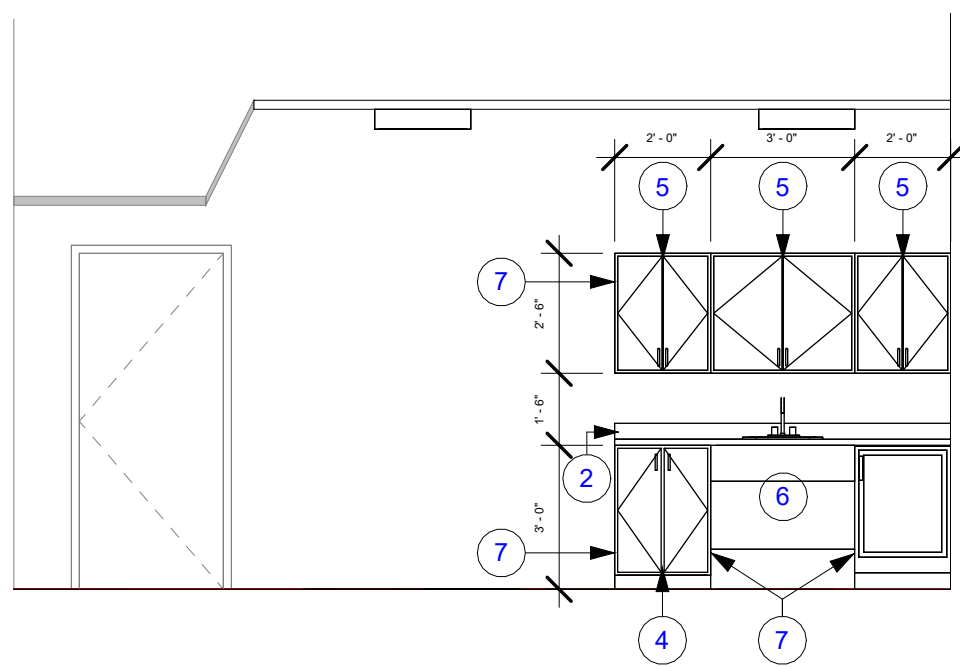


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A505 1/4" = 1'-0"

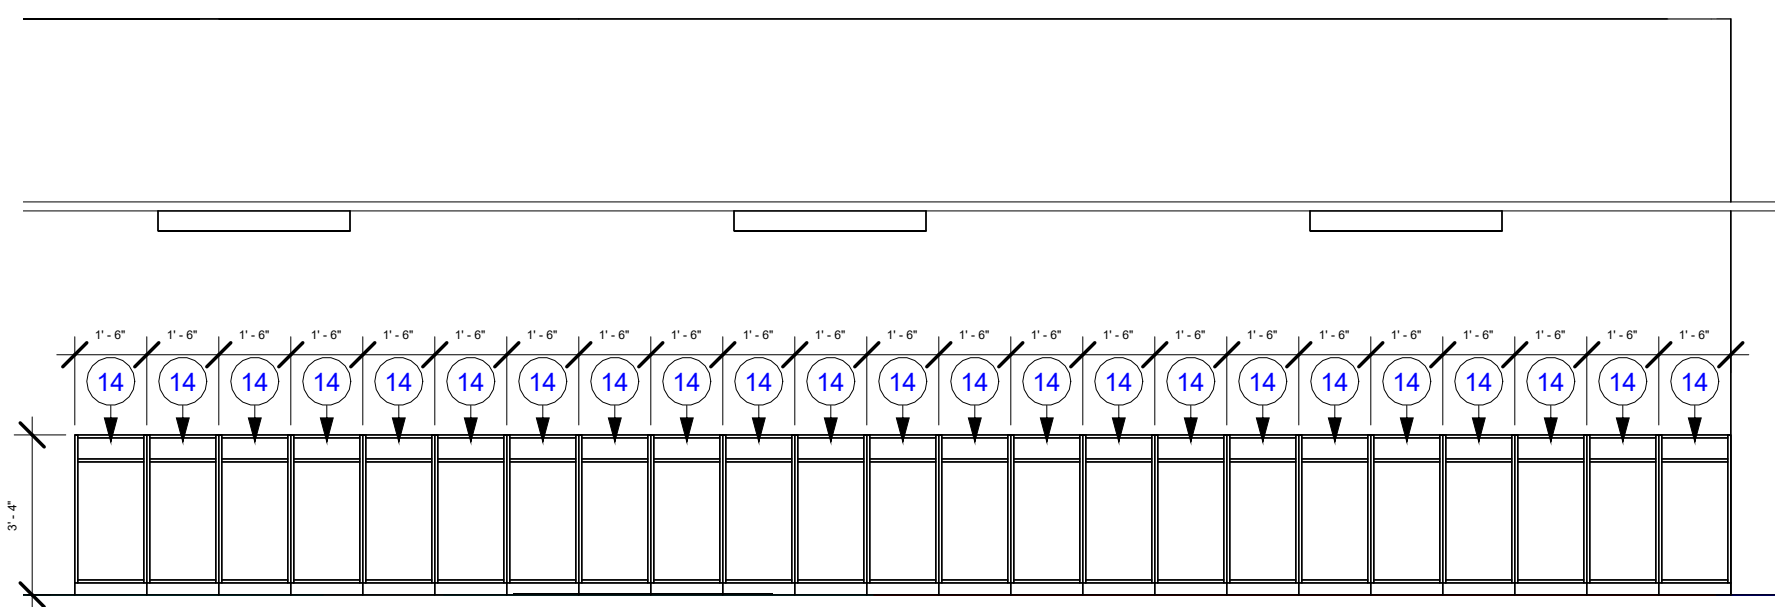


9 INTERIOR ELEVATION
A505 1/4" = 1'-0"

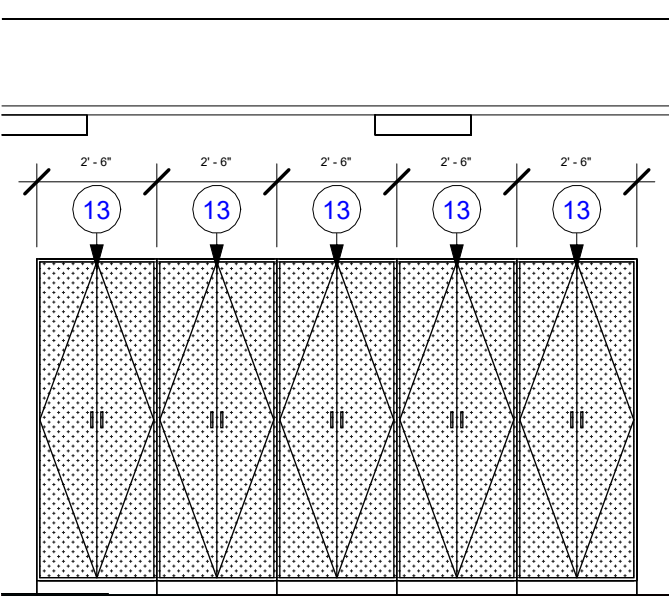


6 INTERIOR ELEVATION
A505 1/4" = 1'-0"

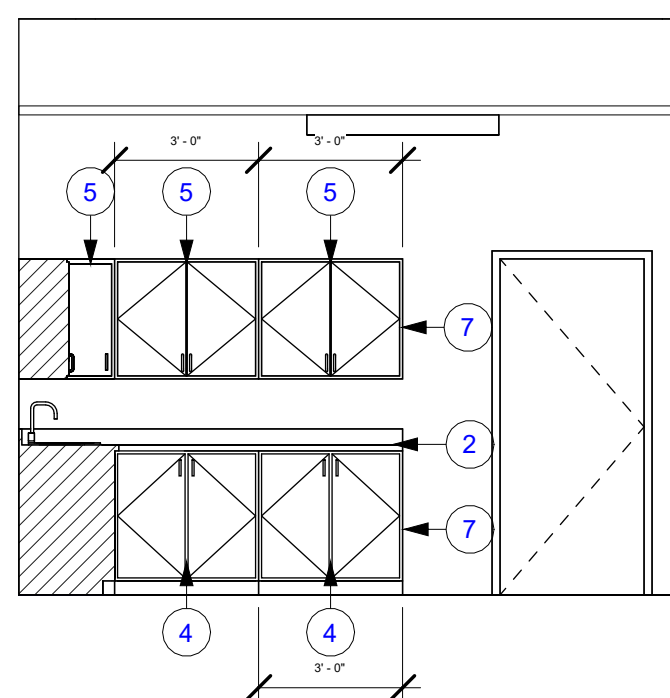


5 INTERIOR ELEVATION
A505 1/4" = 1'-0"

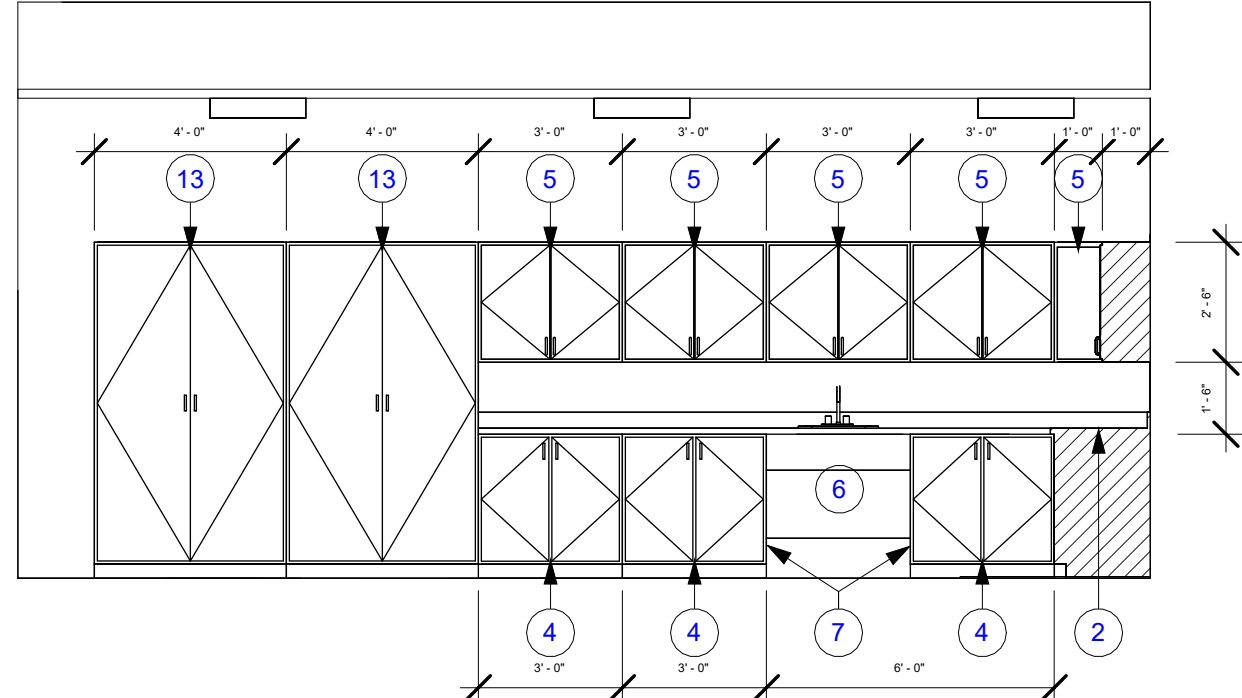


4 INTERIOR ELEVATION
A505 1/4" = 1'-0"

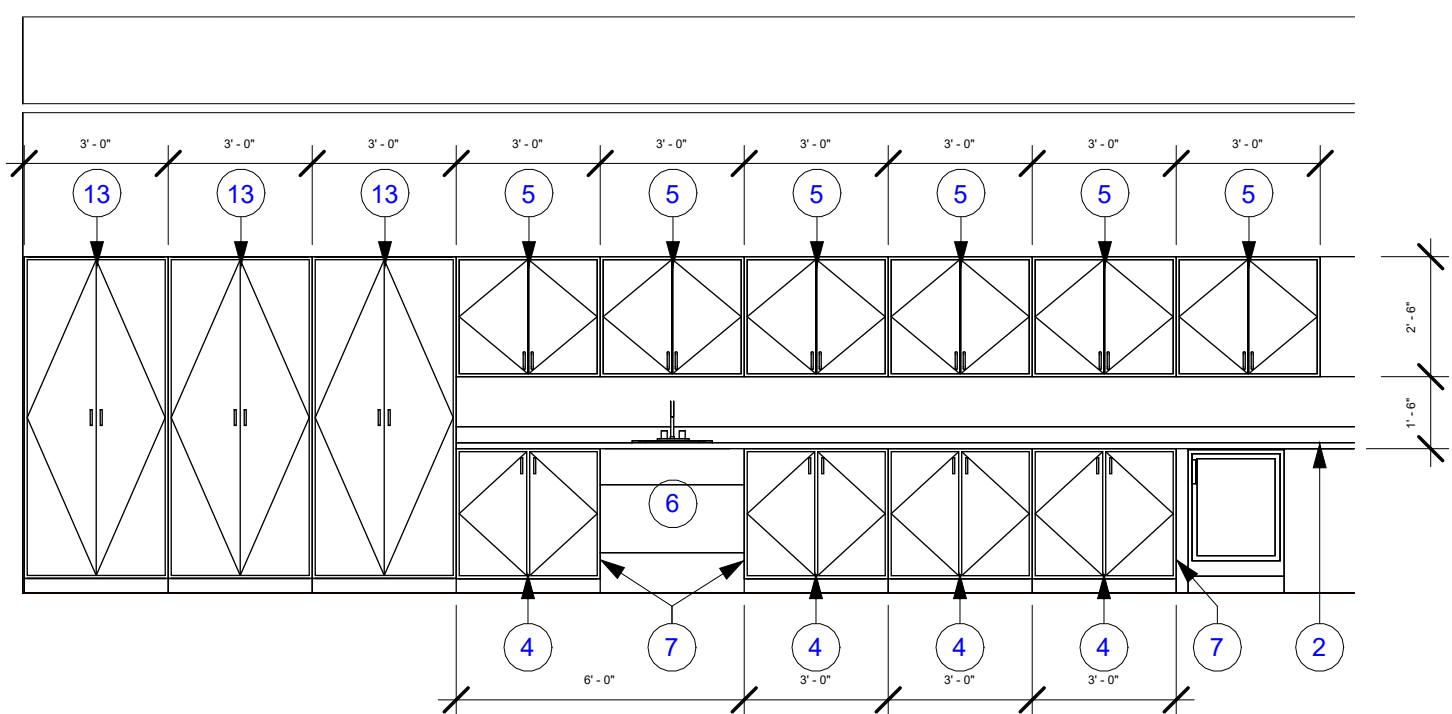

3 INTERIOR ELEVATION
A505 1/4" = 1'-0"

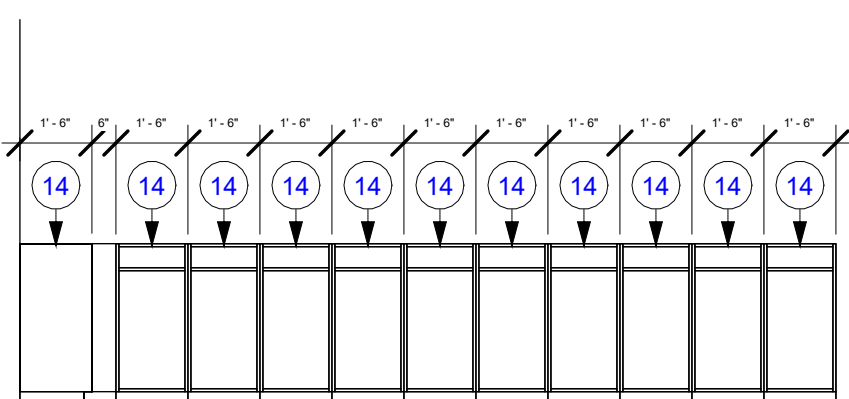

2 INTERIOR ELEVATION
A505 1/4" = 1'-0"

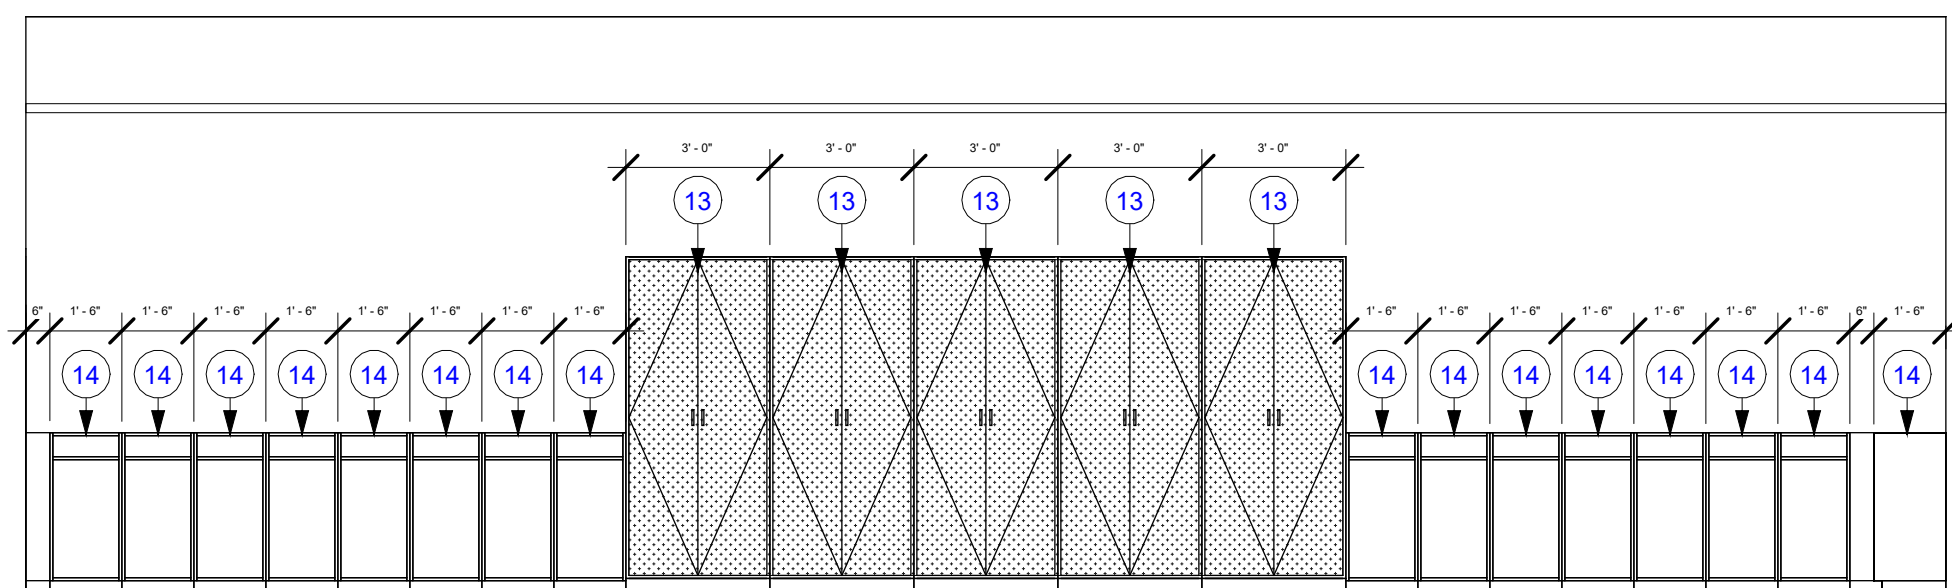

1 INTERIOR ELEVATION
A505 1/4" = 1'-0"



1	MAY 17, 2024	ADDENDUM NO. 1
#	Date	Description


VPS ARCHITECTURE
528 Main Street - Suite 400 Evansville, Indiana 47708
905 North Capitol Avenue - Suite 100 Indianapolis, Indiana 46204
PH: (317) 353-3281 www.VPSARCH.com

STRUCTURAL: ENGINEERS:


Project Name: RENOVATIONS TO RUSHVILLE ELEMENTARY SCHOOL	
Drawing Title: INTERIOR ELEVATIONS	
	Client Project No: VPS Project No: 2023021.00 Project Issue Date: 04/17/24 Drawing No: A505

DOOR & HARDWARE SCHEDULE


DOOR INFORMATION					DOOR PANEL INFORMATION		DOOR FRAME INFORMATION		FRAME DETAIL		REMARKS	DOOR NUMBER
DOOR NUMBER	ROOM NAME	WIDTH	HEIGHT	# OF LEAFS	RATING	ELEVATION ON	DOOR PANEL MATERIAL	ELEVATION ON	DOOR FRAME MATERIAL	HARDWARE SET		
A106	TOILET	3'-0"	7'-0"	1		F	WD	F1	HM	04	5/A701	A106
A107	WORKROOM	3'-0"	7'-0"	1		N	WD	F1	HM	02	5/A701	A107
A113A	WORKROOM	3'-0"	7'-0"	1		N	WD	F1	HM	03	5/A701	A113A
A113B	WORKROOM	3'-0"	7'-0"	1		N	WD	F1	HM	03	5/A701	A113B
C100C	VESTIBULE	6'-0"	7'-10"	2		FG	AL	F3	AL	18	8/A701	C100C
C100D	VESTIBULE	6'-0"	7'-10"	2		FG	AL	F3	AL	18	8/A701	C100D
C101	RECEPTION	3'-0"	7'-0"	1		FG	AL	F4	AL	14	8/A701	C101
C101A	RECEPTION	6'-0"	7'-0"	2		FG	AL	F2	AL	15	8/A701	C101A
C101B	RECEPTION	6'-0"	7'-0"	2		FG	AL	F2	AL	11	8/A701	C101B
C102	OFFICE	3'-0"	7'-0"	1		N	WD	F1	HM	06	5/A701	C102
C103A	CONFERENCE	3'-0"	7'-0"	1		N	WD	F1	HM	06	5/A701	C103A
C103B	CONFERENCE	3'-0"	7'-0"	1		N	WD	F1	HM	06	5/A701	C103B
C104	OFFICE	3'-0"	7'-0"	1		N	WD	F1	HM	06	5/A701	C104
C105	NURSE	3'-0"	7'-0"	1		N	WD	F1	HM	06	5/A701	C105
C105A	CLO	3'-0"	7'-0"	1		F	WD	F1	HM	05	5/A701	C105A
C105B	TOILET	3'-0"	7'-0"	1		F	WD	F1	HM	23	5/A701	C105B
C106	PR	3'-0"	7'-0"	1		F	WD	F1	HM	04	5/A701	C106
C107	PR	3'-0"	7'-0"	1		F	WD	F1	HM	04	5/A701	C107
C108	OFFICE	3'-0"	7'-0"	1		N	WD	F1	HM	06	5/A701	C108
C109	I.S.S.	3'-0"	7'-0"	1		N	WD	F1	HM	06	5/A701	C109
C110	STORAGE	3'-0"	7'-0"	1		F	WD	F1	HM	05	5/A701	C110
C111	WORKROOM	3'-0"	7'-0"	1		N	WD	F1	HM	22	5/A701	C111
C111A	WORKROOM	6'-0"	7'-0"	2		N	WD	F2	HM	09	5/A701	C111A
C112	OFFICE	3'-0"	7'-0"	1		N	WD	F1	HM	06	5/A701	C112
C113	OFFICE	3'-0"	7'-0"	1		N	WD	F1	HM	06	5/A701	C113
C114A	STORAGE	3'-0"	7'-0"	1		F	WD	F1	HM	01	5/A701	C114A
C115	RESTROOM	3'-0"	7'-0"	1		F	WD	F1	HM	24	5/A701	C115
C116	RESTROOM	3'-0"	7'-0"	1		F	WD	F1	HM	24	5/A701	C116
C117	CALMING ROOM	3'-0"	7'-0"	1		N	WD	F1	HM	01	5/A701	C117
C118	CALMING ROOM	3'-0"	7'-0"	1		N	WD	F1	AL	5/A701	C118	
C119	TITLE	3'-0"	7'-0"	1		N	WD	F1	HM	01	5/A701	C119
C120	MEDIA CENTER	6'-0"	6'-10"	2		FG	AL	F2	AL	07	5/A701	C120
C120A	OFFICE	3'-0"	7'-0"	1		N	WD	F1	HM	06	5/A701	C120A
C120B	STORAGE	3'-0"	7'-0"	1		F	WD	F1	HM	05	5/A701	C120B
C121	LIT COACH	3'-0"	7'-0"	1		N	WD	F1	HM	01	5/A701	C121
C122	ESL	3'-0"	7'-0"	1		N	WD	F1	HM	5/A701	C122	
C123	EARLY CHILDHOOD	3'-0"	7'-0"	1		N	WD	F1	HM	5/A701	C123	
C123A	SPEECH	3'-0"	7'-0"	1		N	WD	F1	HM	21	5/A701	C123A
C123B	KINDERGARTEN	3'-0"	7'-0"	1		N	WD	F1	HM	01	5/A701	C123B
C128B	KINDERGARTEN	3'-0"	7'-0"	1		N	WD	F1	HM	01	5/A701	C128B
C129C	TOILET	3'-0"	7'-0"	1		F	WD	F1	HM	20	5/A701	C129C
C129D	STORAGE	3'-0"	7'-0"	1		F	WD	F1	HM	21	5/A701	C129D
C130	SMALL GROUP	3'-0"	7'-0"	1		N	WD	F1	HM	21	5/A701	C130
C131A	KINDERGARTEN	3'-0"	7'-0"	1		N	WD	F1	HM	01	5/A701	C131A
C131B	KINDERGARTEN	3'-0"	7'-0"	1		N	WD	F1	HM	01	5/A701	C131B
C131C	TOILET	3'-0"	7'-0"	1		F	WD	F1	HM	20	5/A701	C131C
C131D	STORAGE	3'-0"	7'-0"	1		F	WD	F1	HM	21	5/A701	C131D
C132	PRE-K	3'-0"	7'-0"	1		N	WD	F1	HM	01	5/A701	C132
C132A	TOILET	3'-0"	7'-0"	1		F	WD	F1	HM	20	5/A701	C132A
C134A	BOYS	3'-0"	7'-0"	1		F	WD	F1	HM	01	5/A701	C134A
C135A	KINDERGARTEN	3'-0"	7'-0"	1		N	WD	F1	HM	01	5/A701	C135A
C135B	KINDERGARTEN	3'-0"	7'-0"	1		N	WD	F1	HM	01	5/A701	C135B
C135C	TOILET	3'-0"	7'-0"	1		F	WD	F1	HM	20	5/A701	C135C
C135D	STORAGE	3'-0"	7'-0"	1		F	WD	F1	HM	21	5/A701	C135D
C136	OFFICE	3'-0"	7'-0"	1		N	WD	F1	HM	21	5/A701	C136
C136A	CORRIDOR	6'-0"	7'-0"	2		N	WD	F2	HM	10	5/A701	C136A
C137A	KINDERGARTEN	3'-0"	7'-0"	1		N	WD	F1	HM	01	5/A701	C137A
C137B	KINDERGARTEN	3'-0"	7'-0"	1		N	WD	F1	HM	01	5/A701	C137B
C137C	TOILET	3'-0"	7'-0"	1		F	WD	F1	HM	20	5/A701	C137C
C137D	STORAGE	3'-0"	7'-0"	1		F	WD	F1	HM	21	5/A701	C137D
C138	CORRIDOR	3'-0"	7'-0"	1		N	WD	F1	HM	21	5/A701	C138
D106	TOILET	3'-0"	7'-0"	1		F	WD	F1	HM	04	5/A701	D106
D107	WORKROOM	3'-0"	7'-0"	1		N	WD	F1	HM	02	5/A701	D107
D113A	WORKROOM	3'-0"	7'-0"	1		N	WD	F1	HM	03	5/A701	D113A
D113B	WORKROOM	3'-0"	7'-0"	1		N	WD	F1	HM	03	5/A701	D113B
E100	VESTIBULE	6'-0"	7'-0"	2		FG	AL	F2	AL	12	8/A701	E100
E100A	VESTIBULE	6'-0"	7'-0"	2		FG	AL	F2	AL	16	8/A701	E100A
E102	LIFE SKILLS	3'-0"	7'-0"	1		N	WD	F1	HM	01	5/A701	E102
E102A	STORAGE	3'-0"	7'-0"	1		F	WD	F1	HM	21	5/A701	E102A
E102B	LIFE SKILLS	3'-0"	7'-0"	1		N	WD	F1	HM	08	5/A701	E102B
E102C	TOILET	3'-0"	7'-0"	1		F	WD	F1	HM	20	5/A701	E102C
E103	LIFE SKILLS	3'-0"	7'-0"	1		N	WD	F1	HM	01	5/A701	E103
E103A	STORAGE	3'-0"	7'-0"	1		F	WD	F1	HM	21	5/A701	E103A
E103B	TOILET	3'-0"	7'-0"	1		F	WD	F1	HM	08	5/A701	E103B
E104	PRE	3'-0"	7'-0"	1		N	WD	F1	HM	01	5/A701	E104
E104A	STORAGE	3'-0"	7'-0"	1		F	WD	F1	HM	21	5/A701	E104A
E104B	TOILET	3'-0"	7'-0"	1		F	WD	F1	HM	20	5/A701	E104B
E105	PRE	3'-0"	7'-0"	1		N	WD	F1	HM	01	5/A701	E105
E105A	STORAGE	3'-0"	7'-0"	1		F	WD	F1	HM	21	5/A701	E105A
E105B	PRE	3'-0"	7'-0"	1		N	WD	F1	HM	08	5/A701	E105B
E105C	TOILET	3'-0"	7'-0"	1		F	WD	F1	HM	20	5/A701	E105C

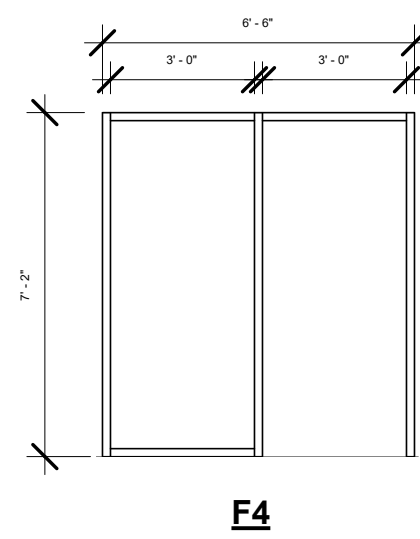


F4

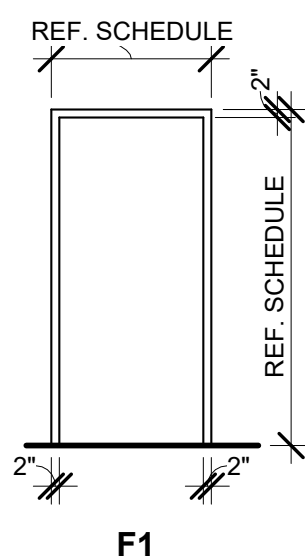

F1

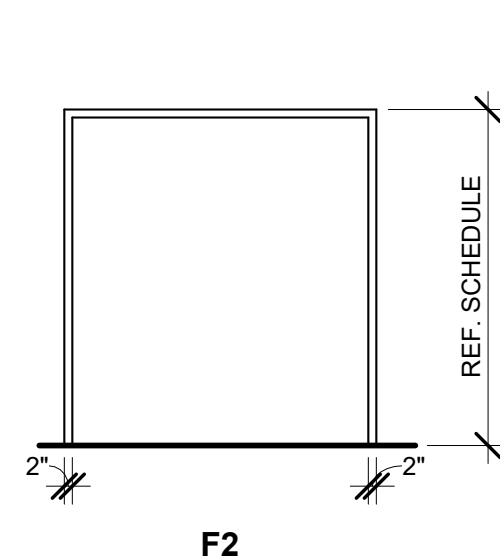


F2

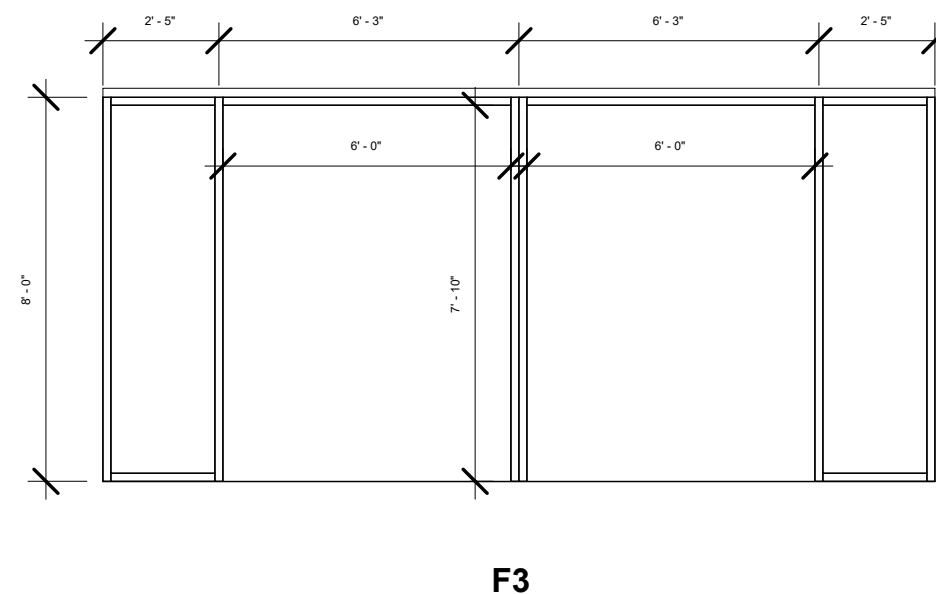

F3


TYPICAL DOOR FRAME ELEVATION

1/4" = 1'-0"

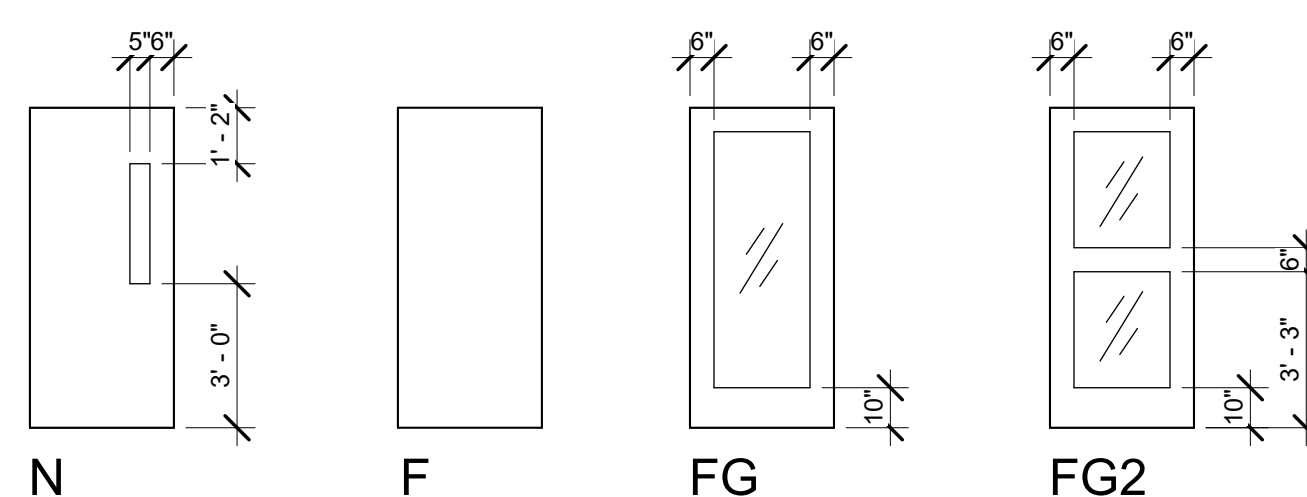


TYPICAL DOOR PANEL ELEVATION

1/4" = 1'-0"

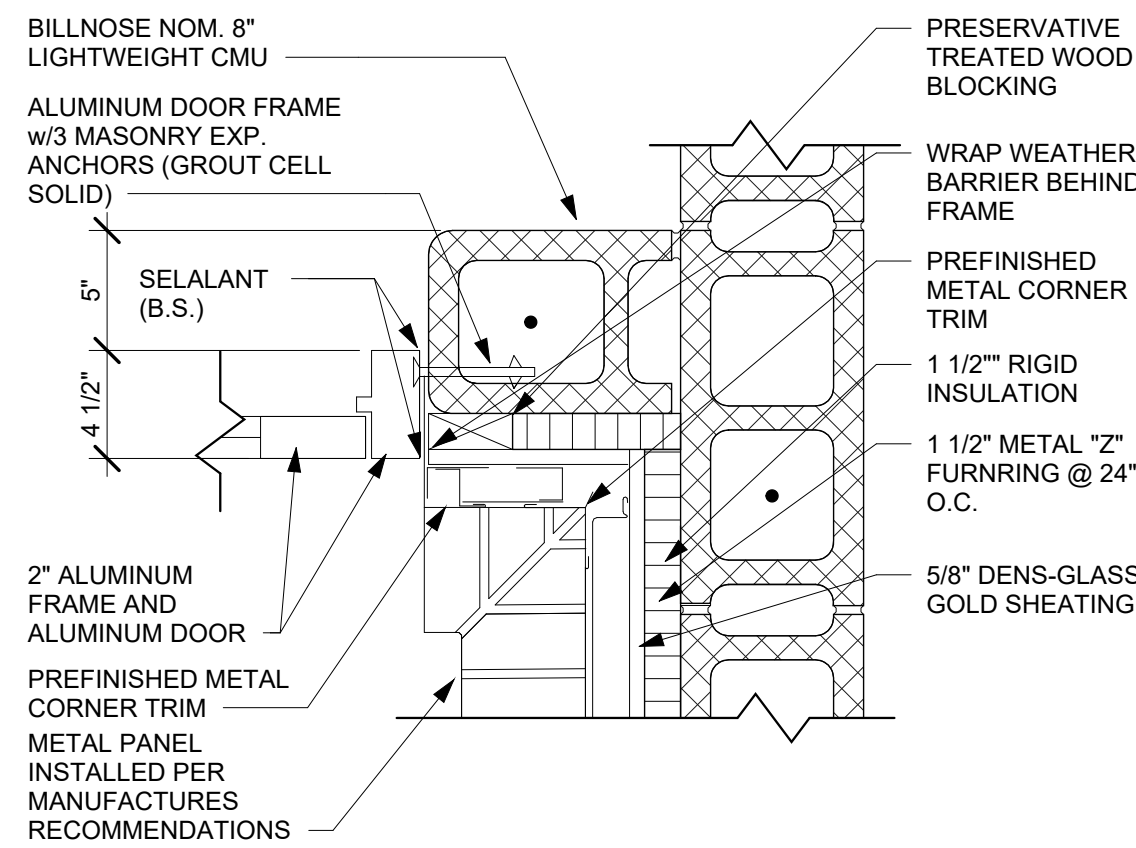


JAMB DETAIL - J4

1 1/2" = 1'-0"

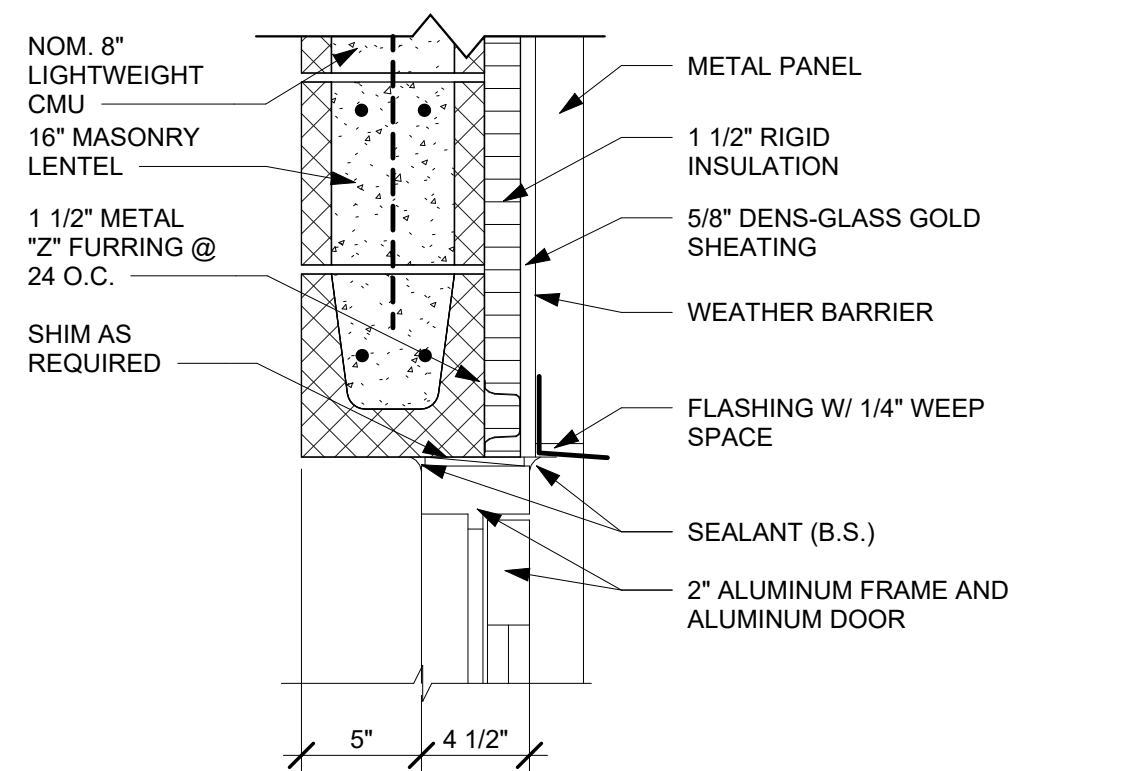


EXTERIOR WALL HEAD DETAIL - H5

1 1/2" = 1'-0"

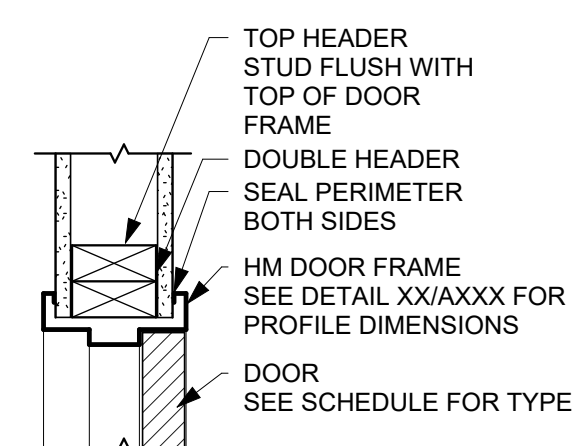


HEAD DETAIL - H4

1 1/2" = 1'-0"

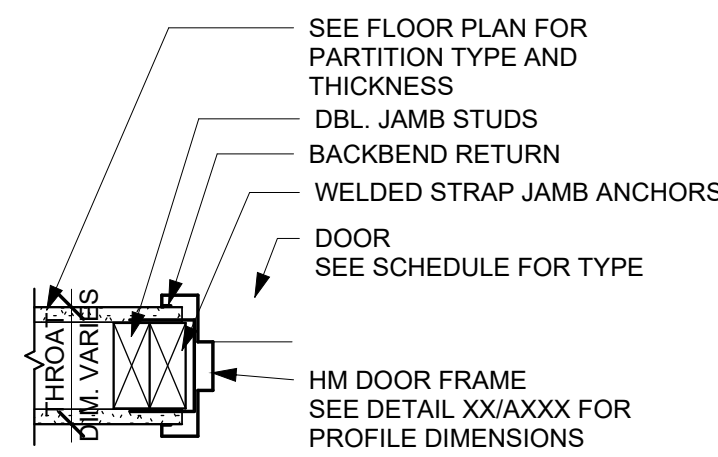


JAMB DETAIL - J3

1 1/2" = 1'-0"

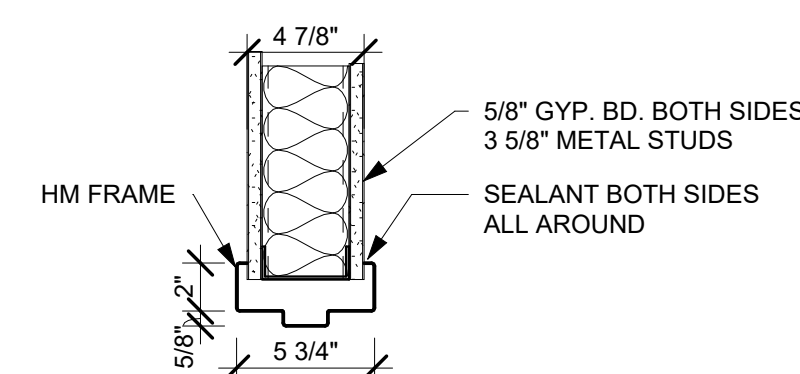


HEAD DETAIL - H3

1 1/2" = 1'-0"

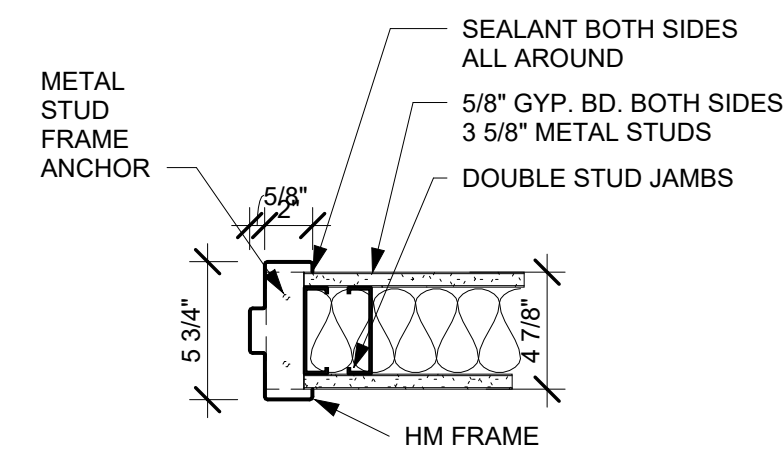


JAMB DETAIL - J2

1 1/2" = 1'-0"

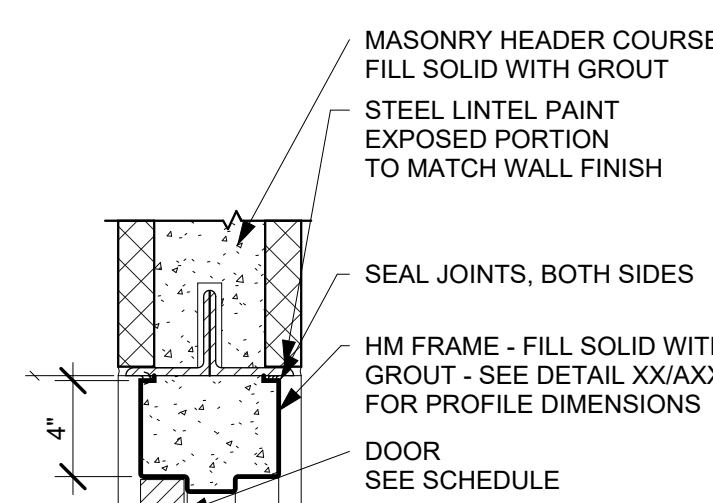


HEAD DETAIL - H2

1 1/2" = 1'-0"

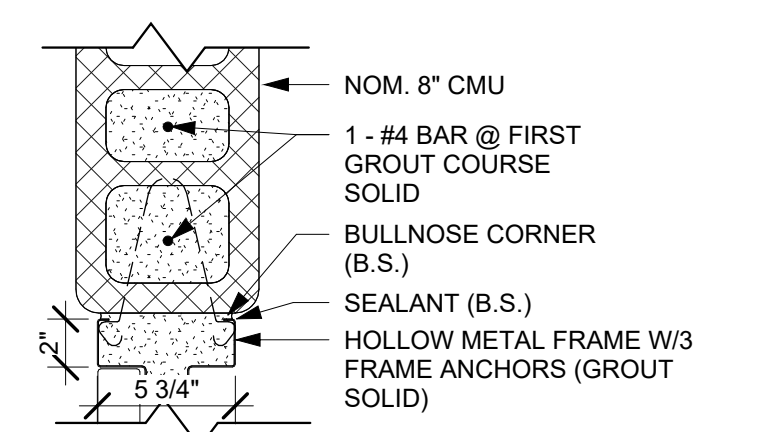


JAMB DETAIL - J1

1 1/2" = 1'-0"

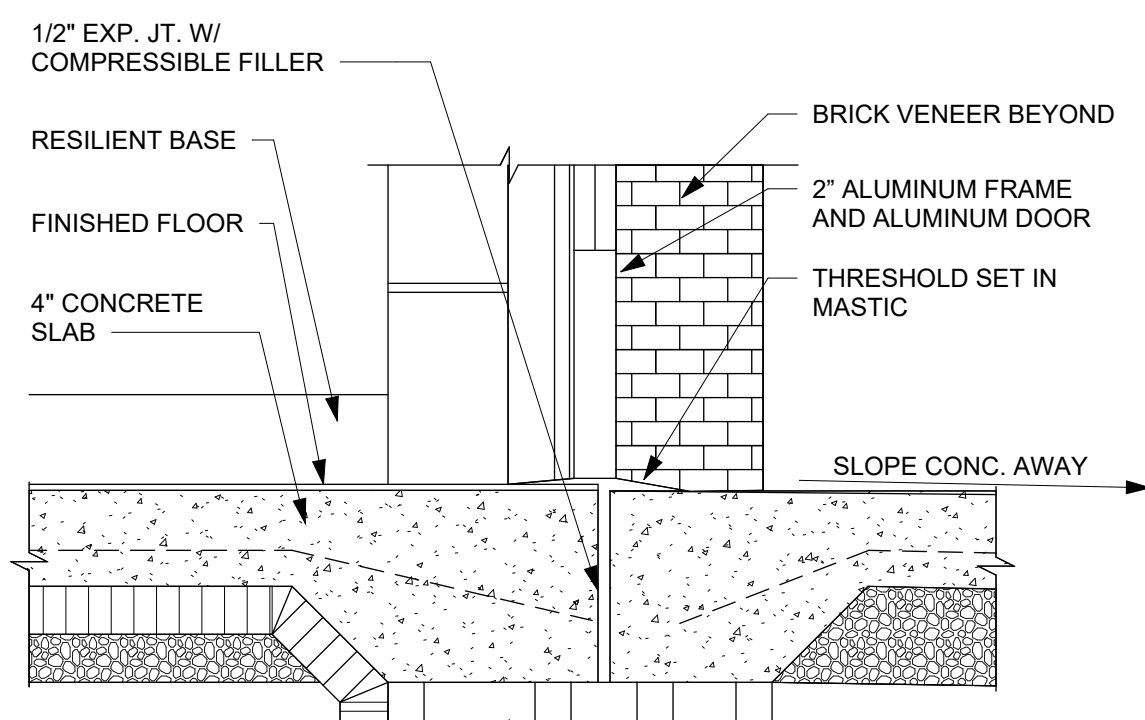

TYPICAL THRESHOLD DETAIL

1 1/2" = 1'-0"

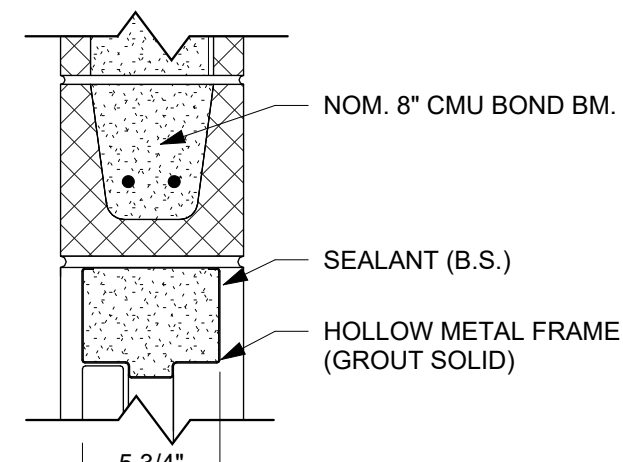


HEAD DETAIL - H1

1 1/2" = 1'-0"



1 MAY 17, 2024 ADDENDUM NO. 1

Date Description

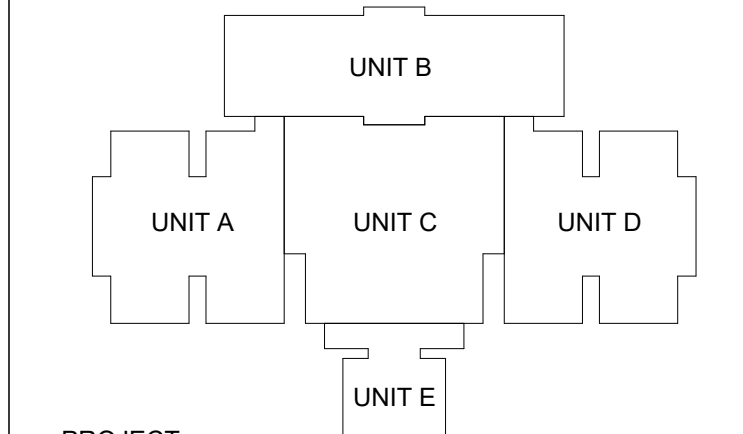

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STRUCTURAL: ENGINEERS:

Project Name:

RENOVATIONS TO
RUSHVILLE ELEMENTARY
SCHOOLDrawing Title:
DOOR SCHEDULES AND DETAILSClient Project No:
VPS Project No: 2023021.00
Project Issue Date: 04/17/24
Drawing No:


A701

ROOM FINISH SCHEDULE

ROOM INFORMATION		FLOOR FINISHES					BASE FINISH		WALLS		WALL FINISHES		CEILING FINISHES		ROOM NUMBER	COMMENTS		
ROOM NUMBER	ROOM NAME	EXISTING TO REMAIN (ETR)	CARPET TILE (CPT#)	LUXURY VINYL TILE (LVT#)	PORCELAIN TILE (TF)	WALK OFF CARPET TILE (WOCP TF)	EXISTING TO REMAIN (ETR)	PORCELAIN TILE (TF#)	RESILIENT (RH)	EXISTING TO REMAIN (ETR)	ALUMINUM FRAME (AL#)	GYPSUM WALLBOARD (GYP BD#)	PAINT (PT#)	PORCELAIN TILE (TF#)			EXISTING TO REMAIN (ETR)	ACOUSTICAL CEILING PANEL SYSTEM (ACP#)
B101A	CLASSROOM		CPT01	LVT01				R01	ETR			GYP BD	PT01			ACP01	B101A	
B101B	CLASSROOM		CPT01	LVT01				R01	ETR			GYP BD	PT01			ACP01	B101B	
B102A	CLASSROOM		CPT01	LVT01				R01	ETR			GYP BD	PT01			ACP01	B102A	
B102B	CLASSROOM		CPT01	LVT01				R01	ETR			GYP BD	PT01			ACP01	B102B	
C138A	JANITOR			LVT01				R01				GYP BD	PT01			ACP01	C138A	
A106	TOILET				PFT01			PFT01				GYP BD		PWT		ACP01	A106	
A107	WORKROOM		CPT01					R01	ETR			GYP BD	PT01			ACP01	A107	
A113	WORKROOM		CPT01					R01				GYP BD	PT01			ACP01	A113	
B101	CAFETERIA	ETR					ETR			ETR					ETR		B101	
B102	GYM	ETR					ETR			ETR					ETR		B102	
C100	VESTIBULE					WOCP T01		R01	ETR		AL01						GYP	C100
C101	RECEPTION		CPT01					R01	ETR			GYP BD	PT01			ACP01	C101	
C102	OFFICE		CPT01					R01	ETR			GYP BD	PT01			ACP01	C102	
C103	CONFERENCE		CPT01					R01	ETR			GYP BD	PT01			ACP01	C103	
C104	OFFICE		CPT01					R01				GYP BD	PT01			ACP01	C104	
C105	NURSE			LVT01				R01	ETR			GYP BD	PT01			ACP01	C105	
C105A	CLO.			LVT01				R01				GYP BD	PT01			ACP01	C105A	
C105B	TOILET				PFT01			PFT01				GYP BD		PWT		ACP01	C105B	
C106	PR				PFT01			PFT01				GYP BD		PWT		ACP01	C106	
C107	PR				PFT01			PFT01				GYP BD		PWT		ACP01	C107	
C108	OFFICE		CPT01					R01	ETR			GYP BD	PT01			ACP01	C108	
C109	I.S.S.		CPT01					R01	ETR			GYP BD	PT01			ACP01	C109	
C110	STORAGE		CPT01					R01	ETR			GYP BD	PT01			ACP01	C110	
C111	WORKROOM		CPT01					R01	ETR			GYP BD	PT01			ACP01	C111	
C112	OFFICE		CPT01					R01	ETR			GYP BD	PT01			ACP01	C112	
C113	OFFICE		CPT01					R01				GYP BD	PT01			ACP01	C113	
C114A	STORAGE		CPT01					R01	ETR			GYP BD	PT01			ACP01	C114A	
C115	RESTROOM	ETR			PFT01			PFT01		ETR		GYP BD		PWT	ETR		C115	
C116	RESTROOM	ETR			PFT01			PFT01		ETR		GYP BD		PWT	ETR		C116	
C117	CALMING ROOM		CPT01					R01	ETR			GYP BD	PT01			ACP01	C117	
C118	CALMING ROOM		CPT01					R01	ETR			GYP BD	PT01			ACP01	C118	
C119	TITLE		CPT01					R01	ETR			GYP BD	PT01			ACP01	C119	
C120	MEDIA CENTER		CPT01					R01	ETR		AL01	GYP BD	PT01			ACP01	C120	
C120A	OFFICE		CPT01					R01				GYP BD	PT01			ACP01	C120A	
C120B	STORAGE		CPT01					R01	ETR			GYP BD	PT01			ACP01	C120B	
C121	LIT COACH		CPT01					R01	ETR			GYP BD	PT01			ACP01	C121	
C122	ESL		CPT01					R01				GYP BD	PT01			ACP01	C122	
C123	EARLY CHILDHOOD		CPT01					R01	ETR			GYP BD	PT01			ACP01	C123	
C128	SPEECH		CPT01					R01				GYP BD	PT01			ACP01	C128	
C129	KINDERGARTEN			LVT01				R01				GYP BD	PT01			ACP01	C129	
C129A	TOILET				PFT01			PFT01				GYP BD		PWT		ACP01	C129A	
C129B	STORAGE		CPT01					R01				GYP BD	PT01			ACP01	C129B	
C130	SMALL GROUP		CPT01					R01				GYP BD	PT01			ACP01	C130	
C131	KINDERGARTEN			LVT01				R01				GYP BD	PT01			ACP01	C131	
C131A	TOILET				PFT01			PFT01				GYP BD		PWT		ACP01	C131A	
C132	PRE-K			LVT01				R01				GYP BD	PT01			ACP01	C132	
C132A	TOILET				PFT01			PFT01				GYP BD		PWT		ACP01	C132A	
C133	GIRLS				PFT01			PFT01				GYP BD		PWT		ACP01	C133	
C134	BOYS				PFT01			PFT01				GYP BD		PWT		ACP01	C134	
C135	KINDERGARTEN			LVT01				R01				GYP BD	PT01			ACP01	C135	
C135A	TOILET				PFT01			PFT01				GYP BD		PWT		ACP01	C135A	
C135B	STORAGE		CPT01					R01				GYP BD	PT01			ACP01	C135B	
C136	OFFICE		CPT01					R01				GYP BD	PT01			ACP01	C136	
C137	KINDERGARTEN			LVT01				R01				GYP BD	PT01			ACP01	C137	
C137A	TOILET				PFT01			PFT01				GYP BD		PWT		ACP01	C137A	
C138	SMALL GROUP		CPT01					R01				GYP BD	PT01			ACP01	C138	
D106	TOILET				PFT01			PFT01				GYP BD		PWT		ACP01	D106	
D107	WORKROOM		CPT01					R01	ETR			GYP BD	PT01			ACP01	D107	
D113	WORKROOM		CPT01					R01				GYP BD	PT01			ACP01	D113	
E100	CORRIDOR	ETR		LVT01			ETR	R01	ETR			GYP BD	PT01		ETR	ACP01	E100	
E100A	VESTIBULE					WOCP T01		R01	ETR		AL01	GYP BD	PT01				GYP	E100A
E102	LIFE SKILLS		CPT01	LVT01				R01	ETR			GYP BD	PT01			ACP01	E102	
E102A	STORAGE			LVT01				R01				GYP BD	PT01			ACP01	E102A	
E103	LIFE SKILLS		CPT01	LVT01				R01	ETR			GYP BD	PT01			ACP01	E103	
E103A	STORAGE			LVT01				R01				GYP BD	PT01			ACP01	E103A	
E103B	TOILET				PFT01			PFT01				GYP BD		PWT		ACP01	E103B	
E104	PRE		CPT01	LVT01				R01	ETR			GYP BD	PT01			ACP01	E104	
E104A	STORAGE			LVT01				R01				GYP BD	PT01			ACP01	E104A	
E104B	TOILET				PFT01			PFT01				GYP BD		PWT		ACP01	E104B	
E105	PRE		CPT01	LVT01				R01	ETR			GYP BD	PT01			ACP01	E105	
E105A	STORAGE			LVT01				R01				GYP BD	PT01			ACP01	E105A	



1	MAY 17, 2024	ADDENDUM NO. 1
#	Date	Description

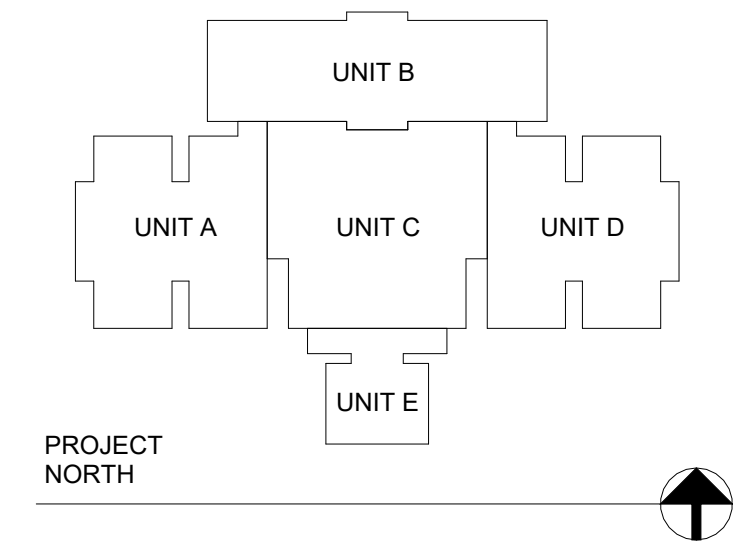


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Project Name:
**RENOVATIONS TO
RUSHVILLE ELEMENTARY
SCHOOL**

Drawing Title:
ROOM FINISH SCHEDULE



Client Project No:
2023021.00
Project Issue Date:
04/17/24
Drawing No:
A703

VAV BOX WITH HOT WATER REHEAT SCHEDULE - 23 36 00																	
IDENTITY DATA				AIRFLOW DATA				NOISE DATA		REHEAT COIL DATA							
MARK	MANUFACTURER	MODEL	INLET DIAMETER	COOLING MAX (CFM)	HEATING MAX (CFM)	OCC. MIN. (CFM)	SPI (IN-WG)	MAX DISCH.	MAX RAD.	CAPACITY (MBH)	EAT/LAT (°F)	APD (IN-WG)	FLOW (GPM)	EWL/LWT (°F)	WPD (FT-WG)	ROWS	NOTES
VAV-C101	PRICE	SDV	8	660	330	198	1.0	22	-	14	55/95	0.4	1.5	140/120	0.5	2	1,2,3,4
VAV-C102	PRICE	SDV	6	320	160	96	1.0	22	-	7	55/95	0.2	0.5	140/113	0.1	2	1,2,3,4
VAV-C103	PRICE	SDV	8	870	435	261	1.0	-	-	19	55/95	0.6	3.7	140/129	2.6	2	1,2,3,4
VAV-C104	PRICE	SDV	8	870	435	261	1.0	-	-	19	55/95	0.6	3.7	140/129	2.6	2	1,2,3,4
VAV-C108	PRICE	SDV	8	660	330	198	1.0	22	-	14	55/95	0.4	1.5	140/120	0.5	2	1,2,3,4
VAV-C113	PRICE	SDV	6	530	265	159	1.0	22	24	12	55/95	0.4	1.5	140/124	0.4	2	1,2,3,4
VAV-C114	PRICE	SDV	6	470	235	141	1.0	28	23	10	55/95	0.3	1.1	140/120	0.2	2	1,2,3,4
VAV-C119	PRICE	SDV	8	600	300	180	1.0	22	-	13	55/95	0.3	1.2	140/118	0.4	2	1,2,3,4
VAV-C120	PRICE	SDV	14	2,085	1,043	626	1.0	-	-	45	55/95	0.5	4.5	140/119	2.5	2	1,2,3,4
VAV-C121	PRICE	SDV	8	720	360	216	1.0	20	-	16	55/95	0.5	1.9	140/123	0.8	2	1,2,3,4
VAV-C122	PRICE	SDV	8	590	295	177	1.0	21	-	13	55/95	0.3	1.2	140/118	0.4	2	1,2,3,4
VAV-C128	PRICE	SDV	8	630	315	189	1.0	22	-	14	55/95	0.4	1.4	140/119	0.5	2	1,2,3,4
VAV-C129	PRICE	SDV	10	1,130	565	339	1.0	-	-	22	55/95	0.5	1.7	140/114	0.9	2	1,2,3,4
VAV-C130	PRICE	SDV	8	860	430	258	1.0	-	-	19	55/95	0.6	3.5	140/129	2.3	2	1,2,3,4
VAV-C131	PRICE	SDV	10	1,160	580	348	1.0	-	-	22	55/95	0.6	1.8	140/115	0.4	2	1,2,3,4
VAV-C132	PRICE	SDV	10	865	433	260	1.0	-	-	19	55/95	0.6	3.6	140/129	2.4	2	1,2,3,4
VAV-C135	PRICE	SDV	10	1,130	565	339	1.0	-	-	22	55/95	0.5	1.7	140/114	0.9	2	1,2,3,4
VAV-C136	PRICE	SDV	6	380	190	114	1.0	25	20	8	55/95	0.2	0.7	140/115	0.1	2	1,2,3,4
VAV-C137	PRICE	SDV	10	1,160	580	348	1.0	-	-	22	55/95	0.6	1.8	140/115	0.4	2	1,2,3,4
VAV-C138	PRICE	SDV	6	530	265	159	1.0	29	24	12	55/95	0.4	1.5	140/124	0.4	2	1,2,3,4
VAV-4E-1	PRICE	SDV	8	600	300	180	1.0	22	-	13	55/95	0.3	1.2	140/118	0.4	2	1,2,3,4
VAV-4W-1	PRICE	SDV	10	920	460	276	1.0	-	-	20	55/95	0.4	1.9	140/119	1.0	2	1,2,3,4
VAV-4W-2	PRICE	SDV	8	680	340	204	1.0	22	-	15	55/95	0.4	1.6	140/121	0.6	2	1,2,3,4
VAV-E102	PRICE	SDV	12	1,280	640	384	1.0	-	-	28	55/95	0.4	2.7	140/118	2.2	2	1,2,3,4
VAV-E103	PRICE	SDV	10	1,170	585	351	1.0	-	-	25	55/95	0.6	3.7	140/125	3.2	2	1,2,3,4
VAV-E104	PRICE	SDV	10	1,170	585	351	1.0	-	-	25	55/95	0.6	3.7	140/125	3.2	2	1,2,3,4
VAV-E105	PRICE	SDV	10	1,110	555	333	1.0	-	-	24	55/95	0.5	3.1	140/124	2.4	2	1,2,3,4

VAV BOX WITH HOT WATER REHEAT SCHEDULE NOTES:

- COORDINATE LOCATION OF BOX ABOVE CEILING WITH LIGHT FIXTURES, FIRE PROTECTION, HEATING AND COOLING SYSTEM PIPING, PLUMBING SYSTEMS, AND WIRE TRAYS.
- SEE M-700 SERIES DRAWINGS FOR TEMPERATURE CONTROLS INFORMATION.
- INSULATED BOTTOM ACCESS DOOR UPSTREAM OF COIL WITH SNAP LATCH FASTENERS.
- MINIMUM 3/4" ELASTOMERIC LINER.

ROOFTOP AIR HANDLING UNIT SCHEDULE - 23 74 16.13																			
IDENTITY DATA					SUPPLY FAN							SUPPLY FAN SOUND POWER (OUTLET)							
MARK	MANUFACTURER	MODEL	LOCATION	SERVICE	WEIGHT (LBS)	AIRFLOW (CFM)	ESP/TSP (IN-WG)	RPM	QTY	HP EA.	BHP EA.	OCTAVE BAND							
												1	2	3	4	5	6	7	8
RTU-4E, 4W	TRANE	YCD360C4M	ROOF	UNIT C	4,990	9,500	1.5/2.6	750	1	10.0	7.2	87	84	81	82	76	73	69	64
RTU-5	TRANE	YSJ150B4S0H	ROOF	KITCHEN	1,535	5,000	1.0/1.6	1,685	1	4.6	3.2	85	91	82	74	70	68	68	67

ROOFTOP AIR HANDLING UNIT SCHEDULE NOTES:

- OVERLOAD PROTECTED DISCONNECT BY MANUFACTURER. SINGLE POINT POWER. HIGH-FAULT 65 KA SCCR.
- AMBIENT TEMPERATURES ARE SUMMER: 95F DB, 75 F WB AND WINTER: -10 F DB.
- PROVIDE BACNET INTERFACE CARD.
- BID ALTERNATE TO PROVIDE RTU-5.

ROOFTOP AIR HANDLING UNIT SCHEDULE (CONTINUED)																	
GAS HEATING DATA				DX COOLING DATA				FILTER				ELECTRICAL DATA					
MARK	MIN OUTSIDE AIR (CFM)	INPUT (MBH)	OUTPUT (MBH)	EAT/LAT (°F)	NOM. TONS	TOTAL (MBH)	SENSIBLE (MBH)	EAT (°F) DB/WB	LAT (°F) DB/WB	EER	REFRIG.	MERV	VOLT/PH/HZ	MCA (A)	MOCP (A)	NOTES	
RTU-4E, 4W	2,850	350	284	49/82	30	350	257	80/67	57/56	10.4	R-410A	8	460/3/60	86.0	100.0	1,2,3	
RTU-5	1,000	250	203	60/96	13	146	113	80/67	60/58	10.8	R-410A	8	460/3/60	31.0	40.0	1,2,3,4	

EXHAUST FAN SCHEDULE - 23 34 23															
IDENTITY DATA				WEIGHT (LBS)	FAN DATA					SOUND CRITERIA		UNIT CONTROL	ELECTRICAL DATA		
MARK	MANUFACTURER	MODEL	SERVICES		FAN TYPE	DRIVE TYPE	AIRFLOW (CFM)	ESP (IN-WG)	RPM	HP/BHP	SONES		DBA	VOLT/PH/HZ	NOTES
EF-E001	GREENHECK	G-099-A	UNIT C RESTROOMS	49	DOWNBLAST CENTIFUGAL	DIRECT	910	0.50	1725	0.25/0.25	12.5	63	BMS	115/1/60	1,2
EF-C002	GREENHECK	G-095-D	UNIT C RESTROOMS	31	DOWNBLAST CENTIFUGAL	DIRECT	280	0.50	1550	0.13/0.09	12.5	61	BMS	115/1/60	1,2
EF-E003	GREENHECK	G-099-A	UNIT C RESTROOMS	49	DOWNBLAST CENTIFUGAL	DIRECT	915	0.50	1725	0.24/0.25	12.5	63	BMS	115/1/60	1,2
EF-C004	GREENHECK	G-095-VG	UNIT C RESTROOMS	49	DOWNBLAST CENTIFUGAL	DIRECT	775	0.50	1711	0.16/0.15	10.4	60	BMS	115/1/60	1,2
EF-E001, E002	GREENHECK	SP-A70	UNIT E RESTROOMS	12	CEILING MOUNTED	DIRECT	70	0.10	850	0.01/0.01	-	23	ROOM SWITCH	115/1/60	1,2

EXHAUST FAN SCHEDULE NOTES:

- DISCONNECT BY MANUFACTURER.
- FAN SPEED CONTROLLER FOR BALANCING.


AIR COOLED SPLIT SYSTEM CONDENSING UNIT SCHEDULE - 23 81 26																	
IDENTITY DATA					COOLING DATA			ENERGY DATA			ELECTRICAL DATA						
MARK	MANUFACTURER	MODEL	SYSTEM SERVED	WEIGHT (LBS)	NOMINAL (BTUH)	AMB. (°F)	EER	SEER	COP	REF. TYPE	VOLT/PH/HZ	MCA (A)	MOCP (A)	NOTES			
CJ-1	DAIKIN	TRUYA0121KA70NA	FC-1	92	12,000	95	16.4	27.0	1.0	R-410A	208/1/60	11.0	28.0	1,2			

AIR COOLED SPLIT SYSTEM CONDENSING UNIT SCHEDULE NOTES:

- LOW AMBIENT COOLING
- WIRED TEMPERATURE CONTROL SENSOR


SPLIT SYSTEM FAN COIL UNIT SCHEDULE - 23 81 26																
IDENTITY DATA			WEIGHT (LBS)	DIMENSIONS			COOLING CAPACITY		AIRFLOW DATA			REF. TYPE	ELECTRICAL DATA			
MARK	MANUFACTURER	MODEL		L	W	H	TOTAL (BTUH)	SENSIBLE (BTUH)	MIN (CFM)	MAX (CFM)	DESIGN (CFM)		VOLT	FLA (A)	MCA (A)	NOTES
FC-1	MITSUBISHI	TPLA0A0121EA70A	46	37"	37"	10"	12,000	12,000	380	530	450	R-410A	24	0.26	1	1

233713 DIFFUSERS, REGISTERS, AND GRILLES									
IDENTITY DATA					NECK SIZE (IN)	MODULE SIZE		MATERIAL	NOTES
MARK	DESCRIPTION	MANUFACTURER	MODEL		Ø	W	L		
EC24/12	EGG GRATE FACE RETURN	PRICE	80		24"	12"			
EC24/24	EGG GRATE FACE RETURN	PRICE	80		24"	24"			
EG12/8	LOUVER FACE GRILLE EXHAUST	PRICE	530		8"	12"			
EG12/12	LOUVER FACE GRILLE EXHAUST	PRICE	530		12"	12"			
SD12-4	SQUARE CONE DIFFUSER	PRICE	ASDA	4"	12"	12"			
SD24-6	SQUARE CONE DIFFUSER	PRICE	ASDA	6"	24"	24"			
SD24-8	SQUARE CONE DIFFUSER	PRICE	ASDA	8"	24"	24"			
SD24-10	SQUARE CONE DIFFUSER	PRICE	ASDA	10"	24"	24"			

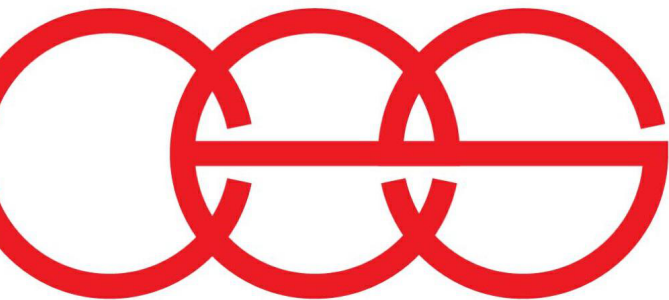

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1	05/17/24	ADDENDUM 1
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Project Name:

**RENOVATIONS TO
RUSHVILLE ELEMENTARY
SCHOOL**

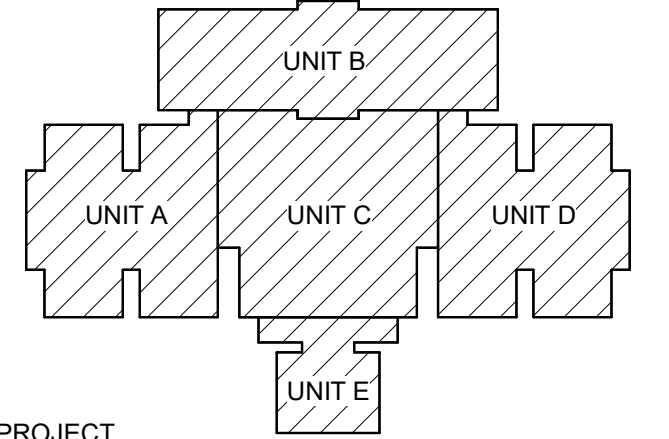Drawing Title:

MECHANICAL SCHEDULES



Client/Project No:

VPS Project No:

2023021.00

Project Issue Date:


05/03/24

Drawing No:

M-601



- 1 REMOVE EXISTING PIPE AND VALVES. PREPARE FOR RECONNECTION. SEE NEW WORK ON ASSOCIATED MP000 SHEETS.
- 2 REMOVE EXISTING DUCTWORK, COILS, AND CONTROLS WHERE INDICATED. PREPARE FOR RECONNECTION. SEE NEW WORK ON ASSOCIATED MH000 SHEETS.
- 3 REMOVE EXISTING DUCTWORK WHERE INDICATED.
- 4 REMOVE EXISTING ABANDONED CONTROL PANELS.
- 5 EXISTING TO REMAIN.
- 6 PROVIDE PRE-READINGS OF EXISTING AIRFLOWS AT SUPPLY AIR OUTLETS AND RETURN AIR INLETS FOR ASSOCIATED UNIT PRIOR TO WORK. SEE NEW WORK PLAN FOR APPLICATION OF CORRECTED AIR FLOW VALUES.
- 7 REMOVE EXISTING EXHAUST GRILLE AND PREPARE FOR INSTALLATION OF NEW GRILLE OF SAME DIMENSIONS.

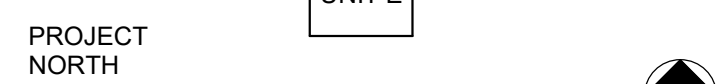


Project Name: _____

RENOVATIONS TO RUSHVILLE ELEMENTARY SCHOOL

Drawing Title:

**MECHANICAL DEMOLITION FIRST FLOOR
PLAN - UNIT C**

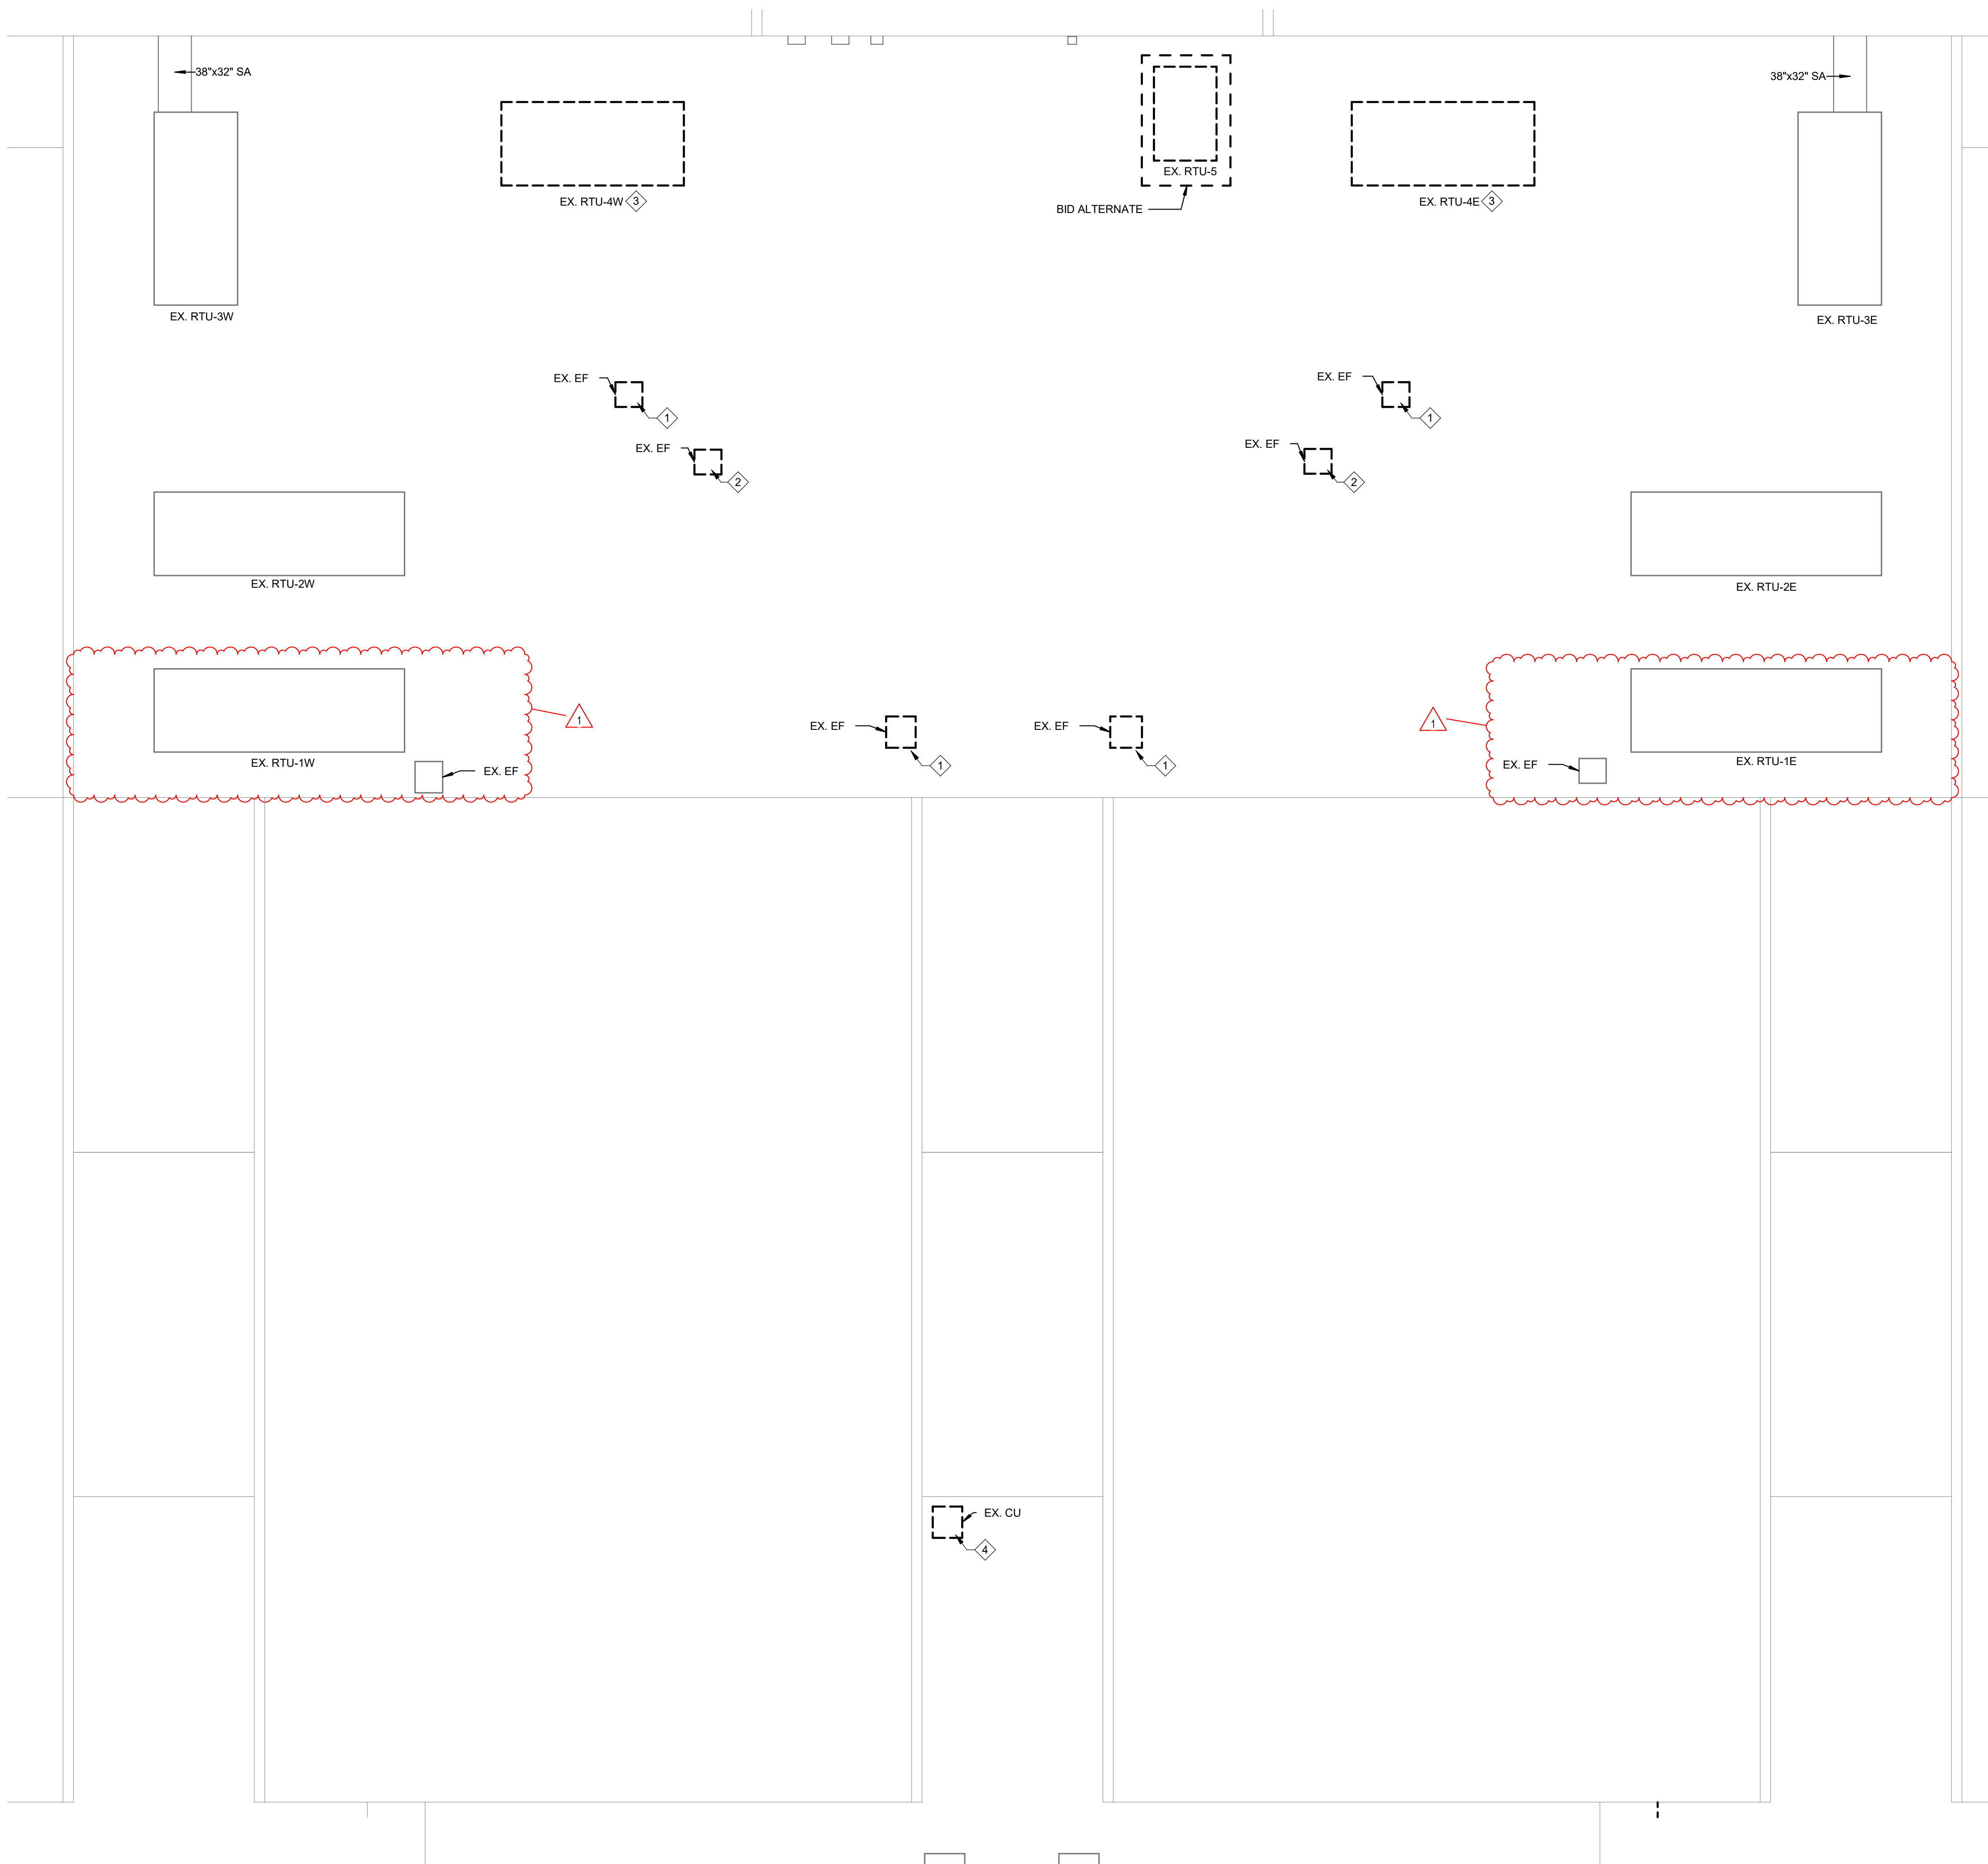


1 MECHANICAL DEMOLITION ROOF PLAN - UNIT C
1/8" = 1'-0"

GENERAL DEMOLITION NOTES


- A. DARK DASHED LINES INDICATE EXISTING EQUIPMENT AND SYSTEMS THAT SHALL BE REMOVED COMPLETELY AS PART OF DEMOLITION WORK.
- B. LIGHT SOLID LINES INDICATE EXISTING EQUIPMENT AND SYSTEMS THAT SHALL REMAIN. THE CONTRACTOR SHALL PROTECT ALL EXISTING EQUIPMENT AND SYSTEMS THAT SHALL REMAIN, DURING DEMOLITION PHASE.
- C. THE CONTRACTOR SHALL INCLUDE ALL SCOPE TO REMOVE ITEMS MADE OBSOLETE BY NEW WORK INCLUDING CONTROLS, CONTROL WIRING AND PNEUMATIC TUBING ASSOCIATED WITH VALVES THAT ARE REMOVED. THE CONTRACTOR SHALL GIVE THE OWNER FIRST RIGHT OF REFUSAL OF ANY EXISTING EQUIPMENT PRIOR TO REMOVAL FROM THE SITE.
- D. THE CONTRACTOR SHALL REMOVE AND PROTECT CEILING TILES AND GRID AS NEEDED TO ACCESS AND REMOVE ITEMS AS NOTED. CEILING REMOVAL AND REINSTALLATION TO ALLOW FOR INSTALLATION OF NEW SYSTEMS ABOVE CEILING IS ALSO THE CONTRACTORS RESPONSIBILITY.
- E. VERIFY EXISTING CONDITIONS PRIOR TO BIDDING AND DEMOLITION.
- F. THE EXISTING HEATING WATER PIPING SYSTEM SHALL BE DRAINED BACK TO THE MECHANICAL ROOM AND NEW, ADDITIONAL SHUT-OFF VALVES SHALL BE INSTALLED AT ALL EXISTING BRANCH PIPING AND NEW BRANCH PIPING CONNECTIONS TO MAINS. NEW VALVES SHALL ALSO BE INSTALLED AT EACH NEW COIL/DEVICE. THE CONTRACTOR SHALL COORDINATE DRAINING AND PIPING WORK TO MINIMIZE SYSTEM DOWN TIME. THE WATER TREATMENT CONTRACTOR SHALL BE RESPONSIBLE FOR FILLING THE SYSTEM AND MAINTENANCE OF CHEMICAL TREATMENT LEVELS DURING CONSTRUCTION. THE MC SHALL BE RESPONSIBLE FOR ALL EXPENSES ASSOCIATED WITH SYSTEM DRAINING AND FILLING AND VALVE INSTALLATION.

ROOF DEMOLITION NOTES

1. REMOVE EXISTING EXHAUST FAN AND PREPARE FOR INSTALLATION OF NEW EXHAUST FAN ON EXISTING CURB. SEE SHEET MR101 FOR NEW WORK.
2. REMOVE EXISTING EXHAUST FAN. SEE SHEET MR101 FOR CURB CAPPING.
3. REMOVE EXISTING RTU AND CURB COMPLETE. SEE MR101 FOR NEW RTU WORK.
4. REMOVE EXISTING CONDENSING UNIT AND PREPARE FOR INSTALLATION OF NEW CONDENSING UNIT.

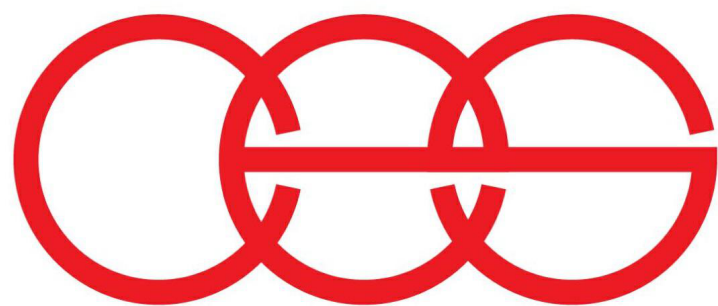

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STRUCTURAL: ENGINEERS: CES

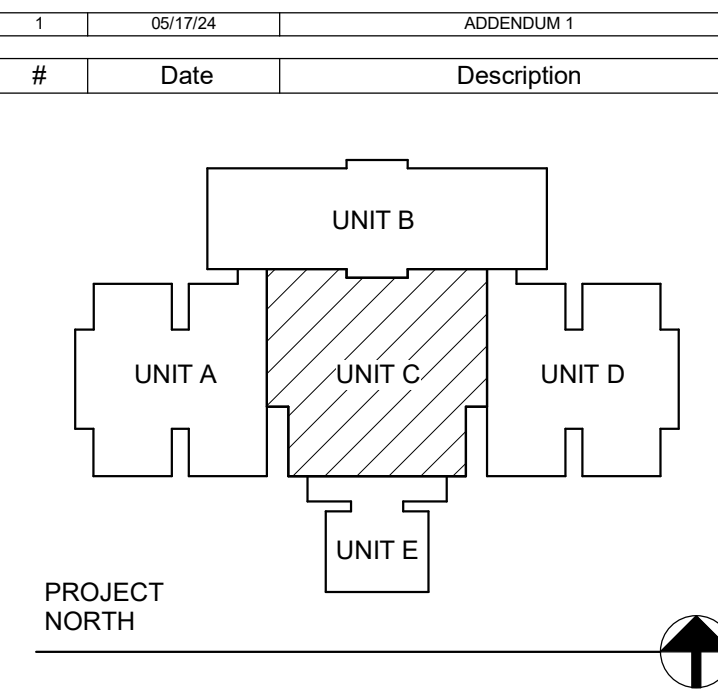Project Name:
**RENOVATIONS TO
RUSHVILLE ELEMENTARY
SCHOOL**

Drawing Title:
**MECHANICAL DEMOLITION ROOF PLAN -
UNIT C**

	Client Project No:
	VPS Project No:
	Project Issue Date:
	Drawing No:


2023021.00
05/03/24
MD103

MECHANICAL HVAC PLAN NOTES


1. PROVIDE CONNECTION TO EXISTING BATHROOM EXHAUST. RE-BALANCE EXHAUST FAN TO PROVIDE EXISTING EXHAUST FLOW RATES IN EXISTING RESTROOMS AS WELL AS ADDITIONAL EXHAUST FROM NEW RESTROOM. TAKE READINGS AND DOCUMENT EXISTING EXHAUST FLOW FROM RESTROOMS PRIOR TO BEGINNING WORK.
2. PROVIDE BACKDRAFT DAMPER AND BIRD SCREEN WITH WALL CAP.
3. CONNECT SINGLE WALL GALVANIZED STEEL SHEET METAL DUCT TO EXISTING INTERNALLY LINED GALVANIZED STEEL SHEET METAL DUCT. REFER TO DETAIL 10 ON SHEET M-501.
4. REBALANCE EXISTING DIFFUSER/GRILLE TO VALUE DETERMINED AT TIME OF AIRFLOW READINGS PRIOR TO DEMOLITION.
6. TOC SHALL COORDINATE WITH MC AND EC FOR FINAL LOCATION.
7. 36x24 UP TO RTU SUPPLY CONNECTION. TRANSITION TO UNIT OPENING.
8. BALANCE AIRFLOW TO VALUE DETERMINED AT TIME OF READINGS PRIOR TO DEMOLITION MINUS 730 CFM.



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1 MECHANICAL HVAC FIRST FLOOR PLAN - UNIT B
1/8" = 1'-0"

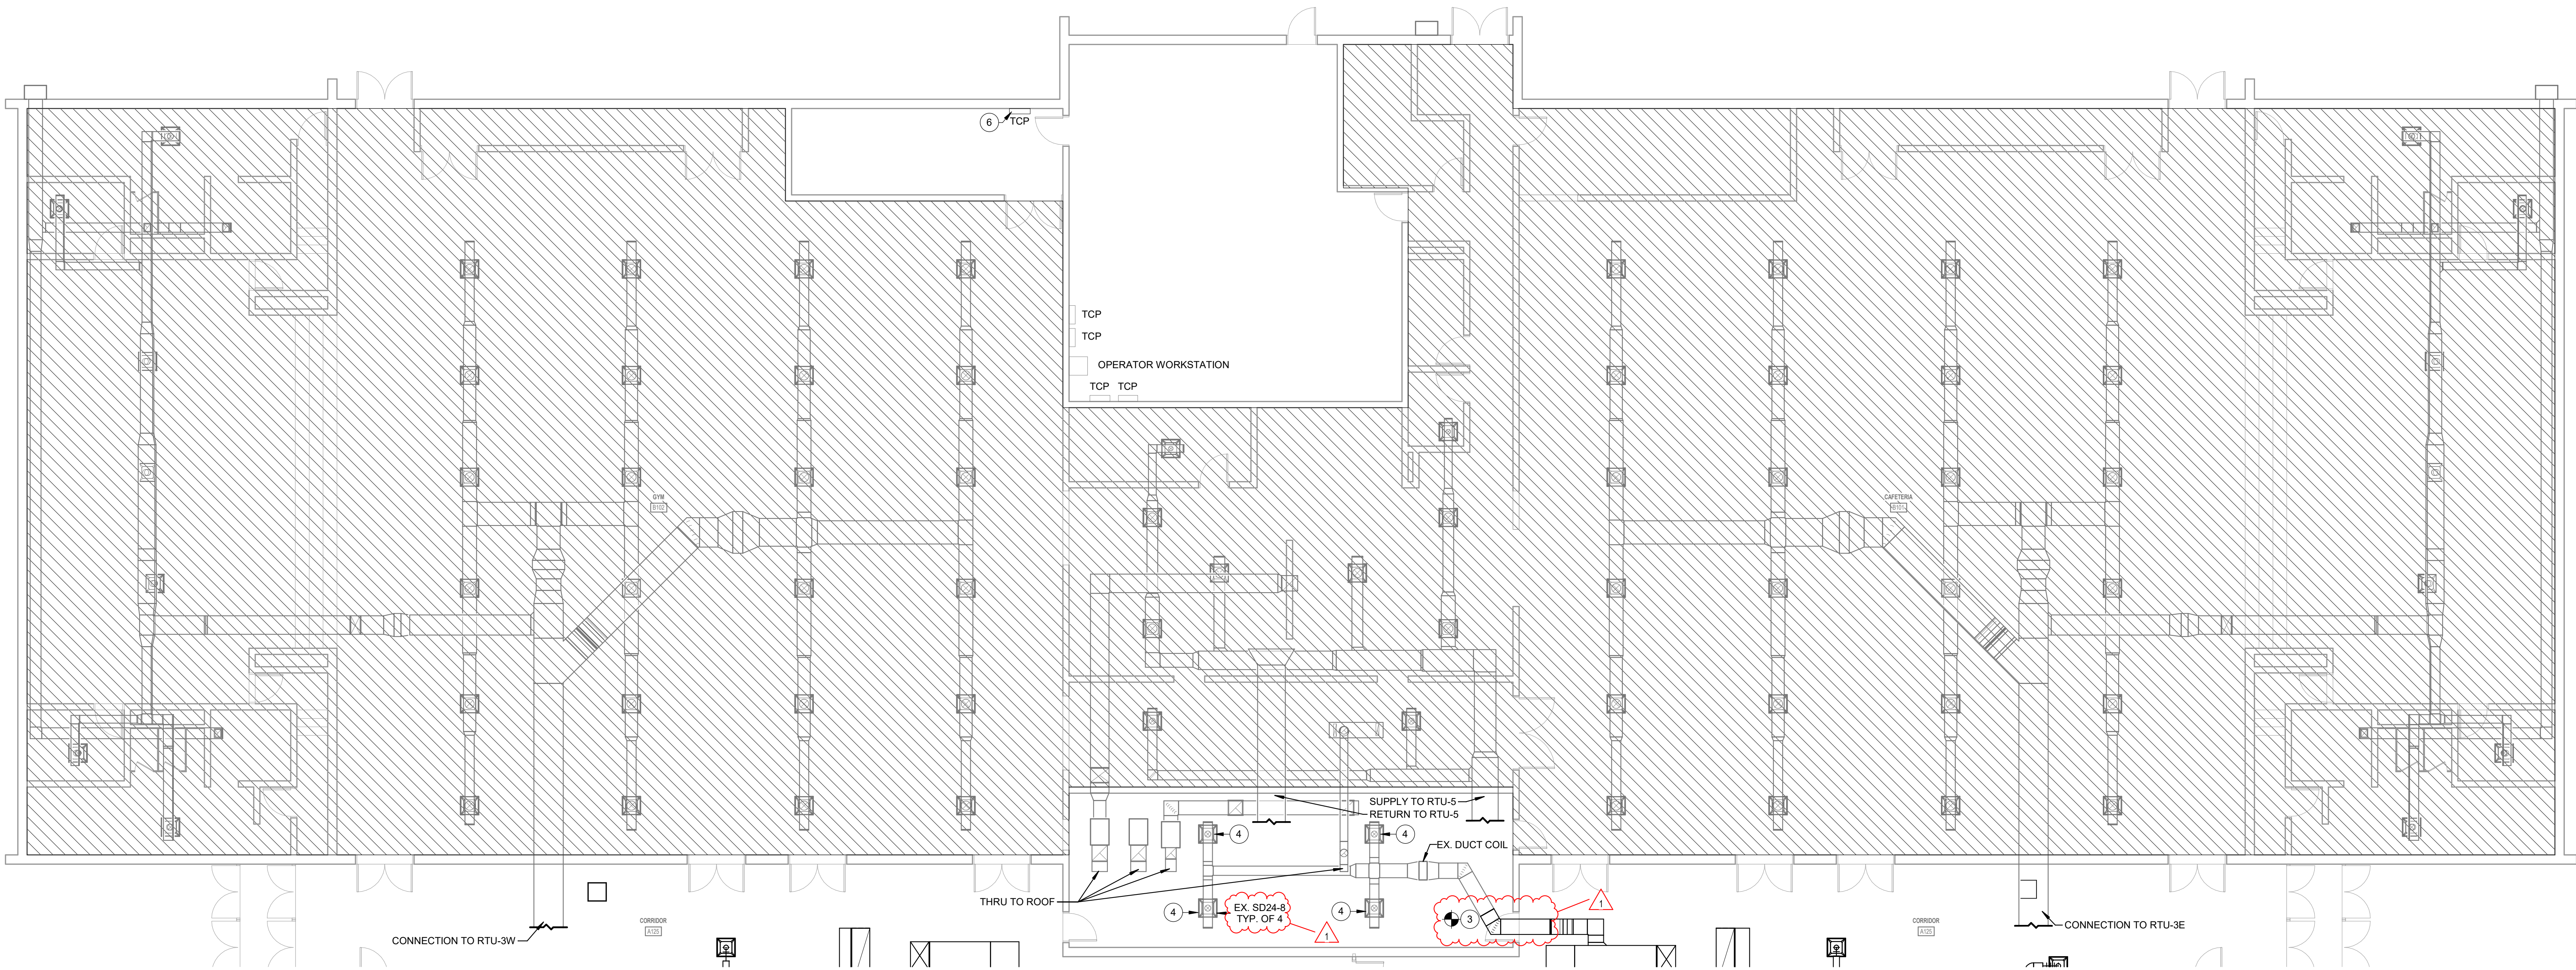

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STRUCTURAL: ENGINEERS: CES

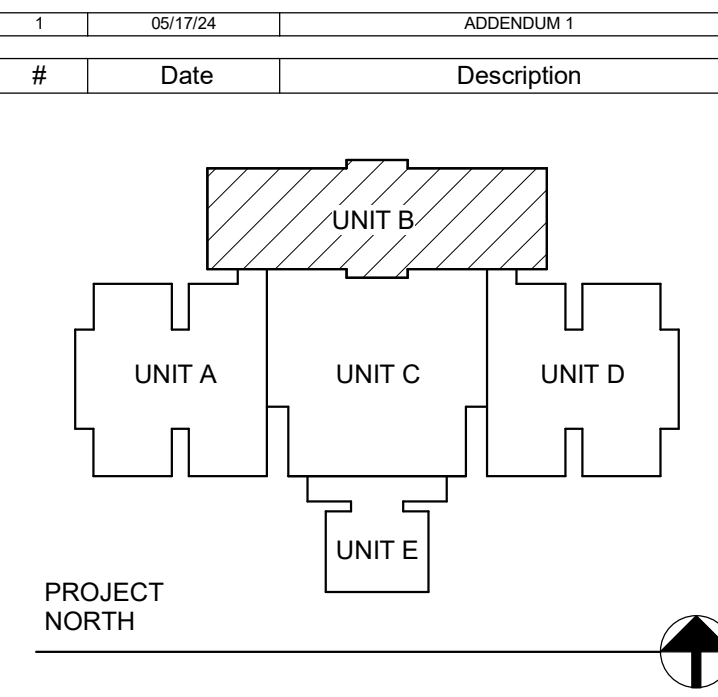
Project Name:
RENOVATIONS TO RUSHVILLE ELEMENTARY SCHOOL
Drawing Title:
MECHANICAL HVAC FIRST FLOOR PLAN - UNIT B



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NO.
PE10808972
STATE OF
INDIANA
PROFESSIONAL ENGINEER

Client Project No:
VPS Project No: **2023021.00**
Project Issue Date: **05/03/24**
Drawing No: **MH102**

1. PROVIDE CONNECTION TO EXISTING BATHROOM EXHAUST - RE-BALANCE EXHAUST FAN TO PROVIDE EXISTING EXHAUST FLOW RATES IN EXISTING RESTROOMS AS WELL AS ADDITIONAL EXHAUST FLOW FROM NEW RESTROOM. TAKE READINGS AND DOCUMENT EXISTING EXHAUST FLOW FROM RESTROOMS PRIOR TO BEGINNING WORK.
2. PROVIDE BACKDRIFT DAMPER AND BIRD SCREEN WITH WALL CAP.
3. CONNECT SINGLE WALL GALVANIZED STEEL SHEET METAL DUCT TO EXISTING INTERIOR LINED GALVANIZED STEEL SHEET METAL DUCT. REFER TO DETAIL 10.01 ON SHEET M-501.
4. REBALANCE EXISTING DIFFUSER/GRILLE TO VALUE DETERMINED AT TIME OF AIRFLOW READINGS PRIOR TO DEMOLITION.
5. TCC SHALL COORDINATE WITH MC AND EC FOR FINAL LOCATION.
6. 36x24 UP TO RITS SUPPLY CONNECTION. TRANSITION TO UNIT OPENING.
7. RE-BALANCE EXHAUST FLOW RATES DETERMINED AT TIME OF READINGS PRIOR TO DEMOLITION MINUS 73% CFM.

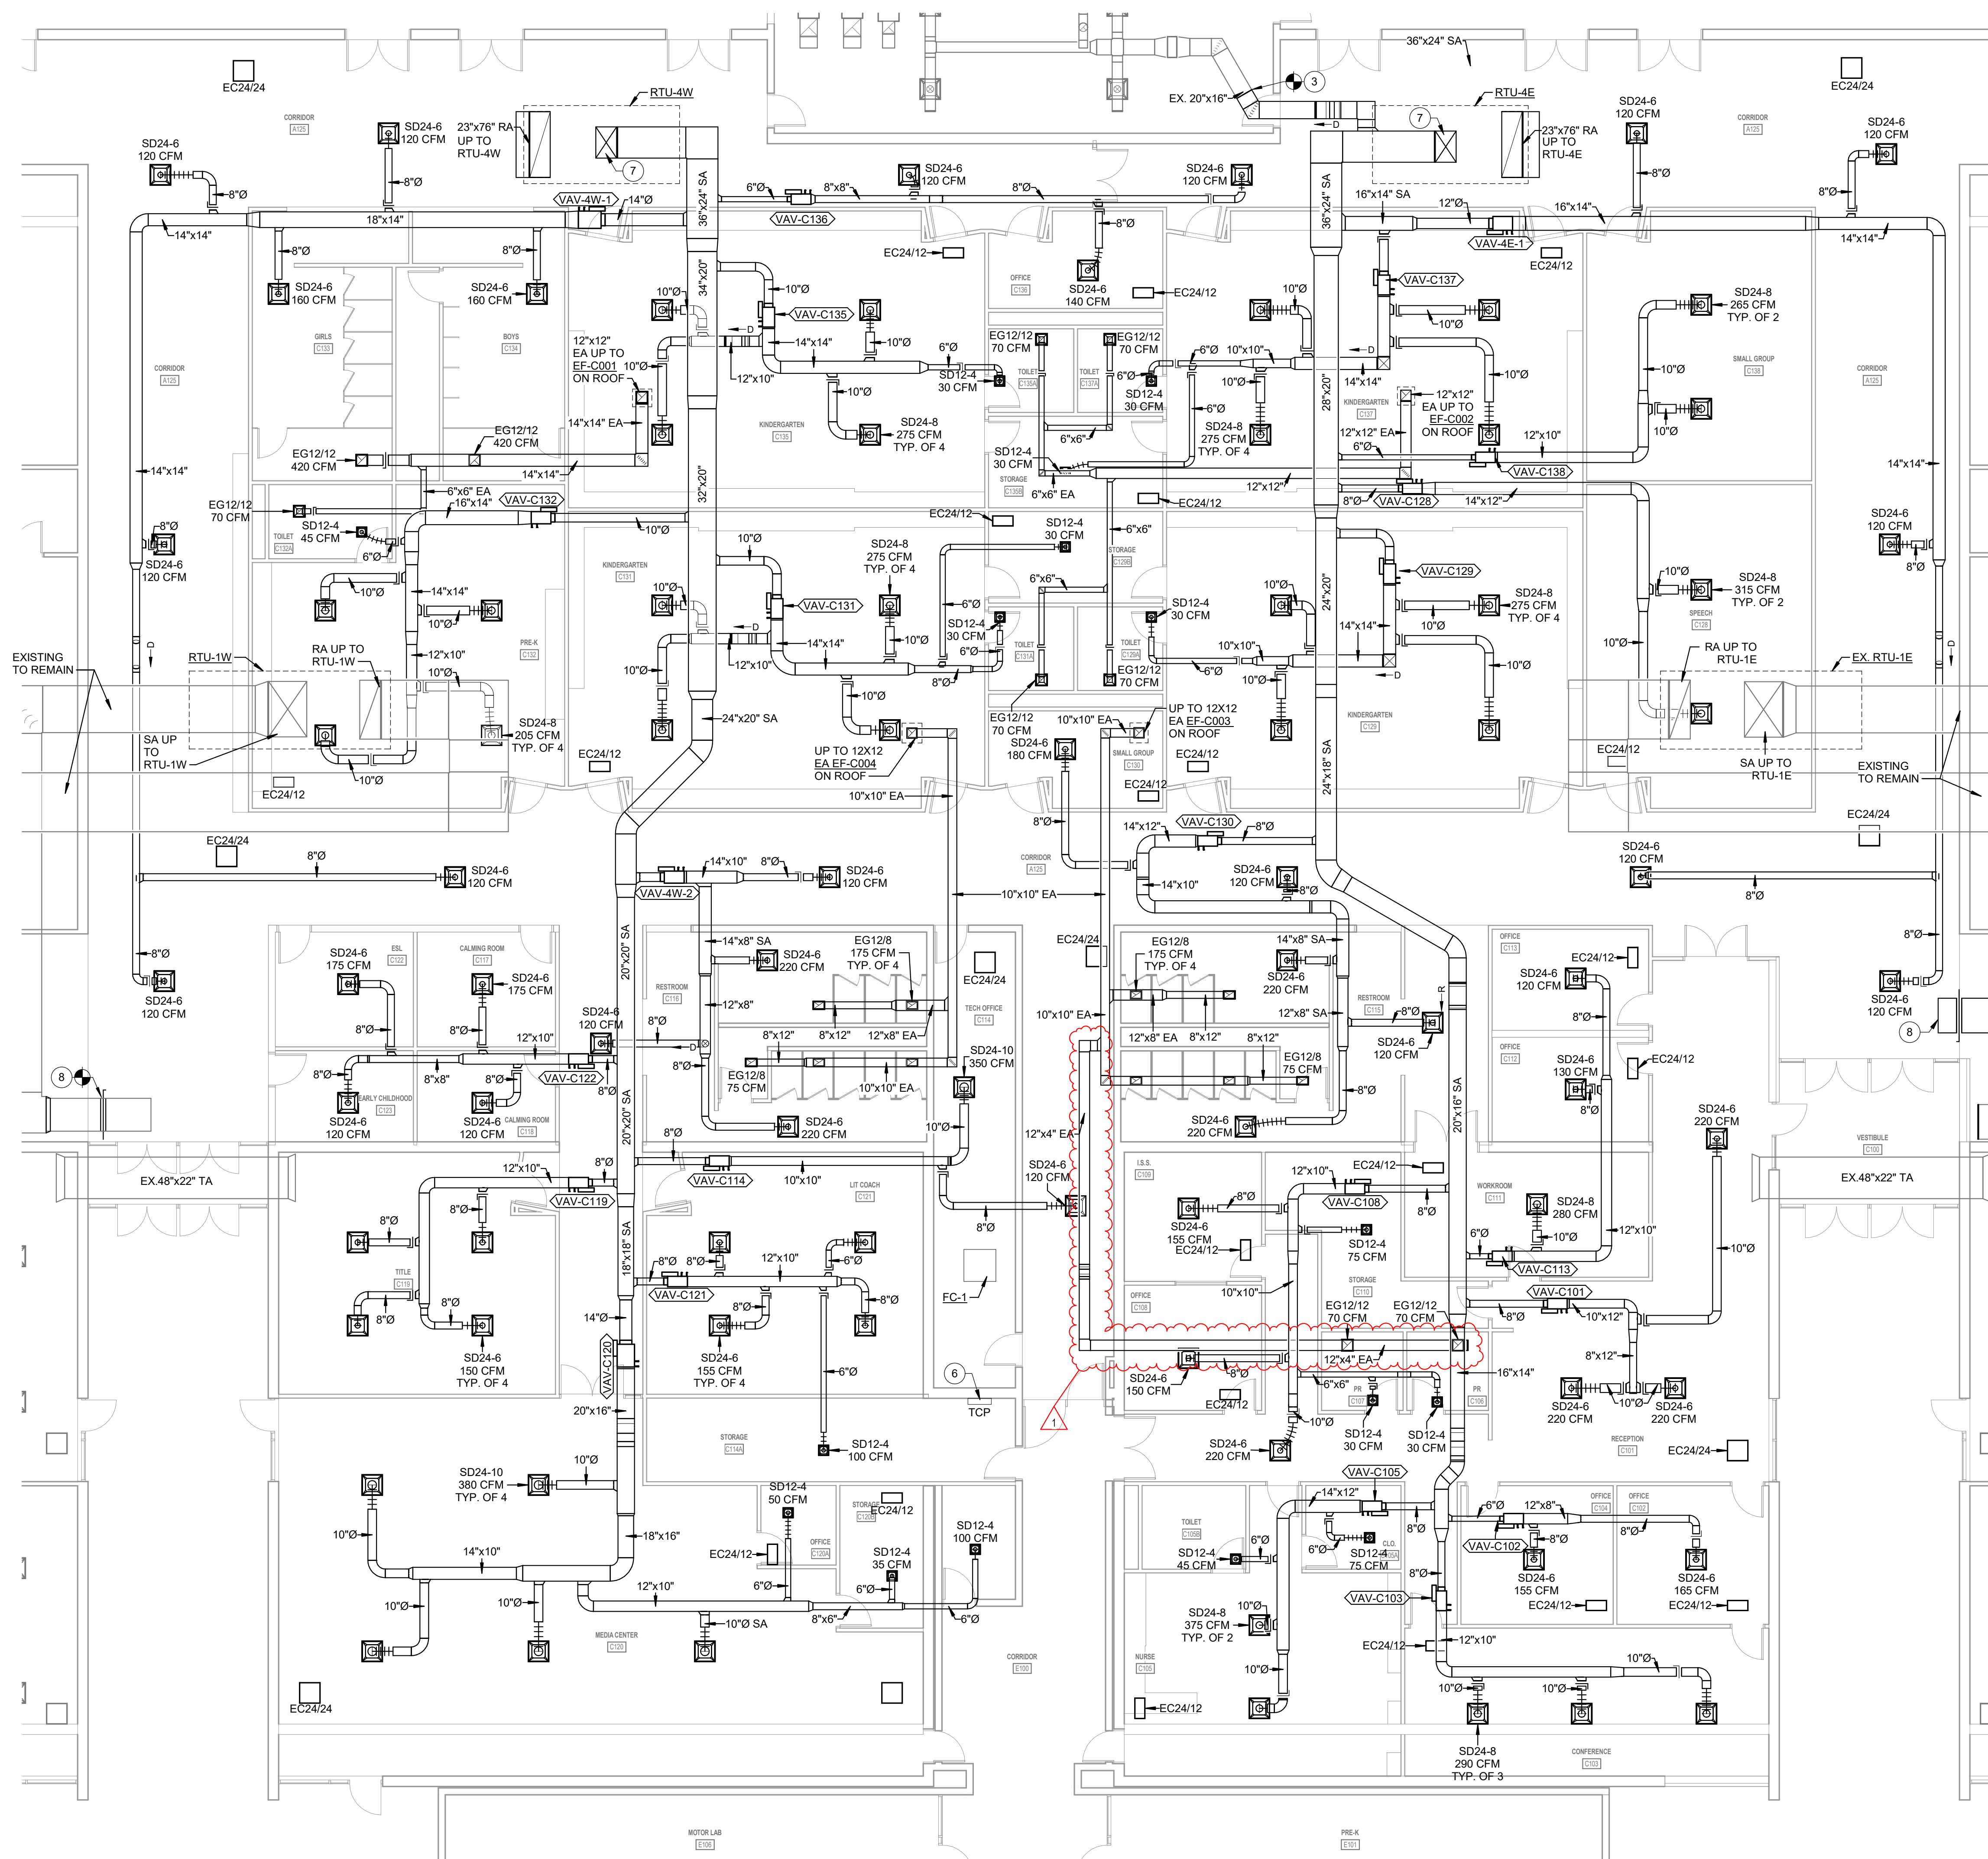

1 MECHANICAL HVAC FIRST FLOOR PLAN - UNIT C
1/8" = 1'-0"



Diagram of Project North showing five units: Unit A, Unit B, Unit C, Unit D, and Unit E. Unit C is shaded with diagonal lines.

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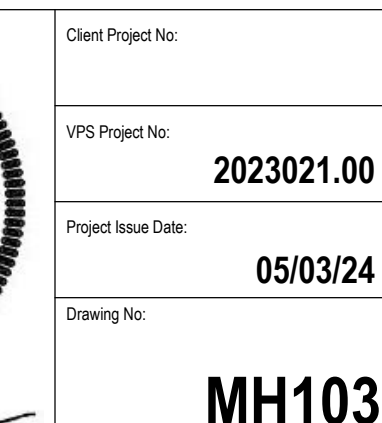
ENGINEERS: CE

Project Name:

**RENOVATIONS TO
RUSHVILLE ELEMENTARY
SCHOOL**

Drawing Title:

**MECHANICAL HVAC FIRST FLOOR PLAN -
UNIT C**




MH103

MECHANICAL PIPING GENERAL NOTES

A THE EXISTING HEATING WATER PIPING SYSTEM SHALL BE DRAINED BACK TO THE MECHANICAL ROOM AND NEW, ADDITIONAL SHUT-OFF VALVES SHALL BE INSTALLED AT ALL EXISTING BRANCH PIPING AND NEW BRANCH PIPING CONNECTIONS TO MAINS. NEW VALVES SHALL ALSO BE INSTALLED AT EACH NEW COIL/DEVICE. THE CONTRACTOR SHALL COORDINATE DRAINING AND PIPING WORK TO MINIMIZE SYSTEM DOWN TIME. THE WATER TREATMENT CONTRACTOR SHALL BE RESPONSIBLE FOR FILLING THE SYSTEM AND MAINTENANCE OF CHEMICAL TREATMENT LEVELS DURING CONSTRUCTION. THE MC SHALL BE RESPONSIBLE FOR ALL EXPENSES ASSOCIATED WITH SYSTEM DRAINING AND FILLING AND VALVE INSTALLATION.


MECHANICAL PIPING PLAN NOTES

1. ROUTE CONDENSATE DOWN IN NEW WALL TO AUXILIARY TAILPIECE CONNECTION AT SINK DRAIN.
2. INSTALL NEW REFRIGERANT PIPING FROM FAN COIL TO CONDENSING UNIT. INSULATE ALL REFRIGERANT LINES. SIZE PIPING PER MANUFACTURERS RECOMMENDATION BASED ON TOTAL EQUIVALENT LENGTH.
3. ROUTE ABOVE SUPPLY MAIN DUCT.

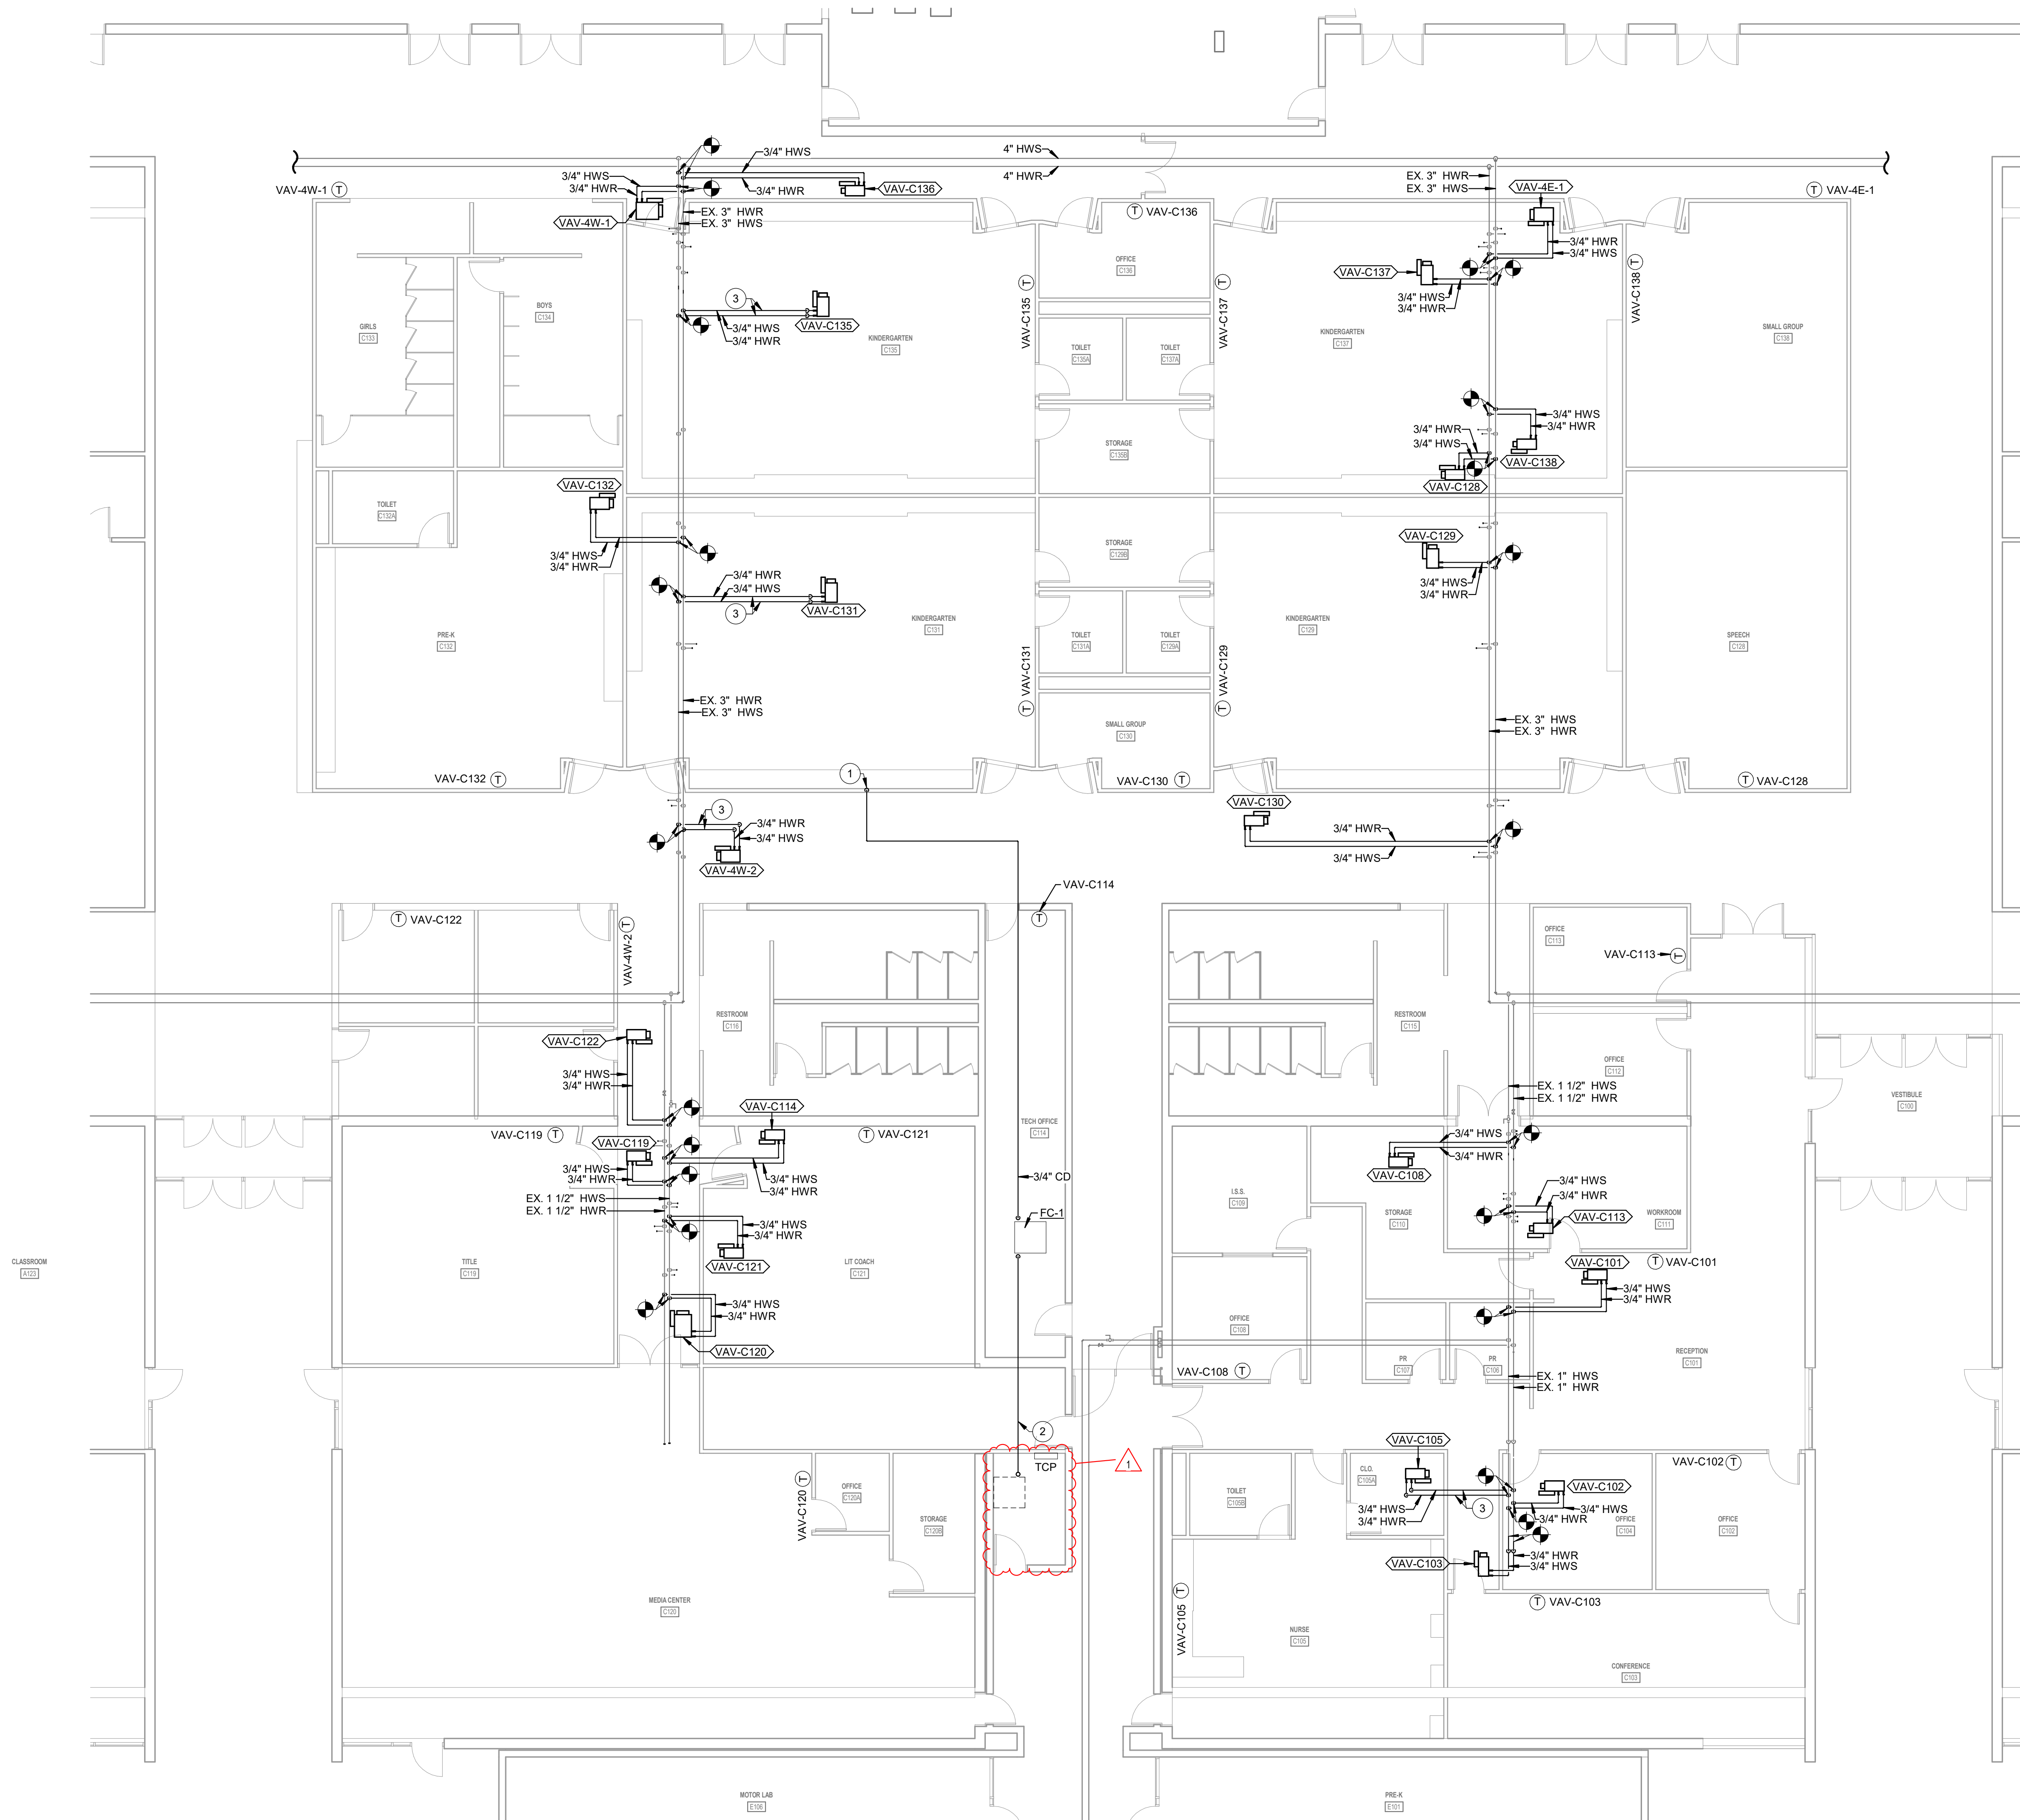

1 MECHANICAL PIPING FIRST FLOOR PLAN - UNIT C
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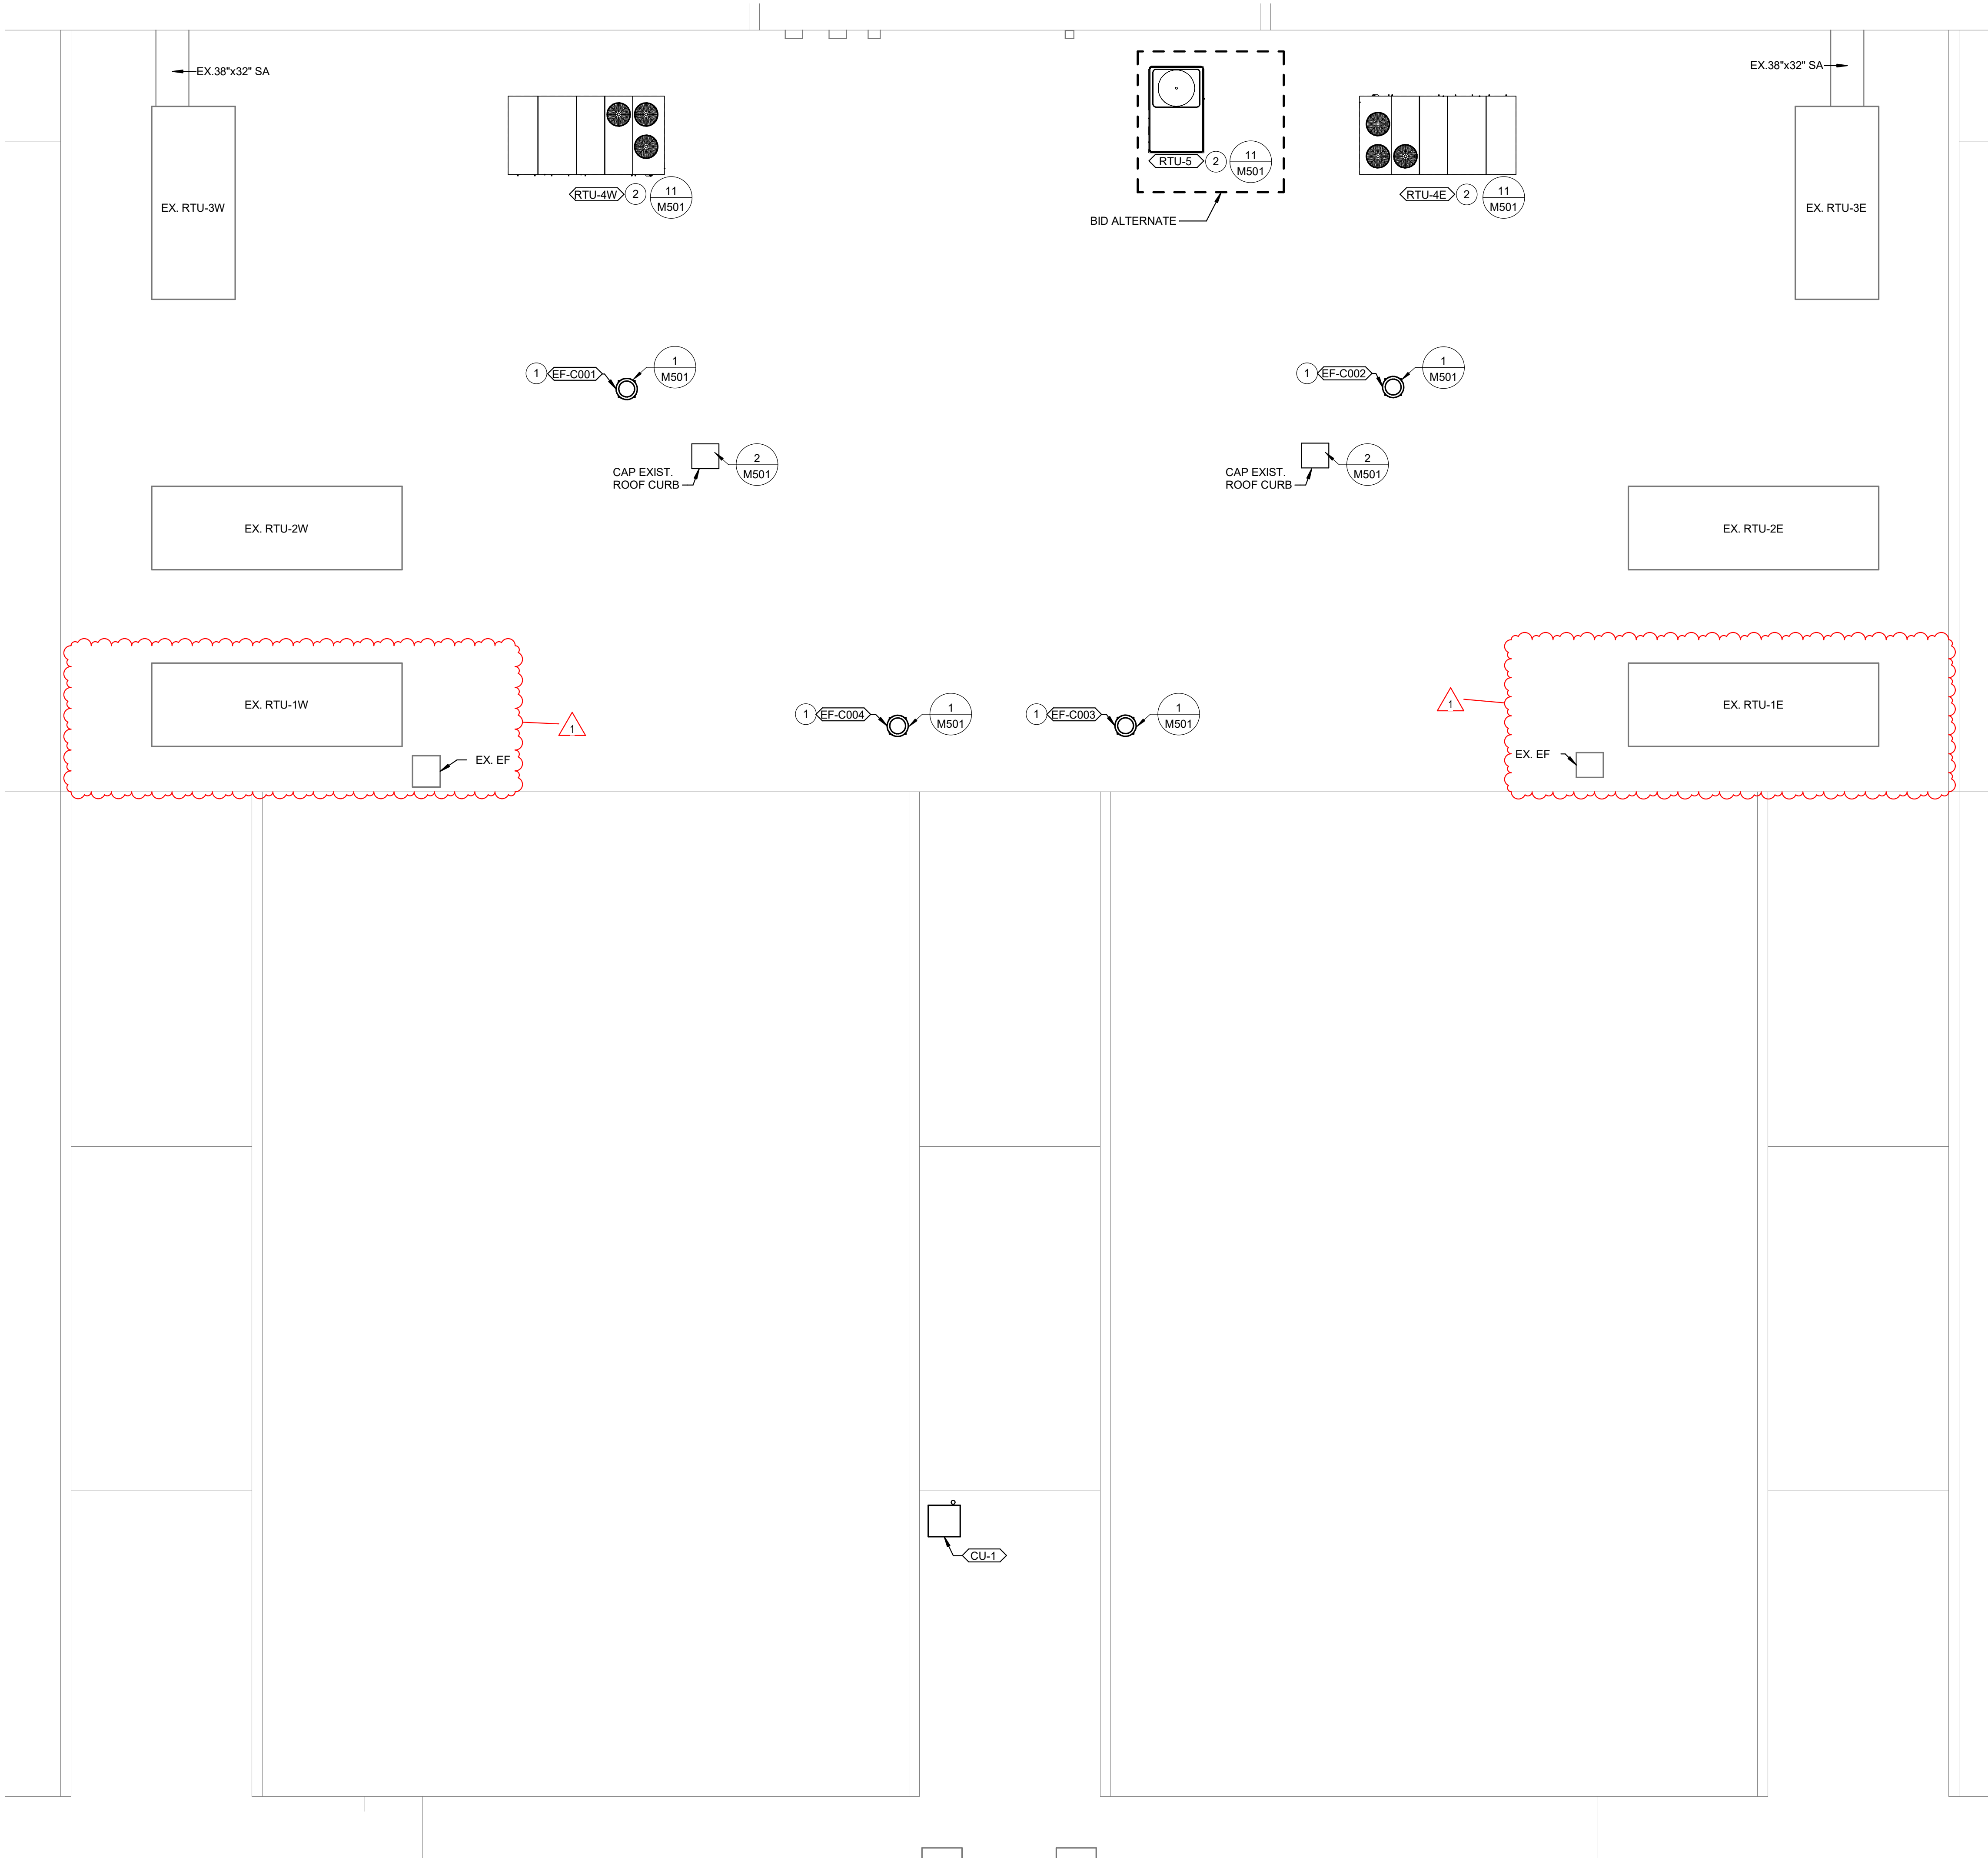
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Project Name:
RENOVATIONS TO RUSHVILLE ELEMENTARY SCHOOL
Drawing Title:
MECHANICAL PIPING FIRST FLOOR PLAN - UNIT C


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PROFESSIONAL ENGINEER
Client Project No:
VPS Project No: **2023021.00**
Project Issue Date: **05/03/24**
Drawing No: **MP101**

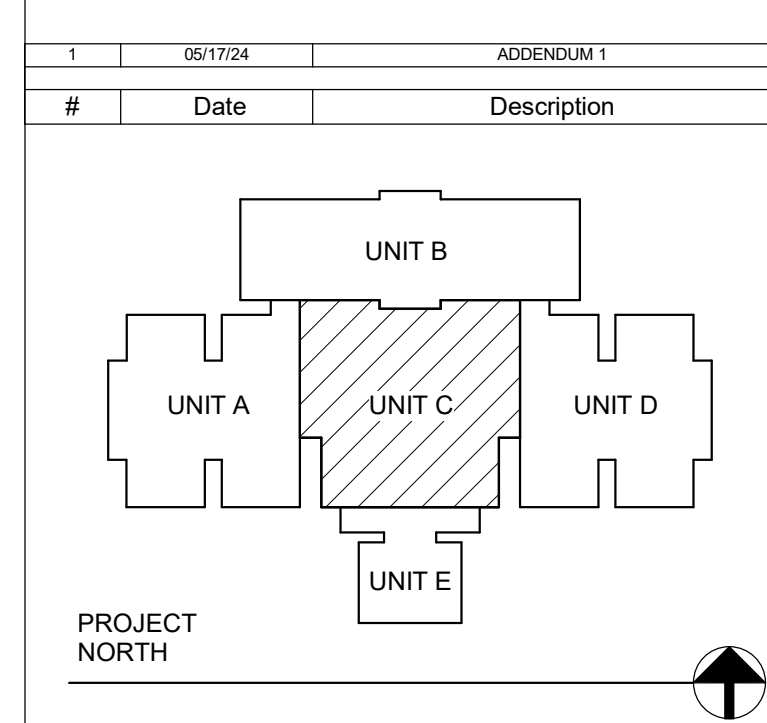MECHANICAL ROOF PLAN NOTES
1. INSTALL NEW EF ON EXISTING CURB. PROVIDE CURB ADAPTER AS REQUIRED.
2. INSTALL NEW RTU ON NEW CURB.



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STRUCTURAL: ENGINEERS: CES

Project Name:
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SCHOOL**

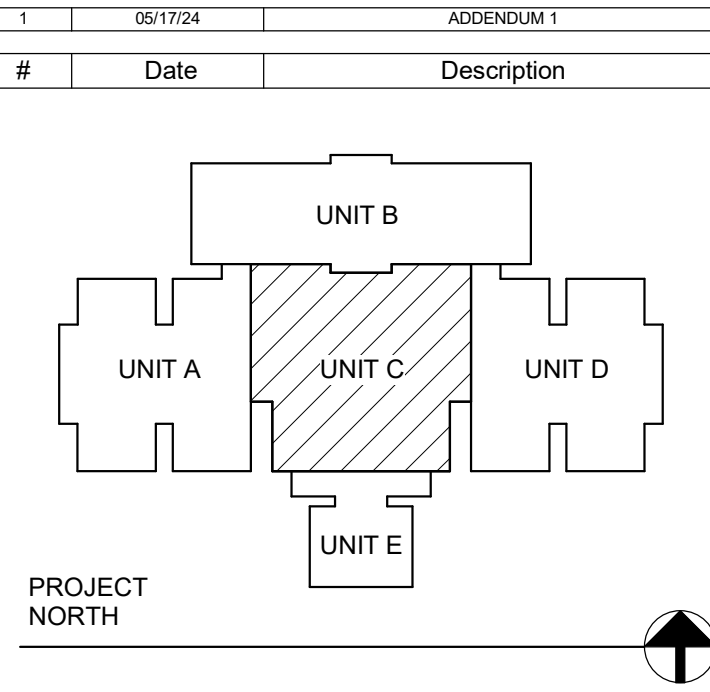Drawing Title:
MECHANICAL HVAC ROOF PLAN - UNIT C

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Project Issue Date: **05/03/24**
Drawing No: **MR101**