

ADDENDUM

Project No.:2401110Addendum No: 02Project:EACS HS Classroom RenovationsDate: 12-18-2024

TO: ALL BIDDERS OF RECORD

ADDENDUM NO. 02, to Drawings and Specifications dated 11-27-2024, for the HS Classroom Renovations for the East Allen County Schools; as prepared by ELEVATUS Architecture, 111 E. Wayne Street, Suite 555, Fort Wayne, IN 46802

This ADDENDUM shall hereby be and become a part of the Contract Documents the same as if originally bound thereto.

The following clarifications, amendments, additions, revisions, changes, and modifications change the original Contract Documents only in the amount and to the extent hereinafter specified and set forth in this ADDENDUM.

Each Bidder shall acknowledge receipt of this ADDENDUM on the Bid Form.

PROJECT MANUAL:

ITEM NO. 1.01 - PROJECT MANUAL, 00 25 13, Pre-Bid Conference

A. Revise location of Pre-Bid conference to reflect change to Notice to Bidders in Addendum #1

ITEM NO. 1.02 - PROJECT MANUAL, 10 14 00, Identifying Devices

A. Article 1.3, paragraph B; revise to read in Braille <u>per applicable state and local ADA Building</u>
 <u>Codes</u>

DRAWINGS HERITAGE JR/SR HIGH SCHOOL:

ITEM NO. 2.01 - DRAWING NO. AD101 Architectural Demolition Plan - Second Floor

- A. Removal of Demolition Plan Notes 3.07 from Second Floor Architectural Demolition Plan.
- B. Removal of note 3.07 from Demolition Plan Notes.

ITEM NO. 2.02 - DRAWING NO. A-111 Architectural Notation Plan - Second Floor

- C. Addition of Floor Plan Note 4.01 to rooms 204, 205, 206, 207, 208, 209.
- D. Addition of note 4.01 to Floor Plan Notes.
- E. Removal of Floor Plan Note 9.01 from Second Floor Architectural Notation Plan
- F. Removal of note 9.01 from Floor Plan Notes.
- G. Removal of Door Elevation Transom Infill #2.
- H. Removal HM Frame Transom Infill Detail #3.

ITEM NO. 2.03 - DRAWING NO. A-141 Finishes Plan - Second Floor

- A. Revision to Elevation Typ. Classroom Casework #2
- B. Revision to Elevation Classroom Instruction Wall #4

Project No.: 2401110

Project Name: EACS HS Classroom Renovations

DRAWINGS WOODLAN JR/SR HIGH SCHOOL:

<u>ITEM NO. 2.04 - DRAWING NO. AD101 Architectural Demolition Plan - Second Floor In response to RFI</u>#B-03

Addendum No.:

Page:

02

2 of 2

- A. Addition of note 3.13 to Demolition Plan Notes.
- B. Addition of Demolition Plan Note 3.13 to Hallway 200.

<u>ITEM NO. 2.05 - DRAWING NO. A-111 Architectural Notation Plan - Second Floor In response to RFI #B-03</u>

- A. Addition of note 11.03 to Floor Plan Notes.
- B. Addition of Floor Plan Note 11.03 to Second Floor Architectural Notation Plan

ITEM NO. 2.06 - DRAWING NO. A-141 Finishes Plan - Second Floor

A. Revision of Finish Plan Note 1.

ITEM NO. 2.07 - MEP Addendum #2

A. Refer to attached MEP Addendum

Submitted By:

Abigail Redick, WELL AP

ELEVATUS

ARCHITECTURE

cc:	File:	Document
	Owner:	
	Contractor:	
	Consultant:	
	Consultant:	

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Primary Engineering, Inc.


2828 Lake Ave. Fort Wayne, Indiana 46805 260-424-0444 ph www.primary-eng.com



Date: 12/18/2024

Project: **EACS HS Classroom Renovations**

Comm #: **24667**

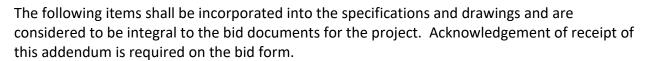

Item #1: General Clarifications.

- **A.** Alternates:
 - Alternate #1 Leo HS Classroom 156
 - Alternate #2 Leo HS Classroom 142
 - Alternate #3 Heritage HS Classroom 205
 - Alternate #4 Heritage HS Classroom 204
 - Alternate #5 Woodlan HS Classroom 207B
 - Alternate #36 Woodlan HS- Classroom 207A
- **B.** Heritage HS: Remove existing finned tube radiation complete including all associated mounting devices, piping, electrical, controls and cover panels. Cap piping below slab. Coordinate with GC to patch to match adjacent surroundings.

Item #2: Woodland HS: Drawing Sheet M001, "Mechanical Information Sheet":

A. Added Diffuser and Grille Schedule. Refer to drawing sheet M001 labeled Addendum #2 for more information.

Item #3: Woodland HS: Drawing Sheet M101, "Second Floor Mechanical Plan":

A. Added transfer grilles and openings above ceilings. Refer to drawing sheet M101 labeled Addendum #2 for more information.

Item #4: Leo HS: Drawing sheet E001, "Electrical Information sheet".

A. Revise Light Fixture Schedule, added emergency exit fixture. Refer to sheet E001.

Item #5: Leo HS: Drawing sheet E001, "Lighting Plan".

A. Added emergency exit light fixtures in classroom 142. Refer to sheet E301.



SECTION 00 25 13 - PRE-BID CONFERENCE

PRE-BID CONFERENCE for the

EACS HS Classroom Renovations at Leo Jr/Sr High School Heritage Jr/Sr High School Woodlan High School

There will be a pre-bid conference held on at 10:00 AM (local time) Thursday December 05, 2024 at the EACS Annex Building, 800 Homestead Drive EACS Service Center Conference Room, 1322 Green Road, New Haven, IN 46774, consisting of review of the project. At this time the Owner's representatives and Architect will discuss the project requirements and procedures. Contractors are highly encouraged to attend. Failure to attend does not relieve the bidder from the responsibility to carry out the work in the manner discussed at the conference. This pre-bid conference does not relieve the bidders to the on-site inspection of the project requirements.

END OF SECTION

EACS HS Classroom Renovations

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SECTION 10 14 23.16 - IDENTIFYING DEVICES

PART 1 - GENERAL

1.1 SUMMARY

- A. Provide labor, materials, and equipment necessary for the complete installation of identifying devices as indicated on the Drawings and specified herein.
 - Interior signage

1.2 SUBMITTALS

- A. Furnish required shop drawings and other submittals as required for Architect selection in accordance with Division 01 requirements.
- B. Product data sheets including installation instructions for each item specified.

1.3 QUALITY ASSURANCE

- A. Each door to each occupied space shall have a room sign installed.
- B. All room signage and life safety signage shall be in Braille per <u>applicable state and local ADA Building Codes</u><**Codes**%>.

1.4 AMERICANS WITH DISABILITIES ACT (ADA) REQUIREMENTS

A. Signage shall be provided to conform with ADA requirements. ADA requirements superseded Technical Specifications in this Section. Manufacturer shall conform to tactile, Braille, letter size, and other requirements as may be required by ADA Accessibility Guidelines for Buildings and Facilities, Section 4.30, Signage, and other applicable sections; and State and Local Codes and Regulations.

PART 2 - PRODUCTS

2.1 INTERIOR SIGNAGE

- A.. Interior Room Name and Number Signs:
 - 1. Match existing.
 - 2. Mounting: Mount to walls with concealed mechanical fasteners or adhesive as recommended by the manufacturer.
 - 3. Material: 1/8 inch thick matte polycarbonate with all edges eased.

PART 3 - EXECUTION

3.1 INSTALLATION

A. Install interior signage in accordance with approved shop drawings, ADA requirements, and at locations indicated on the Architect's Drawings and in conformance with manufacturer's instructions using only approved materials and methods

END OF SECTION


EACS HS Classroom Renovations

DEMOLITION GENERAL NOTES


- 1. DEMOLITION PLANS SHALL SERVE TO AID IN EVALUATION OF THE WORK AND EXTENT OF DEMOLITION BUT SHALL NOT BE HELD TO BE ALL INCLUSIVE. FIELD VERIFY EXISTING CONDITIONS, DEMOLITION AND REMOVALS AS REQUIRED FOR INSTALLATION OF THE NEW WORK AND FINISHES INDICATED WHETHER OR NOT SPECIFICALLY NOTED IN THESE DRAWINGS. 2. SCHEDULE DEMOLITION WORK EFFECTING OCCUPIED AREAS OF THE FACILITY IN ADVANCE WITH
- THE OWNER THROUGH CONSTRUCTION/PROJECT MANAGER. REFER TO SPECIFICATIONS. 3. FINISH REMOVAL NOTES APPLY TO PARTITIONS/WALLS THAT REMAIN. REMOVE ALL FINISHES FROM WALLS THAT REMAIN WITHIN THE LIMIT OF CONSTRUCTION, UNLESS NOTED OTHERWISE.
- REMOVED, PATCH AND REPAIR ADJACENT AREAS AS REQUIRED TO RECEIVE NEW CONSTRUCTION OR FINISHES AND TO MATCH ADJACENT SURFACES. MAINTAIN ALL EXISTING AND REQUIRED FIRE RATED CONSTRUCTION THROUGHOUT. WHERE NEW FLOOR FINISHES ARE SCHEDULED OR INDICATED, REMOVE ALL EXISTING FLOOR FINISHES AND PREPARE & CLEAN SLAB TO RECEIVE NEW FLOOR FINISHES IN ACCORDANCE WITH THE NEW FLOOR FINISH MANUFACTURERS' WRITTEN RECOMMENDATIONS UNLESS NOTED
- OTHERWISE. PROPER PREPARATION OF EXISTING SURFACES SHALL INCLUDE, BUT NOT BE LIMITED TO, REMOVAL OF ACCUMULATED ADHESIVES & MASTICS, FILLING AND REPAIR OF CRACKS & VOIDS, SURFACE RESTORATION, THOROUGH CLEANING, ETC. & OTHER PROCEDURES AS MAY BE RECOMMENDED BY MANUFACTURER OF NEW FLOORING.
- 6. UNLESS NOTED OTHERWISE, REMOVE ALL EXISTING ACCESSORIES & HARDWARE. PATCH & REPAIR ALL SURFACES TO RECEIVE NEW FINISHES. 7. OFFER REMOVED ITEMS TO OWNER BEFORE REMOVAL FROM THE SITE. DETERMINE SALVAGE ITEMS WITH THE OWNER BEFORE DEMOLITION BEGINS. ALL ITEMS NOT DESIRED BY OWNER SHALL
- BECOME PROPERTY OF THE CONTRACTOR AND SHALL BE LEGALLY DISPOSED OF OFF SITE. 8. PROTECT ALL ITEMS TO REMAIN AND REPAIR/REPLACE ANY DAMAGED ITEMS OR CONSTRUCTION. 9. GENERAL CONTRACTOR IS RESPONSIBLE FOR COORDINATING THE WORK WITH OTHER TRADES. 10. CONTRACTOR SHALL PROVIDE TEMPORARY SHORING AS NECESSARY TO COMPLETE THE WORK.
- 11. HOLES LEFT IN CONCRETE FLOORS FROM REMOVED ITEMS SHALL BE PATCHED BY GENERAL CONTRACTOR. 12. REFER TO ENGINEERING DRAWINGS FOR RELATED WORK AND ITEMS TO BE REMOVED OR RE-
- INSTALLED IN NEW CONSTRUCTION. COORDINATE TEMPORARY LIGHTING, COMMUNICATION AND MECHANICAL SYSTEMS WITH OTHER TRADES. MAINTAIN ALL LIFE SAFETY DEVICES. 13. REMOVE ABANDONED UTILITY SERVICES, SUCH AS ELECTRICAL, PLUMBING, GAS LINES, AND MECHANICAL DUCTWORK, DISCOVERED AND NOT SCHEDULED FOR REUSE BACK TO THEIR SOURCE (INCLUDING ALL HANGARS, STRAPS, WIRES, ETC.). MAINTAIN ANY SYSTEM SERVICING ADJACENT BUILDING AREAS THAT ARE NOT INCLUDED IN THE CONTRACT; REROUTE AS REQUIRED. SEE
- ENGINEERING DRAWINGS FOR ADDITIONAL INFORMATION. 14. PROVIDE ALL NECESSARY DEMOLITION OF EXISTING CONSTRUCTION FOR NEW UTILITY SERVICES AS REQUIRED.


DEMOLITION PLAN NOTES DESCRIPTION CEILING DEMOLITION 1.01 REMOVE ACOUSTICAL LAY-IN CEILING SYSTEM: PANELS, GRID SUSPENSION SYSTEM AND ALL RELATED

- HANGERS AND SUPPORTS. 1.03 ACOUSTICAL LAY-IN CEILING SYSTEM TO REMAIN. PROTECT DURING CONSTRUCTION. REPAIR ALL DAMAGED AREAS AT CONCLUSION OF THE WORK. FLOORING DEMOLITION
- 2.01 REMOVE VINYL COMPOSITION TILE FLOORING AND ALL RELATED MASTIC/ADHESIVE. CLEAN/PREP SUBFLOOR TO ACCEPT NEW FLOORING AS SCHEDULED. FLOOR FINISH TO REMAIN. PROTECT FLOORING DURING CONSTRUCTION. REPLACE DAMAGED FLOORING
- 3.01 REMOVE RESILIENT WALL BASE. PATCH/REPAIR WALL SURFACE TO ACCEPT NEW FINISHES AS SCHEDULED.
- DOOR(S) AND FRAME TO REMAIN. PROTECT DURING CONSTRUCTION. REPAIR/REPLACE DAMAGED COMPONENTS AT CONCLUSION OF THE WORK. 3.10 WINDOW AND WINDOW SILL TO REMAIN. PROTECT DURING CONSTRUCTION.
- EIXTURE DEMOLITION 4.05 TECHNOLOGY EQUIPMENT IS TO BE REMOVED BY OWNER.
- 4.06 REMOVE ALL WINDOW TREATMENTS SUCH AS MINI-BLINDS, CURTAINS, AND RELATED HANGERS. PATCH AND REPAIR ANY HOLES IN WALLS AT CONCLUSION OF WORK TO PREP FOR NEW BLINDS. OFFER TO OWNER BEFORE DISPOSING.
- REMOVE BASE CABINET(S), COUNTERTOP AND WALL CABINET(S), PATCH AND REPAIR ANY HOLES IN WALLS AT CONCLUSION OF WORK. OFFER TO OWNER BEFORE DISPOSING.
- 4.08 REMOVE TACKBOARDS, TACK STRIPS, MARKERBOARDS, ETC. PATCH AND REPAIR ANY HOLES IN WALLS AT CONCLUSION OF WORK. OFFER TO OWNER BEFORE DISPOSING. 4.09 REMOVE ALL REMAINING FURNITURE AND EQUIPMENT IN SPACE. OFFER TO OWNER BEFORE DISPOSIN
- HVAC UNIT TO REMAIN. PROTECT DURING CONSTRUCTION REPAIR/REPLACE DAMAGED COMPONENTS
- AT CONCLUSION OF THE WORK. SEE MECHANICAL DOCUMENTS FOR MORE INFORMATION. EXISTING AIR SUPPLY/RETURN VENTILATION GRILL WITH IN BASE CABINETS TO BE REMOVED IN ITS ENITERITY. EXISTING CONNECTIONS TO MECHANICAL UNIT TO BE SEALED. SEE MECHANICAL DRAWINGS FOR RELATED WORK. GENERAL CONTRACTOR TO PATCH REMAINING HOLES THROUGH FLOOR DECK

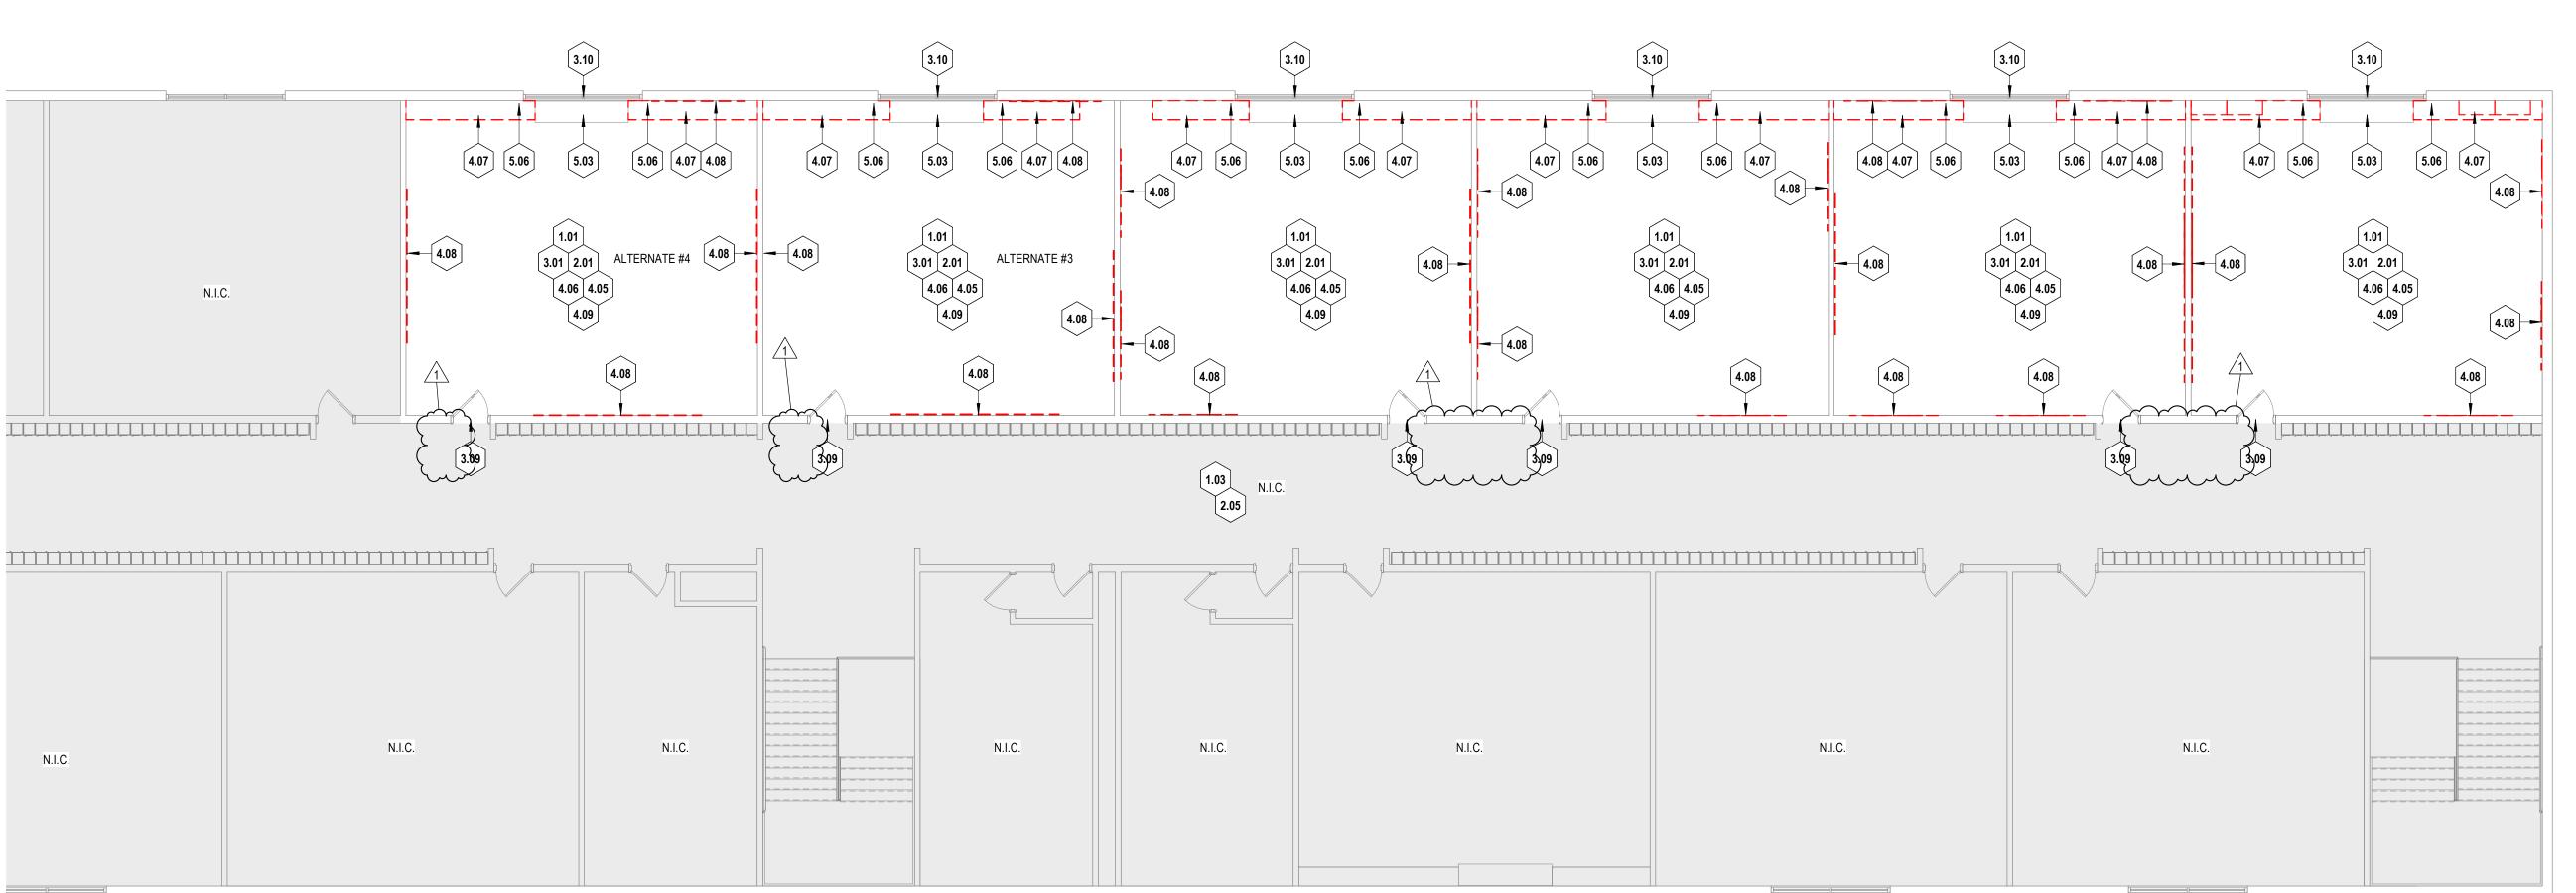



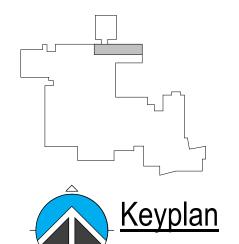

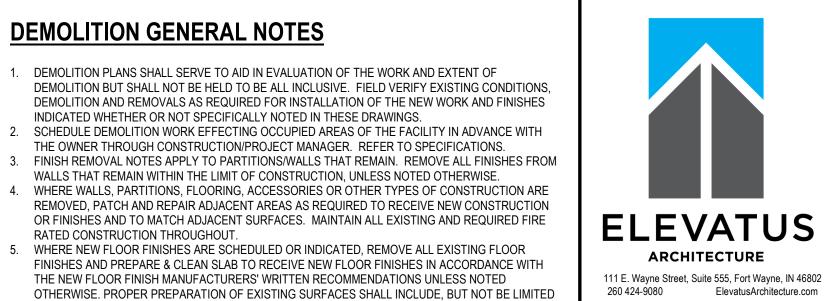

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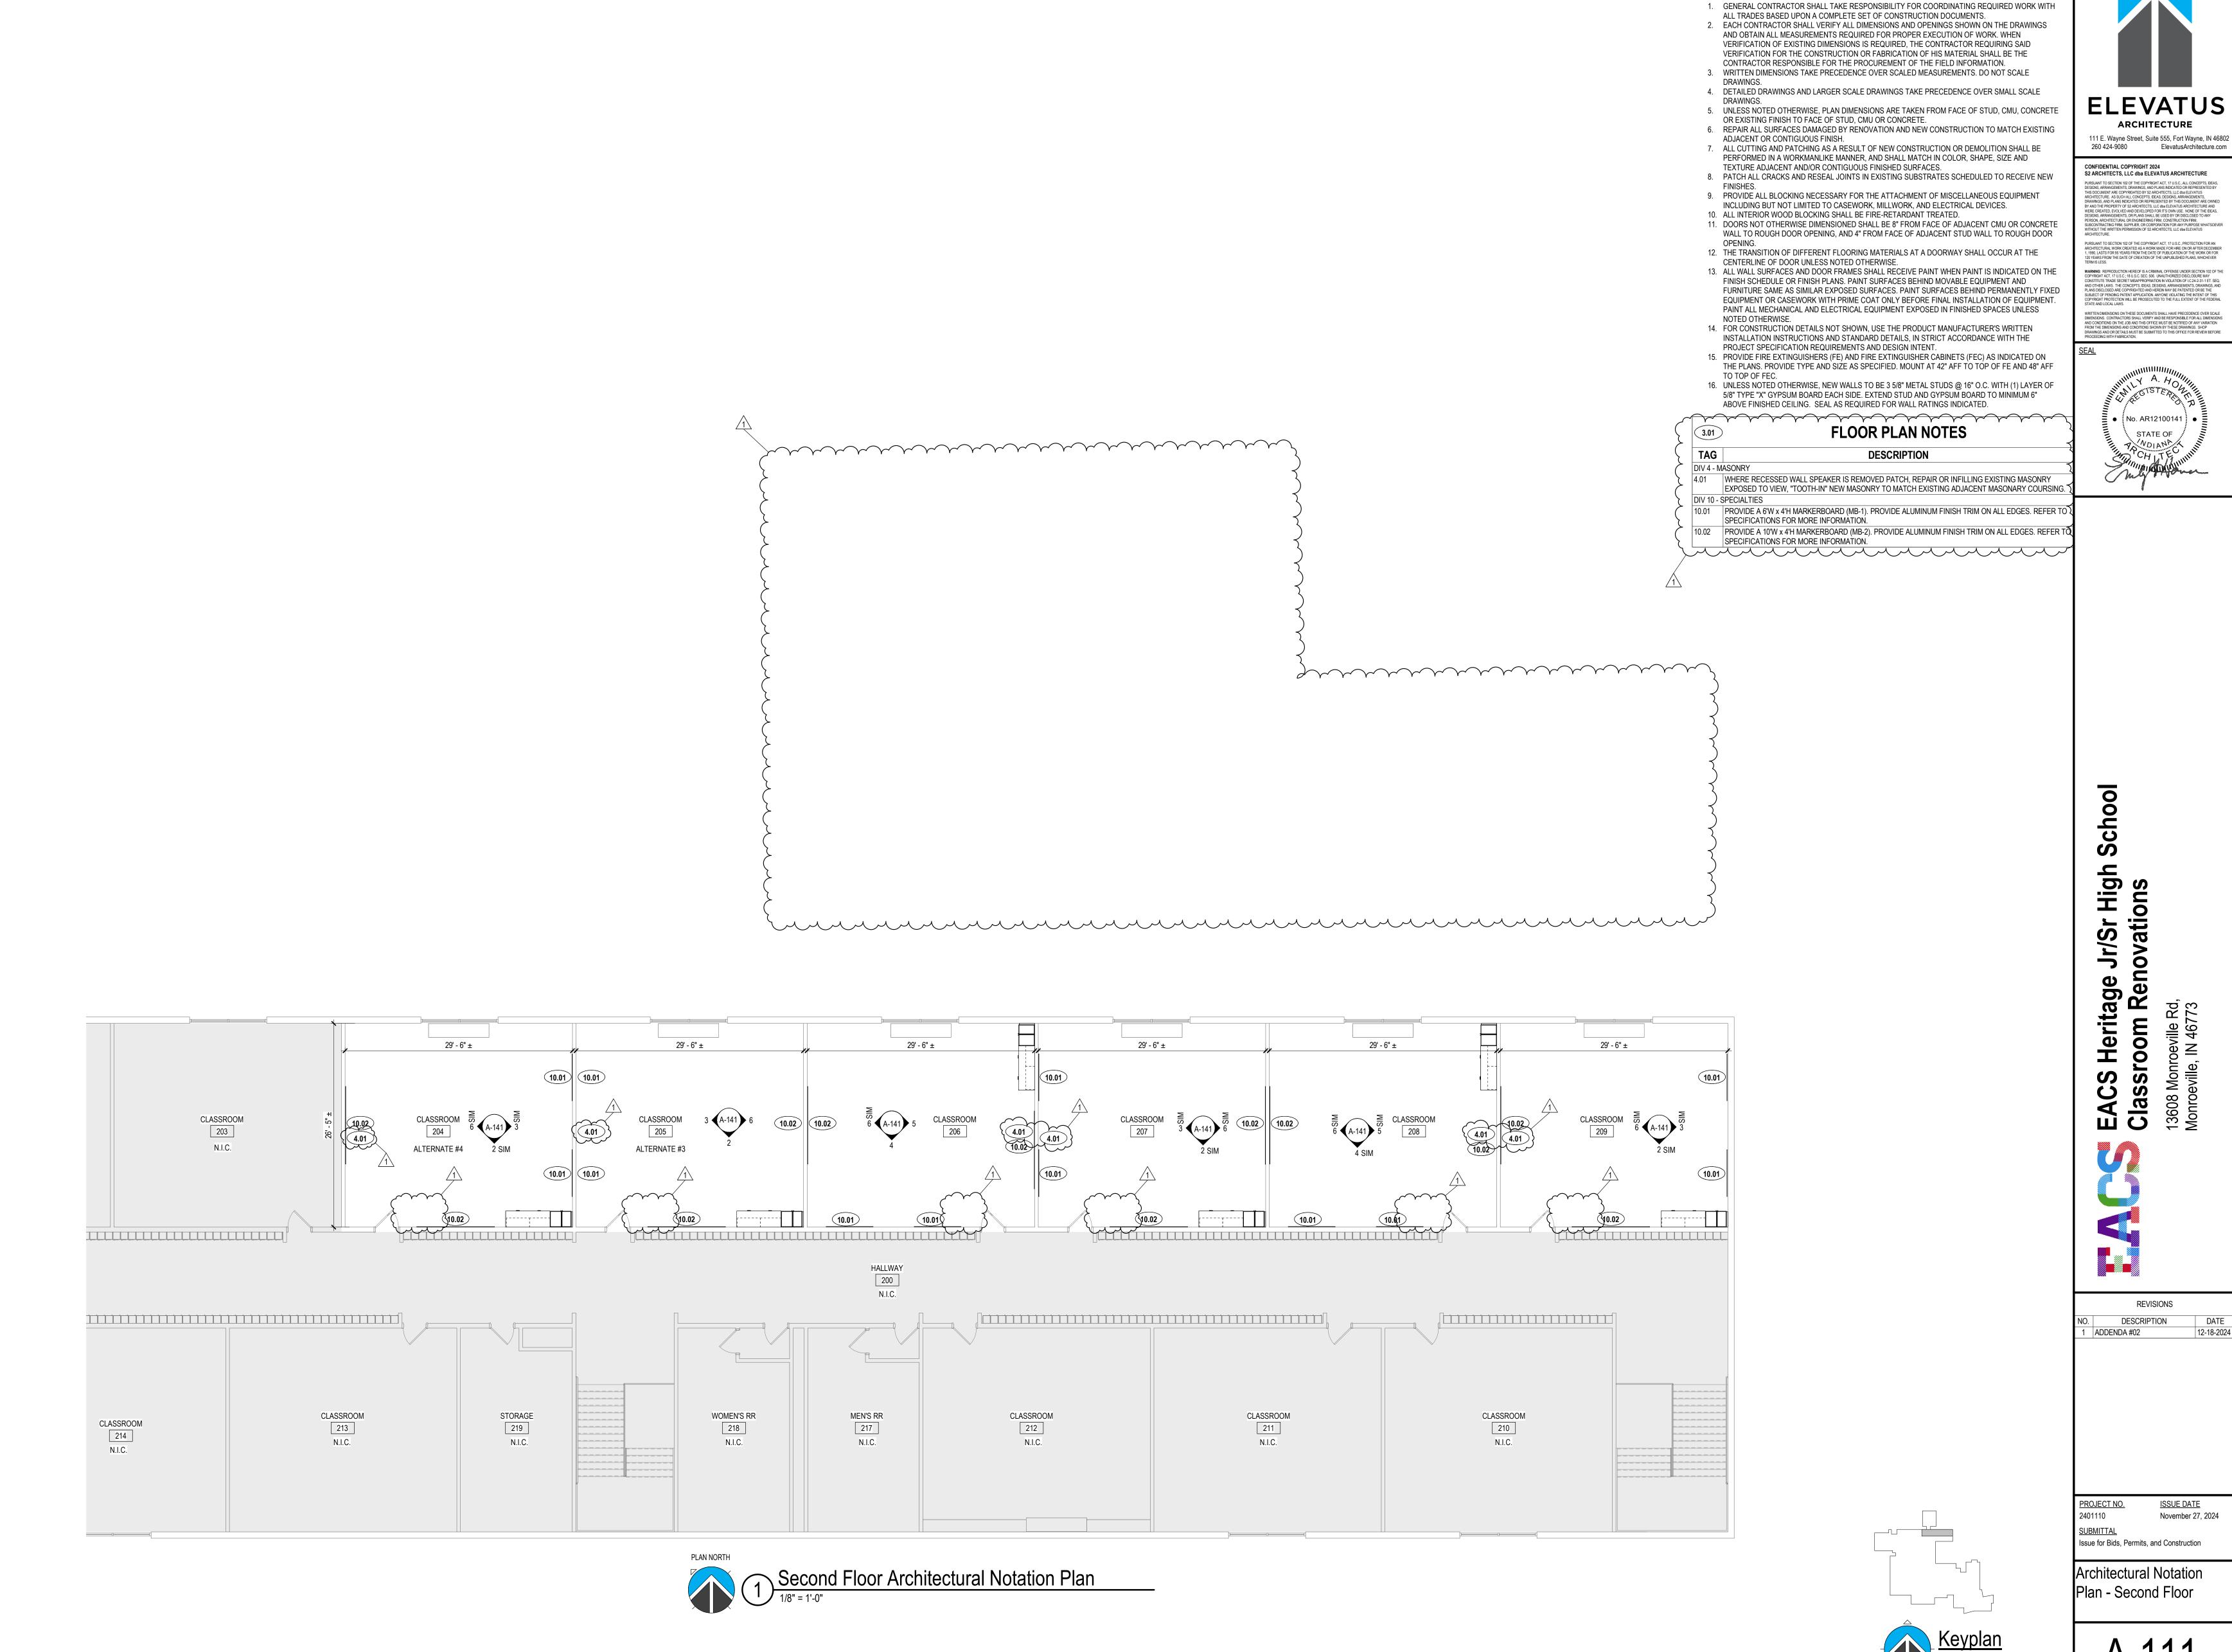
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EACS Heritage Jr/Sr High Classroom Renovations

DESCRIPTION ADDENDA #02


Issue for Bids, Permits, and Construction

Plan - Second Floor




FLOOR PLAN GENERAL NOTES

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 FINISH REMOVAL NOTES APPLY TO PARTITIONS/WALLS THAT REMAIN. REMOVE ALL FINISHES FROM
- WALLS THAT REMAIN WITHIN THE LIMIT OF CONSTRUCTION, UNLESS NOTED OTHERWISE.
 4. REMOVE INTERIOR WALLS/PARTITIONS ENTIRELY FROM DECK ABOVE TO DECK BELOW.
 5. WHERE WALLS, PARTITIONS, FLOORING, ACCESSORIES OR OTHER TYPES OF CONSTRUCTION ARE REMOVED, PATCH AND REPAIR ADJACENT AREAS AS REQUIRED TO RECEIVE NEW CONSTRUCTION OR FINISHES AND TO MATCH ADJACENT SURFACES. MAINTAIN ALL EXISTING AND REQUIRED FIRE RATED CONSTRUCTION THROUGHOUT.
- 6. WHERE NEW FLOOR FINISHES ARE SCHEDULED OR INDICATED, REMOVE ALL EXISTING FLOOR FINISHES AND PREPARE & CLEAN SLAB TO RECEIVE NEW FLOOR FINISHES IN ACCORDANCE WITH THE NEW FLOOR FINISH MANUFACTURERS' WRITTEN RECOMMENDATIONS UNLESS NOTED OTHERWISE. PROPER PREPARATION OF EXISTING SURFACES SHALL INCLUDE, BUT NOT BE LIMITED TO, REMOVAL OF ACCUMULATED ADHESIVES & MASTICS, FILLING AND REPAIR OF CRACKS & VOIDS, SURFACE RESTORATION, THOROUGH CLEANING, ETC. & OTHER PROCEDURES AS MAY BE RECOMMENDED BY MANUFACTURER OF NEW FLOORING.
- 7. UNLESS NOTED OTHERWISE, REMOVE ALL EXISTING ACCESSORIES & HARDWARE. PATCH & REPAIR ALL SURFACES TO RECEIVE NEW FINISHES.
- 8. OFFER REMOVED ITEMS TO OWNER BEFORE REMOVAL FROM THE SITE. DETERMINE SALVAGE ITEMS WITH THE OWNER BEFORE DEMOLITION BEGINS. ALL ITEMS NOT DESIRED BY OWNER SHALL BECOME PROPERTY OF THE CONTRACTOR AND SHALL BE LEGALLY DISPOSED OF OFF SITE.
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 9. PROTECT ALL ITEMS TO REMAIN AND REPAIR/REPLACE ANY DAMAGED ITEMS OR CONSTRUCTION.

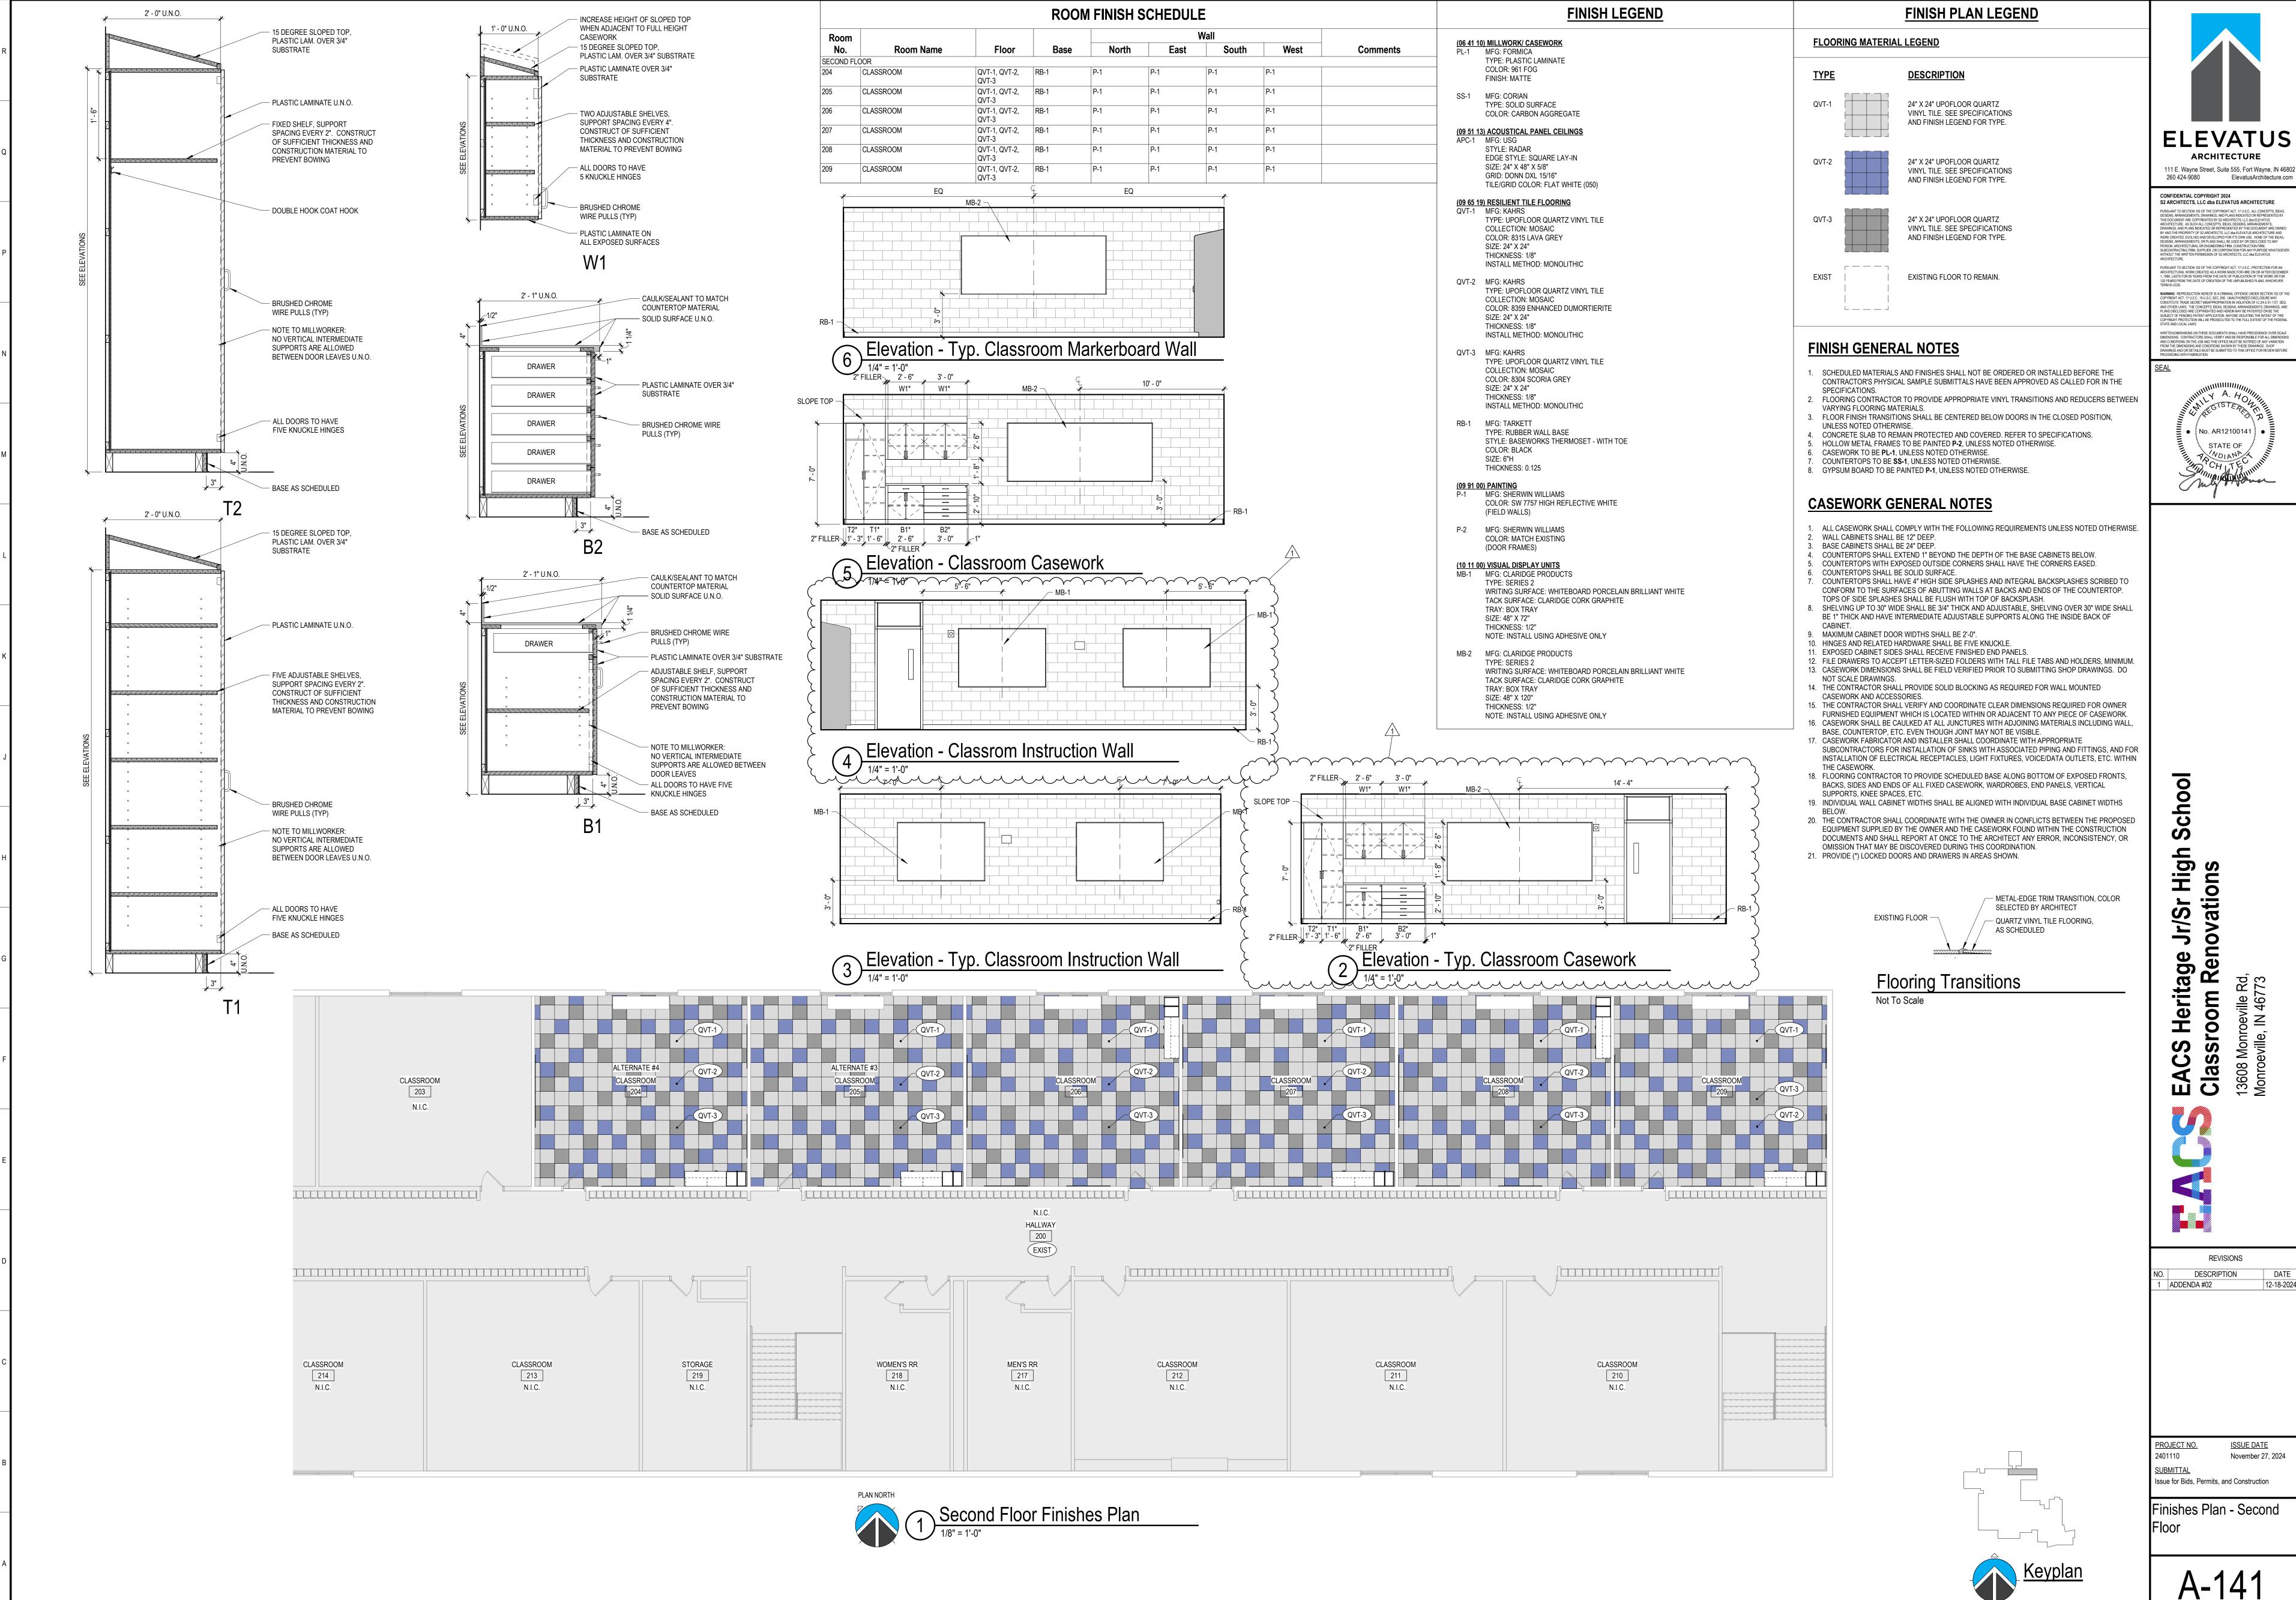 10. GENERAL CONTRACTOR IS RESPONSIBLE FOR COORDINATING THE WORK WITH OTHER TRADES.
- CONTRACTOR SHALL PROVIDE TEMPORARY SHORING AS NECESSARY TO COMPLETE THE WORK.
 CAP AND REROUTE EXISTING UTILITY SERVICES LOCATED IN WALLS, CEILINGS, OR FLOORS TO BE REMOVED, AS REQUIRED FOR NEW CONDITIONS AND IN ACCORDANCE WITH APPLICABLE CODES.
 SEE ENGINEERING DRAWINGS FOR ADDITIONAL INFORMATION.
- HOLES LEFT IN CONCRETE FLOORS FROM REMOVED ITEMS SHALL BE PATCHED BY GENERAL CONTRACTOR.
- 14. REFER TO ENGINEERING DRAWINGS FOR RELATED WORK AND ITEMS TO BE REMOVED OR RE-INSTALLED IN NEW CONSTRUCTION. COORDINATE TEMPORARY LIGHTING, COMMUNICATION AND
- MECHANICAL SYSTEMS WITH OTHER TRADES. MAINTAIN ALL LIFE SAFETY DEVICES.

 15. REMOVE ABANDONED UTILITY SERVICES, SUCH AS ELECTRICAL, PLUMBING, GAS LINES, AND MECHANICAL DUCTWORK, DISCOVERED AND NOT SCHEDULED FOR REUSE BACK TO THEIR SOURCE (INCLUDING ALL HANGARS, STRAPS, WIRES, ETC.). MAINTAIN ANY SYSTEM SERVICING ADJACENT BUILDING AND THE CONTRACT; REROUTE AS REQUIRED. SEE
- ENGINEERING DRAWINGS FOR ADDITIONAL INFORMATION.

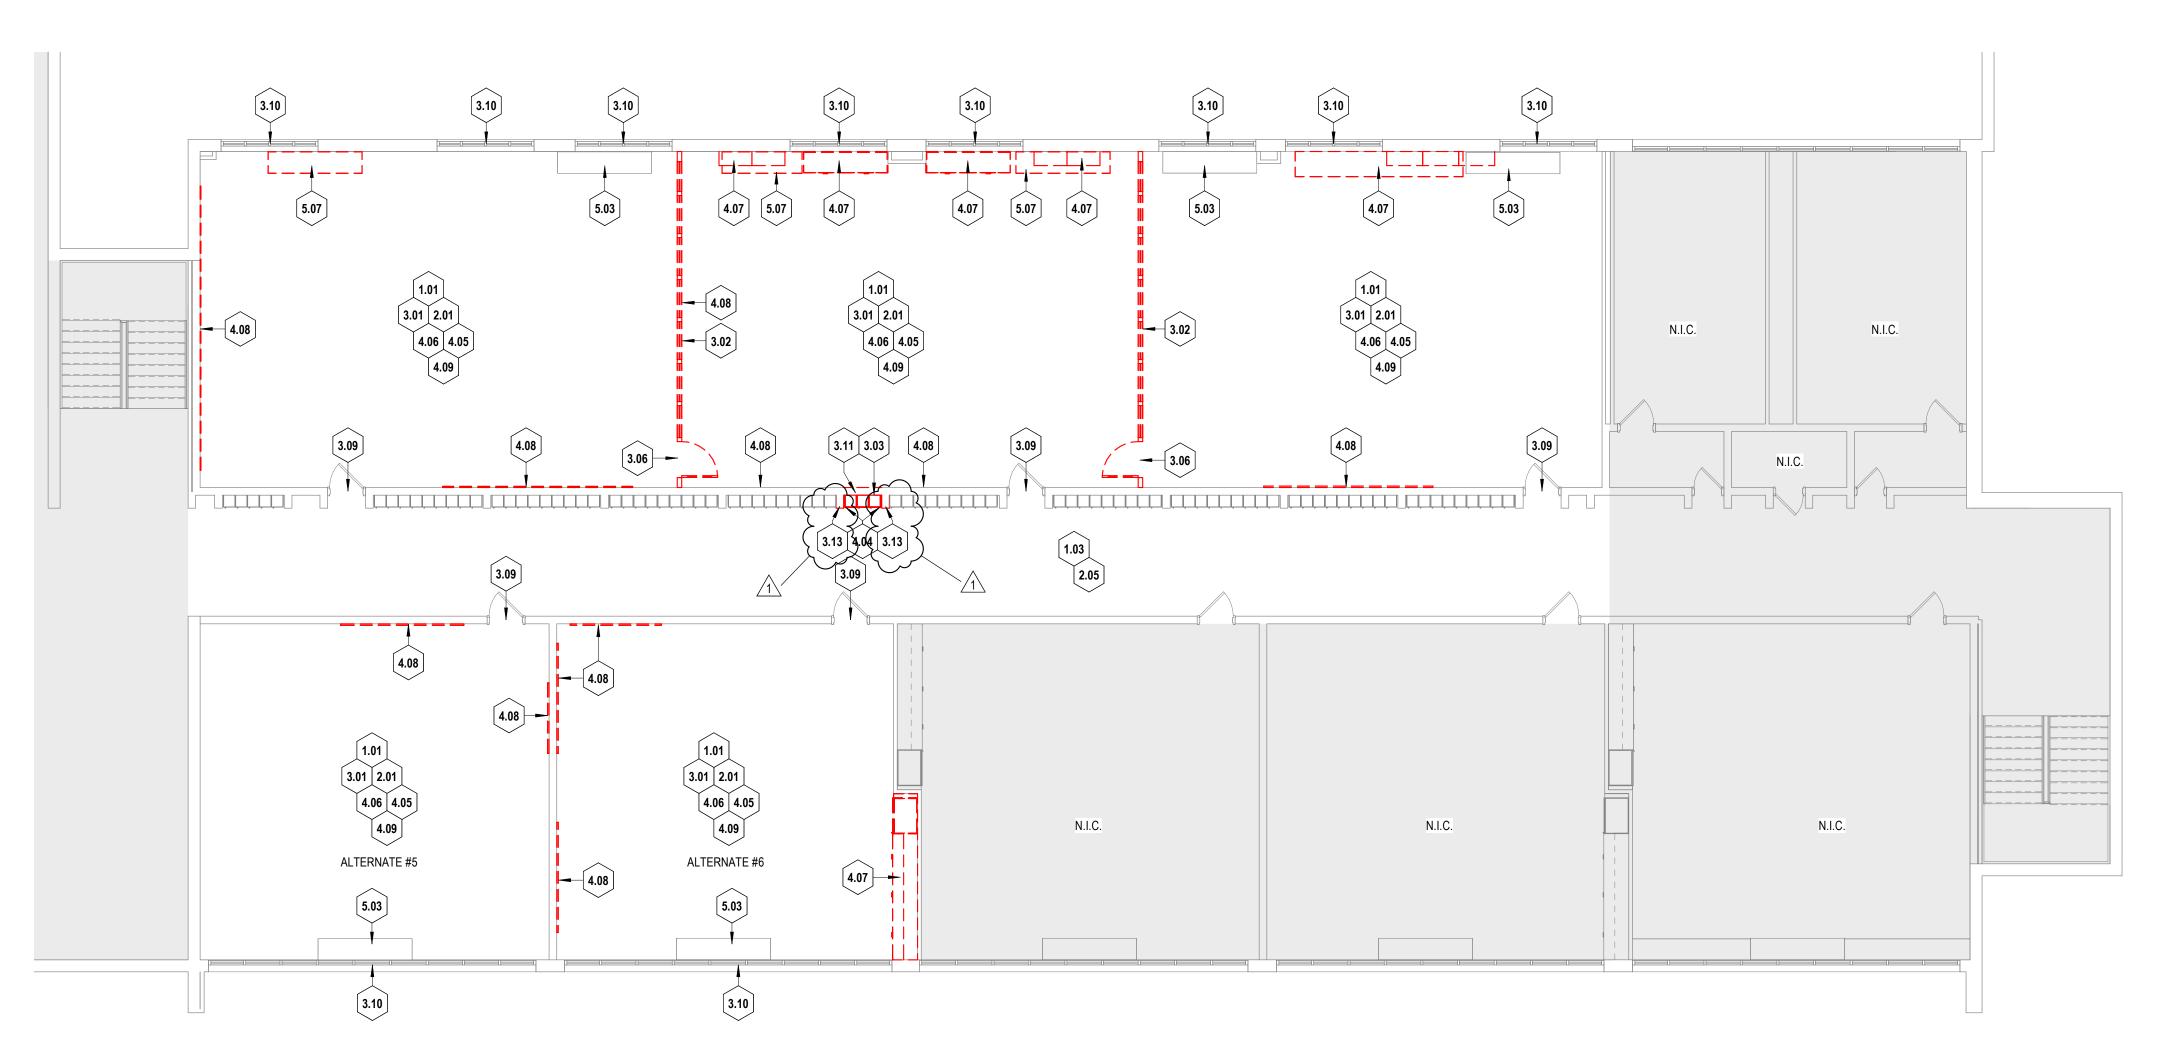 16. PROVIDE ALL NECESSARY DEMOLITION OF EXISTING CONSTRUCTION FOR NEW UTILITY SERVICES AS REQUIRED.

TAG DESCRIPTION

CEILING DEMOLITION

1.01 REMOVE ACOUSTICAL LAY-IN CEILING SYSTEM: PANELS,GRID AND ALL RELATED HANGERS AND

1.03 ACOUSTICAL LAY-IN CEILING SYSTEM TO REMAIN. PROTECT DURING CONSTRUCTION. REPAIR ALL DAMAGED AREAS AT CONCLUSION OF THE WORK.

FLOORING DEMOLITION

2.01 REMOVE VINYL COMPOSITION TILE FLOORING AND ALL RELATED MASTIC/ADHESIVE. CLEAN/PREP SUBFLOOR TO ACCEPT NEW FLOORING AS SCHEDULED.

2.05 FLOOR FINISH TO REMAIN PROTECT FLOORING DURING CONSTRUCTION, REPLACE DAMAGED FLOOR

2.05 FLOOR FINISH TO REMAIN. PROTECT FLOORING DURING CONSTRUCTION. REPLACE DAMAGED FLOORING (MATCH EXISTING) AT CONCLUSION OF THE WORK.

PARTITION DEMOLITION

3.01 REMOVE RESILIENT WALL BASE. PATCH/REPAIR WALL SURFACE TO ACCEPT NEW FINISHES AS

SCHEDULED.

3.02 REMOVE PARTITION IN ITS ENTIRETY, INCLUDING INTERIOR WINDOWS AND WALL BASE. VERIFY

STRUCTURAL INTEGRITY OF PARTITION PRIOR TO REMOVAL.

3.03 REMOVE VINYL WALL COVERING ABOVE DOOR. PATCH/REPAIR WALL SURFACE TO ACCEPT NEW

3.03 REMOVE VINYL WALL COVERING ABOVE DOOR. PATCH/REPAIR WALL SURFACE TO ACCEPT NEV FINISHES AS SCHEDULED.

3.06 REMOVE DOOR(S) AND FRAME. OFFER DOOR(S) AND HARDWARE TO OWNER BEFORE DISPOSING.

3.09 DOOR(S) AND FRAME TO REMAIN. PROTECT DURING CONSTRUCTION. REPAIR/REPLACE DAMAGED COMPONENTS AT CONCLUSION OF THE WORK.

3.10 WINDOW AND WINDOW SILL TO REMAIN. PROTECT DURING CONSTRUCTION.

3.11 REMOVE PORTION OF WALL/PARTITION FOR INSTALLATION OF NEW OPENING BRACE AS REQUIRED.

3.13 REMOVE PARTITION IN ITS ENTIRETY INCLUDING WALL COVERINGS, WALL BASES, AND ANY DOORS/DOOR FRAMES WITHIN.

EIXTORE DEMONTION

4.04 REMOVE LOCKERS: SALVAGE FOR REINSTALLATION. OFFER TO OWNER BEFORE DISPOSING
 4.05 TECHNOLOGY EQUIPMENT IS TO BE REMOVED BY OWNER.

4.06 REMOVE ALL WINDOW TREATMENTS SUCH AS MINI-BLINDS, CURTAINS, AND RELATED HANGERS. PATCI AND REPAIR ANY HOLES IN WALLS AT CONCLUSION OF WORK TO PREP FOR NEW BLINDS BY OWNER. OFFER TO OWNER BEFORE DISPOSING.

4.07 REMOVE BASE CABINET(S), COUNTERTOP AND WALL CABINET(S). PATCH AND REPAIR ANY HOLES IN WALLS AT CONCLUSION OF WORK. OFFER TO OWNER BEFORE DISPOSING.

4.08 REMOVE TACKBOARDS, TACK STRIPS, MARKERBOARDS, ETC. PATCH AND REPAIR ANY HOLES IN WALLS AT CONCLUSION OF WORK. OFFER TO OWNER BEFORE DISPOSING.

REMOVE ALL REMAINING FURNITURE AND EQUIPMENT IN SPACE. OFFER TO OWNER BEFORE DISPOSINITY DEMOLITION

HUAC LINIT TO REMAIN, PROTECT DURING CONSTRUCTION DEPAID/REDI ACE DAMAGED COMPONENTS.

5.03 HVAC UNIT TO REMAIN. PROTECT DURING CONSTRUCTION REPAIR/REPLACE DAMAGED COMPONENTS AT CONCLUSION OF THE WORK. - SEE MECHANICAL DOCUMENTS FOR MORE INFORMATION.
 5.07 HVAC UNIT TO BE REMOVED. SEE MECHANICAL DOCUMENTS FOR MORE INFORMATION.

ELEVATUS
ARCHITECTURE

111 E. Wayne Street, Suite 555, Fort Wayne, IN 46802

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DRAWINGS AND OR DETAILS MUST BE SUBMITTED TO THIS OFFICE FOR REVEW BEFOR PROCEEDING WITH FABRICATION.

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No. AR12100141

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EACS Woodlan High School
Classroom Renovation

REVISIONS

REVISIONS

DESCRIPTION
ADDENDUM #02


DENDUM #02 12-18-2


PROJECT NO. ISSUE II Novemb


Issue for Bids, Permits, and Construction

Architectural Demolition
Plan - Second Floor

AD101

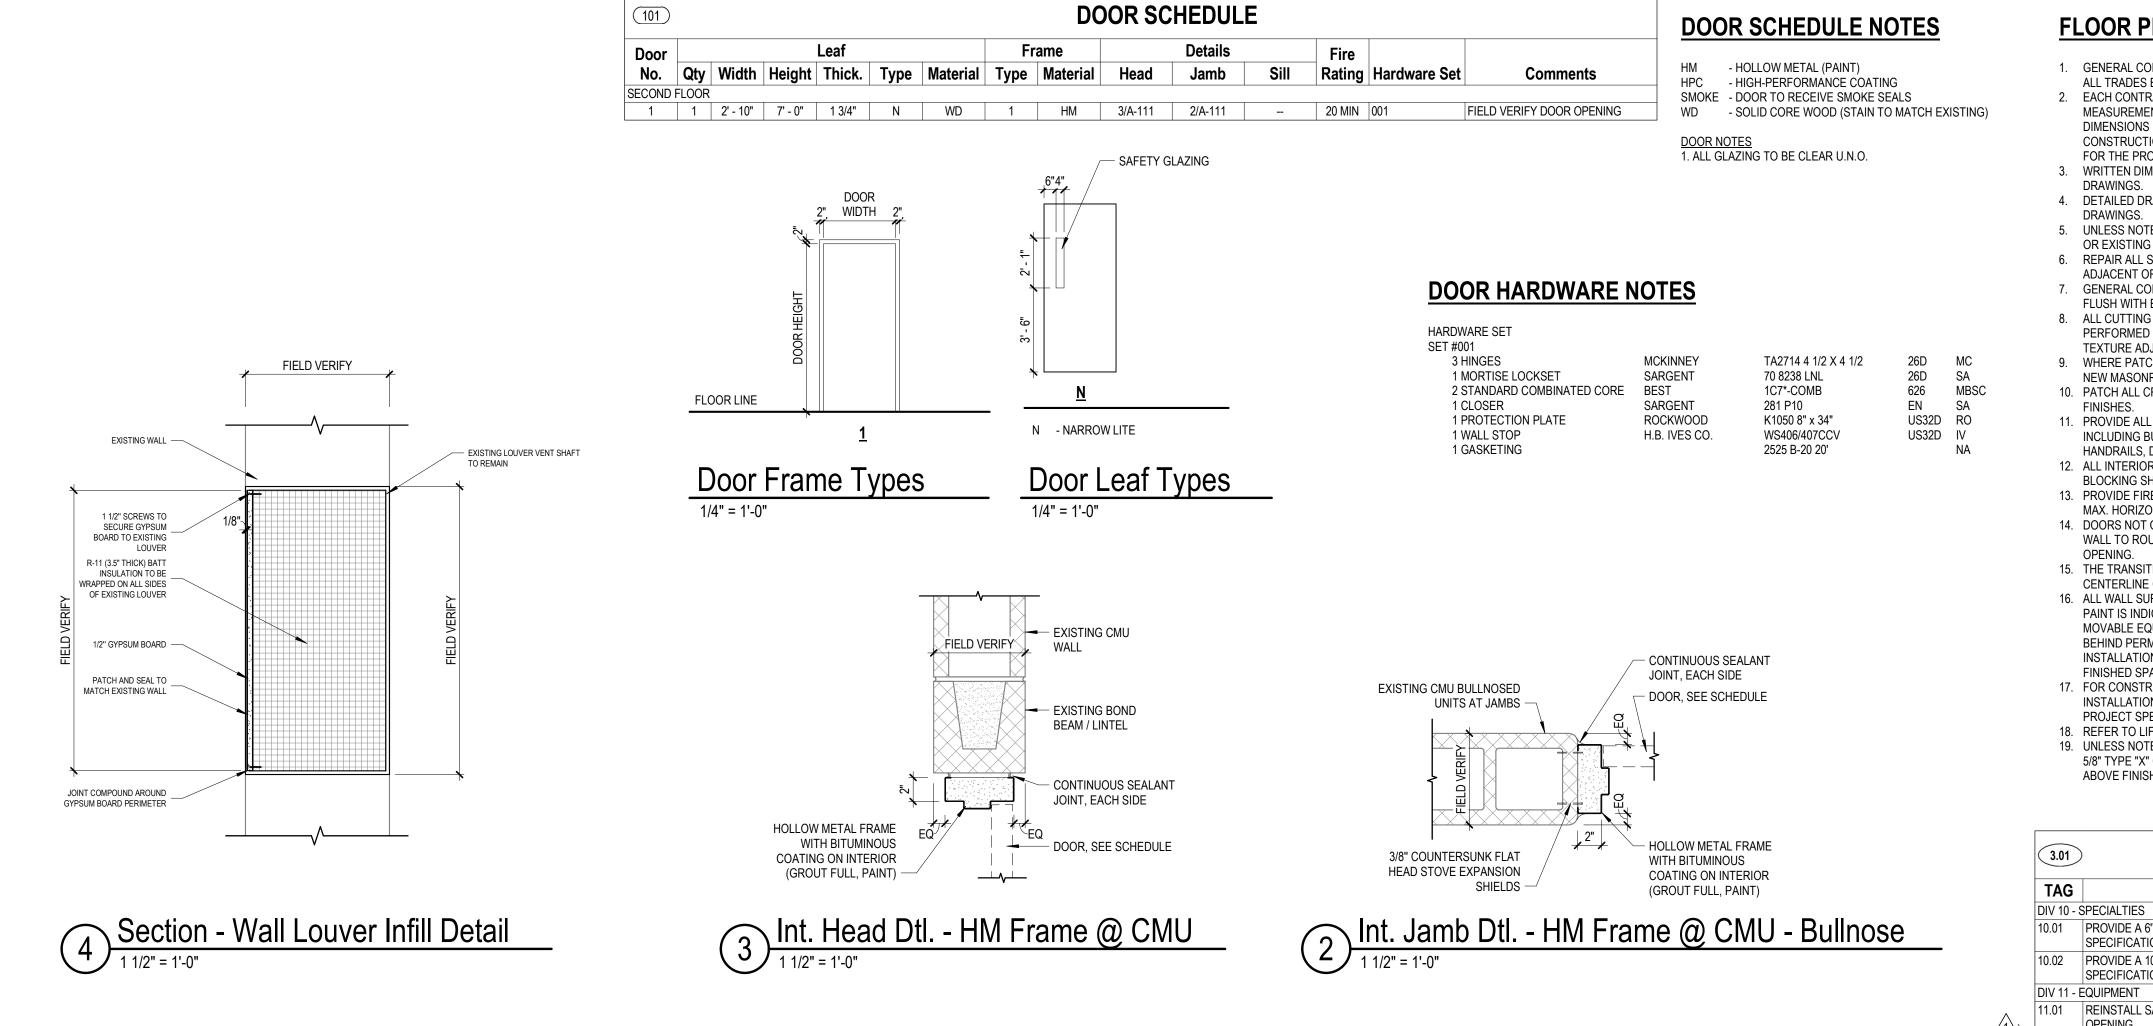

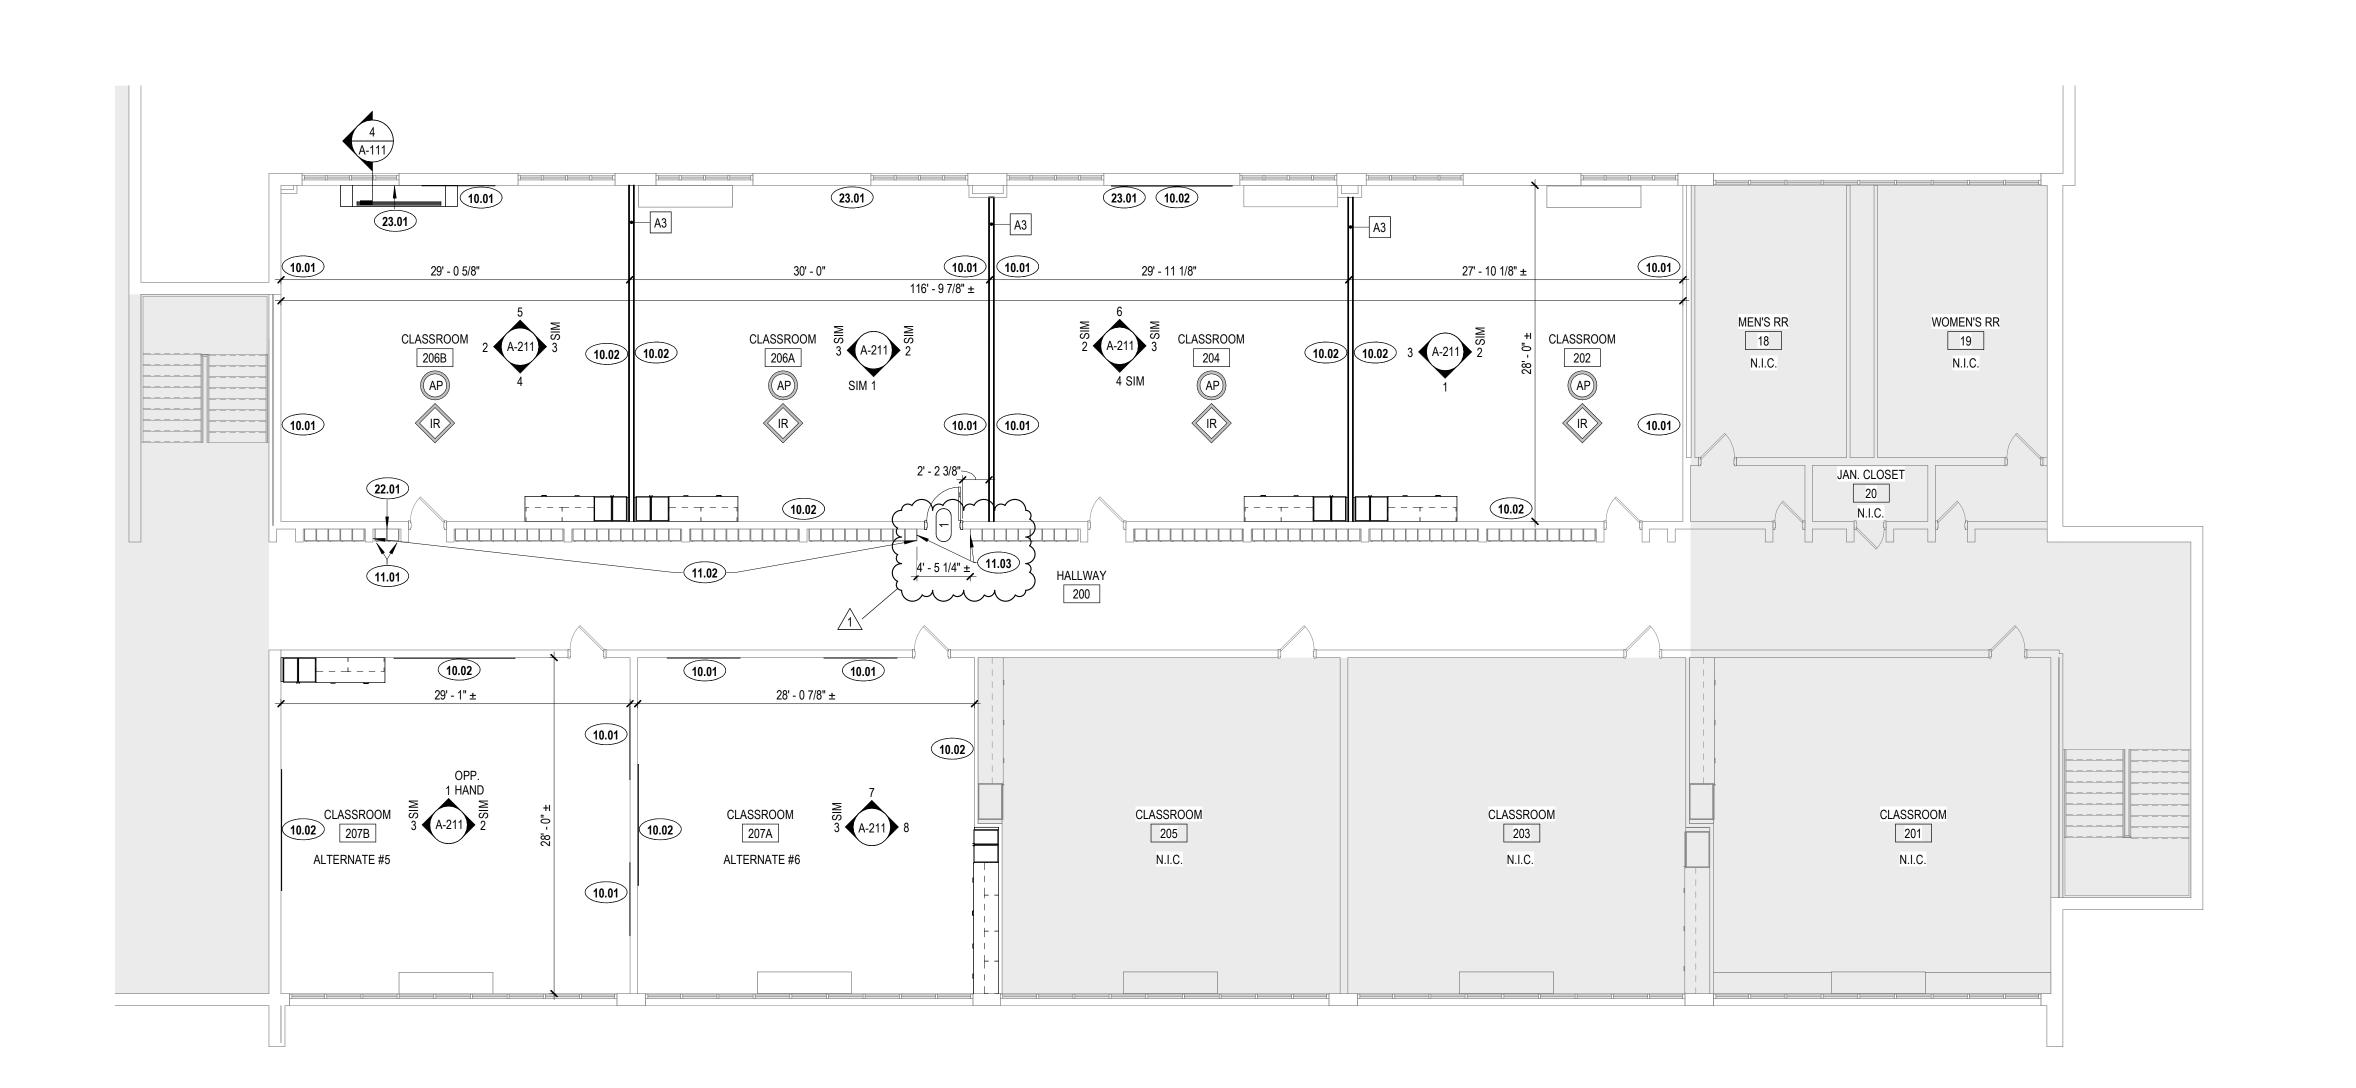

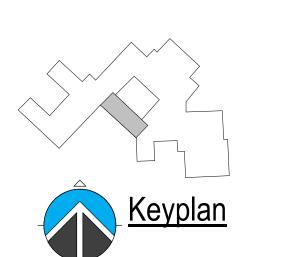



 GENERAL CONTRACTOR SHALL TAKE RESPONSIBILITY FOR COORDINATING REQUIRED WORK WITH ALL TRADES BASED UPON A COMPLETE SET OF CONSTRUCTION DOCUMENTS.
 EACH CONTRACTOR SHALL VERIFY ALL DIMENSIONS SHOWN ON THE DRAWINGS AND OBTAIN ALL MEASUREMENTS REQUIRED FOR PROPER EXECUTION OF WORK. WHEN VERIFICATION OF EXISTING DIMENSIONS IS REQUIRED, THE CONTRACTOR REQUIRING SAID VERIFICATION FOR THE CONSTRUCTION OR FABRICATION OF HIS MATERIAL SHALL BE THE CONTRACTOR RESPONSIBLE

CONSTRUCTION OR FABRICATION OF HIS MATERIAL SHALL BE THE CONTRACTOR RESPONSIBLE FOR THE PROCUREMENT OF THE FIELD INFORMATION.

3. WRITTEN DIMENSIONS TAKE PRECEDENCE OVER SCALED MEASUREMENTS. DO NOT SCALE

WRITTEN DIMENSIONS TAKE PRECEDENCE OVER SCALED MEASUREMENTS. DO NOT SCALE DRAWINGS.
 DETAILED DRAWINGS AND LARGER SCALE DRAWINGS TAKE PRECEDENCE OVER SMALL SCALE

DRAWINGS.

5. UNLESS NOTED OTHERWISE, PLAN DIMENSIONS ARE TAKEN FROM FACE OF STUD, CMU, CONCRETE OR EXISTING FINISH TO FACE OF STUD, CMU OR CONCRETE.

6. REPAIR ALL SURFACES DAMAGED BY RENOVATION AND NEW CONSTRUCTION TO MATCH EXISTING

ADJACENT OR CONTIGUOUS FINISH.

7. GENERAL CONTRACTOR TO PATCH ALL CONCRETE SLAB MECH/ELEC PENETRATIONS. PATCH SLAB FLUSH WITH EXISTING SLAB AND PROVIDE #4 DOWELS INTO EXISTING SLAB AS REQUIRED.

8. ALL CUTTING AND PATCHING AS A RESULT OF NEW CONSTRUCTION OR DEMOLITION SHALL BE PERFORMED IN A WORKMANLIKE MANNER, AND SHALL MATCH IN COLOR, SHAPE, SIZE AND

TEXTURE ADJACENT AND/OR CONTIGUOUS FINISHED SURFACES.

9. WHERE PATCHING, REPAIRING OR INFILLING EXISTING MASONRY EXPOSED TO VIEW, "TOOTH-IN" NEW MASONRY TO ADJACENT EXISTING MASONRY TO REMAIN.

10. PATCH ALL CRACKS AND RESEAL JOINTS IN EXISTING SUBSTRATES SCHEDULED TO RECEIVE NEW

FINISHES.

11. PROVIDE ALL BLOCKING NECESSARY FOR THE ATTACHMENT OF MISCELLANEOUS EQUIPMENT INCLUDING BUT NOT LIMITED TO CASEWORK, MILLWORK, TOILET ACCESSORIES, GRAB BARS,

HANDRAILS, DOOR HARDWARE, ELECTRICAL DEVICES AND LABORATORY EQUIPMENT.

12. ALL INTERIOR WOOD BLOCKING SHALL BE FIRE-RETARDANT TREATED. ALL EXTERIOR WOOD BLOCKING SHALL BE PRESSURE TREATED.

PROVIDE FIRE-BLOCKING AND DRAFT-STOPPING IN COMBUSTIBLE CONCEALED WALLS AT 10'-0" O.C. MAX. HORIZONTALLY & VERTICALLY.
 DOORS NOT OTHERWISE DIMENSIONED SHALL BE 8" FROM FACE OF ADJACENT CMU OR CONCRETE


14. DOORS NOT OTHERWISE DIMENSIONED SHALL BE 8" FROM FACE OF ADJACENT CMU OR CONCRETE WALL TO ROUGH DOOR OPENING, AND 4" FROM FACE OF ADJACENT STUD WALL TO ROUGH DOOR OPENING.

THE TRANSITION OF DIFFERENT FLOORING MATERIALS AT A DOORWAY SHALL OCCUR AT THE CENTERLINE OF DOOR UNLESS NOTED OTHERWISE.
 ALL WALL SURFACES, DOOR FRAMES, BULKHEADS AND CEILINGS SHALL RECEIVE PAINT WHEN PAINT IS INDICATED ON THE FINISH SCHEDULE OR FINISH PLANS. PAINT SURFACES BEHIND MOVABLE EQUIPMENT AND FURNITURE SAME AS SIMILAR EXPOSED SURFACES. PAINT SURFACES BEHIND PERMANENTLY FIXED EQUIPMENT OR FURNITURE WITH PRIME COAT ONLY BEFORE FINAL INSTALLATION OF EQUIPMENT. PAINT ALL MECHANICAL AND ELECTRICAL EQUIPMENT EXPOSED IN

FINISHED SPACES UNLESS NOTED OTHERWISE.

17. FOR CONSTRUCTION DETAILS NOT SHOWN, USE THE PRODUCT MANUFACTURER'S WRITTEN INSTALLATION INSTRUCTIONS AND STANDARD DETAILS, IN STRICT ACCORDANCE WITH THE PROJECT SPECIFICATION REQUIREMENTS AND DESIGN INTENT.

REFER TO LIFE SAFETY PLANS FOR RATED PARTITIONS AND ASSEMBLIES.
 UNLESS NOTED OTHERWISE, NEW WALLS TO BE 3 5/8" METAL STUDS @ 16" O.C. WITH (1) LAYER OF 5/8" TYPE "X" GYPSUM BOARD EACH SIDE. EXTEND STUD AND GYPSUM BOARD TO MINIMUM 6" ABOVE FINISHED CEILING. SEAL AS REQUIRED FOR WALL RATINGS INDICATED.

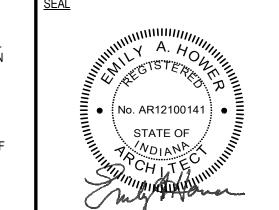

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FLOOR PLAN NOTES

DESCRIPTION

10.01 PROVIDE A 6'W x 4'H MARKERBOARD (MB-1). PROVIDE ALUMINUM FINISH TRIM ON ALL EDGES. REFER TO SPECIFICATIONS FOR MORE INFORMATION.
 10.02 PROVIDE A 10'W x 4'H MARKERBOARD (MB-2). PROVIDE ALUMINUM FINISH TRIM ON ALL EDGES. REFER TO SPECIFICATIONS FOR MORE INFORMATION.

11.01 REINSTALL SALVAGED LOCKERS TO FIT EXISTING OPENING, USE FILLER TO CENTER LOCKERS WITHIN OPENING

11-02 REMOVE AND REINSTALL LOCKER HUMBER PLATES IN HUMBERICAL ORDER.

11.03 PROVIDE METAL LOCKER END CAP FOR EXPOSED LOCKER ENDS AT CONCLUSION OF WORK. MATCH

FINISH TO EXISTING LOCKERS.

BY 22 - PLUMBING

22.01 CAP EXISTING PLUMBING IN WALL.

DIV 23 - HEATING, VENTILATION, AND AIR CONDITIONING

23.01 EXISTING LOUVER TO BE SEALED. SEE DETAIL 4/A-111.

Joo

EACS Woodlan High School
Classroom Renovation
Woodburn Rd,
Woodburn, IN 46797



REVISIONS


. DESCRIPTION
ADDENDUM #02

PROJECT NO. ISSUE DATE
2401110 November 27, 2024

SUBMITTAL
Issue for Bids, Permits, and Construction

Architectural Notation Plan - Second Floor

4-111

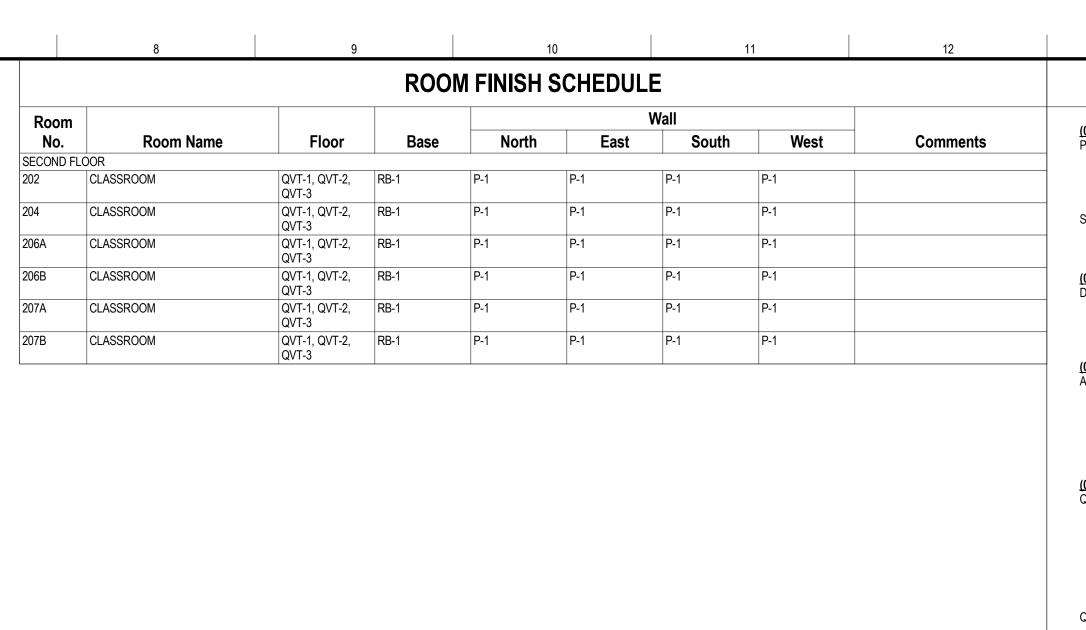

<u>FINISH</u>	LEGEND	

(06 41 10) MILLWORK/ CASEWORK PL-1 MFG: FORMICA TYPE: PLASTIC LAMINATE COLOR: 961 FOG FINISH: MATTE

SS-1 MFG: CORIAN TYPE: SOLID SURFACE COLOR: CARBON AGGREGATE

(08 14 16) WOOD DOORS D-1 MFG: MASONITE ARCHITECTURAL SPECIES: RED OAK **CUT: MATCH EXISTING**

STAIN COLOR: CUSTOM MATCH EXISTING (09 51 13) ACOUSTICAL PANEL CEILINGS APC-1 MFG: USG

STYLE: RADAR EDGE STYLE: SQUARE LAY-IN SIZE: 24" X 48" X 5/8" GRID: DONN DXL 15/16" TILE/GRID COLOR: FLAT WHITE (050)

(09 65 19) RESILIENT TILE FLOORING QVT-1 MFG: KAHRS

TYPE: UPOFLOOR QUARTZ VINYL TILE COLLECTION: MOSAIC COLOR: 8315 LAVA GREY SIZE: 24" X 24" THICKNESS: 1/8" INSTALL METHOD: MONOLITHIC

QVT-2 MFG: KAHRS TYPE: UPOFLOOR QUARTZ VINYL TILE COLLECTION: MOSAIC COLOR: 8359 ENHANCED DUMORTIERITE SIZE: 24" X 24" THICKNESS: 1/8" INSTALL METHOD: MONOLITHIC

QVT-3 MFG: KAHRS TYPE: UPOFLOOR QUARTZ VINYL TILE COLLECTION: MOSAIC COLOR: 8304 SCORIA GREY SIZE: 24" X 24" THICKNESS: 1/8" INSTALL METHOD: MONOLITHIC

RB-1 MFG: TARKETT TYPE: RUBBER WALL BASE STYLE: BASEWORKS THERMOSET - WITH TOE COLOR: BLACK SIZE: 6"H THICKNESS: 0.125

(09 91 00) PAINTING P-1 MFG: SHERWIN WILLIAMS COLOR: SW 7757 HIGH REFLECTIVE WHITE

(FIELD WALLS)

P-2 MFG: SHERWIN WILLIAMS COLOR: MATCH EXISTING (DOOR FRAMES)

(10 11 00) VISUAL DISPLAY UNITS MB-1 MFG: CLARIDGE PRODUCTS

> TYPE: SERIES 2 WRITING SURFACE: WHITEBOARD PORCELAIN BRILLIANT WHITE TACK SURFACE: CLARIDGE CORK GRAPHITE SIZE: 48" X 72"

THICKNESS: 1/2" NOTE: INSTALL USING ADHESIVE ONLY

NOTE: INSTALL USING ADHESIVE ONLY

THICKNESS: 1/2"

MB-2 MFG: CLARIDGE PRODUCTS TYPE: SERIES 2 WRITING SURFACE: WHITEBOARD PORCELAIN BRILLIANT WHITE TACK SURFACE: CLARIDGE CORK GRAPHITE TRAY: BOX TRAY SIZE: 48" X 120"

FINISH PLAN LEGEND

FLOORING MATERIAL LEGEND

TYPE DESCRIPTION QVT-1 24" X 24" UPOFLOOR QUARTZ VINYL TILE. SEE SPECIFICATIONS AND FINISH LEGEND FOR TYPE.



QVT-3 24" X 24" UPOFLOOR QUARTZ VINYL TILE. SEE SPECIFICATIONS




FINISH GENERAL NOTES

1. SCHEDULED MATERIALS AND FINISHES SHALL NOT BE ORDERED OR INSTALLED BEFORE THE CONTRACTOR'S PHYSICAL SAMPLE SUBMITTALS HAVE BEEN APPROVED AS CALLED FOR IN THE

- SPECIFICATIONS. 2. FLOORING CONTRACTOR TO PROVIDE APPROPRIATE VINYL TRANSITIONS AND REDUCERS BETWEEN VARYING FLOORING MATERIALS. 3. FLOOR FINISH TRANSITIONS SHALL BE CENTERED BELOW DOORS IN THE CLOSED POSITION,
- UNLESS NOTED OTHERWISE. 4. CONCRETE SLAB TO REMAIN PROTECTED AND COVERED. REFER TO SPECIFICATIONS. 5. DOORS TO BE MASONITE, **MATCH EXISTING**
- 6. HOLLOW METAL FRAMES TO BE PAINTED P-2, UNLESS NOTED OTHERWISE. 7. CASEWORK TO BE **PL-1**, UNLESS NOTED OTHERWISE.

8. COUNTERTOPS TO BE **\$\$-1**, UNLESS NOTED OTHERWISE.



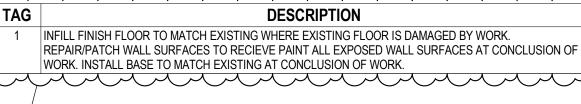

SELECTED BY ARCHITECT EXISTING FLOOR — QUARTZ VINYL TILE FLOORING, AS SCHEDULED

— METAL-EDGE TRIM TRANSITION, COLOR

Flooring Transitions

Not To Scale



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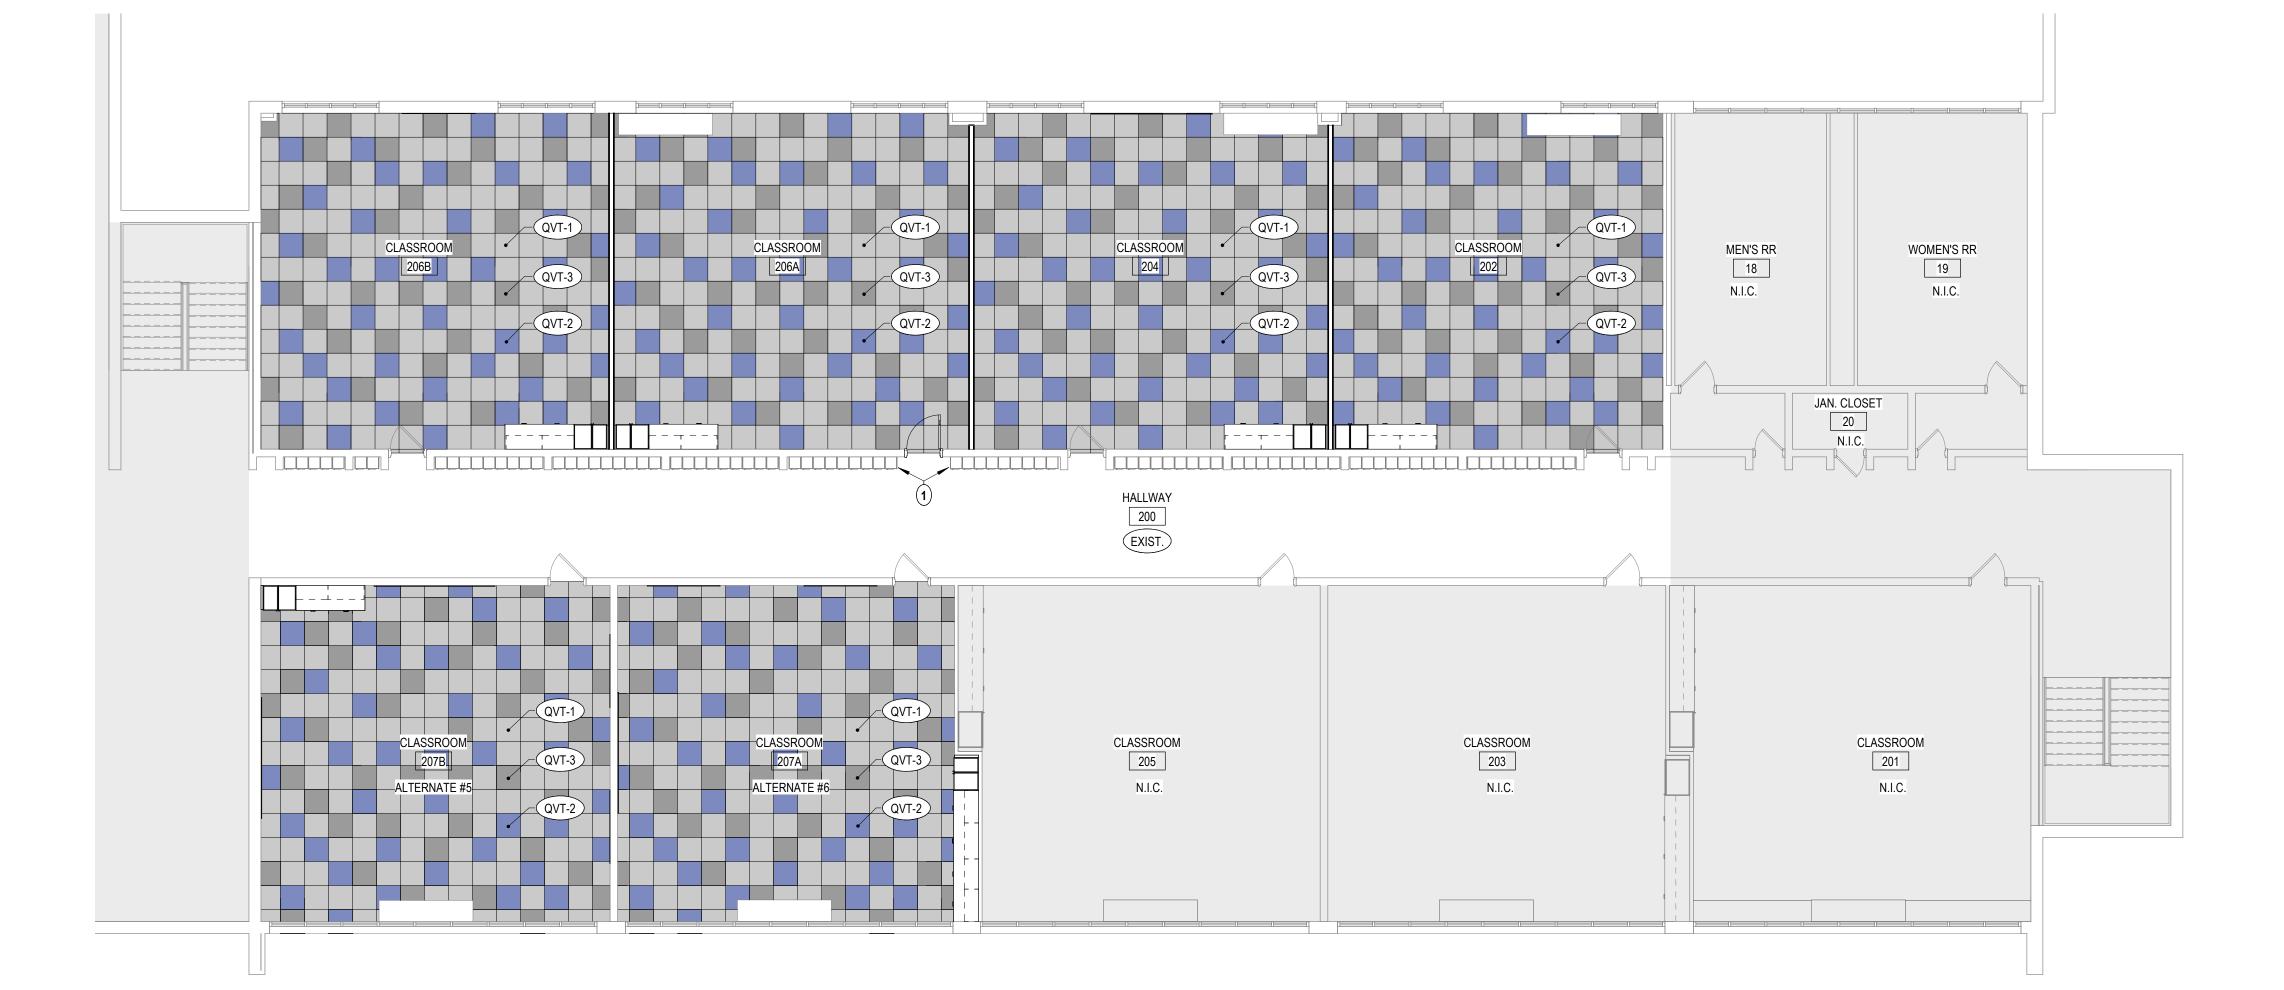
REVISIONS

DESCRIPTION ADDENDUM #02


November 27, 2024


Issue for Bids, Permits, and Construction

Finishes Plan - Second





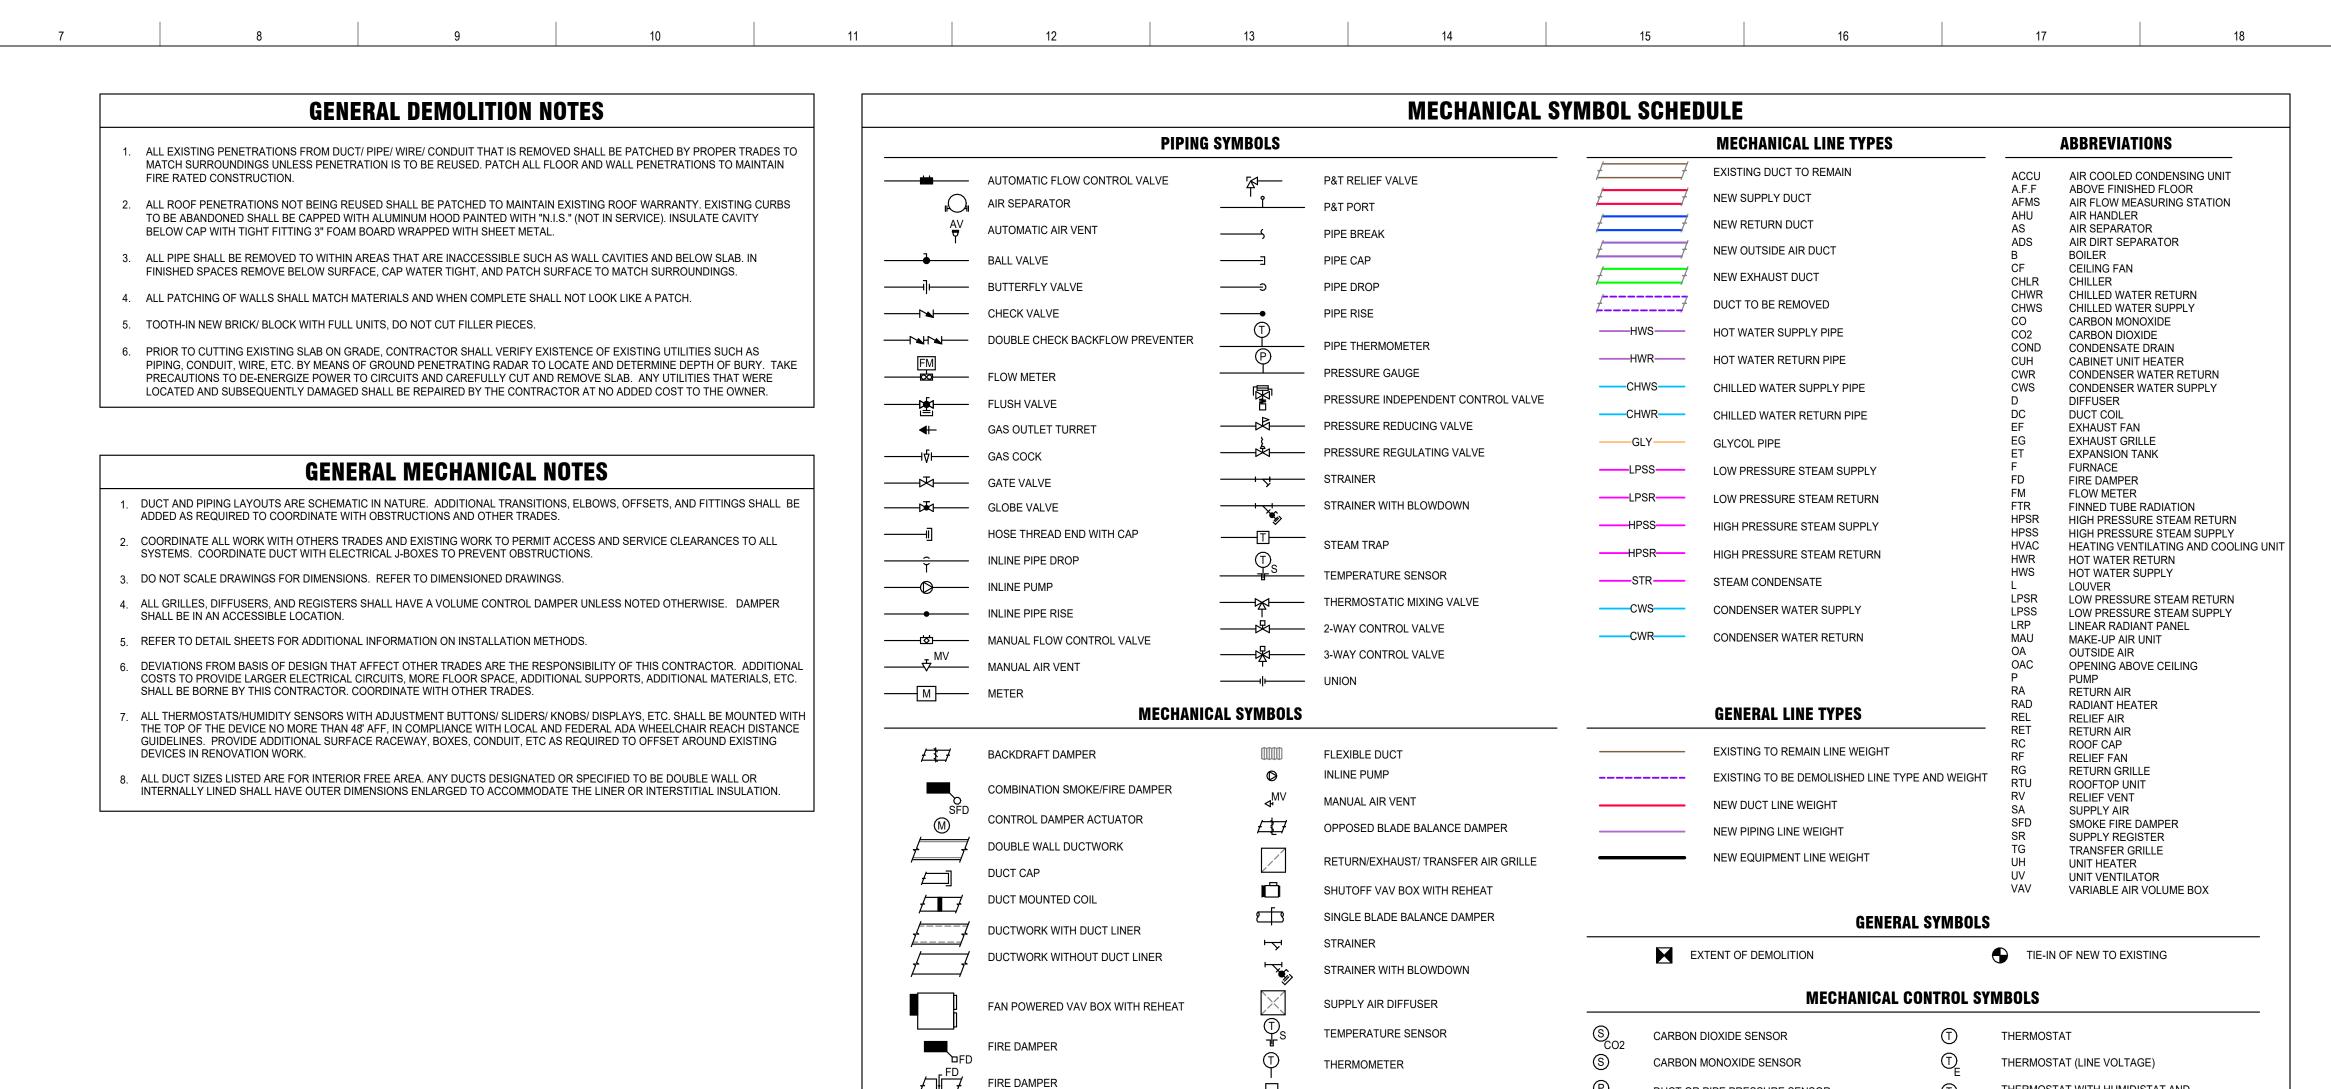

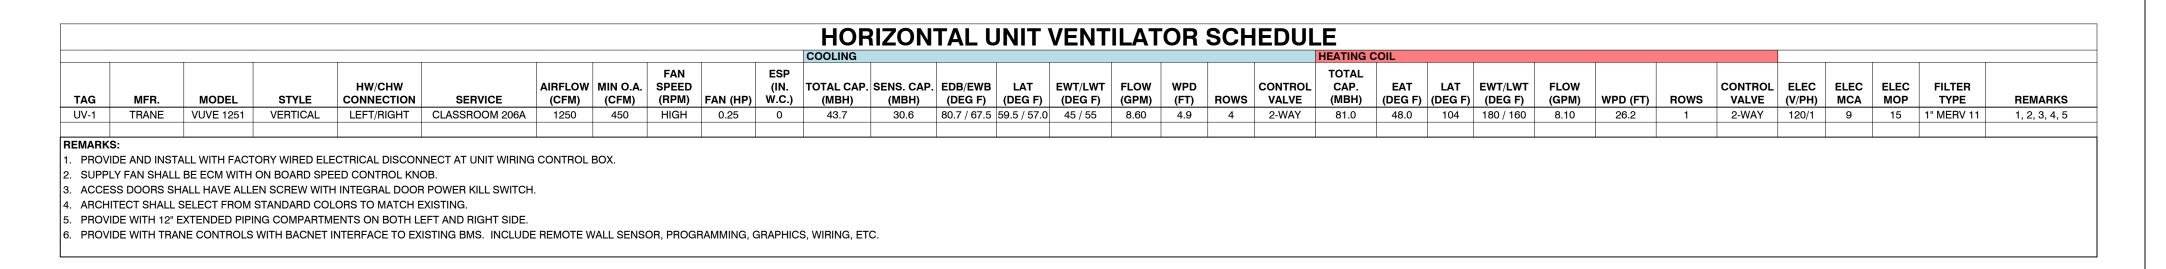


TYPICAL EQUIPMENT TAG DETAIL

SCALE: NTS

UNIT HEATER

WALL MOUNTED PRESSURE GAUGE

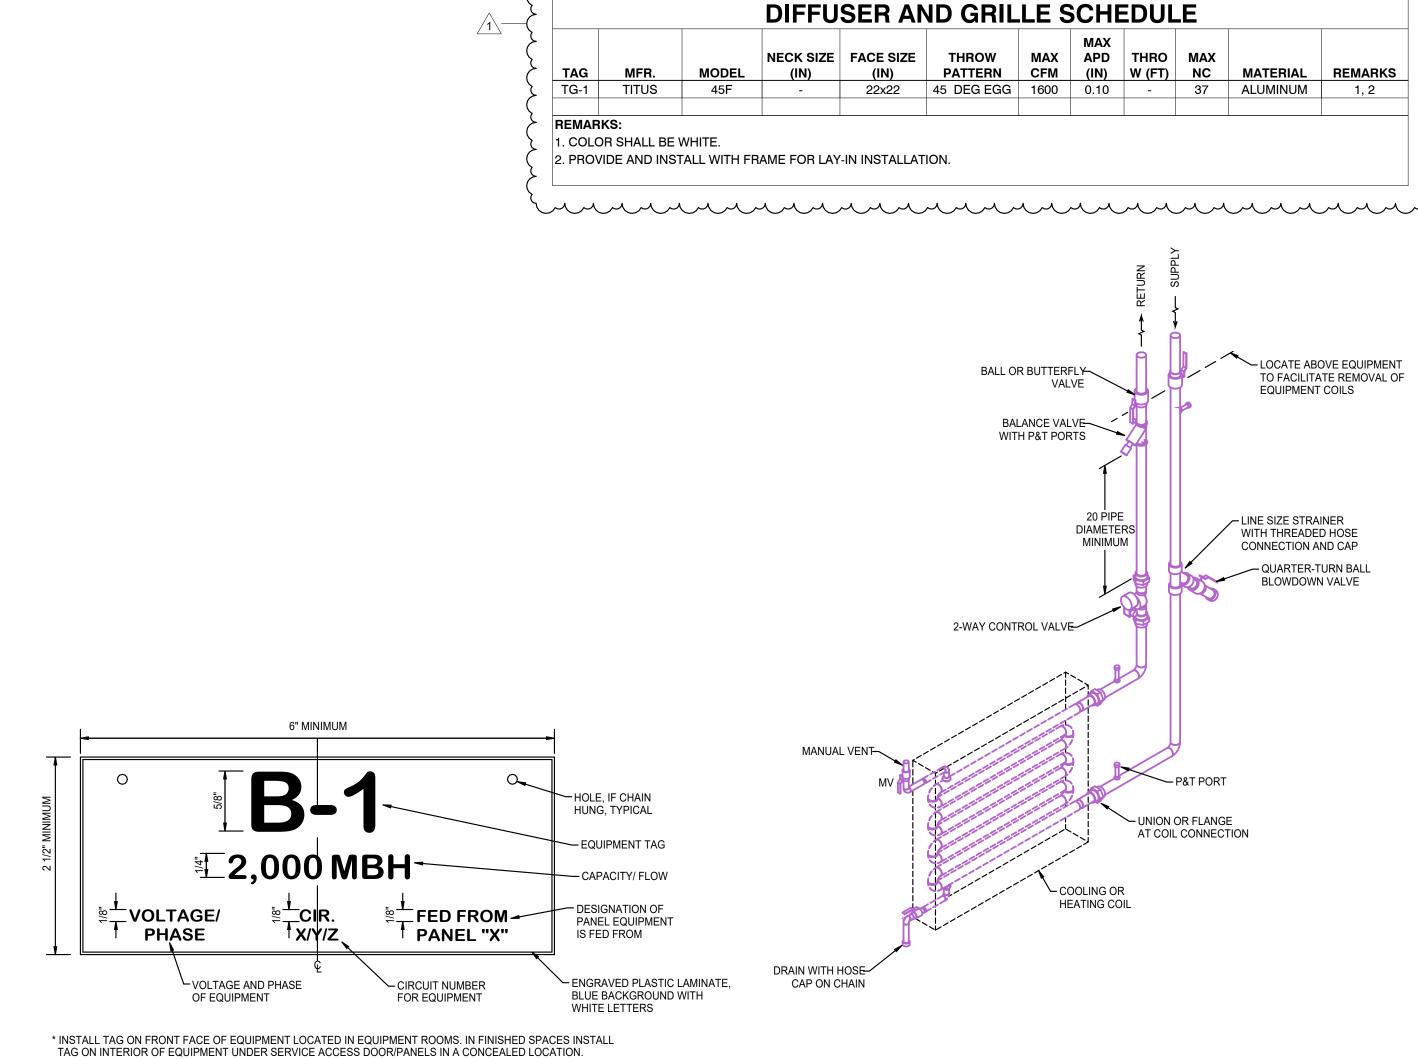

DUCT OR PIPE PRESSURE SENSOR

SECURITY TYPE THERMOSTAT

PNEUMATIC THERMOSTAT

THERMOSTAT WITH HUMIDISTAT AND

DIFFERENTIAL PRESSURE SENSOR

CO2 SENSOR

HUMIDISTAT

UNIT VENTILATOR/ FAN COIL 2-WAY COOLING/ HEATING COIL PIPING DETAIL SCALE: NTS (VALVE FAILS FULL FLOW TO COIL)



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REVISIONS DESCRIPTION ADDENDUM #2 12/18/24

<u>ISSUE DATE</u> November 27, 2024

SUBMITTAL Issue for Bids, Permits, and Construction

MECHANICAL **INFORMATION SHEET**

PRIMARY JOB # 24667 Rvt 23

IF THE WHEEL PRINTED BELOW IS PRINTED BELOW IS

NOT SHOWN IN

COLOR, THIS SET OF
PRINTS IS NOT
REPRESENTING ALL
LINE TYPES
CORRECTLY. CONTAC
PRIMARY
ENGINEERING FOR DIRECTIONS ON HON TO OBTAIN A FULL



SCALE: 3/4" = 1'-0"

IF THE WHEEL
PRINTED BELOW IS
NOT SHOWN IN
COLOR, THIS SET OF
PRINTS IS NOT
REPRESENTING ALL
LINE TYPES
CORRECTLY. CONTACT
PRIMARY
ENGINEERING FOR
DIRECTIONS ON HOW
TO OBTAIN A FULL
COLOR SET OF PRINTS

ELEVATUS ARCHITECTURE

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DESCRIPTION

1 ADDENDUM #2

November 27, 2024

SUBMITTAL

Issue for Bids, Permits, and Construction

SECOND FLOOR MECHANICAL PLAN

PRIMARY JOB # 24667 Rvt 23

GENERAL ELECTRICAL NOTES	LINE TYPE SCHEDULE		
REFER TO ARCHITECTURAL PLANS FOR DIMENSIONS.	— - — - — - — - — UNDERGROUND COMMUNICATION, LINE TYPE AND WEIGHT		
2. DIMENSIONS SHOWN ON OUTLET BOXES AND DEVICES SHALL BE TO THE BOTTOM OF THE BOX.	UNDERGROUND BRANCH CIRCUIT, LINE TYPE AND WEIGHT		
3. CONDUIT SHOWN TO LIGHT FIXTURES IS SHOWN TO INDICATE SWITCHING AND DOES NOT REPRESENT THE QUANTITY	NEW POWER LINE WEIGHT		
OR EXACT LOCATION OF WIRING AND/OR CONDUIT.			
4. COORDINATE LOCATION OF LIGHT FIXTURES IN AREAS OF MECHANICAL DUCTWORK AND PIPING WITH MECHANICAL CONTRACTOR. RELOCATE LIGHT FIXTURES, WIRING, AND CONDUIT IF NECESSARY AND AS DIRECTED BY THE			
ARCHITECT/ENGINEER.			
 VERIFY LOCATION OF ALL BACKBOXES IN LABORATORY EQUIPMENT AND BUILT-IN FURNITURE WITH EQUIPMENT SUPPLIER AND INSTALLER PRIOR TO ROUGH-IN. 	NEW EMERGENCY AND FIRE DEVICE LINE WEIGHT		
6. PROVIDE AND INSTALL PLASTER RINGS DRYWALL FRAMING KITS, OR SURFACE MOUNT KITSFOR LIGHT FIXTURES	NEW COMMUNICATION DEVICE LINE WEIGHT		
WHERE REQUIRED BY CEILING CONSTRUCTION. REFER TO ARCHITECTURAL DRAWINGS.	EXISTING TO REMAIN LINE WEIGHT		
7. VERIFY HEIGHT AND LOCATION OF RECEPTACLES BEHIND ELECTRIC WATER COOLERS WITH THE MECHANICAL	EVICTING TO BE DEMOLICHED LINE TYPE AND WEIGHT		

MOUNTING HEIGHT SCHEDULE

SWITCHES - 44" OR AS SPECIFIED ON DRAWINGS.

WALL MOUNTED OCCUPANCY / VACANCY SENSORS - 9'-0" A.F.F. OR AS SPECIFIED ON DRAWINGS.

---- EXISTING TO BE DEMOLISHED LINE TYPE AND WEIGHT

- RECEPTACLES OR CONVENIENCE OUTLETS 16" OR AS SPECIFIED ON DRAWINGS.
- RECEPTACLES OR CONVENIENCE OUTLETS 44" FOR MECHANICAL, ELECTRICAL, JANITOR, SHOP AREAS, GARAGE AREAS STORAGE, AND ELEVATOR EQUIPMENT ROOMSOR AS SPECIFIED ON DRAWINGS.
- EXTERIOR WEATHER PROOF RECEPTACLES OR CONVENIENCE OUTLETS 24" ABOVE GRADE OR AS SPECIFIED ON
- SAFETY SWITCHES 54" OR AS SPECIFIED ON DRAWINGS.
- MOTOR CONTROLLERS 54" OR AS SPECIFIED ON DRAWINGS.
- PANELBOARDS TO TOP 72" OR AS SPECIFIED ON DRAWINGS.
- TELEPHONE OR DATA 16" OR AS SPECIFIED ON DRAWINGS.
- TELEPHONE (PAY WALL HUNG) 44" OR AS SPECIFIED ON DRAWINGS.

REMOVE ALL EXPOSED RACEWAY AND WIRE THAT ARE NO LONGER TO BE USED.

LOCKOUT OR PANIC BUTTONS - 44" OR AS SPECIFIED ON DRAWINGS.

FIRE ALARM PULL STATION - 44" OR AS SPECIFIED ON DRAWINGS.

WITH NEW DEVICES AND COVER PLATES.

FIRE ALARM HORN, HORN/VISUAL, SPEAKER, SPEAKER/VISUAL - 80"-84" OR AS SPECIFIED ON DRAWINGS.

GENERAL ELECTRICAL DEMOLITION NOTES

- BLANK OFF OR REMOVE ALL ABANDONED JUNCTION AND OUTLET BOXES IN WALLS, FLOORS, AND CEILINGS THAT ARE TO
- REMOVE ALL ELECTRICAL OUTLETS, DEVICES, AND RACEWAYS FROM WALL THAT ARE TO BE REMOVED.
- REMOVE ALL FLOOR MOUNTED RACEWAYS.
- ALL EXISTING EQUIPMENT THAT IS TO REMAIN IS INTENDED TO BE OPERATIONAL AT THE COMPLETION OF THE PROJECT. RECIRCUIT WHERE NECESSARY TO INSURE THIS CONTINUED OPERATION.
- OWNER SHALL HAVE FIRST RIGHT OF REFUSAL ON ALL EQUIPMENT THAT IS TO BE REMOVED. ALL EXISTING RECEPTACLES AND LIGHT SWITCHES THAT ARE TO REMAIN WITHIN A REMODELED AREA SHALL BE REPLACED
- THE EXISTING EQUIPMENT SHOWN ON THE DRAWINGS IS BELIEVED TO BE A REASONABLE INDICATION OF THE EXISTING

LAYOUT. EXACT QUANTITY AND LOCATION SHALL BE FIELD VERIFIED BY CONTRACTOR.

		\\\\\\\\\\\\\\\\\\\\\\\\\\\\\\\\\\\\\\	\sim			\searrow				
LIGHT FIXTURE SCHEDULE										
TAG	MANUFACTURER'S CATALOG NUMBER	MAX. WATTS	MOUNT	MIN. LUMEN OUTPUT *(D/I)	сст	CRI	DESCRIPTION	REMARKS		
L1	LITHONIA #CPX 2X4 AL08 SWW7 SWL MVOLT	45	RECESSED	6,383	4000	80	120-277V, 2'X4' FULLY SWITCHABLE SATIN WHITE LENS LED PANEL AND COLD ROLLED STEEL HOUSING. ELECTRONIC 0-10V DIMMING DRIVER WITH RANGE FROM 100% TO 10%. UL LISTED. FACTORY TO SELECT LUMENS AND COLOR TEMPERATURE LISTED, CONTRACTOR TO VERIFY PRIOR TO INSTALLATION.			
	SURE LITE #LPX-6						120-277V, WHITE POLYCARBONATE EXIT SIGN WITH RED LETTERS. UL LISTED			

UNIVERSAL

LIGHTING SENSOR SCHEDULE

TAG	MANUFACTURER'S CATALOG NUMBER	INPUT VOLTAGE	MOUNT	REMARKS	REMARKS
O1	WATTSTOPPER #DT-300 SENSOR SWITCH #CM-PDT-9-R GREENGATE #OAC-DT-R HUBBELL #OMNI-DT-XXXX-RP	24V	CEILING	DUAL TECHNOLOGY CEILING SENSOR WITH A COMBINATION OF ULTRASONIC AND PASSIVE INFRARED. SENSOR TO BE EQUIPPED WITH SELF ADJUSTING TECHNOLOGY AND ISOLATED RELAY OUTPUTS. SENSOR SHALL OPERATE AS AUTOMATIC "ON" AND AUTOMATIC "OFF" WITH A 15 MINUTE TIME DELAY.	1
PP	WATTSTOPPER #BZ150 SENSOR SWITCH #PP20 GREENGATE #SP20-MV HUBBELL	120/277V	4 SQUARE BOX ABOVE ACCESSIBLE CEILING	POWER PACK TO OPERATE LOW VOLTAGE (24VDC) OCCUPANCY SENSORS. RELAY TO BE 20A RATED.	

- . PROVIDE POWER PACKS AND EMERGENCY LIGHTING CONTROL UNITS AS REQUIRED TO OPERATE LIGHTING AS SHOWN ON FLOOR PLANS
- 120/277V SENSOR IN LIEU OF POWER PACK IS ACCEPTABLE.

CONTRACTOR PRIOR TO ROUGH-IN.

MEASUREMENTS SHALL BE BORNE BY THE CONTRACTOR.

BY ANOTHER DISCIPLINE.

ENGINEER PRIOR TO ROUGH-IN.

CIRCUITS.)

LITHONIA #LQM-S-3-R-120/277

DUAL LITE #EVE-U-R-W

REMARKS:

CIRCUIT BREAKER

120V, 20 A

SHALL NOT BE SHARED ON BRANCH CIRCUITS.

3. THE ELECTRICAL LAYOUT DRAWINGS ARE DIAGRAMMATIC IN NATURE. REFER TO ENTIRE CONSTRUCTION DRAWING SET AND SPECIFICATIONS FOR GUIDANCE ON DIMENSIONS, CEILING HEIGHTS, DOOR SWINGS, ROOM FINISHES,

STRUCTURAL DETAILS, LOCATIONS OF PIPING, DUCTWORK, STRUCTURAL MEMBERS, AND OTHER OBSTRUCTIONS.

ALL DIMENSIONS OF EXISTING DEVICES AND EQUIPMENT ARE APPROXIMATE. CONTRACTOR SHALL MAKE ALL

10. PROVIDE ADDITIONAL SUPPORT FOR SWITCHES, STARTERS, RACEWAY, GROUNDING SYSTEMS, AND OTHER

12. COORDINATE ALL EQUIPMENT WIRING WITH MFR'S REQUIREMENTS. CHANGES REQUIRED FROM THE USE OF PRODUCTS THAT ARE OTHER THAN THE BASIS OF DESIGN SHALL BE BORNE BY THE CONTRACTOR.

MATERIAL EQUAL TO THOMAS AND BETTS U.L. LISTED FLAME-SAFE FIRE STOP SYSTEM.

ELECTRICAL EQUIPMENT WHEREVER THE BUILDING CONSTRUCTION IS NOT SUITABLE FOR DIRECT MOUNTING.

11. ALL PENETRATIONS THROUGH FIRE RATED WALLS, FLOORS, AND CEILINGS SHALL BE SEALED WITH FIRE STOPPING

13. SIZING OF BRANCH CIRCUITS AND FEEDERS FOR EQUIPMENT IS BASED ON DESIGN LOADS. PRIOR TO INSTALLATION,

14. BRANCH CIRCUITS SHALL BE WIRED WITH 3/4"C, 2-#12, 1-#12G, UNLESS NOTED OTHERWISENEUTRAL CONDUCTORS

15. WHERE CONDUIT AND WIRING HAS NOT BEEN SHOWN ON THE DRAWINGS, THE ARRANGEMENT AND ROUTING OF

16. EXCEPT WHERE NOTED OTHERWISE, SIZE BRANCH CIRCUIT CONDUCTORS WITHIN THE FOLLOWING MAXIMUMENGTH

7. PROVIDE #12 AWG MINIMUM FOR BRANCH CIRCUITS. PROVIDE ADDITIONAL DERATING PER N.E.CTABLES 310-16

19. FOR EQUIPMENT THAT IS TO BE FURNISHED BY OTHERS AND WIRED BY THIS CONTRACTOR, REVIEW ALL

21. ELECTRICAL CONTRACTOR SHALL BE RESPONSIBLE FOR ROUGH-IN OF TEMPERATURE CONTROL DEVICES.

THROUGH 310-31 FOR ALL HOME RUNS WITH MORE THAN THREE CURRENT CARRYINGCONDUCTORS IN A RACEWAY.

18. CONDUITS SHALL BE LIMITED TO A MAXIMUM OF NINE BRANCH CIRCUIT CONDUCTORS OF WHICH A MAXIMUM OF FOUR

PHASE CONDUCTORS SHALL BE PERMITTED. GROUNDING CONDUCTORS SHALL NOT BE INCLUDED IN THE COUNT.

SPECIFICATION SECTIONS, EQUIPMENT SCHEDULES, AND/OR DRAWING DETAILS THAT PERTAIN TO THIS EQUIPMENT

20. CONDUIT, BOXES, AND WIRING DEVICES IN ALL AREAS SHALL BE INSTALLED IN CONCEALED SPACES OR RECESSED IN

WALLS UNLESS IN MECHANICAL/ELECTRICAL EQUIPMENT ROOMS OR AS DIRECTED BY THE ARCHTECT/ENGINEER.

CONTRACTOR SHALL PROVIDE AND INSTALL BACK BOXES AND CONDUIT WITH BUSHING TO NEAREST ACCESSIBL

CEILING. REFER TO MECHANICAL DRAWINGS FOR LOCATIONS. COORDINATE WITH MECHANICAL CONTRACTOR.

22. ELECTRIC WATER COOLERS (EWC DUPLEX RECEPTACLE ON SYMBOL SCHEDULE) SHALL BE PROTECTED BY GFCI

23. ALL HVAC CONTROL WIRING SHALL BE THE RESPONSIBILITY OF THE HVAC CONTRACTOR UNLESS NOTED OTHERWISE.

PROTECTED CIRCUIT BREAKER IN PANEL BOARD UNLESS OTHERWISE NOTED. PROVIDE AT ALL LOCATIONS.

AND INCLUDE ALL WIRING AND DEVICES REFERENCED. CONTRACTOR SHALL COORDINATE EXACT LOCATION OF THIS

LIMITS: (MEASURE TO THE CENTER OF THE LOAD FOR LIGHTING ANDTO THE MOST REMOTE OUTLET FORRECEPTACLE

CONDUCTOR SIZE

GENERALLY ACCEPTED GOOD PRACTICE, N.E.C. REQUIREMENTS, AND THE FOLLOWING LIMITATIONS:

CIRCUIT LENGTH

100 FEET

150 FEET

200 FEET

EQUIPMENT WITH EQUIPMENT INSTALLER PRIOR TO ROUGH-IN INSTALLATION.

CONFIRM EXACT LOADS WITH RELEASED SHOP DRAWINGS. BRING ANY DISCREPANCIES TO THE ATTENTION OF THE

LIGHTING AND RECEPTACLE BRANCH CIRCUITS SHALL BE AT THE DISCRETION OF CONTRACTOR IN ACCORDANCE WITH

INSTALL THE ELECTRICAL SYSTEMS SO AS NOT TO INTERFERE WITH THE INSTALLATION OR FUNCTION OF ANY WORK

NECESSARY FIELD MEASUREMENTS OF EXISTING STRUCTURES AND EQUIPMENT TO VERIFY DIMENSIONS SHOWN ON

THE PLANS. ALL ADDED COSTS TO MODIFY NEW CONSTRUCTION DUE TO A LACK OF COORDINATION AND FIELD

CEILING MOUNTED OCCUPANCY SENSORS SHALL BE INSTALLED 6'-0" AWAY FROM ANY SUPPLY DIFFUSERS, COORDINATE WITH MECHANICAL CONTRACTOR.

A OR AMP	AMPERE	EWH	ELECTRICAL WATER HEATER	MH	METAL HALIDE	UNO	UNLESS NOTED OTHERWISE
AC	ABOVE COUNTER	EXIST	EXISTING	MIN	MINIMUM	UPS	UNINTERRUPTIBLE POWER S
A/E	ARCHITECT/ENGINEER	EXT	EXTERIOR	MISC	MISCELLANEOUS	V	VOLTAGE
AFF	ABOVE FINISHED FLOOR	F	FURNACE	МО	MASONRY OPENING	VAV	VARIABLE AIR VOLUME
AFG	ABOVE FINISHED GRADE	FA	FIRE ALARM	#	NUMBER	VERT	VERTICAL
AHU	AIR HANDLING UNIT	FAA	FIRE ALARM ANNUNCIATOR	NC	NORMALLY CLOSED	VFD OR VSD	VARIABLE FREQUENCY DRIVE
ALT	ALTERNATE	FACP	FIRE ALARM CONTROL PANEL	NIC	NOT IN CONTRACT	l w	WATT
APPROX	APPROXIMATELY	FCU	FAN COIL UNIT	N/L	NIGHT LIGHT	W/	WITH
AWG	AMERICAN WIRE GAUGE	FDN	FOUNDATION	l no	NORMALLY OPEN	WG	WIRE GUARD
BLDG	BUILDING	FIN	FINISH	NOM	NOMINAL	W/O	WITHOUT
BLKG	BLOCKING	FL	FLUORESCENT	NTS	NOT TO SCALE	WP	WATERPROOF
BTM	BOTTOM	FT	FOOT	OAC	OPENING ABOVE CEILING	XFRMR	TRANSFORMER
C	CONDUIT	FT-C	FOOT CANDLE	oc	ON CENTER	l yD	YARD
СВ	CIRCUIT BREAKER	G OR EGC	GROUND	OD	OUTSIDE DIAMETER	YR	YEAR
CL	CENTERLINE	GA	GAUGE	OP	OVERHEAD POWER LINES		
CFM	CUBIC FEET PER MINUTE	GFCI OR GFI	GROUND FAULT CIRCUIT INTERRUPTER	LB	POUND		
CUH	CABINET UNIT HEATER	GRC	GALVANIZED RIGID CONDUIT	PH	PHASE		
CLG	CEILING	GWH	GAS WATER HEATER	PC	PLUMBING CONTRACTOR		
CMU	CONCRETE MASONRY UNIT	HT	HEIGHT	PIV	POST INDICATING VALVE		
COL	COLUMN	HORIZ	HORIZONTAL	PVC	POLYVINYL CHLORIDE		
CONC	CONCRETE	HPS	HIGH PRESSURE SODIUM	R	RADIUS		
CONC BLK	CONCRETE BLOCK	HR	HOUR	REQ OR REQ'D	REQUIRED		
CONST	CONSTRUCTION	ID	INSIDE DIAMETER	RM	ROOM		
CONTR	CONTRACTOR	IG	ISOLATED GROUND	RO	ROUGH OPENING		
Cu	COPPER	IMC	INTERMEDIATE METAL CONDUIT	RTU	ROOF TOP UNIT		
DC	DIRECT CURRENT	INSUL	INSULATION	SCHED	SCHEDULE		
DIA	DIAMETER	INT	INTERIOR	SIM	SIMILAR		
DEG	DEGREE	INFO	INFORMATION	SPEC	SPECIFICATION		
DET	DETAIL	KCMIL	THOUSAND CIRCULAR MILLS	SQ	SQUARE		
DIM	DIMENSION	KVA	KILOVOLT-AMPERE	SS	STAINLESS STEEL		
DWG	DRAWING	KWH	KILOWATT-HOUR	STD	STANDARD		
EC	ELECTRICAL CONTRACTOR	KW	KILOWATT	STL	STEEL		
EF	EXHAUST FAN	LP	LIGHT POLE	SUSP	SUSPEND		
ELEC	ELECTRICAL	MAU	MAKE-UP AIR UNIT	TCP	TEMPERATURE CONTROL PANEL		
ELEV	ELEVATION	MAX	MAXIMUM	TS	TEACHER'S STATION		
EM	EMERGENCY	MC	MECHANICAL CONTRACTOR	TTB	TELEPHONE TERMINAL BOARD		
EMT	ELECTRICAL METALLIC TUBING	MCC	MOTOR CONTROL CENTER	TYP	TYPICAL		
EQ	EQUAL EQUAL	MCM	THOUSAND CIRCULAR MILLS	UH	UNIT HEATER		
EWC	ELECTRIC WATER COOLER	MFR	MANUFACTURER	UL	UNDERWRITERS LABORATORIES		




* NOT ALL SYMBOLS USED ON THIS PROJECT



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REVISIONS DESCRIPTION ADDENDUM #2

<u>ISSUE DATE</u> November 27, 2024 Issue for Bids, Permits, and Construction

ELECTRICAL INFORMATION SHEET

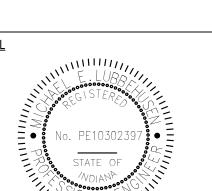E-001

LINE TYPES
CORRECTLY. CONTAC
PRIMARY ENGINEERING FOR TO OBTAIN A FULL

PRINTED BELOW IS NOT SHOWN IN COLOR, THIS SET OF PRINTS IS NOT

REPRESENTING AL



IF THE WHEEL
PRINTED BELOW IS
NOT SHOWN IN
COLOR, THIS SET OF
PRINTS IS NOT
REPRESENTING ALL
LINE TYPES
CORRECTLY. CONTACT
PRIMARY
ENGINEERING FOR
DIRECTIONS ON HOW
TO OBTAIN A FULL
COLOR SET OF PRINTS

PLAN NOTES

- 1. PROVIDE AND INSTALL NEW LIGHT FIXTURES. EXTEND EXISTING BRANCH CIRCUIT AS REQUIRED TO CONNECT NEW LIGHTING AND LIGHTING CONTROL DEVICES IN THIS AREA. TYPICAL OF ALL FIXTURES AND CONTROLS IN THIS ROOM.
- 2. PROVIDE AND INSTALL 0-10V DIMMING CONTROL CABLING WITH EXISTING BRANCH CIRCUIT FROM DIMMER SWITCH TO LIGHT FIXTURES IN THIS ROOM.
- PROVIDE AND INSTALL 0-10V DIMMER SWITCHES IN EXISTING DEVICE BOX. EXTEND EXISTING BRANCH CIRCUIT, AS REQUIRED, TO CONNECT TO NEW DIMMER SWITCHES. PROVIDE AND INSTALL

NEUTRAL CONDUCTOR, AS REQUIRED, TO ALL FOR INSTALLATION OF DIMMER SWITCHES.


- 4. PROVIDE AND INSTALL NEW SWITCH IN EXISTING DEVICE BOX. EXTEND EXISTING BRANCH CIRCUIT,
- AS REQUIRED, TO CONNECT TO NEW SWITCH. PROVIDE AND INSTALL NEUTRAL, AS REQUIRED.
- 5. CONNECT TO ALL EMERGENCY LIGHT FIXTURES TO EXISTING LIGHTING CIRCUIT SERVING AREA AHEAD OF ANY SWITCHES, SENSORS AND RELAYS.

ELEVATUS ARCHITECTURE

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DESCRIPTION
1 ADDENDUM #2

November 27, 2024

LIGHTING PLAN

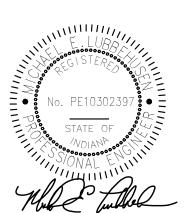Issue for Bids, Permits, and Construction

E-301