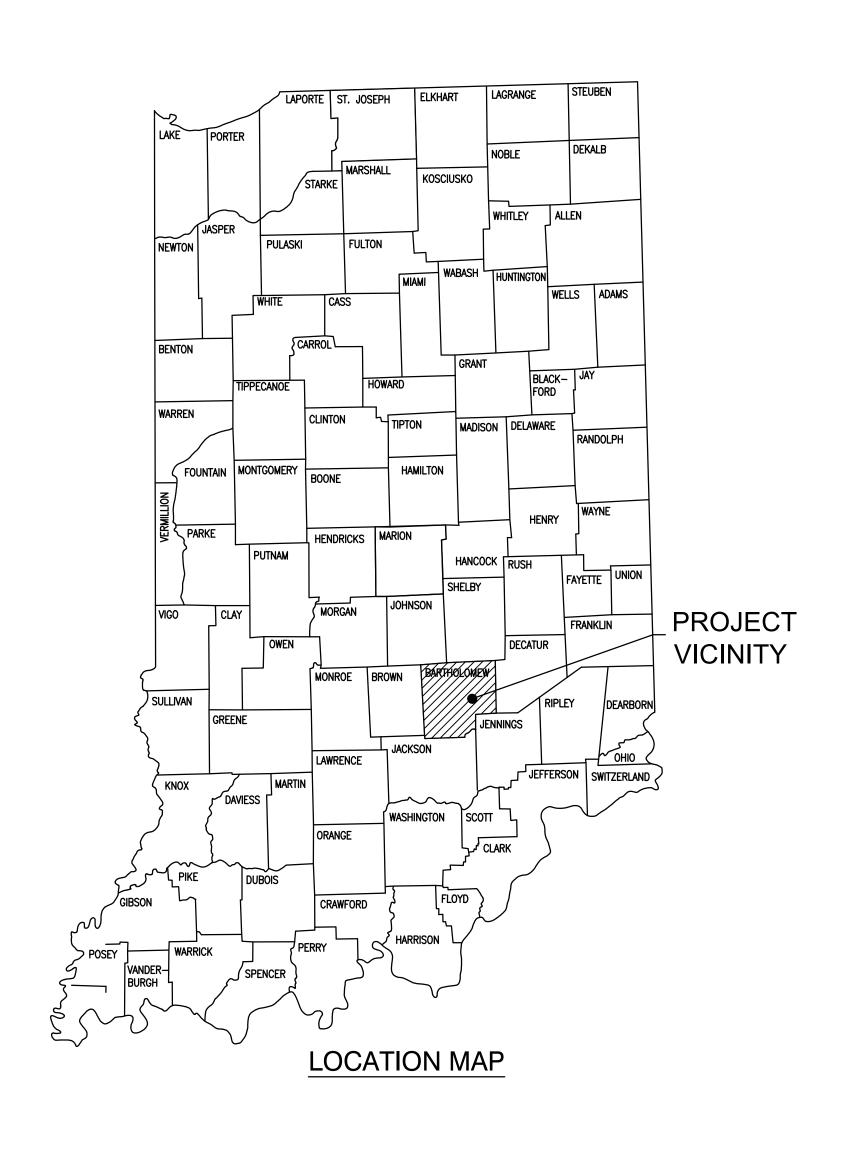
BCSC - SMITH ELEMENTARY RENOVATIONS AND ADDITIONS

4505 WAYCROSS DRIVE
COLUMBUS, INDIANA 47203
100% CIVIL CONSTRUCTION DOCUMENTS
JANUARY 15, 2025






Sheet Number	Sheet Title	Drawing No.			
01	TITLE SHEET	C000			
02	BOUNDARY RETRACEMENT SURVEY	BNDRY			
03	TOPOGRAPHIC SURVEY	ТОРО			
04	TOPOGRAPHIC SURVEY	ТОРО			
05	TOPOGRAPHIC SURVEY	ТОРО			
06	OVERALL DEMOLITION PLAN	C100			
07	DEMOLITION PLAN - NORTH	C101			
08	DEMOLITION PLAN - SOUTH	C102			
09	DEMOLITION PLAN - EAST ALTERNATE	C103			
10	OVERALL GRADING PLAN	C300			
11	11 GRADING PLAN - NORTH				
12	12 GRADING PLAN - SOUTH				
13	13 GRADING PLAN - EAST ALTERNATE				
14	FLOOD ROUTING PLAN				
15	FLOOD ROUTING PLAN - EAST ALTERNATE	C305			
16	OVERALL DRAINAGE PLAN	C400			
17	C401				
18	C402				
19	DRAINAGE PLAN - EAST ALTERNATE	C403			
20	20 OVERALL UTILITY PLAN				
21	C501				
22	C502				
23	SITE DETAILS	C800			
24	SITE DETAILS	C801			
25	25 OVERALL STORMWATER POLLUTION PREVENTION PLAN				
26	STORMWATER POLLUTION PREVENTION PLAN - NORTH	C901			
27	STORMWATER POLLUTION PREVENTION PLAN - SOUTH	C902			
28	STORMWATER POLLUTION PREVENTION PLAN - EAST ALTERNATE	C903			
29	STORMWATER POLLUTION PREVENTION NOTES	C904			
30	STORMWATER POLLUTION PREVENTION DETAILS	C905			
	CITY OF COLUMBUS STANDARD DETAILS				



JNTACT: JONATHAN P		SOInc.net
TILITIES:		
	ELECTRIC DUKE ENERGY 2727 CENTRAL AVE COLUMBUS, IN 47201	SANITARY SEWER COLUMBUS CITY UTILITIES 1111 MCCLURE RD COLUMBUS, IN 47201 (812)372-8861 ATTN: SCOTT DOMPKE
ORM SEWER LUMBUS ENGINEERING WASHINGTON ST. LUMBUS, IN 47201 2)376-2540 N: ANDREW BECKORT	1111 MCCLURE RD COLUMBUS, IN 47201 (812)372-8861	1101 JACKSON ST.

PLANNING DEPARTMENT

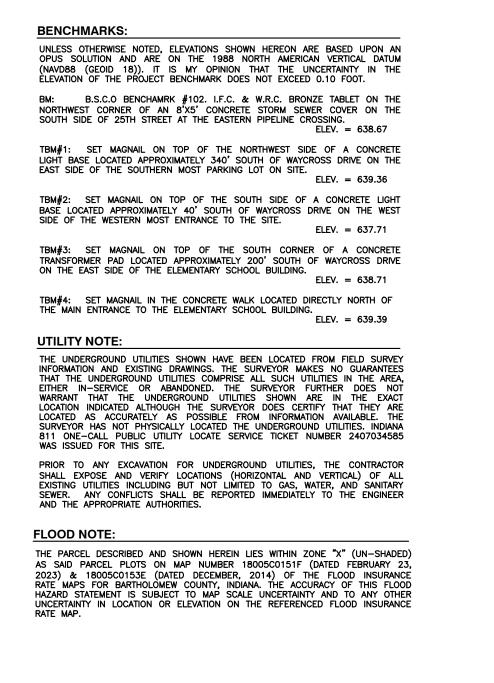123 WASHINGTON ST. COLUMBUS, IN 47201 (812)376-2550 ATTN: JEFF BERGMAN







8831 Keystone Crossing, Indianapolis, IN 462 317.848.7800 | csoinc.net

Civil & Environmental Consultants, I
530 E. Ohio Street · Suite G - Indianapolis, IN 46204
317-655-7777 · 877-746-0749
www.cecinc.com

BARTHOLOMEW CONSOLIDATE SCHOOL CORPORATION RENOVATIONS TO

SCOPE DRAWINGS:
These drawings indicate the general scope of the proje in terms of architectural design concept, the dimensions of the building, the major architectural elements and the type of structural, mechanical and electrical systems.
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REVISIONS:

02/05/2025 - ADDENDUM #02

202/12/2025 - ADDENDUM #04

ISSUE DATE DRAWN BY CHECKED BY

1/15/2025 MP/RT JP

DRAWING TITLE:
TITLE
SHEET

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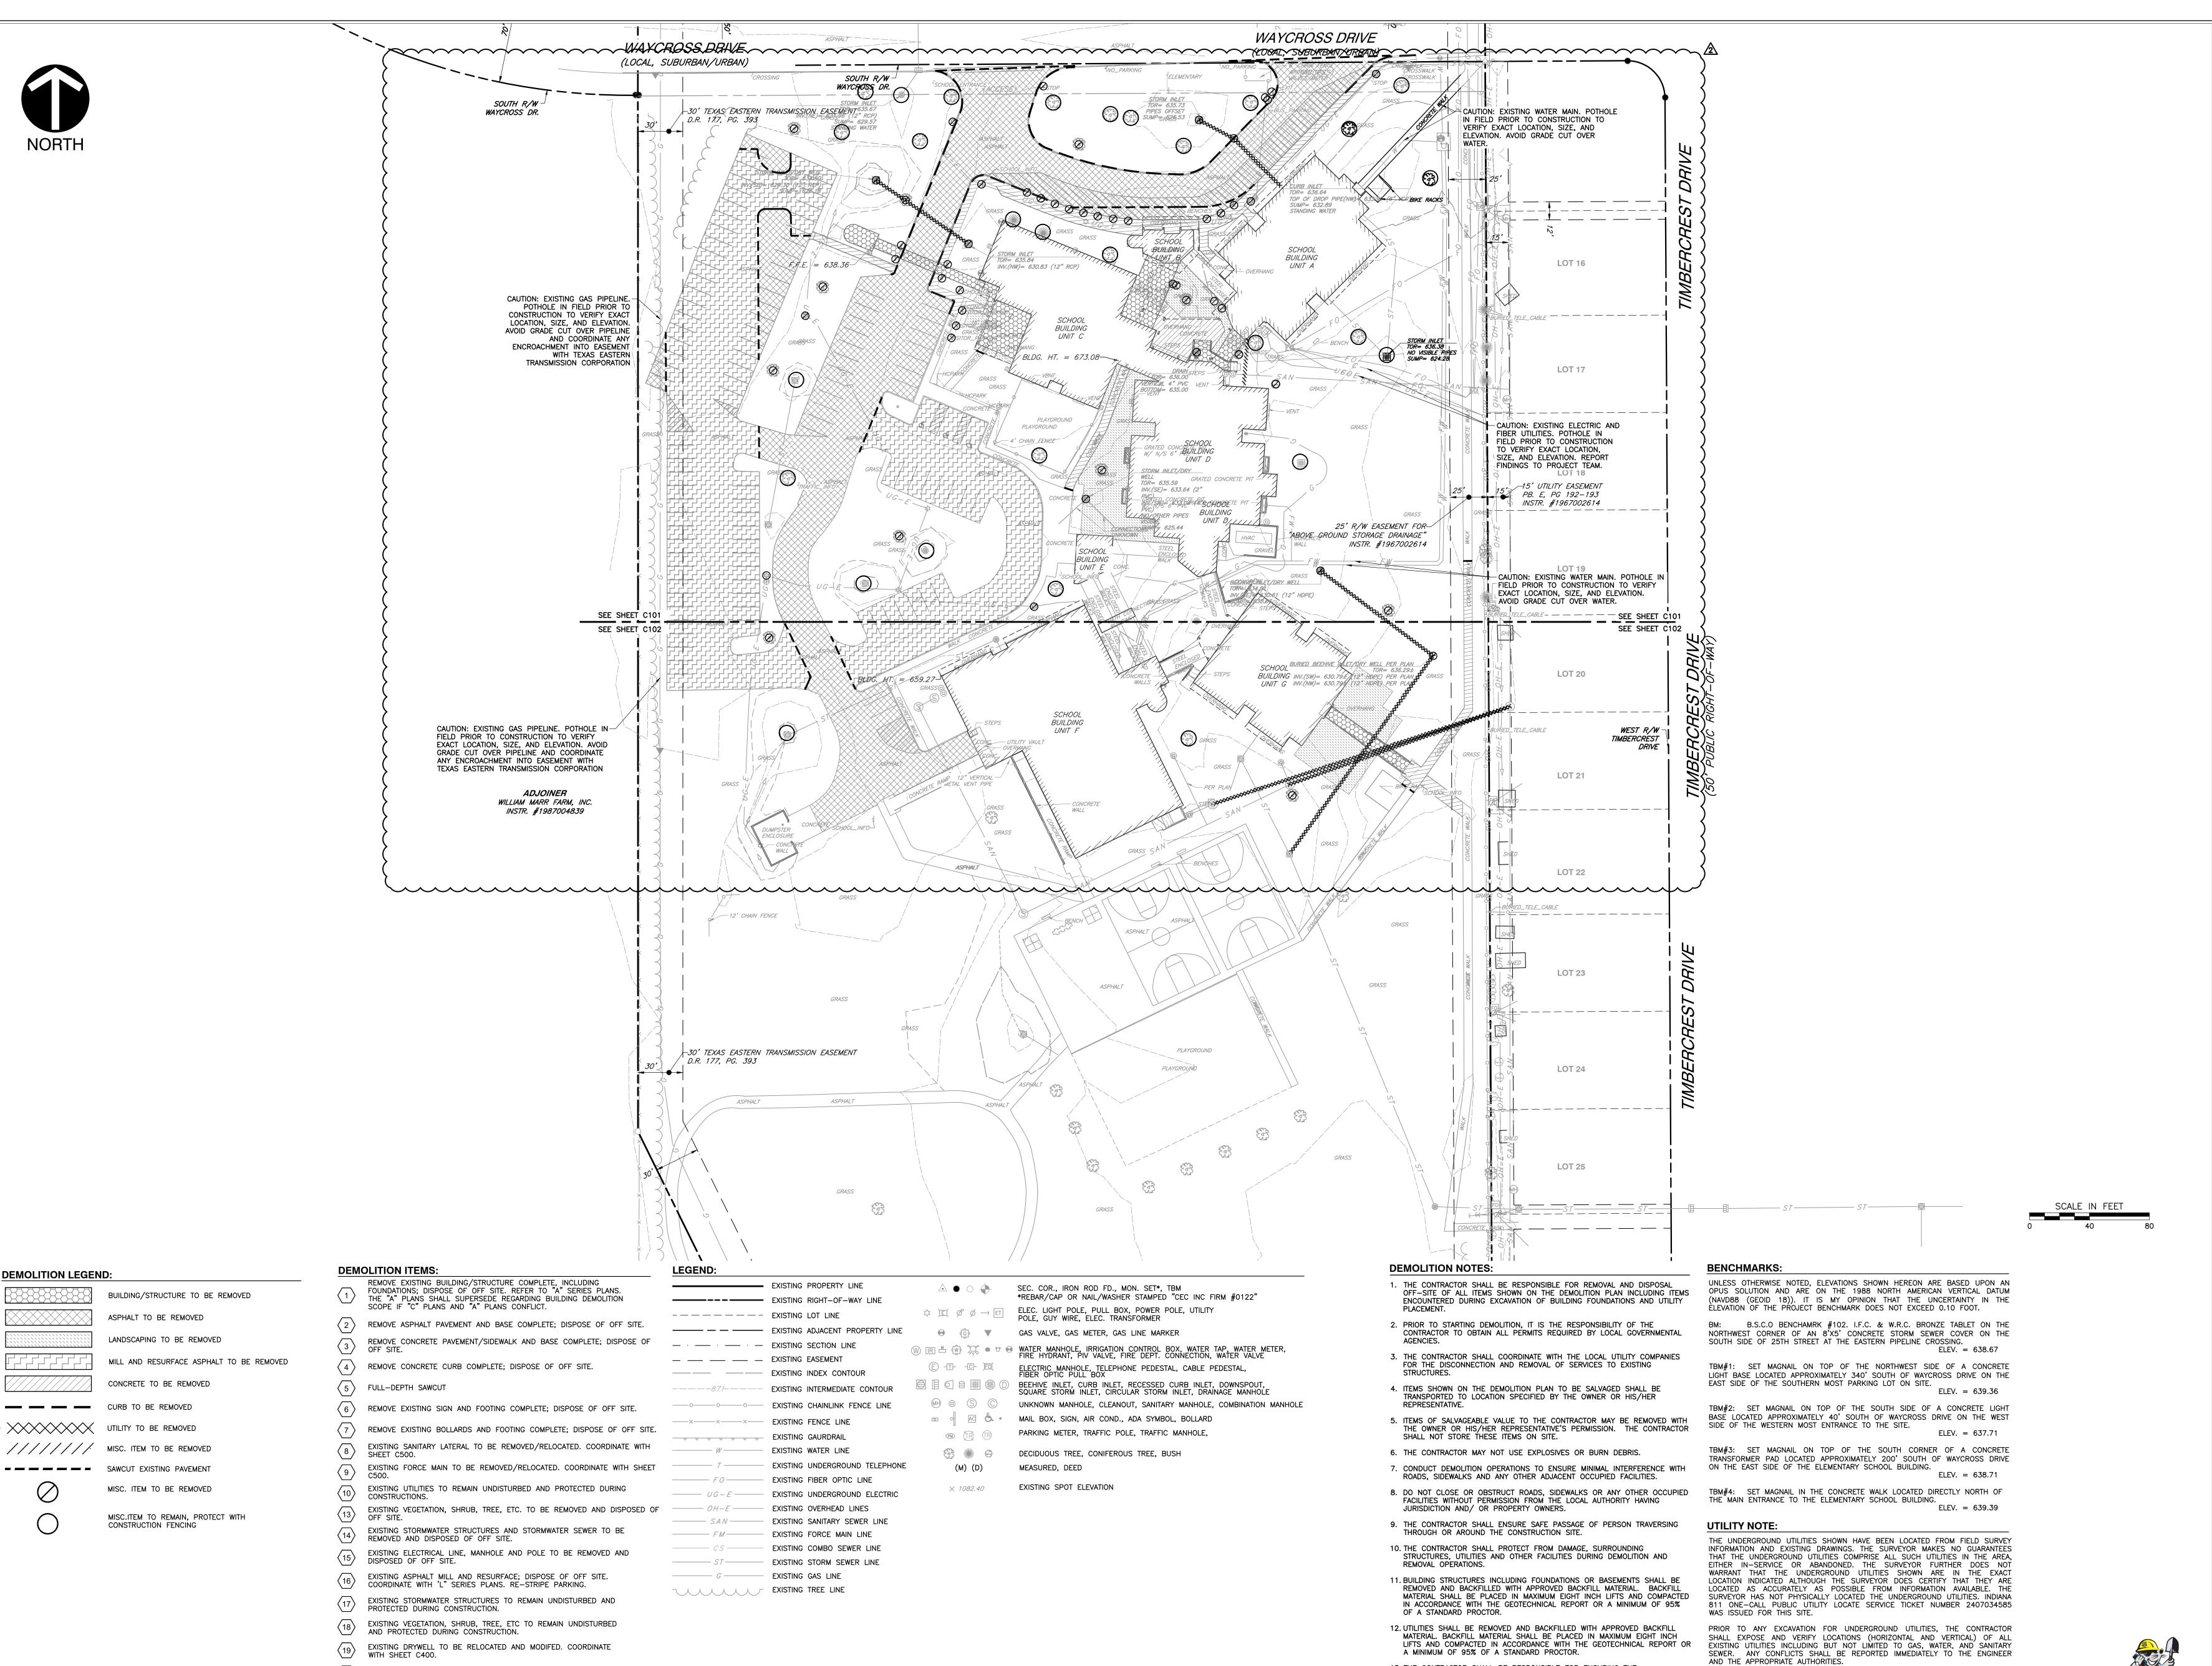
No. PE12100829

STATE OF

WDIANA

O1/15/25

DRAWING NUMBER
COOO
PROJECT NUMBER



EXISTING LIGHT POLE TO BE REMOVED. COORDINATE WITH "E" SERIES PLANS.

13. THE CONTRACTOR SHALL BE RESPONSIBLE FOR ENSURING THE

CONSTRUCTION SITE AND SURROUNDING AREAS ARE FREE OF ACCUMULATED

FLOOD NOTE:

THE PARCEL DESCRIBED AND SHOWN HEREIN LIES WITHIN ZONE "X" (UN-SHADED) AS SAID PARCEL PLOTS ON MAP NUMBER 18005C0151F (DATED FEBRUARY 23, 2023) & 18005C0153E (DATED DECEMBER, 2014) OF THE FLOOD INSURANCE RATE MAPS FOR BARTHOLOMEW COUNTY. INDIANA. THE ACCURACY OF THIS FLOOD

HAZARD STATEMENT IS SUBJECT TO MAP SCALE UNCERTAINTY AND TO ANY OTHER UNCERTAINTY IN LOCATION OR ELEVATION ON THE REFERENCED FLOOD INSURANCE

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c. 8831 Keystone Crossing, Indianapol 317.848.7800 | csoinc.ne

Environmental Consultants, Ir
Conio Street · Suite G - Indianapolis, IN 46204
317-655-7777 · 877-746-0749

www.cecinc.com

HOOL CORPORATION
SENOVATIONS TO
SES SMITH ELEMENTARY

SCOPE DRAWINGS:

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On the basis of the general scope indicated or described the trade contractors shall furnish all items required for the

REVISIONS: 02/12/2025 - ADDENDUM #04

202/12/2025 - ADDENDUM #04

ISSUE DATE DRAWN BY CHECKED BY

1/15/2025 MP/RT JF

OVERALL
DEMOLITION
PLAN

CERTIFIED BY:

No. PE12100829

STATE OF

MOIANA

MOIANA


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DRAWING NUMBER
C100

C100

PROJECT NUMBER 346-935

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REVISIONS:

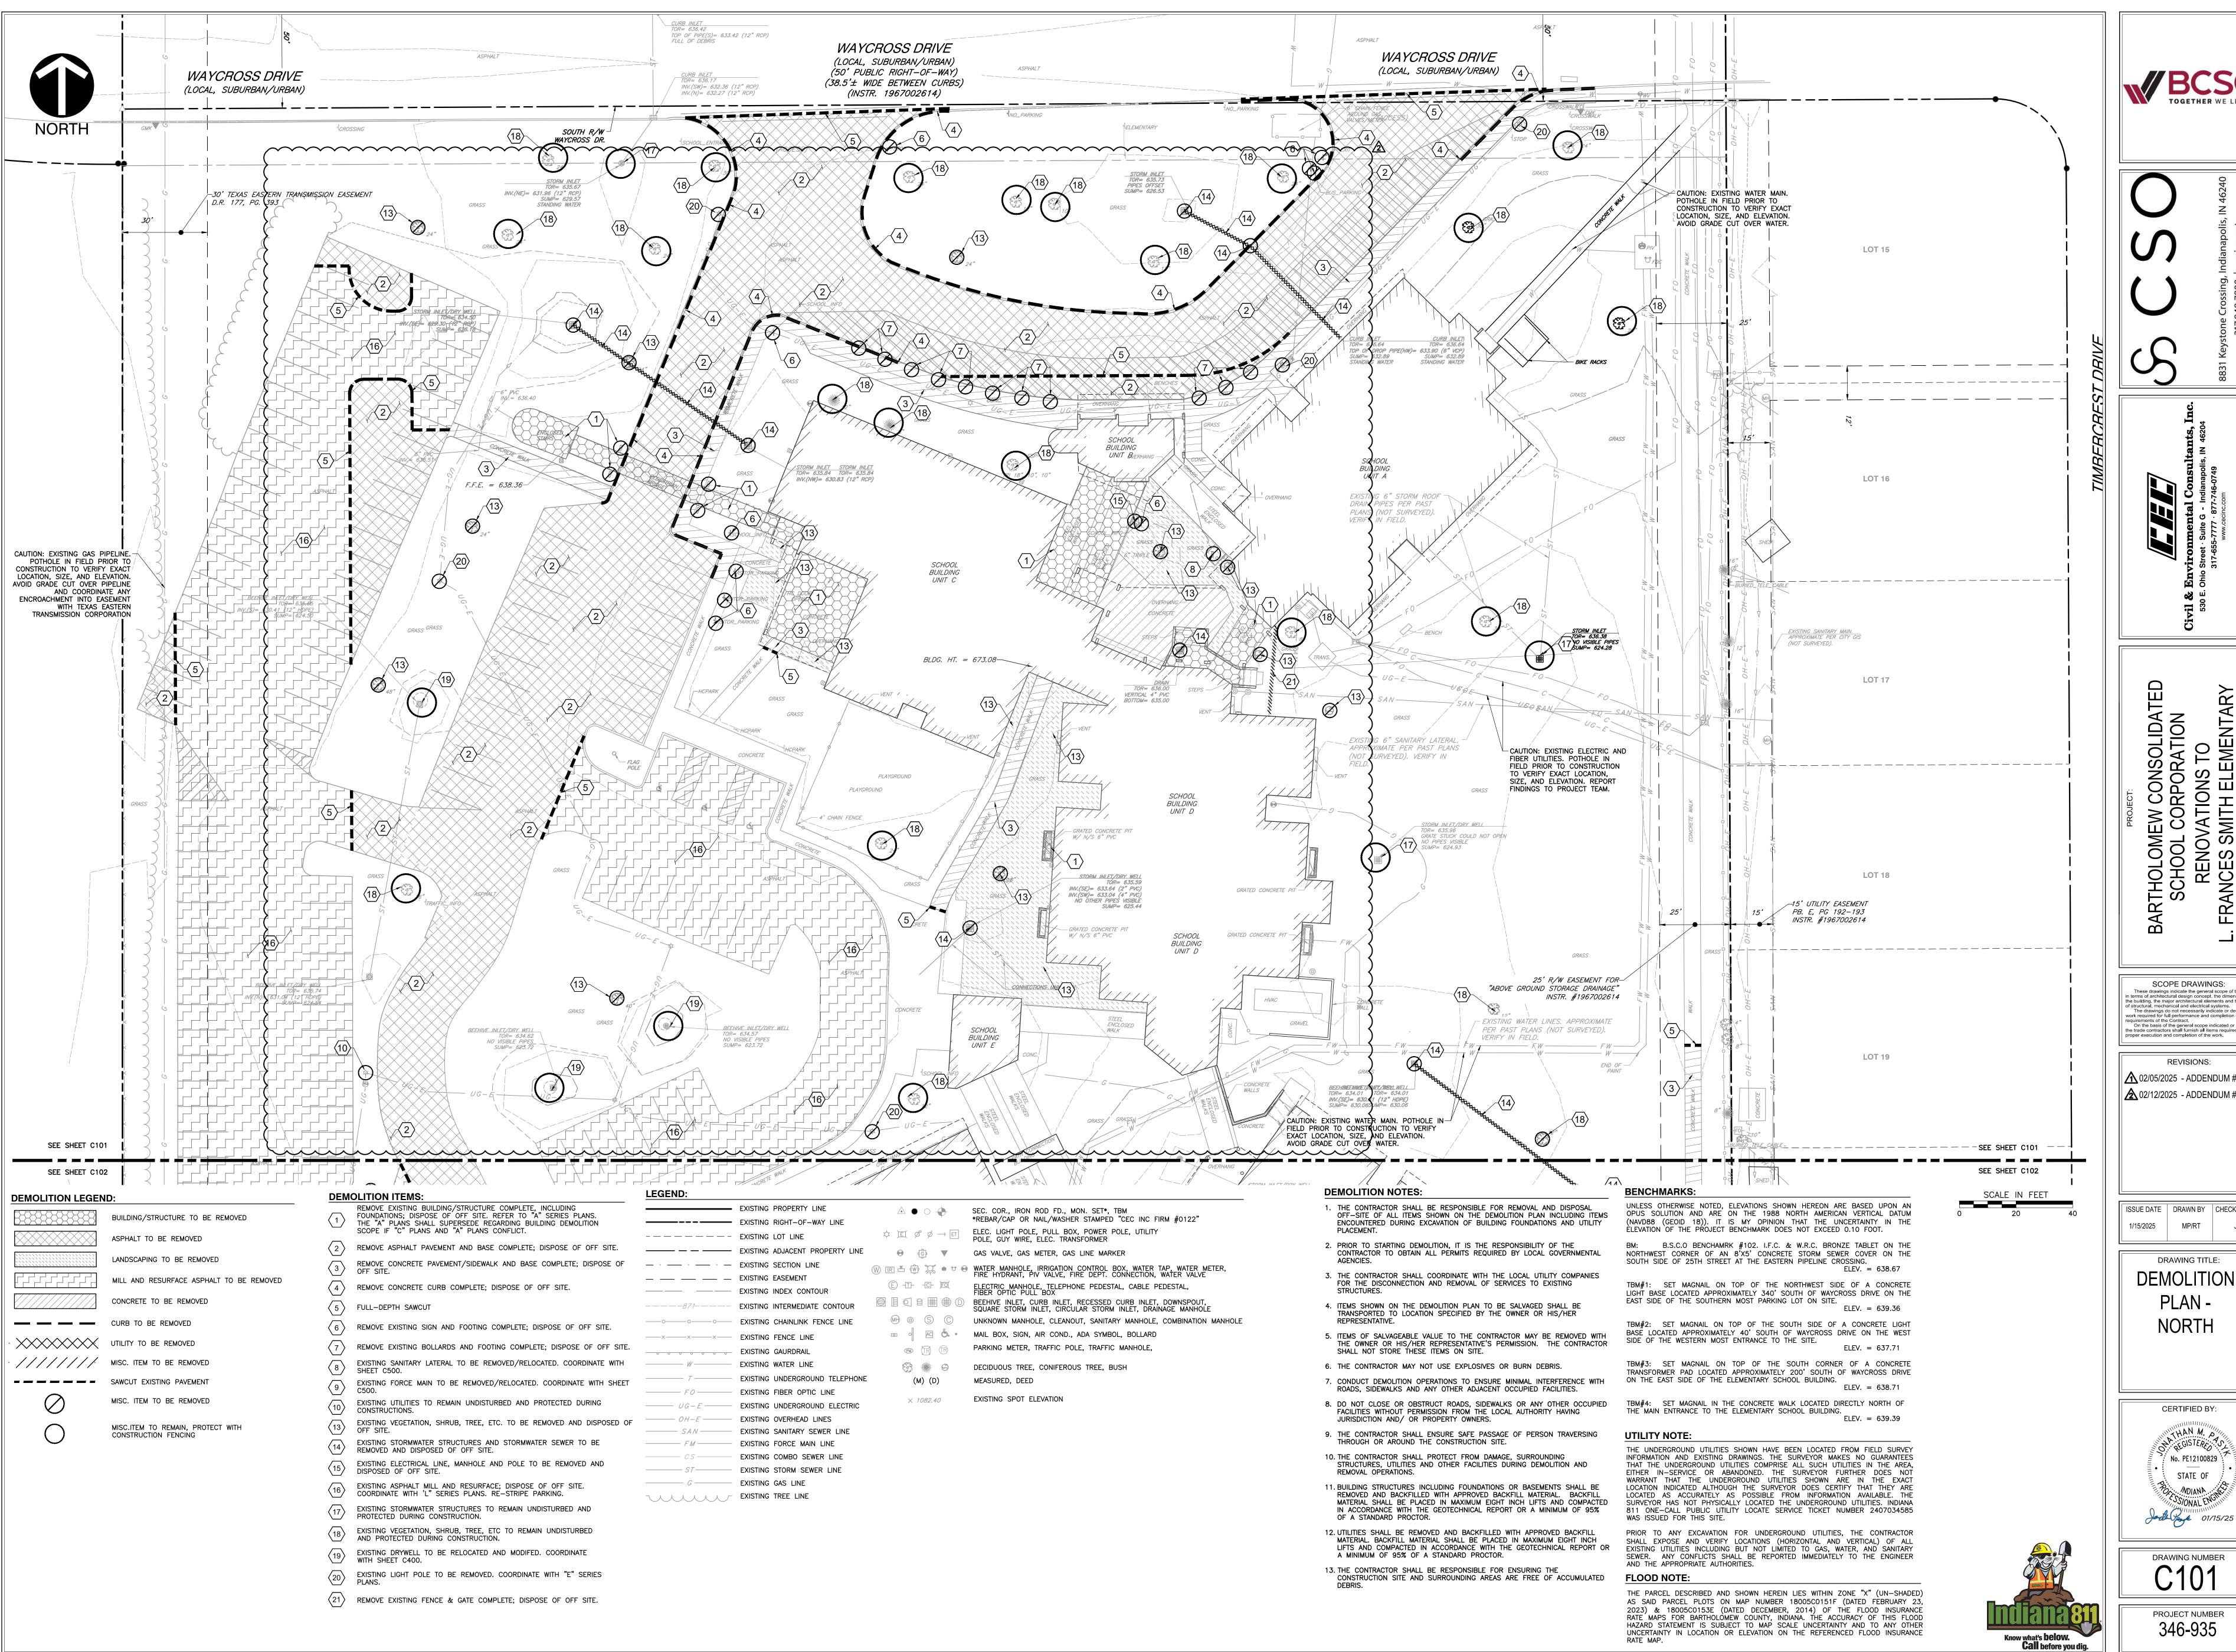1 02/05/2025 - ADDENDUM #02 2 02/12/2025 - ADDENDUM #04

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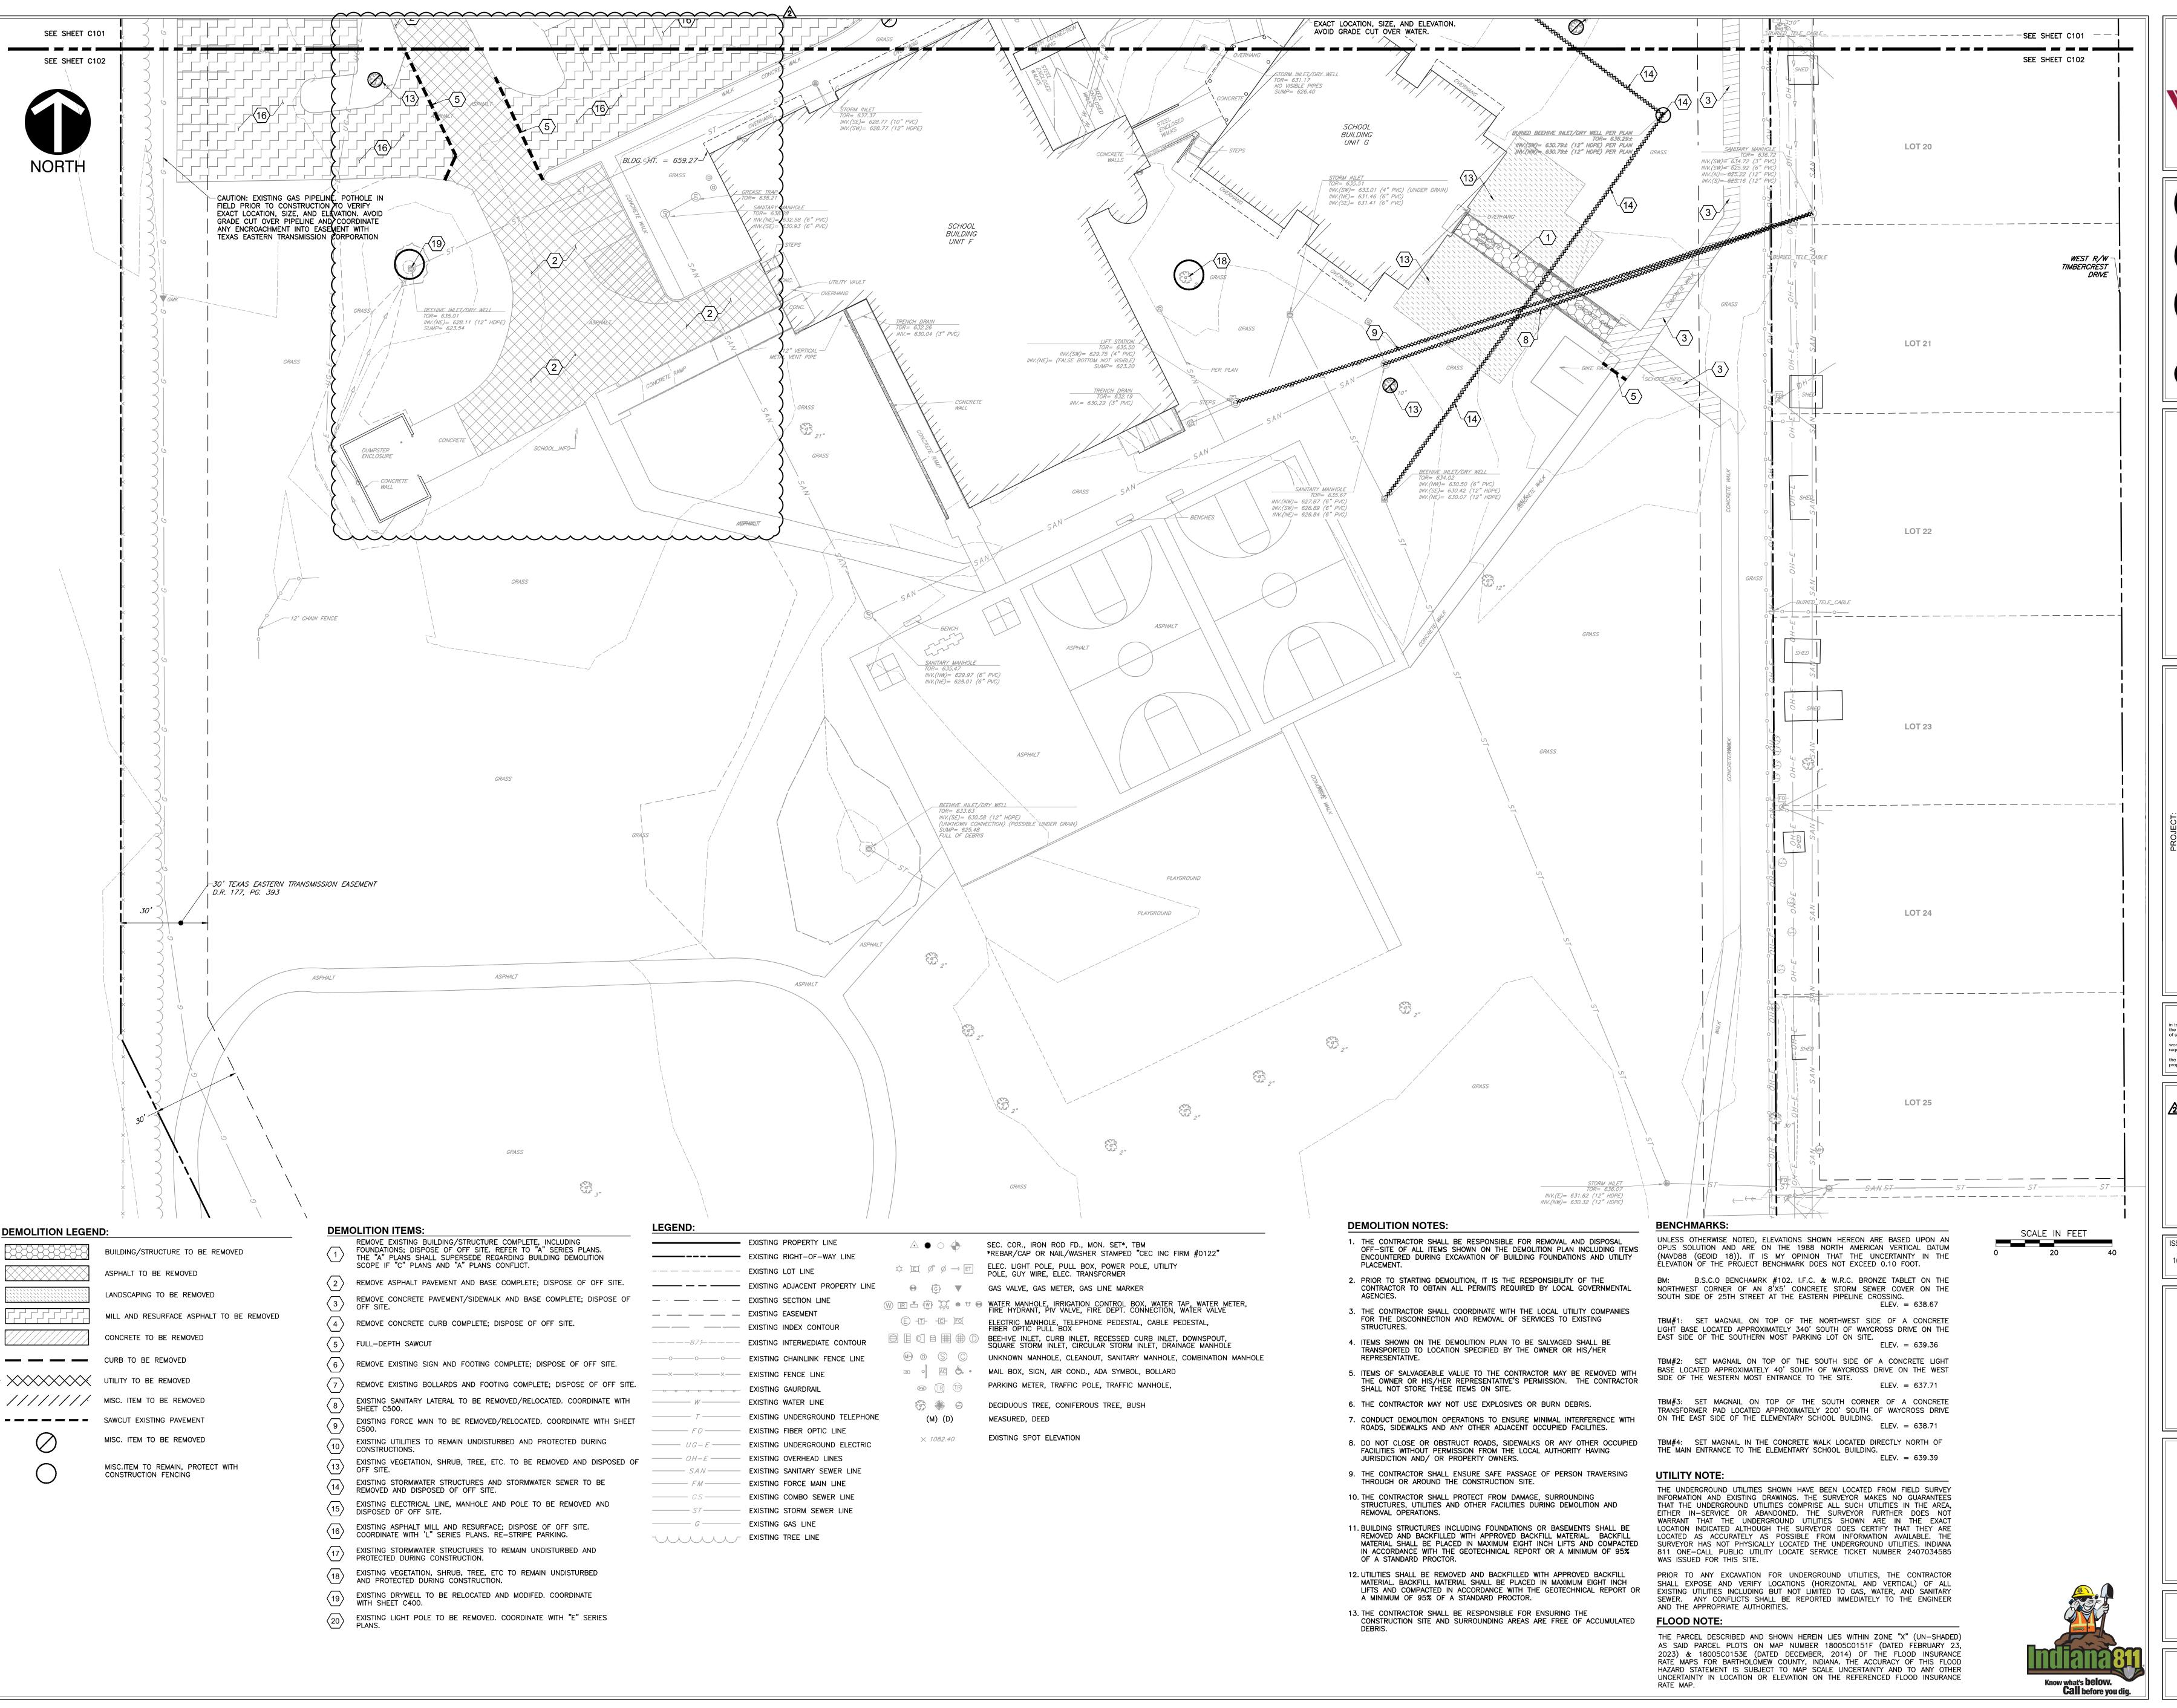
1/15/2025 MP/RT

> DRAWING TITLE: PLAN -

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DRAWING NUMBER

346-935



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J C dianapolis, IN 46240

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SCHOOL CORPORATION
SCHOOL CORPORATION
RENOVATIONS TO
RANCES SMITH ELEMENTARY

SCOPE DRAWINGS:
drawings indicate the general scope of the project architectural design concept, the dimensions of g, the major architectural elements and the type il, mechanical and electrical systems. awings do not necessarily indicate or describe all led for full performance and completion of the ts of the Contract. basis of the general scope indicated or described ontractors shall furnish all items required for the cution and completion of the work.

REVISIONS:

202/12/2025 - ADDENDUM #04

ISSUE DATE | DRAWN BY | CHECKED BY

1/15/2025 MP/RT JP

DRAWING TITLE:

EMOLITION PLAN -SOUTH

CERTIFIED BY:

No. PE12100829

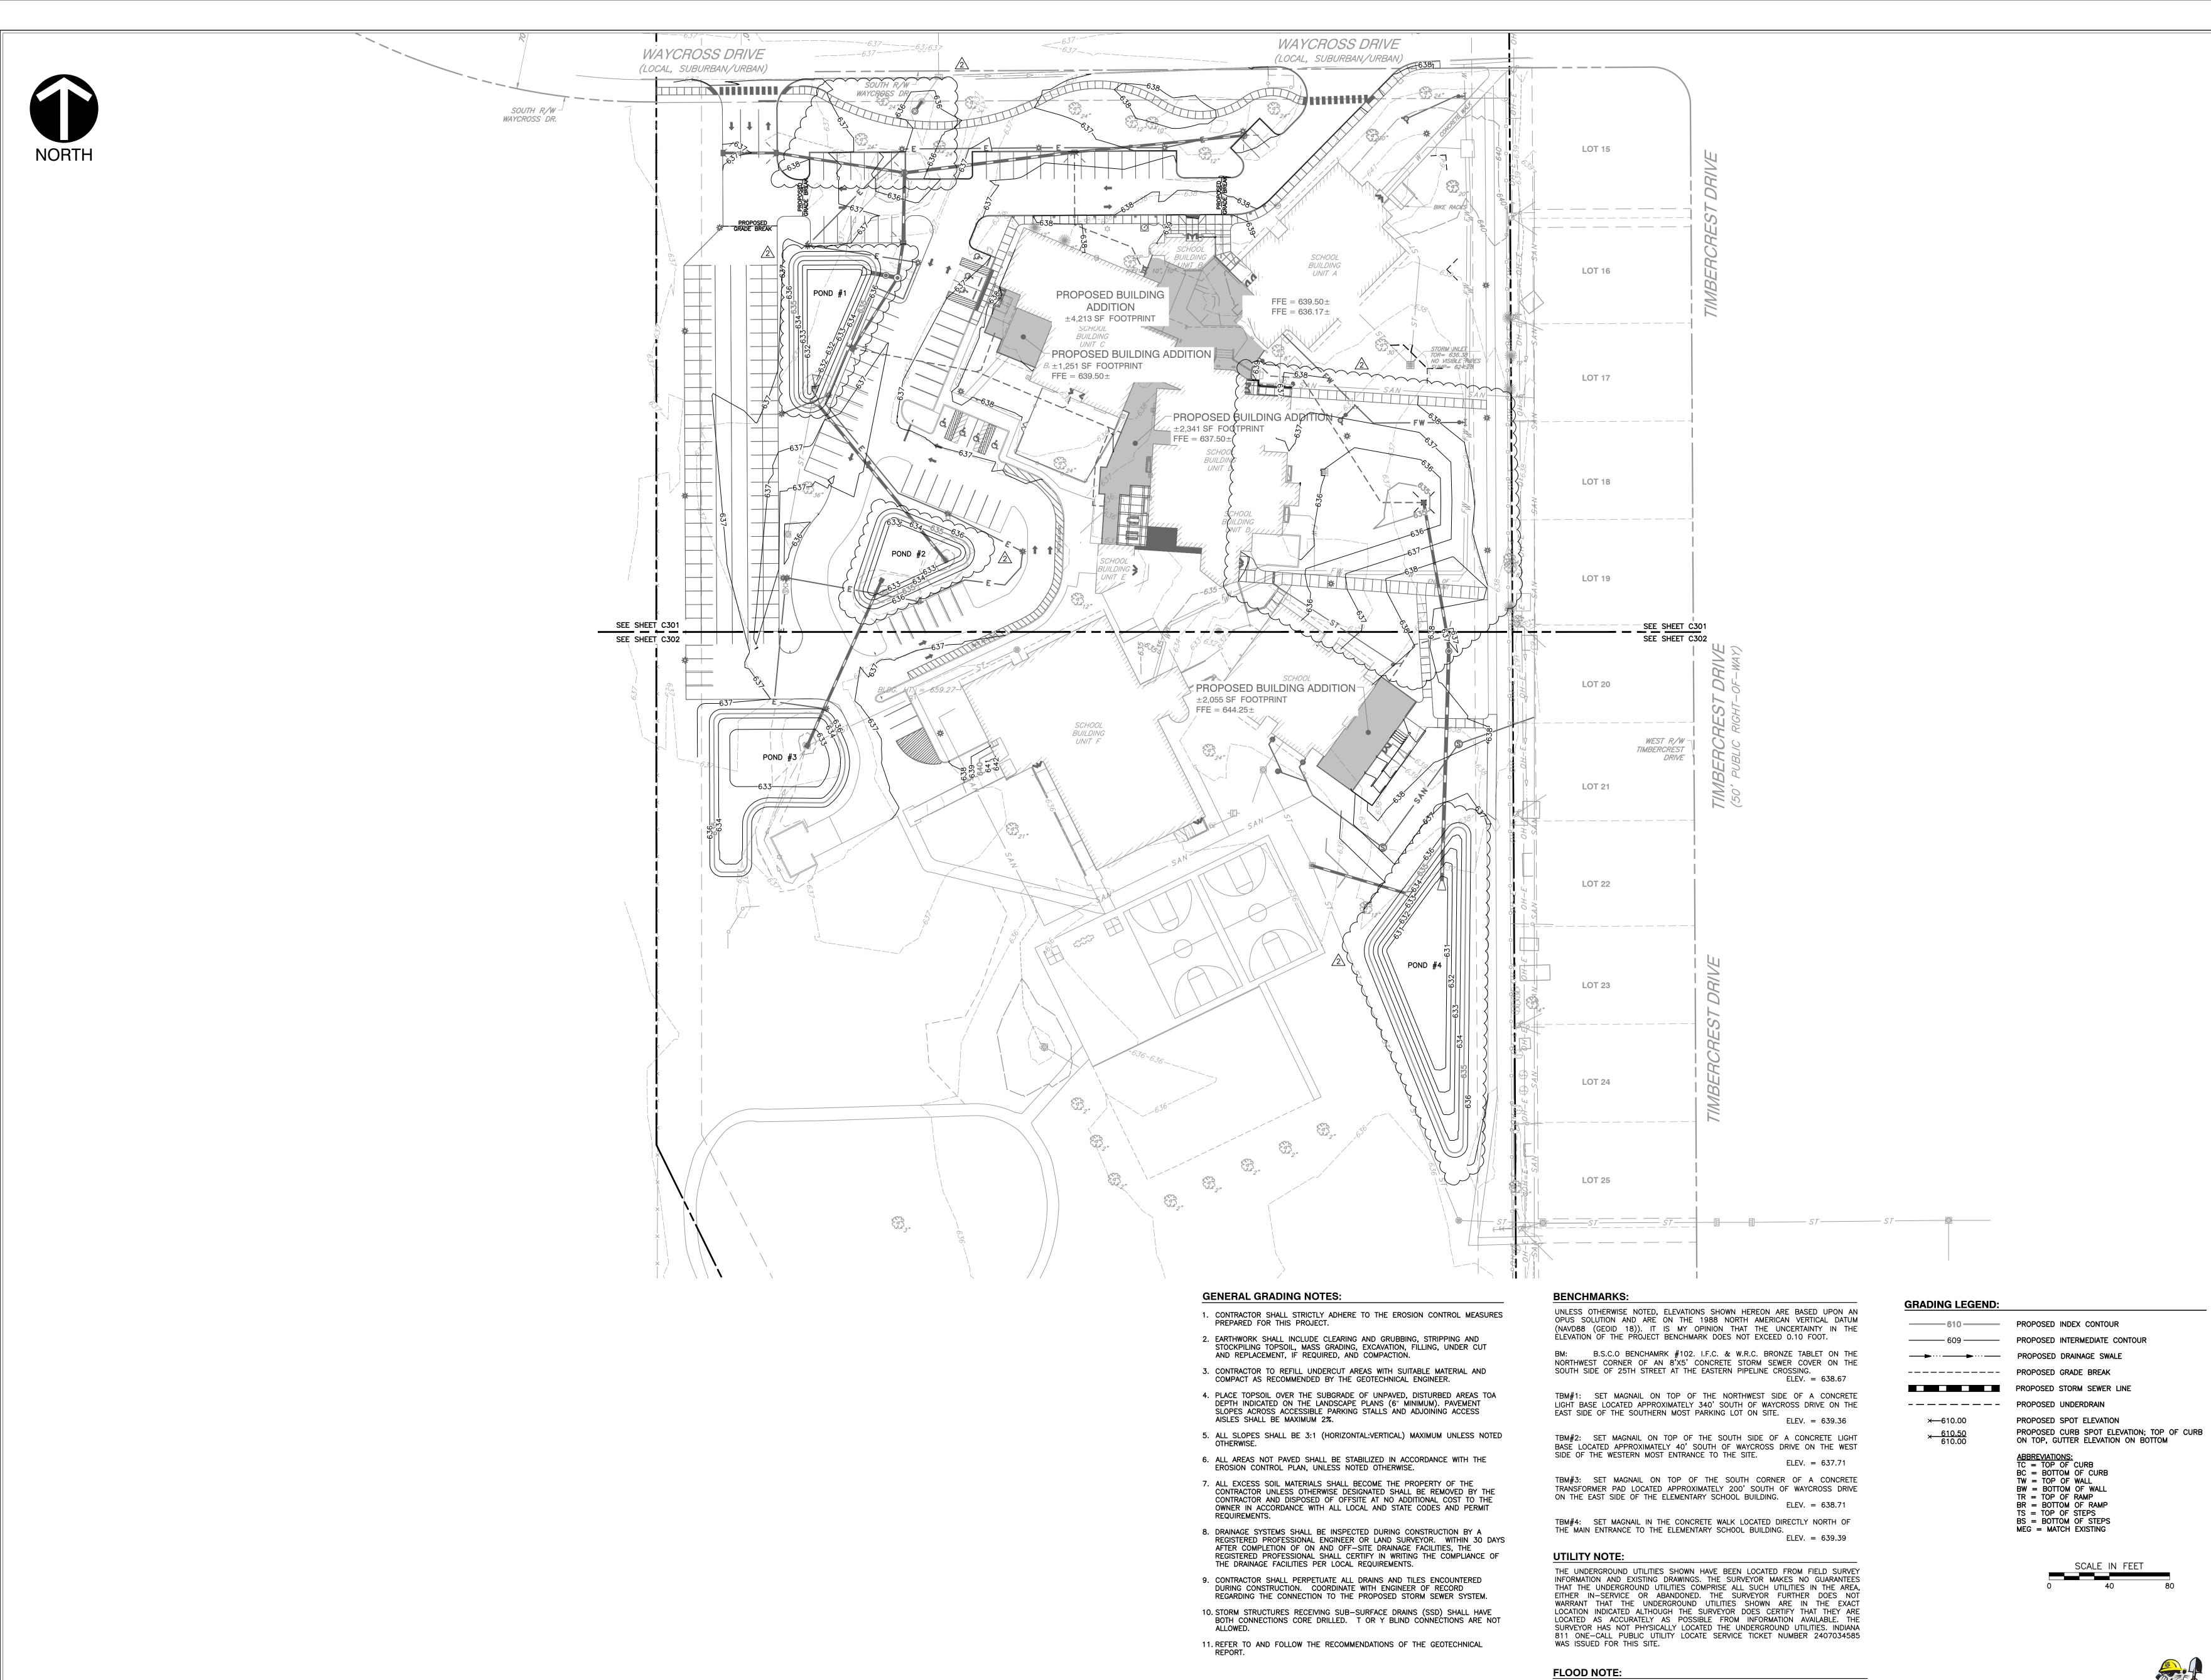
STATE OF

WDIANA

O1/15/25

C102

PROJECT NUMBER 346-935



of structural, mechanical and electrical systems.

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REVISIONS: 02/12/2025 - ADDENDUM #04

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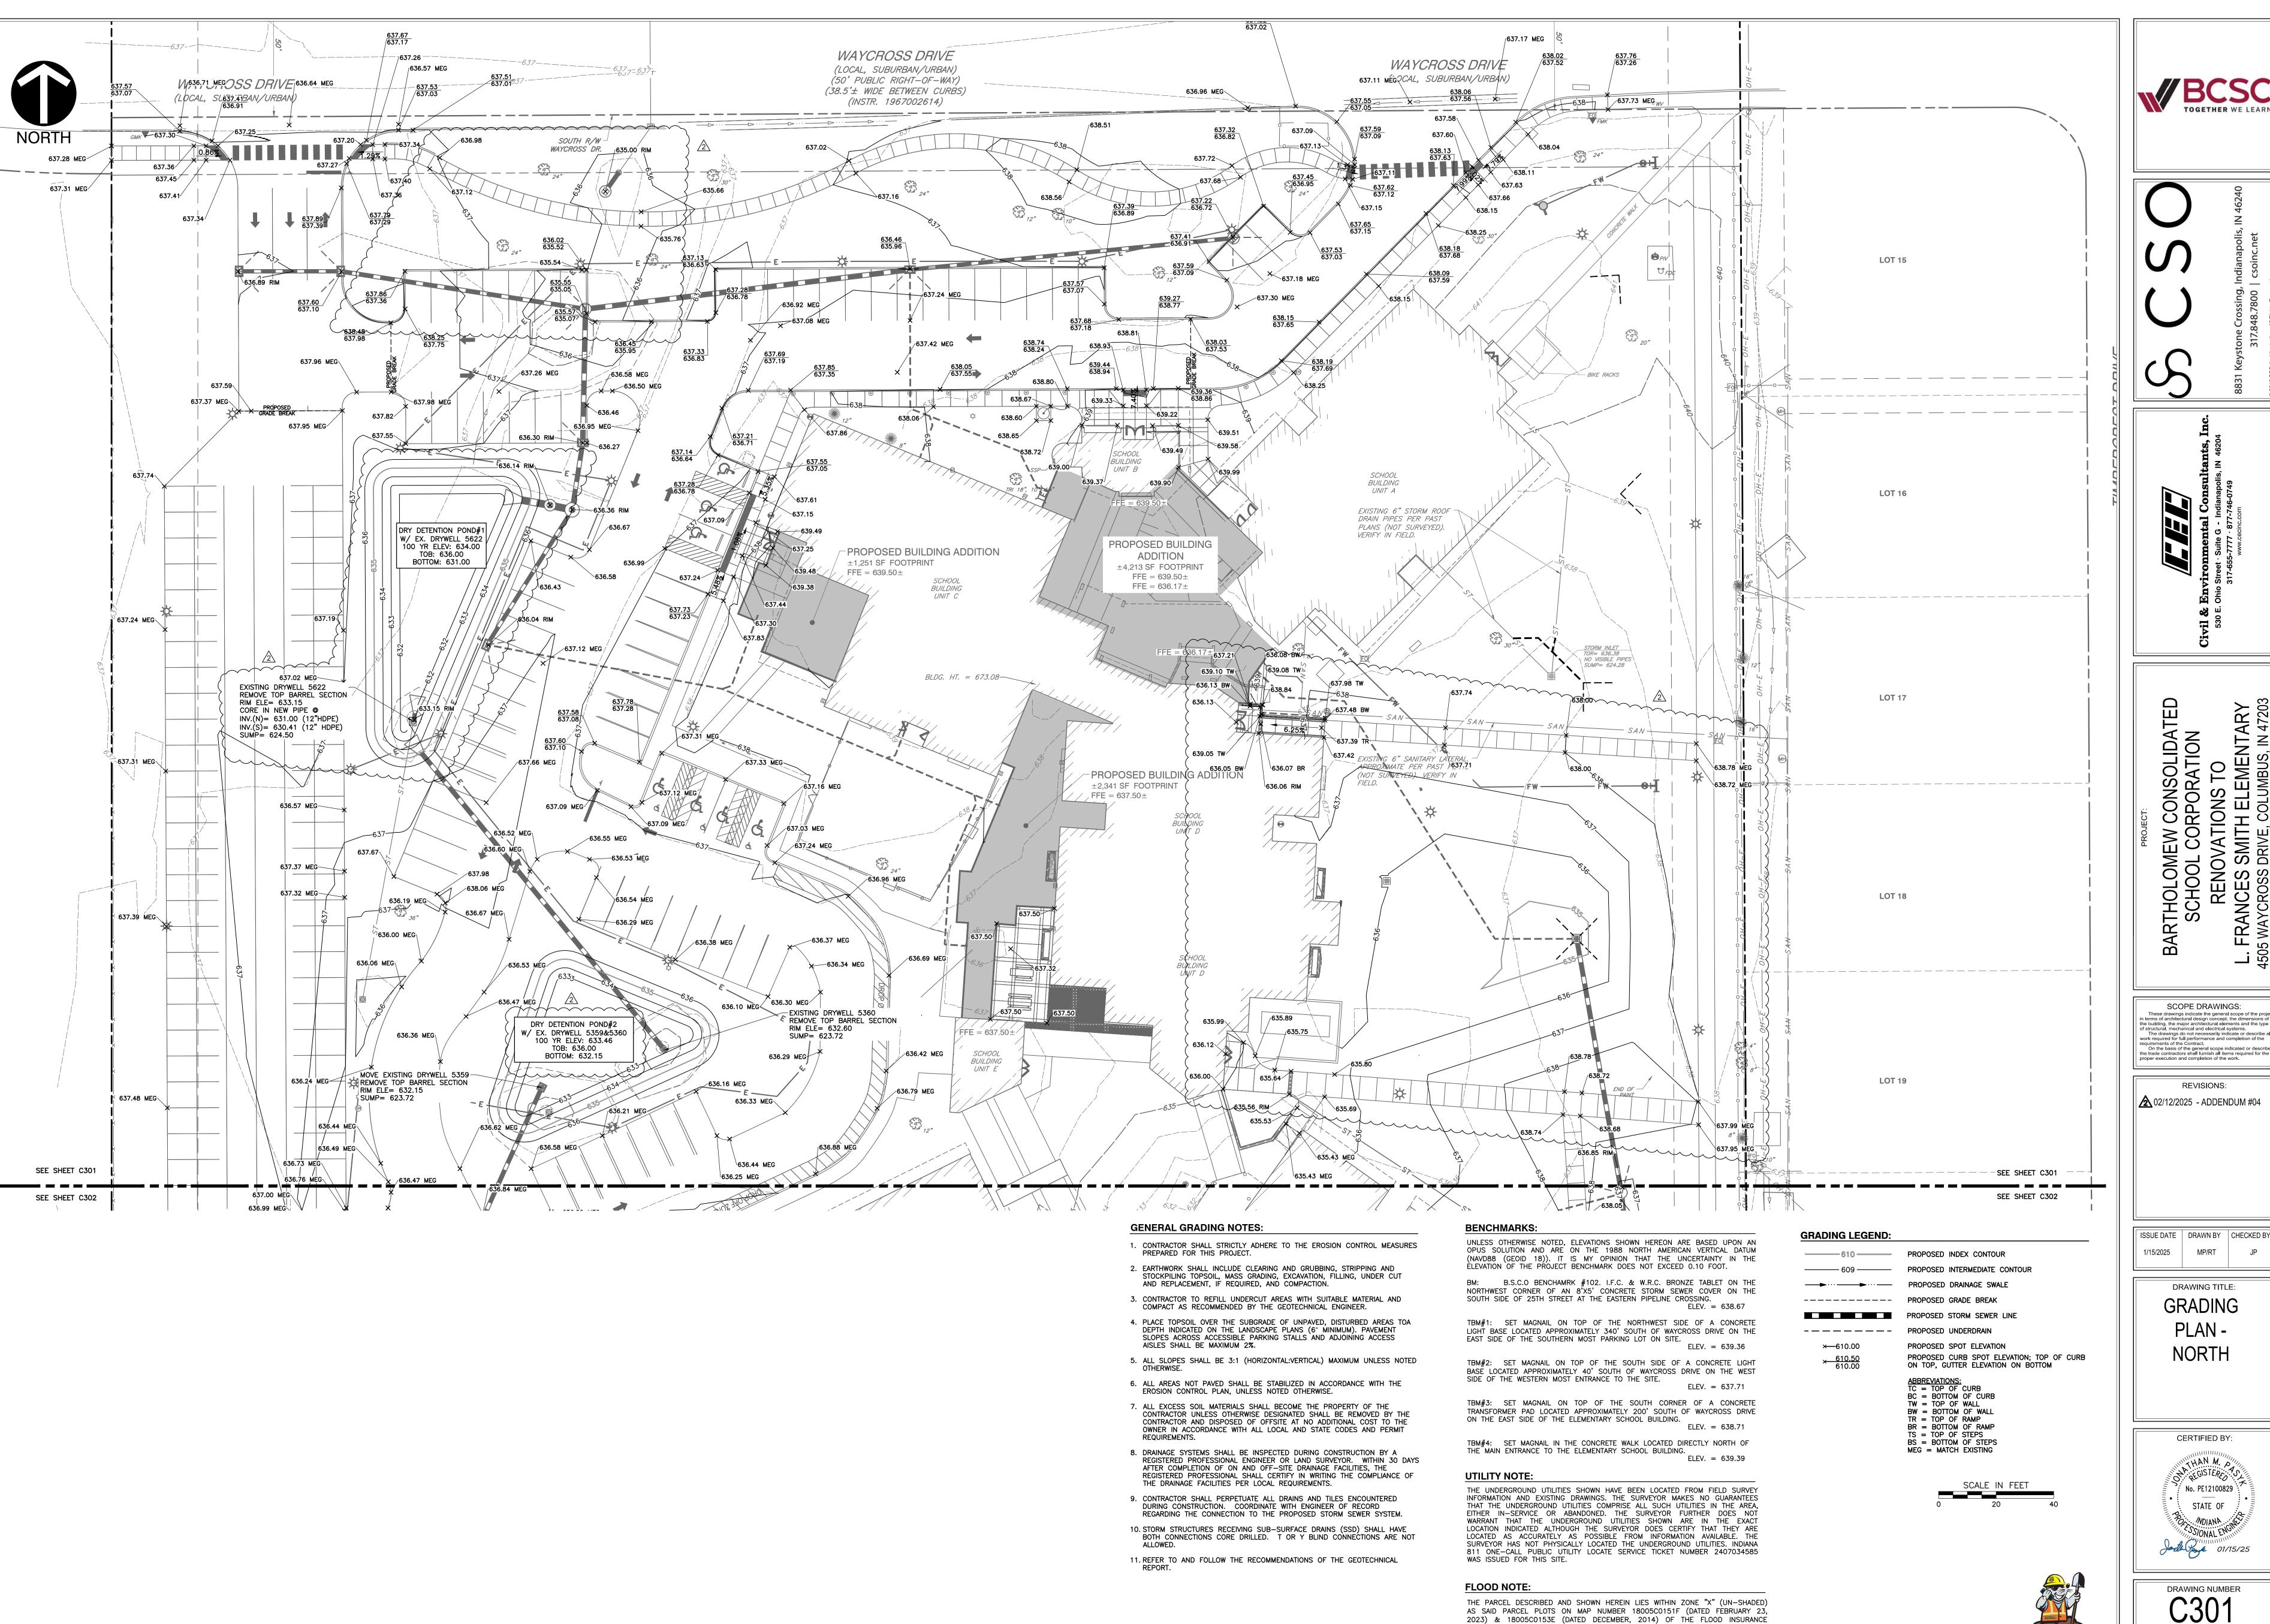
DRAWING TITLE: **OVERALL**

CERTIFIED BY: MAN M. D ON REGISTERS TO No. PE12100829 STATE OF NOIANA ... SSONAL ENGIN Jarle York 01/15/25

DRAWING NUMBER PROJECT NUMBER

Know what's **below. Call** before you dig.

THE PARCEL DESCRIBED AND SHOWN HEREIN LIES WITHIN ZONE "X" (UN-SHADED) AS SAID PARCEL PLOTS ON MAP NUMBER 18005C0151F (DATED FEBRUARY 23, 2023) & 18005C0153E (DATED DECEMBER, 2014) OF THE FLOOD INSURANCE RATE MAPS FOR BARTHOLOMEW COUNTY, INDIANA. THE ACCURACY OF THIS FLOOD HAZARD STATEMENT IS SUBJECT TO MAP SCALE UNCERTAINTY AND TO ANY OTHER UNCERTAINTY IN LOCATION OR ELEVATION ON THE REFERENCED FLOOD INSURANCE





work required for full performance and completion of the

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ISSUE DATE | DRAWN BY | CHECKED BY 1/15/2025 MP/RT

> DRAWING TITLE: GRADING PLAN -


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DRAWING NUMBER

Know what's **below. Call** before you dig.

RATE MAPS FOR BARTHOLOMEW COUNTY, INDIANA. THE ACCURACY OF THIS FLOOD HAZARD STATEMENT IS SUBJECT TO MAP SCALE UNCERTAINTY AND TO ANY OTHER UNCERTAINTY IN LOCATION OR ELEVATION ON THE REFERENCED FLOOD INSURANCE

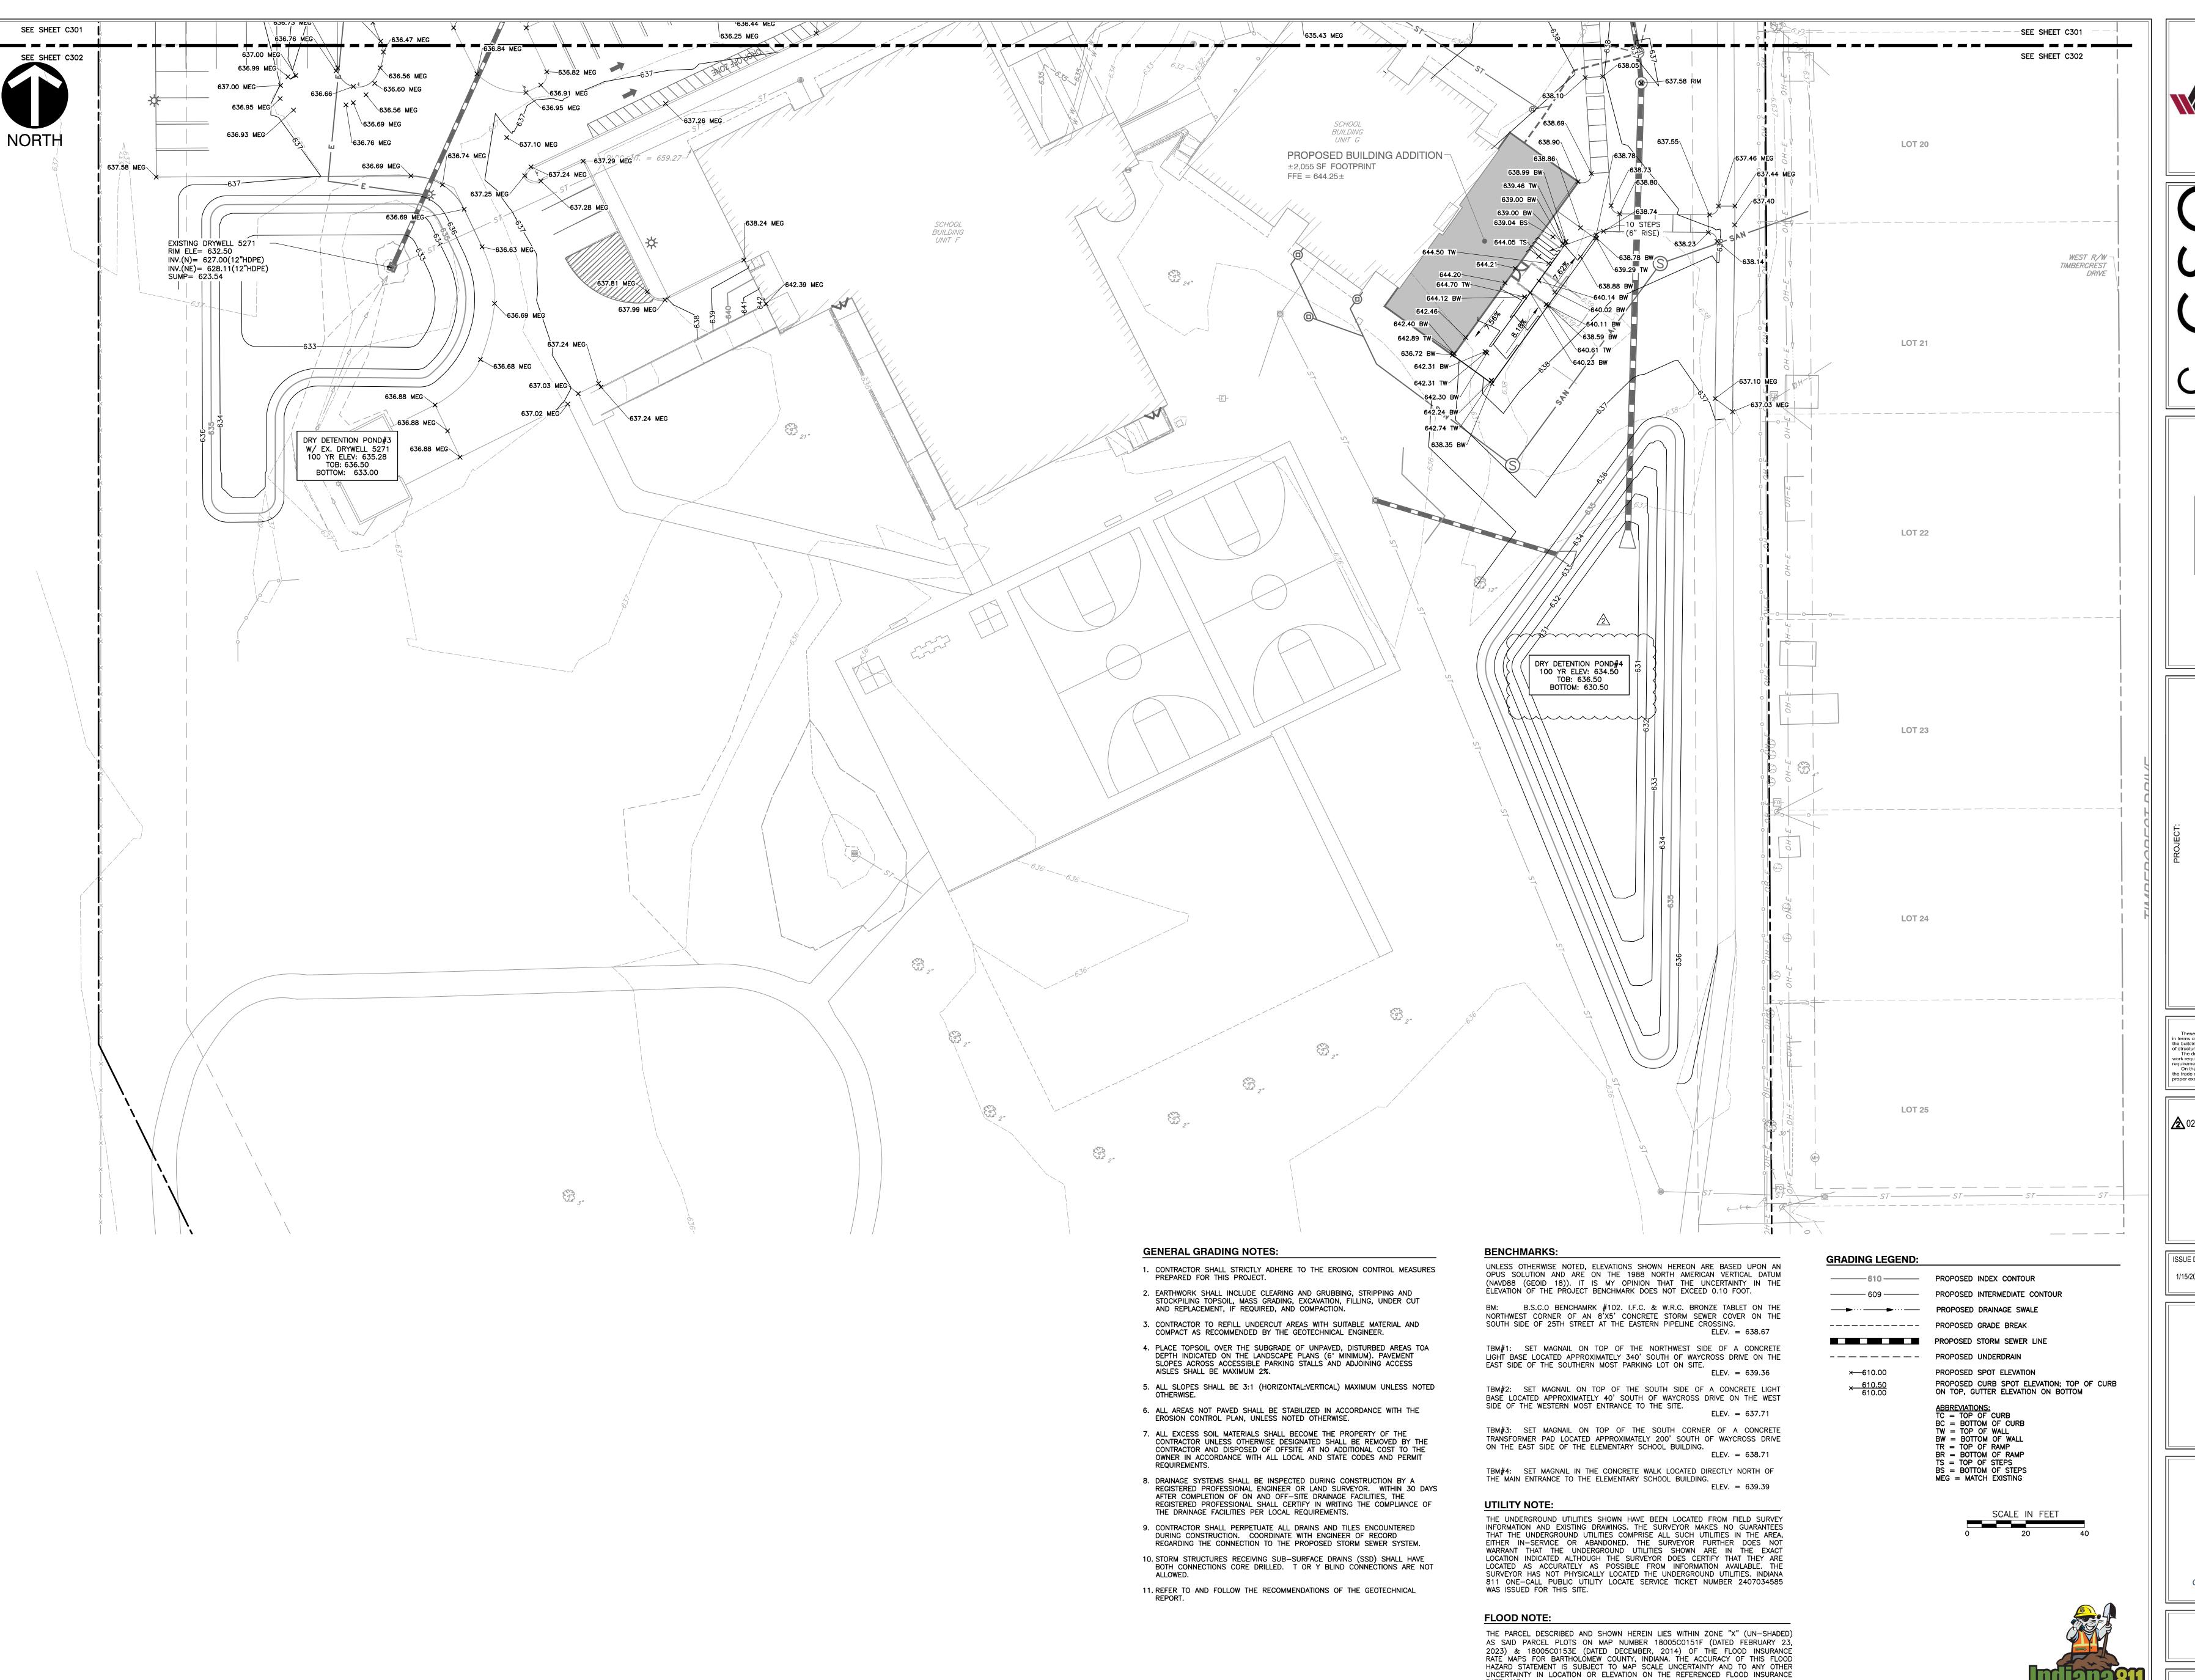RATE MAP.



RATE MAP.

of structural, mechanical and electrical systems.

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REVISIONS:

2 02/12/2025 - ADDENDUM #04

ISSUE DATE | DRAWN BY | CHECKED BY 1/15/2025 MP/RT


DRAWING TITLE:

PLAN -

CERTIFIED BY: MAN M. D ON REGISTERS TO No. PE12100829 STATE OF NOIANA ... SSONAL ENGIN Jest Jank 01/15/25

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02/12/2025 - ADDENDUM #04
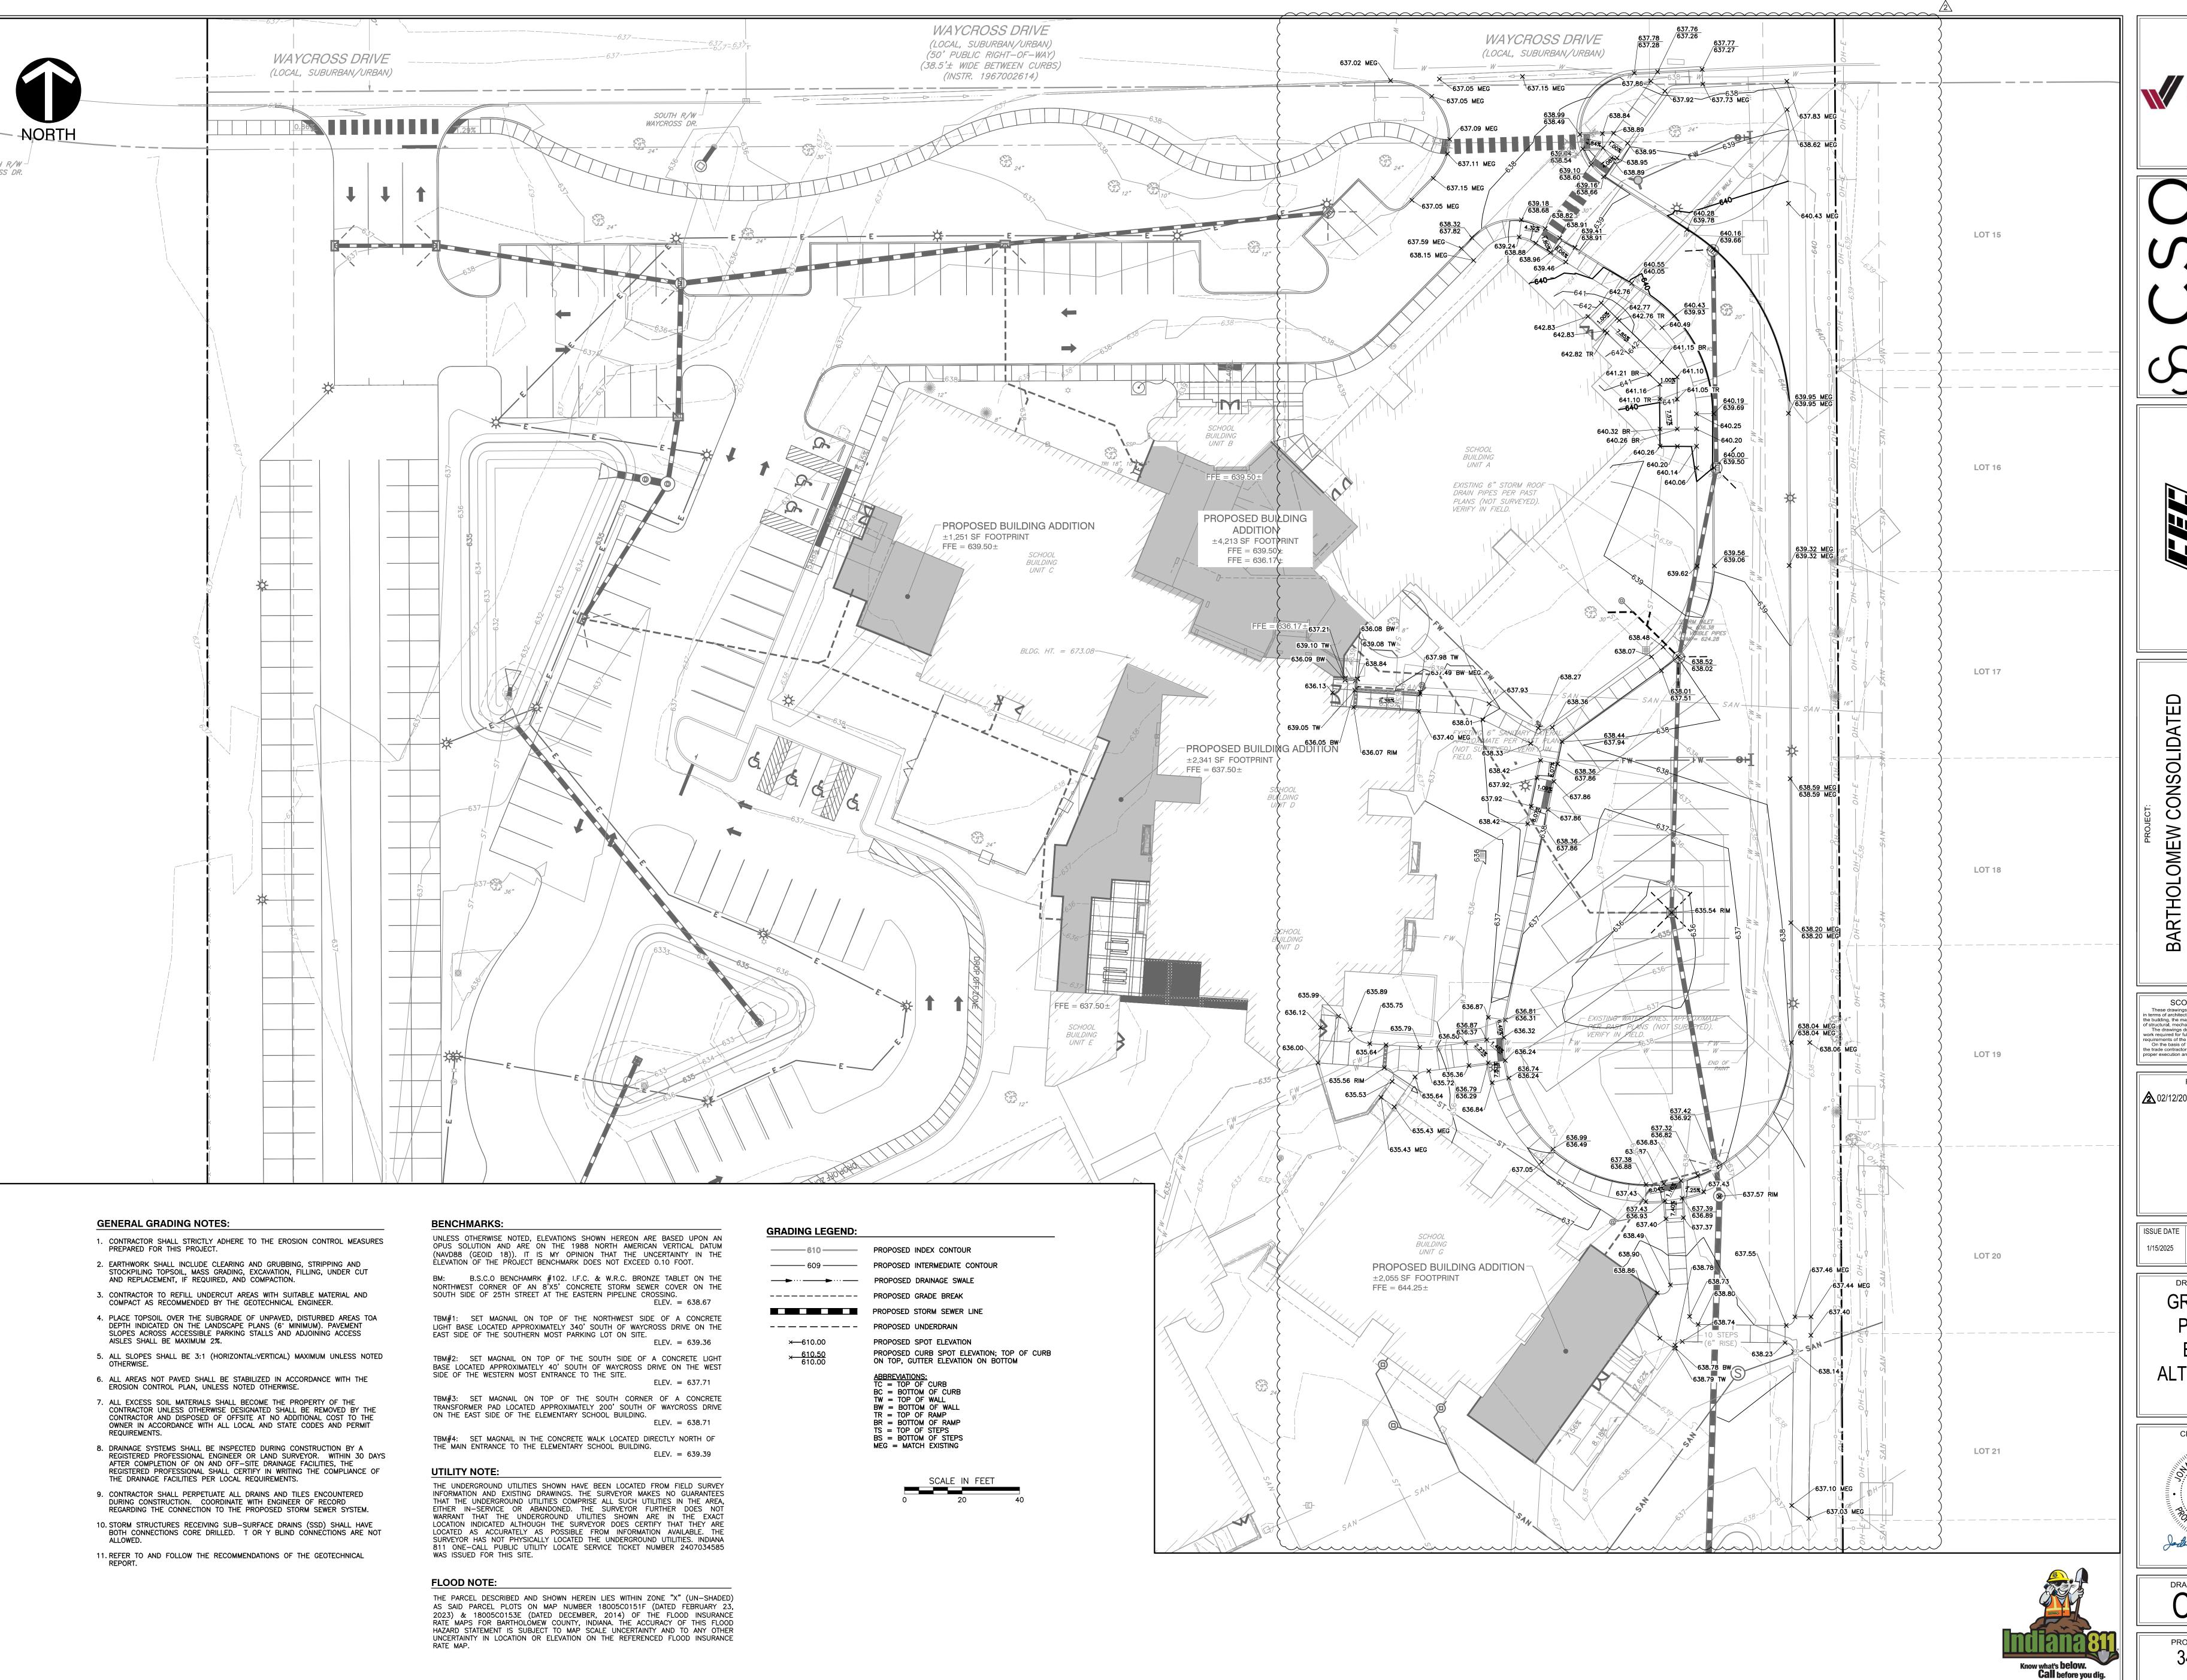
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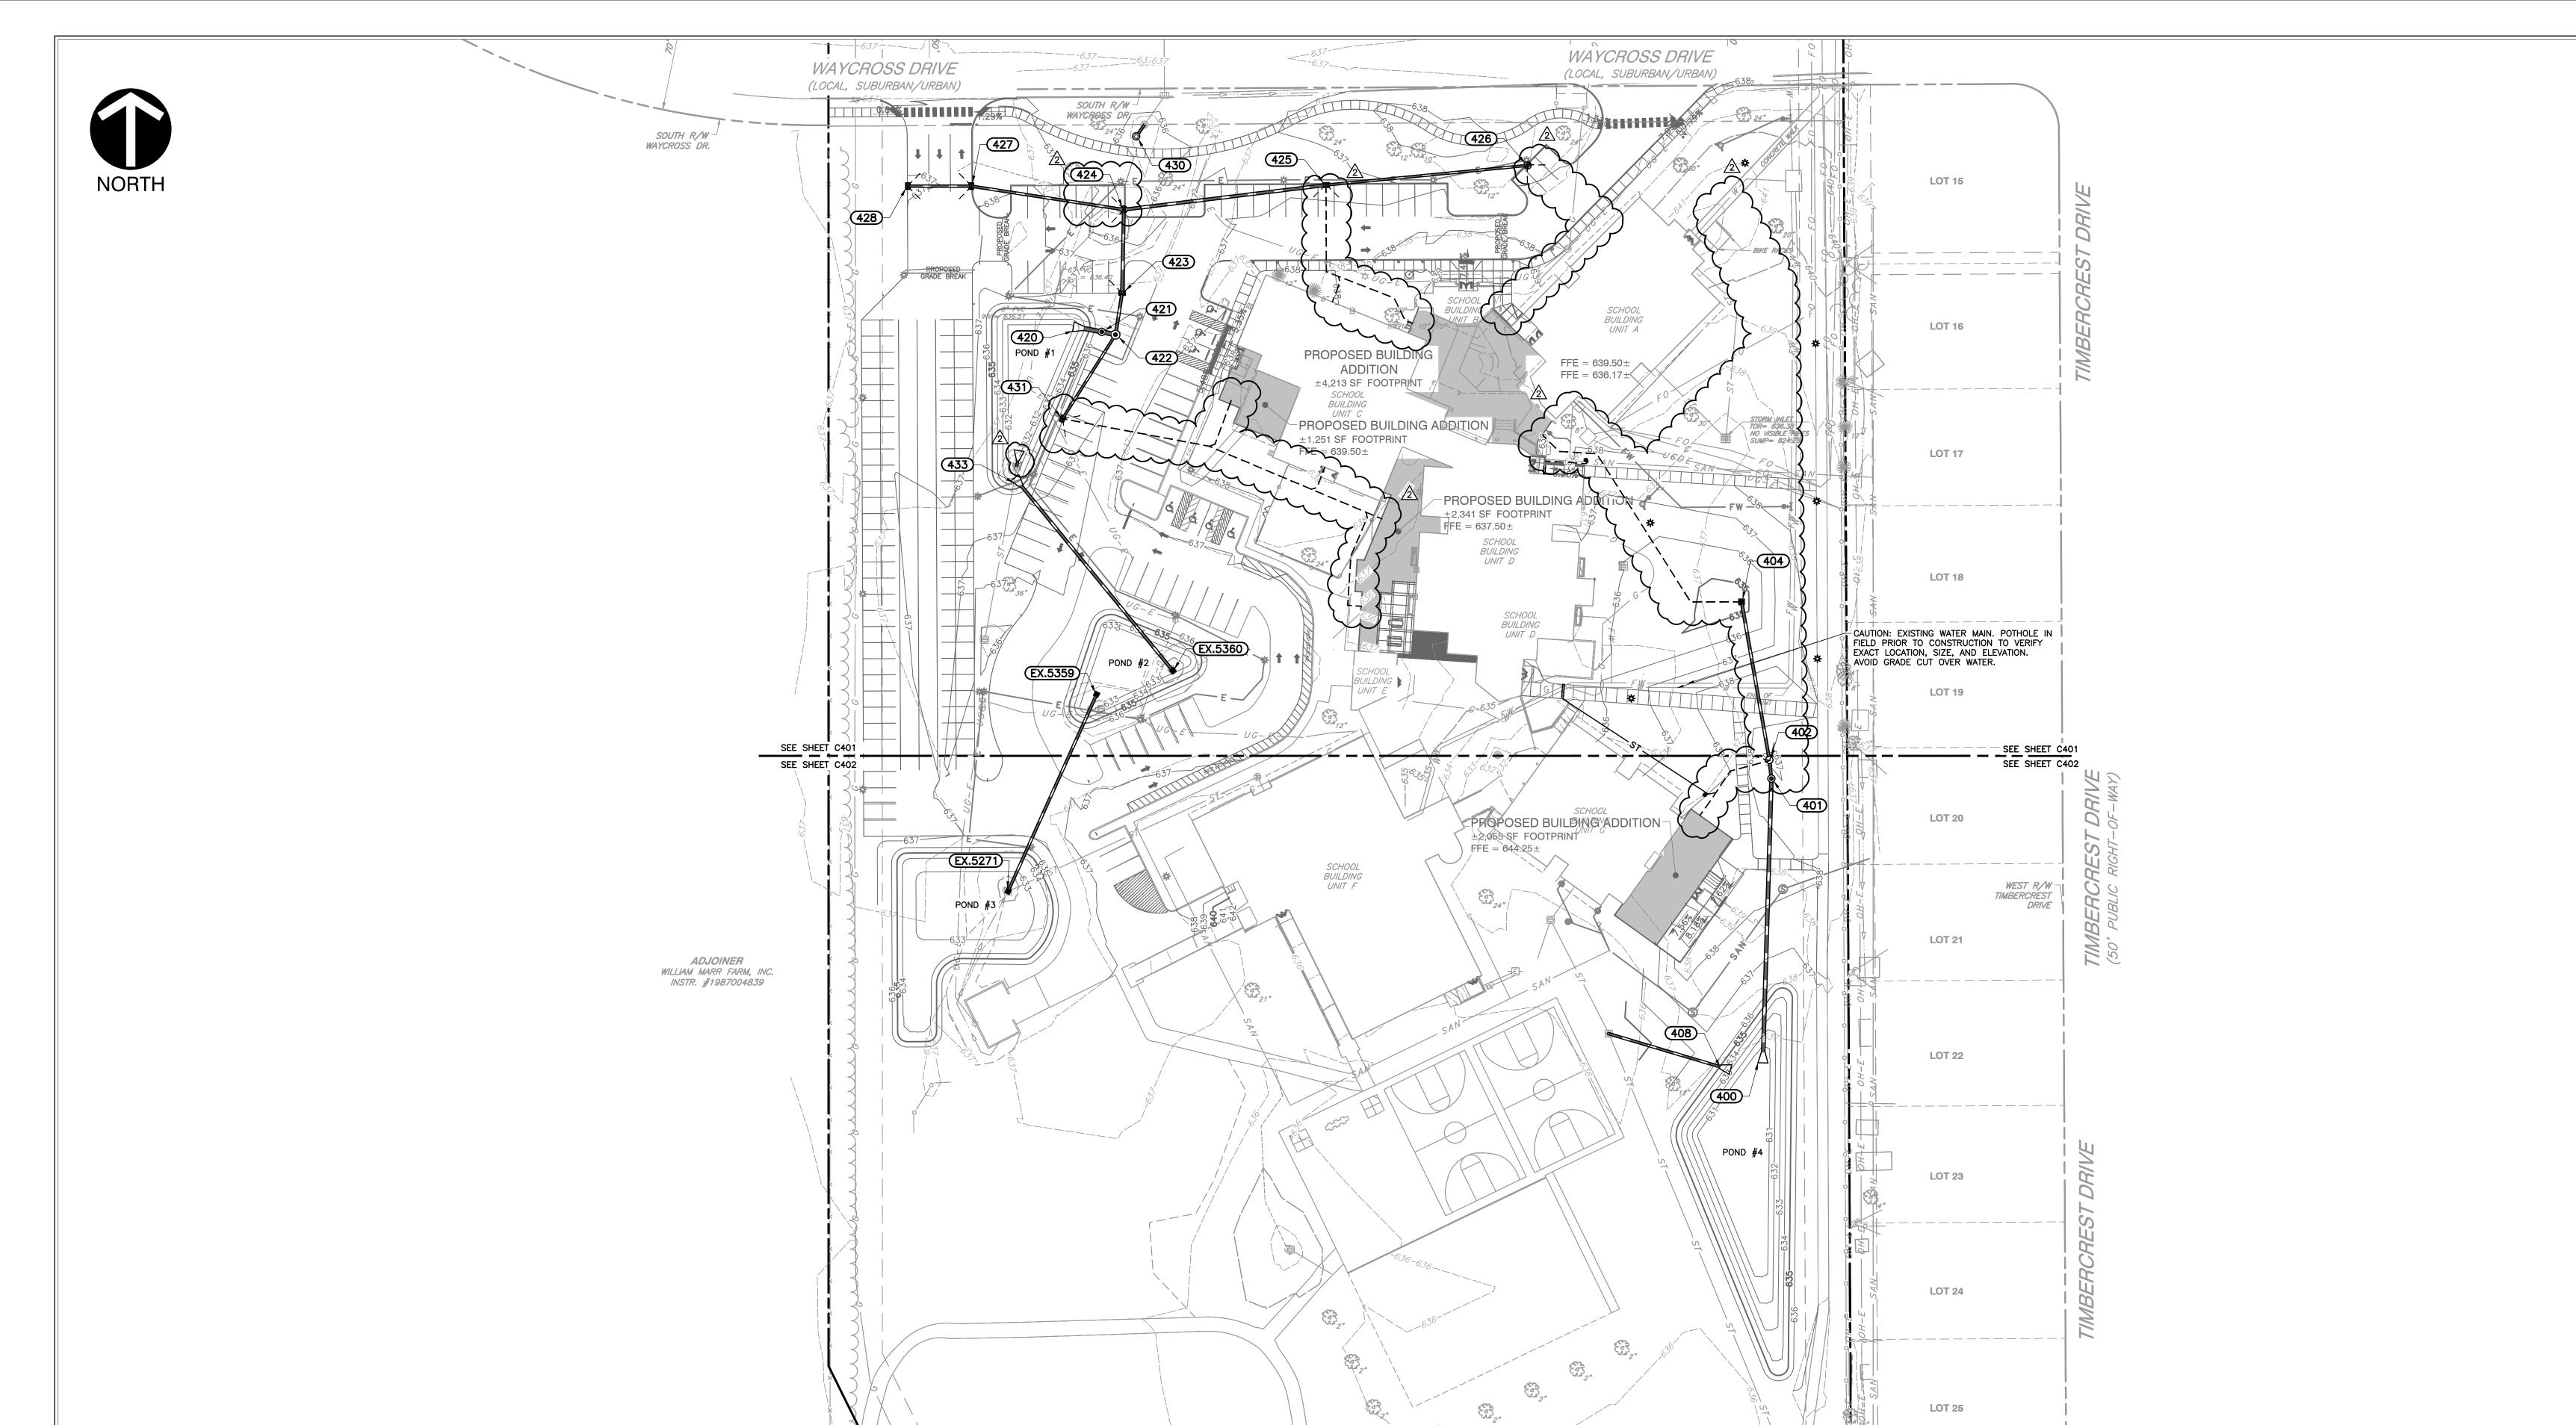
MP/RT

DRAWING TITLE: GRADING

PLAN -ALTERNATE

CERTIFIED BY: M MAH A REGISTERED TO No. PE12100829 STATE OF WDIANA ... SONAL ENGIN Joseph 01/15/25

DRAWING NUMBER



Structure Name	RIM E.	INVERT IN	INVERT OUT	REMARKS
EX.5359	632.15		EX.5359 = 629.00	RELOCATE EXISTING DRYWELL 5359
EX.5360	632.60	EX.5360 = 629.50		CONNECT TO EXISTING DRYWELL 5360
EX.5271	633.00	EX.5359 = 627.00		CONNECT TO EXISTING DRYWELL 5271
400	632.29	401 = 630.50		CONCRETE END SECTION
401	637.57	402 = 631.06	401 = 630.96	AQUASWIRL XC-2 UNIT NEENAH R-1772
402	636.92	404 = 631.19	402 = 631.09	TYPE C MANHOLE NEENAH R-3287-10V
404	634.44	405 = 631.56	404 = 631.46	TYPE M INLET NEENAH R-3455-C
408	636.50		408 = 635.25	CONCRETE END SECTION
409	631.73	408 = 630.50		Null Structure
420	634.24	421 = 632.00		CONCRETE END SECTION
421	636.44	422 = 632.01	421 = 632.01	AQUASWIRL XC-3 UNIT NEENAH R-1772
422	636.51	431 = 632.12 423 = 632.12	422 = 632.02	TYPE C MANHOLE NEENAH R-1772
423	636.30	424 = 632.29	423 = 632.19	TYPE M INLET NEENAH R-3287-10V
424	635.10	427 = 632.54 425 = 632.54	424 = 632.44	TYPE C MANHOLE NEENAH R-3287-10V
425	636.00	426 = 632.92	425 = 632.82	TYPE M INLET NEENAH R-3287-SB10
426	636.68		426 = 633.22	TYPE C MANHOLE NEENAH R-3287-SB10
427	637.10	428 = 632.92	427 = 632.82	TYPE M INLET NEENAHR-3287-10V

428 = 633.02

431 = 632.31

428

430

431

433 | 634.19 |

636.89

440 | 632.19 | 440 = 631.00

635.00 430 = 631.80

Structure Table

TYPE J INLET NEENAH R-3287-10V

4'ø DRY WELL & STONE NEENAH R4372

TYPE J INLET
NEENAH R-3287-SB10

CONCRETE END SECTION

EX.5360 = 632.75 | CONCRETE END SECTION

	EX.5359	12	120.5	1.66%	HDPE	\
	EX.5360	15	132.9	2.44%	HDPE	1
60	401	18	152.5	0.30%	HDPE	\
G	402	15	10.5	0.30%	HDPE	1
ON.	404	15	89.5	0.30%	HDPE	1
IT	408	12	64.5	7.36%	HDPE	1
	421	24	9.9	0.11%	HDPE	\
,	422	24	7.9	0.11%	HDPE	\
∸	423	15	23.6	0.30%	HDPE	1
	424	15	46.5	0.33%	CLASS V RCP	\
NC	425	15	113.6	0.25%	CLASS V RCP	\
	426	12	113.0	0.26%	HDPE	\
NC	427	12	86.1	0.33%	CLASS V RCP	\
IT	428	12	35.3	0.26%	HDPE	1
_	430	12	8.0	2.06%	HDPE	\
	431	12	55.5	0.35%	HDPE	1
	440	12	3.0	0.00%	HDPE	\
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Pipe Name Size (in) Length (ft) Slope MATERIAL

GENERAL DRAINAGE NOTES:

- DISTANCES SHOWN ON PIPING ARE HORIZONTAL DISTANCES FROM CENTER OF STRUCTURE TO CENTER OF STRUCTURE, UNLESS OTHERWISE NOTED.
 THE CONTRACTOR SHALL BE RESPONSIBLE FOR ALL COSTS ASSOCIATED WITH THE INSTALLATION, INSPECTION, TESTING AND FINAL ACCEPTANCE OF ALL NEW STORMWATER MANAGEMENT FACILITIES CONSTRUCTION. CONTRACTOR SHALL COORDINATE WITH ALL APPLICABLE REGULATING AGENCIES CONCERNING INSTALLATION, INSPECTION AND APPROVAL OF THE STORM DRAINAGE SYSTEM CONSTRUCTION.
- ALL STORMWATER MANAGEMENT FACILITIES, INCLUDING COLLECTION AND CONVEYANCE STRUCTURES SHALL BE INSTALLED IN ACCORDANCE WITH ALL APPLICABLE LOCAL AND STATE CODES AND REGULATIONS.
 ANY WORK PERFORMED IN THE LOCAL OR STATE RIGHT OF WAYS SHALL BE IN ACCORDANCE WITH THE APPLICABLE LOCAL OR STATE REQUIREMENTS. IT SHALL BE THE CONTRACTOR'S RESPONSIBILITY TO OBTAIN THE NECESSARY PERMITS FOR THE WORK, SCHEDULE NECESSARY INSPECTIONS, AND PROVIDE THE NECESSARY TRAFFIC CONTROL MEASURES AND DEVICES, ETC., FOR
- 5. ALL PROPOSED STORM SEWER AND DRAINAGE APPURTENANCES SHALL BE IN CONFORMANCE WITH THE CITY OF COLUMBUS STORMWATER TECHNICAL STANDARDS MANUAL, LATEST EDITION. DISCREPANCIES BETWEEN THE PLANS AND THE MANUAL SHALL NOT ALLEVIATE THE CONTRACTOR FROM ADHERING TO THE REQUIREMENTS AS SET FORTH IN THE MANUAL.

WORK PERFORMED IN THE RIGHT OF WAYS.

BENCHMARKS: UNLESS OTHERWISE NOTED, ELEVATIONS SHOWN HEREON ARE BASED UPON AN

OPUS SOLUTION AND ARE ON THE 1988 NORTH AMERICAN VERTICAL DATUM (NAVD88 (GEOID 18)). IT IS MY OPINION THAT THE UNCERTAINTY IN THE ELEVATION OF THE PROJECT BENCHMARK DOES NOT EXCEED 0.10 FOOT.

BM: B.S.C.O BENCHAMRK #102. I.F.C. & W.R.C. BRONZE TABLET ON THE NORTHWEST CORNER OF AN 8'X5' CONCRETE STORM SEWER COVER ON THE SOUTH SIDE OF 25TH STREET AT THE EASTERN PIPELINE CROSSING.

TBM#1: SET MAGNAIL ON TOP OF THE NORTHWEST SIDE OF A CONCRETE LIGHT BASE LOCATED APPROXIMATELY 340' SOUTH OF WAYCROSS DRIVE ON THE EAST SIDE OF THE SOUTHERN MOST PARKING LOT ON SITE.

ELEV. = 639.36

TBM#2: SET MAGNAIL ON TOP OF THE SOUTH SIDE OF A CONCRETE LIGHT BASE LOCATED APPROXIMATELY 40' SOUTH OF WAYCROSS DRIVE ON THE WEST SIDE OF THE WESTERN MOST ENTRANCE TO THE SITE.

TBM#3: SET MAGNAIL ON TOP OF THE SOUTH CORNER OF A CONCRETE TRANSFORMER PAD LOCATED APPROXIMATELY 200' SOUTH OF WAYCROSS DRIVE ON THE EAST SIDE OF THE ELEMENTARY SCHOOL BUILDING.

ELEV. = 638.71

TBM#4: SET MAGNAIL IN THE CONCRETE WALK LOCATED DIRECTLY NORTH OF THE MAIN ENTRANCE TO THE ELEMENTARY SCHOOL BUILDING.

ELEV. = 639.39

INFORMATION AND EXISTING DRAWINGS. THE SURVEYOR MAKES NO GUARANTEES THAT THE UNDERGROUND UTILITIES COMPRISE ALL SUCH UTILITIES IN THE AREA, EITHER IN—SERVICE OR ABANDONED. THE SURVEYOR FURTHER DOES NOT WARRANT THAT THE UNDERGROUND UTILITIES SHOWN ARE IN THE EXACT LOCATION INDICATED ALTHOUGH THE SURVEYOR DOES CERTIFY THAT THEY ARE LOCATED AS ACCURATELY AS POSSIBLE FROM INFORMATION AVAILABLE. THE SURVEYOR HAS NOT PHYSICALLY LOCATED THE UNDERGROUND UTILITIES. INDIANA 811 ONE—CALL PUBLIC UTILITY LOCATE SERVICE TICKET NUMBER 2407034585 WAS ISSUED FOR THIS SITE.

THE UNDERGROUND UTILITIES SHOWN HAVE BEEN LOCATED FROM FIELD SURVEY

FLOOD NOTE:

UTILITY NOTE:

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DRAINAGE LEGEND:

	PROPOSED STORM SEWER L
	PROPOSED UNDERDRAIN
	PROPOSED ROOF DRAINS
	PROPOSED DRAINAGE SWALE
 610 	PROPOSED INDEX CONTOUR

PROPOSED INTERMEDIATE OF PROPOSED STORM MANHOLE PROPOSED STORM INLETS

PROPOSED UNDERDRAIN
PROPOSED ROOF DRAINS
PROPOSED DRAINAGE SWALE
PROPOSED INDEX CONTOUR
PROPOSED INTERMEDIATE CONTOUR
PROPOSED STORM MANHOLE, CURB INLET

SCALE IN FEET

40



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PORATION

NS TO

ELEMENTARY

DI UMBUS, IN 47203

SCOPE DRAWINGS:

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REVISIONS:

202/12/2025 - ADDENDUM #04

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DRAWING TITLE:

OVERALL

DRAINAGE

CERTIFIED BY:

No. PE12100829

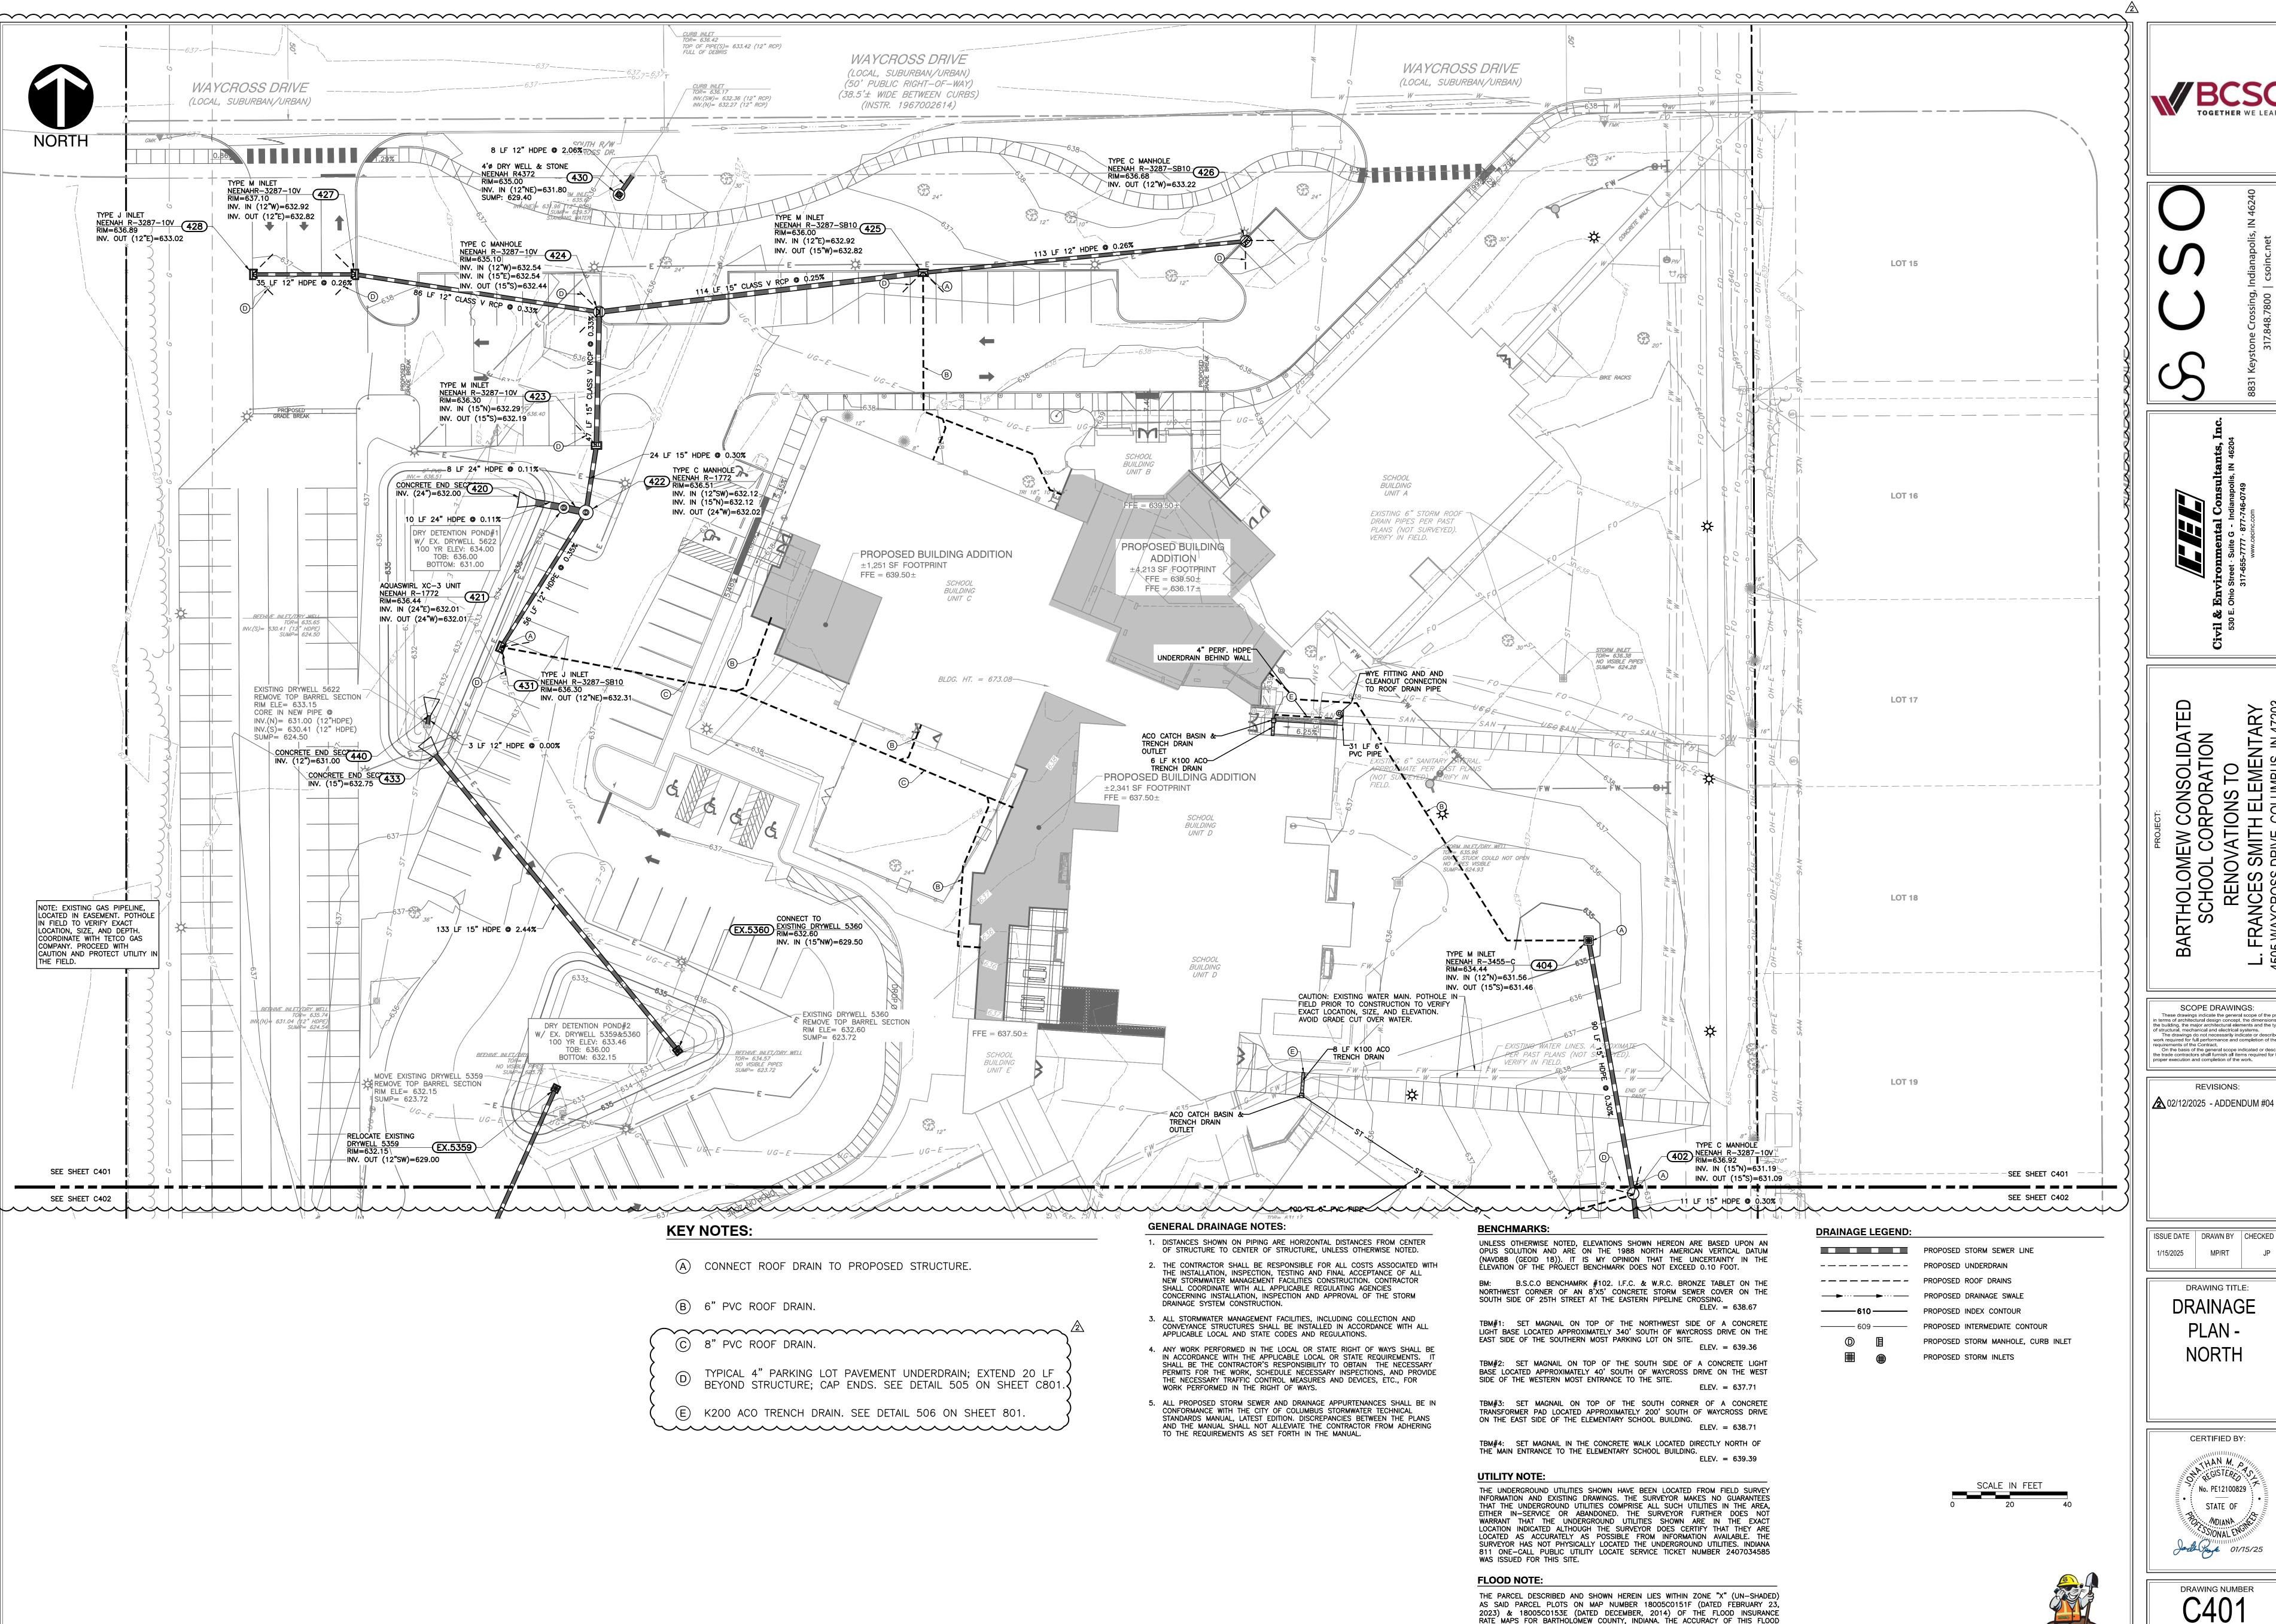
STATE OF

WDIANA

O1/15/25

DRAWING NUMBER

PROJECT NUMBER 346-935



ISSUE DATE | DRAWN BY | CHECKED BY MP/RT

> DRAWING TITLE: DRAINAGE PLAN -NORTH


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PROJECT NUMBER

Know what's **below. Call** before you dig.

HAZARD STATEMENT IS SUBJECT TO MAP SCALE UNCERTAINTY AND TO ANY OTHER UNCERTAINTY IN LOCATION OR ELEVATION ON THE REFERENCED FLOOD INSURANCE

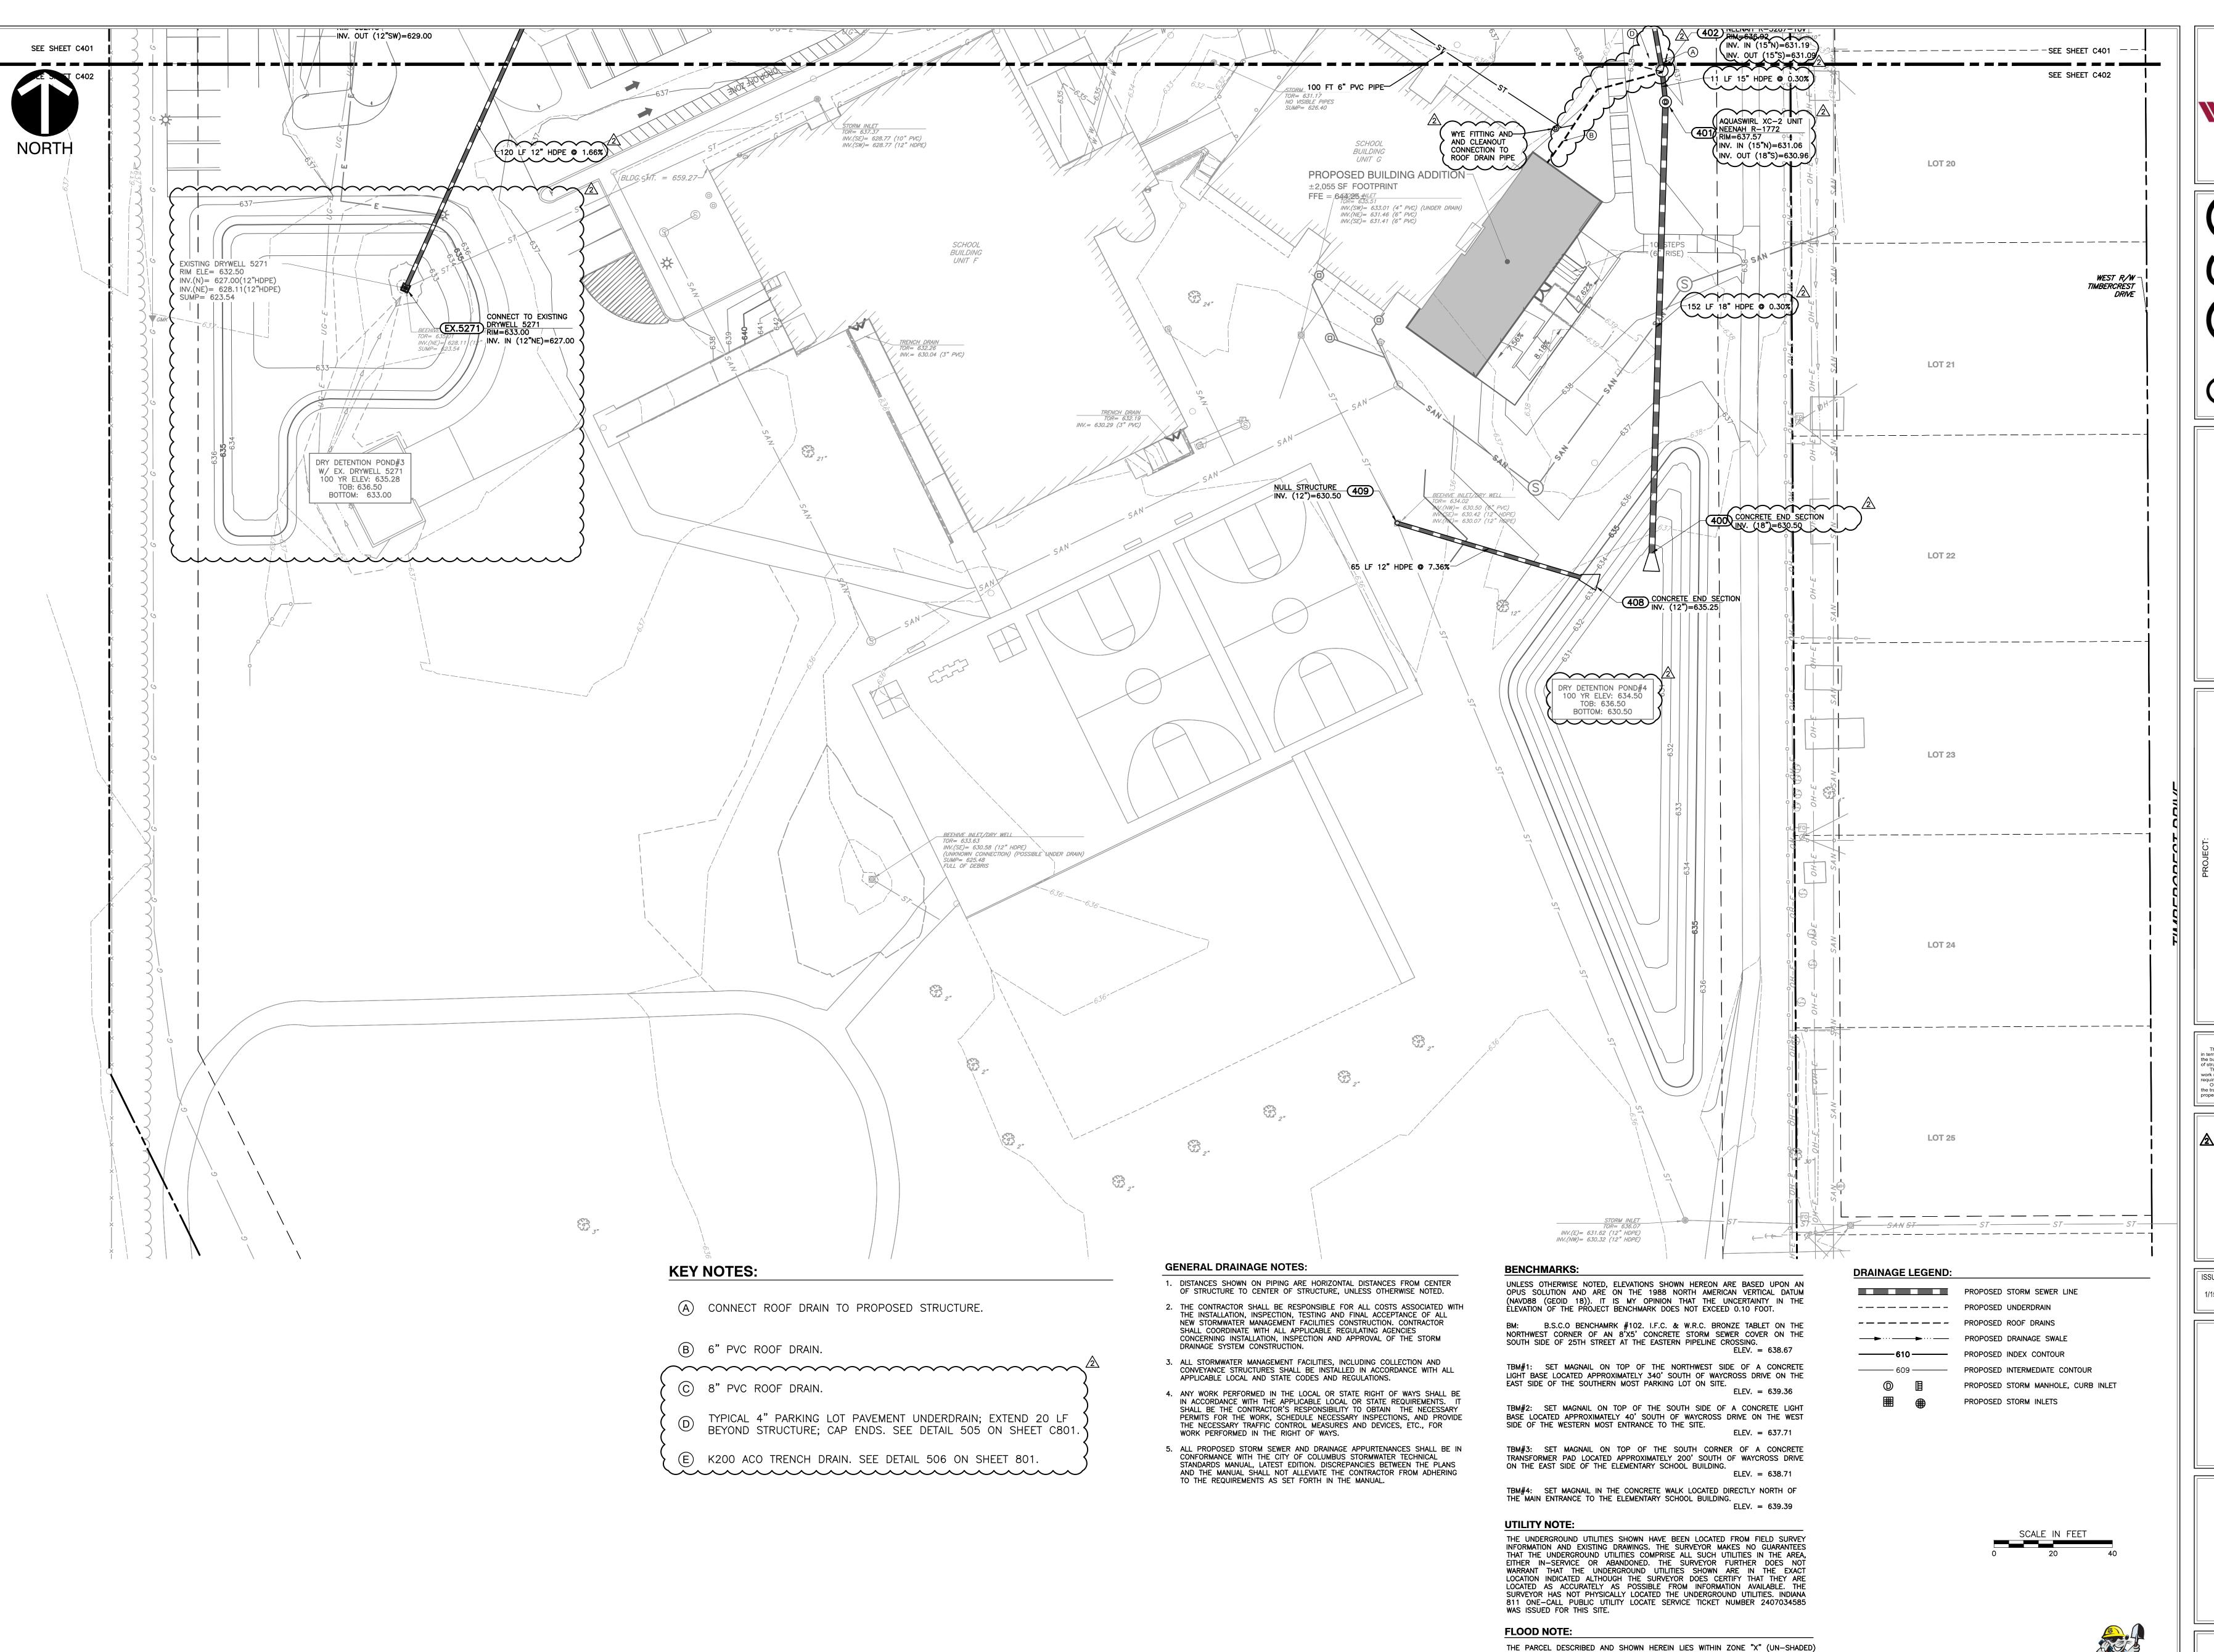RATE MAP.



work required for full performance and completion of the requirements of the Contract.

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REVISIONS: 2 02/12/2025 - ADDENDUM #04

ISSUE DATE | DRAWN BY | CHECKED BY

1/15/2025 MP/RT

DRAWING TITLE: DRAINAGE PLAN -


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Jest Jank 01/15/25 DRAWING NUMBER

Know what's **below**. **Call** before you dig.

AS SAID PARCEL PLOTS ON MAP NUMBER 18005C0151F (DATED FEBRUARY 23. 2023) & 18005C0153E (DATED DECEMBER, 2014) OF THE FLOOD INSURANCE RATE MAPS FOR BARTHOLOMEW COUNTY, INDIANA. THE ACCURACY OF THIS FLOOD HAZARD STATEMENT IS SUBJECT TO MAP SCALE UNCERTAINTY AND TO ANY OTHER UNCERTAINTY IN LOCATION OR ELEVATION ON THE REFERENCED FLOOD INSURANCE

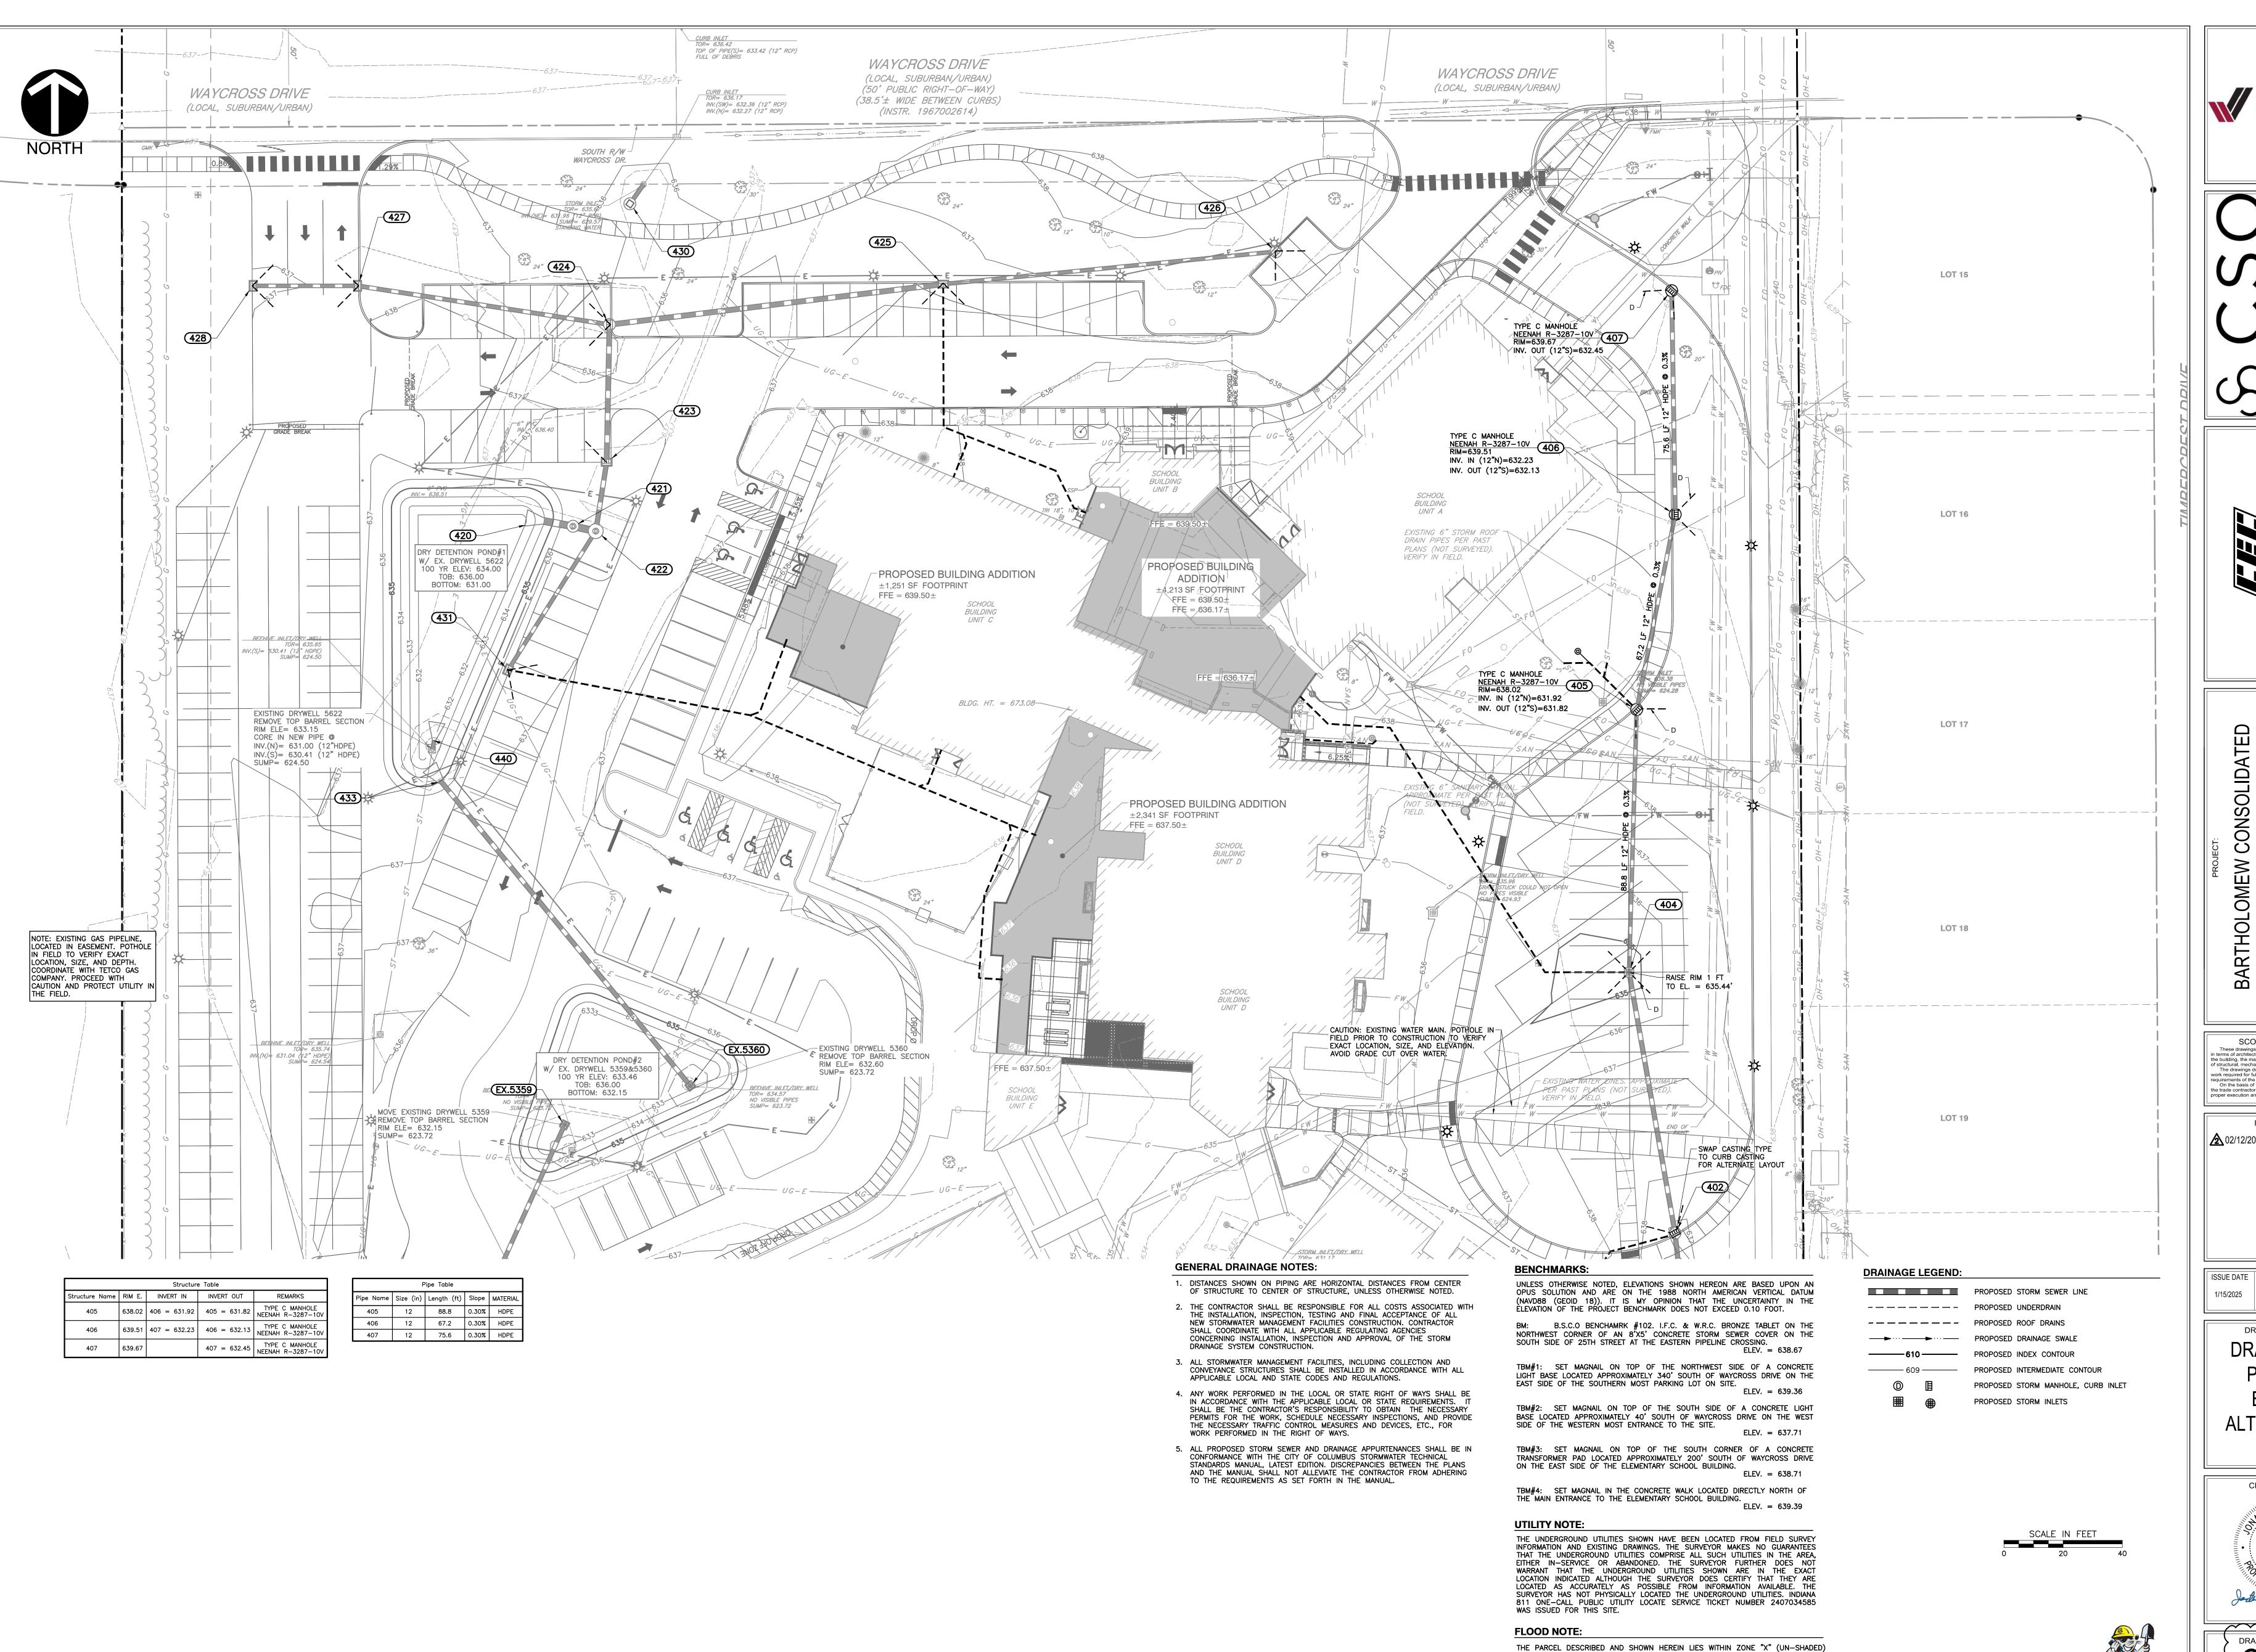RATE MAP.



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REVISIONS: 02/12/2025 - ADDENDUM #04

ISSUE DATE | DRAWN BY | CHECKED BY

MP/RT

DRAWING TITLE: ALTERNATE


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Jest Jack 01/15/25 DRAWING NUMBER

PROJECT NUMBER

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11. CONTRACTOR IS RESPONSIBLE FOR ELECTRIC, TELEPHONE, AND CABLE

CONDUITS AND TRENCHING. COORDINATE WITH THE LOCAL UTILITY

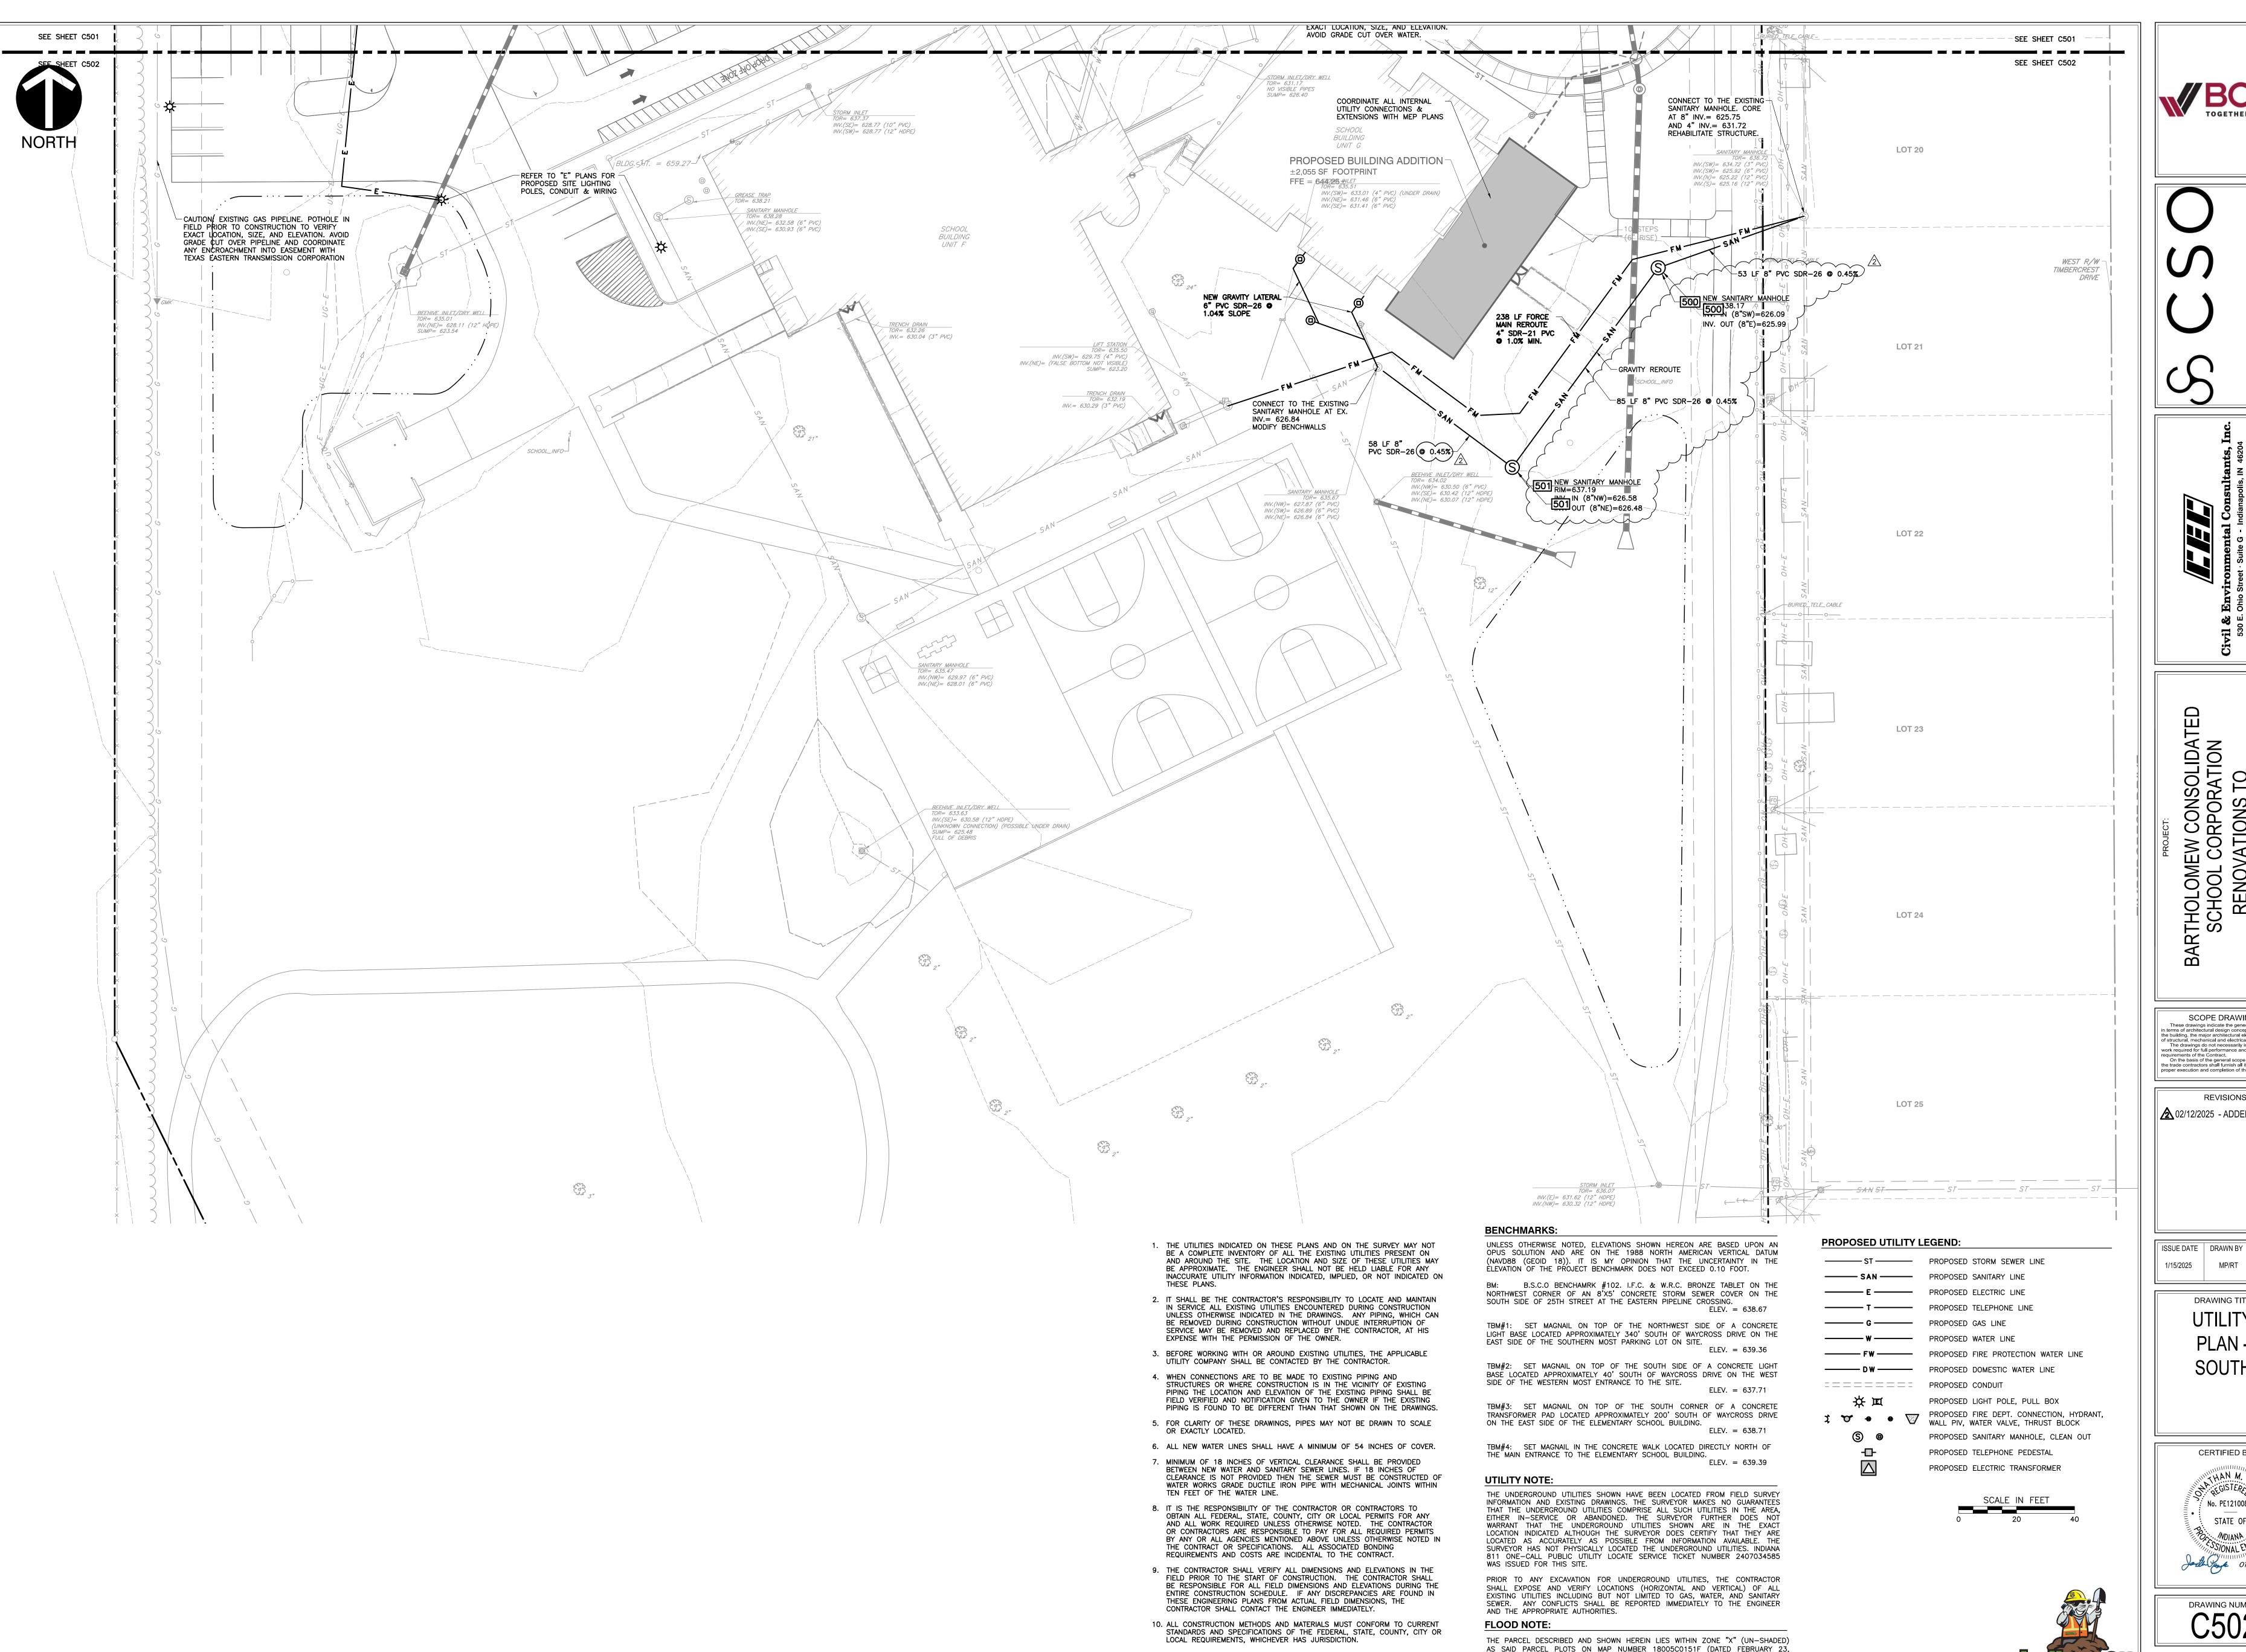AND QUANTITIES..

PROVIDERS AND MECHANICAL, ELECTRICAL AND PLUMBING PLANS FOR SIZES

2023) & 18005C0153E (DATED DECEMBER, 2014) OF THE FLOOD INSURANCE

RATE MAPS FOR BARTHOLOMEW COUNTY, INDIANA. THE ACCURACY OF THIS FLOOD

HAZARD STATEMENT IS SUBJECT TO MAP SCALE UNCERTAINTY AND TO ANY OTHER

UNCERTAINTY IN LOCATION OR ELEVATION ON THE REFERENCED FLOOD INSURANCE

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ISSUE DATE | DRAWN BY | CHECKED BY

DRAWING TITLE:

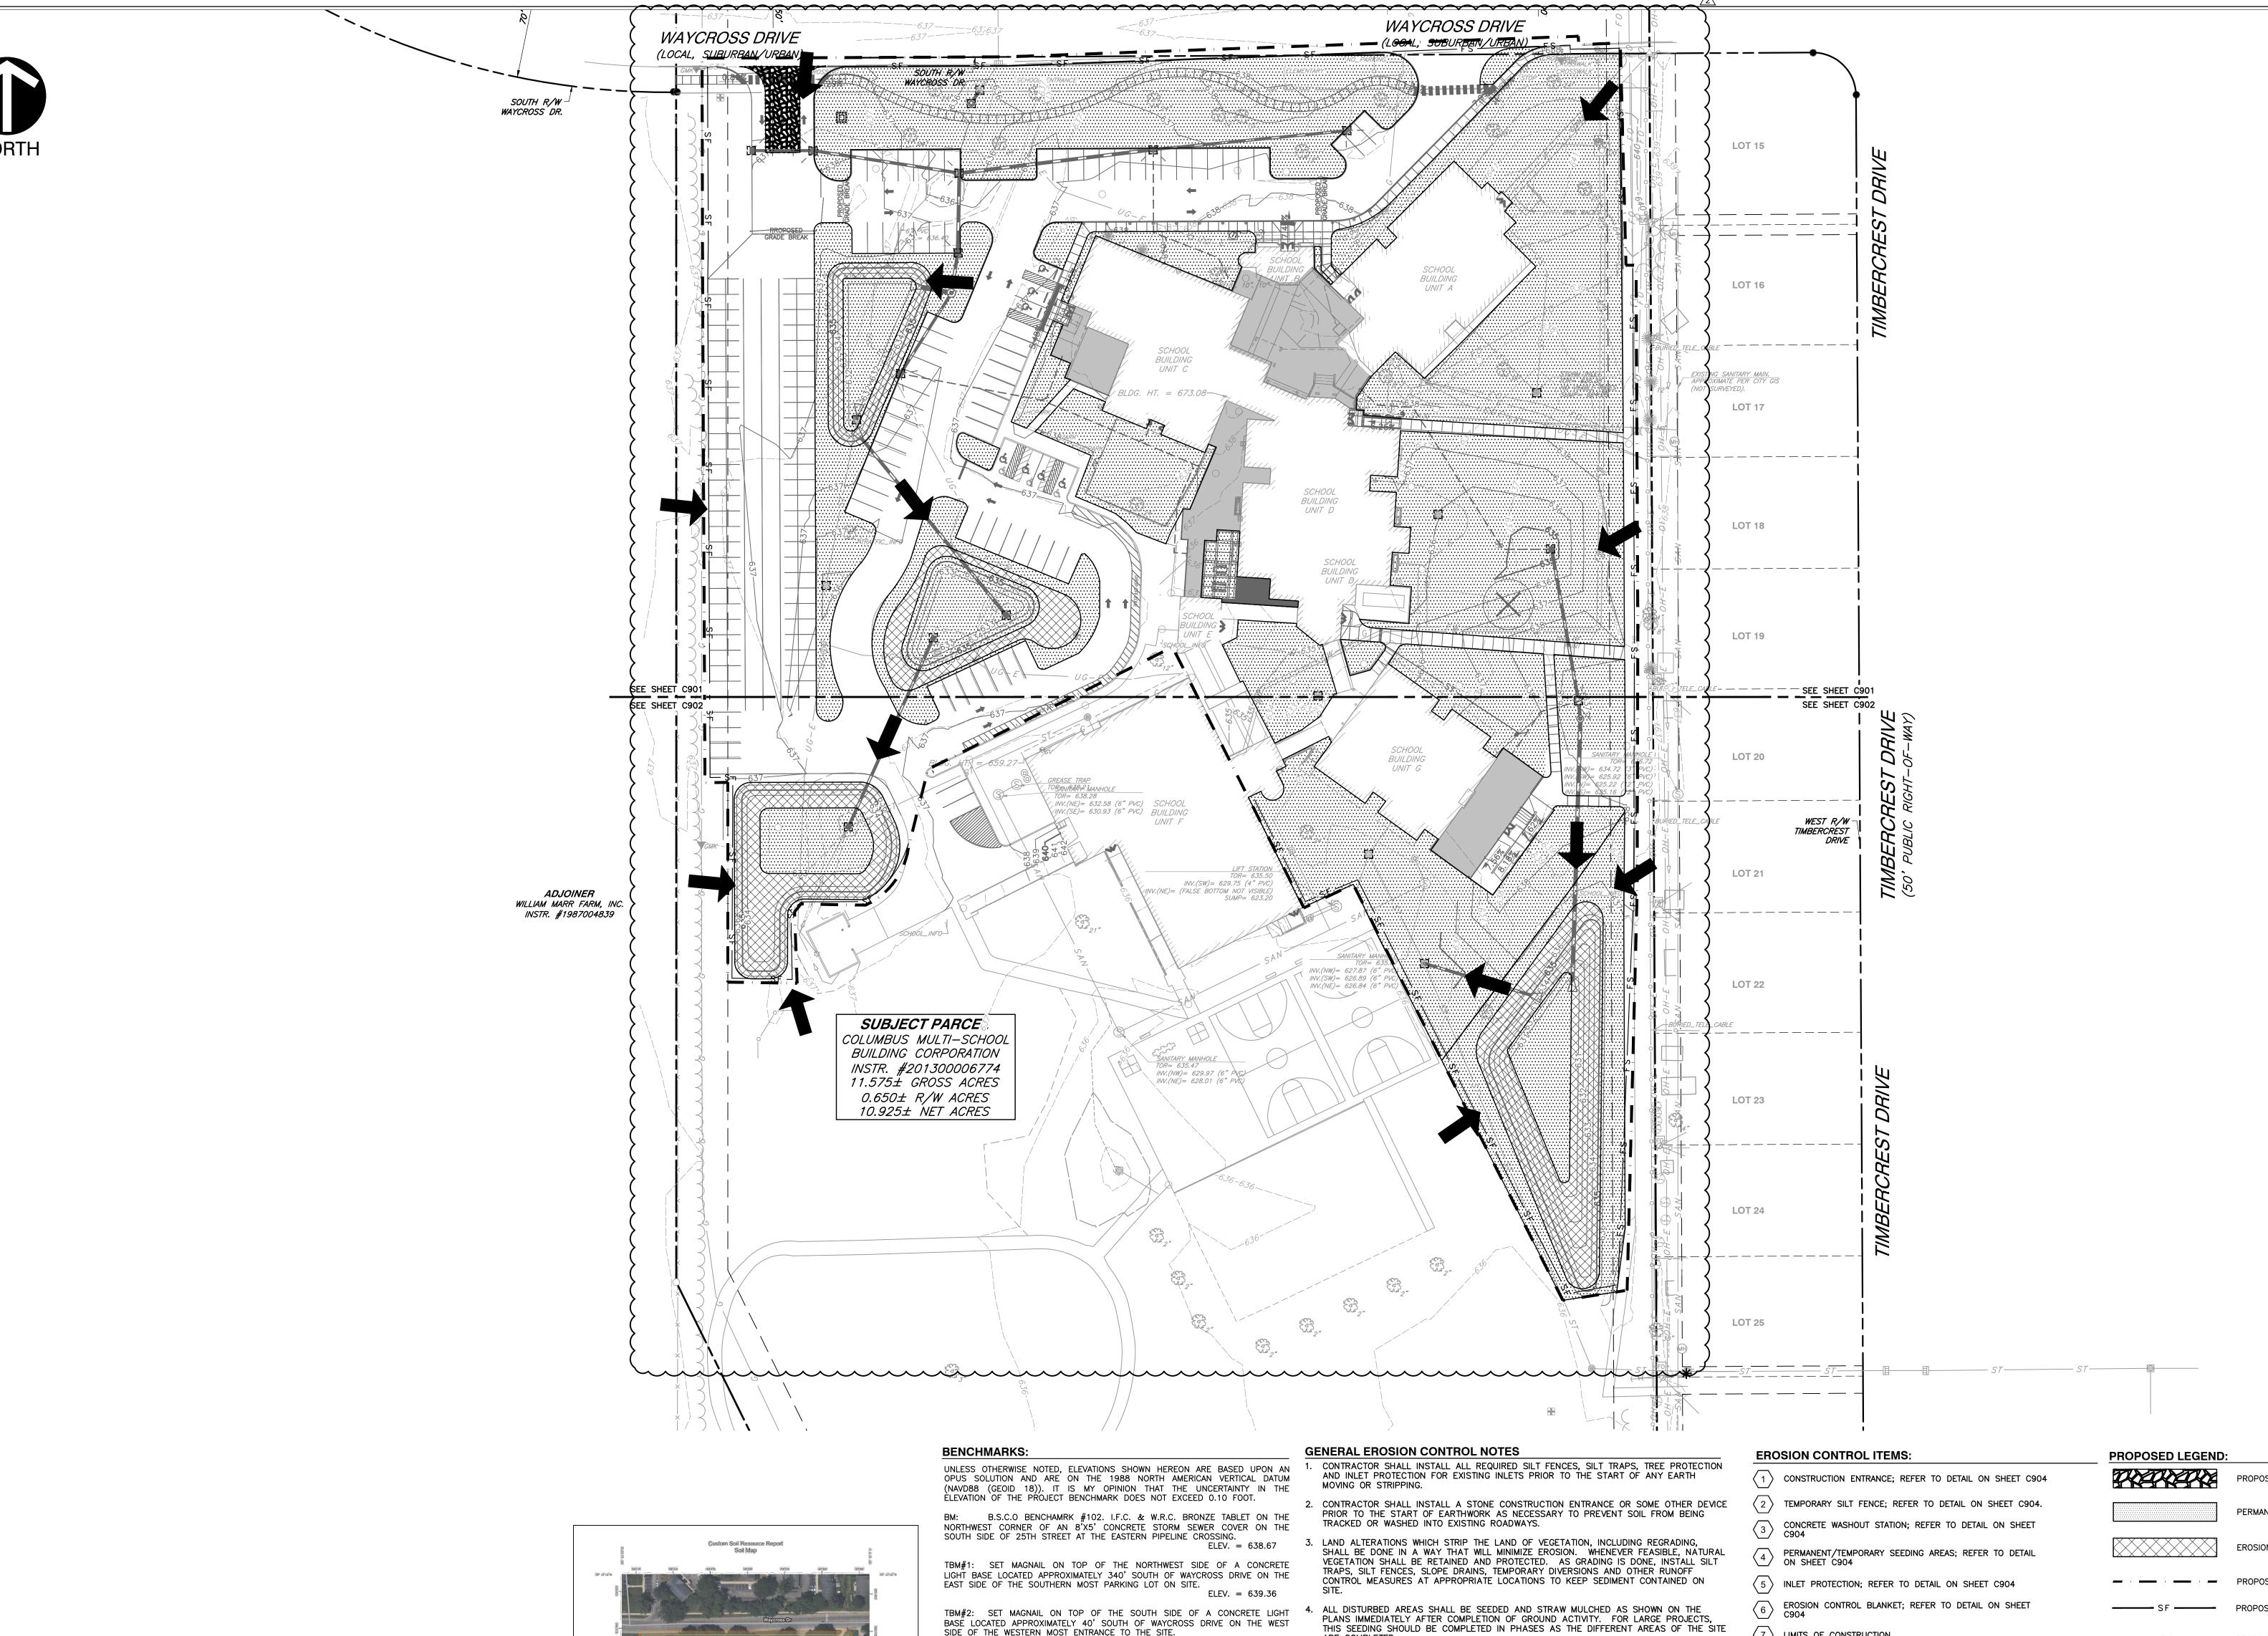
PLAN -

CERTIFIED BY: M MAHZ A REGISTERS OF No. PE12100829 STATE OF ... ANAIDW ... SSIONAL ENGI Jarth Jark 01/15/25

DRAWING NUMBER

PROJECT NUMBER

Know what's **below. Call** before you dig.



SOIL MAP SOIL MAPS FROM THE UNITED STATES DEPARTMENT OF AGRICULTURE, SOIL CONSERVATION SERVICE

SOIL LEGEND UhyA — Urban land—Martinsville, sandy substratum complex, 0 to 2 Percent Slopes; Well drained UkpA — Urban land—Ockley complex, 0 to 2 Percent Slopes; Well drained * IF CONSTRUCTION IS TAKING PLACE DURING WET SEASON, SOILS MAY REQUIRE LIME STABILIZATION

NO EARTH DISTURBING ACTIVITY MAY COMMENCE WITHOUT AN APPROVED STORMWATER MANAGEMENT PERMIT.

SIDE OF THE WESTERN MOST ENTRANCE TO THE SITE.

TBM#3: SET MAGNAIL ON TOP OF THE SOUTH CORNER OF A CONCRETE 5. PERMANENT AND FINAL VEGETATION OR STRUCTURAL EROSION CONTROL DEVICES SHALL TRANSFORMER PAD LOCATED APPROXIMATELY 200' SOUTH OF WAYCROSS DRIVE ON THE EAST SIDE OF THE ELEMENTARY SCHOOL BUILDING.

TBM#4: SET MAGNAIL IN THE CONCRETE WALK LOCATED DIRECTLY NORTH OF THE MAIN ENTRANCE TO THE ELEMENTARY SCHOOL BUILDING. **UTILITY NOTE:**

THE UNDERGROUND UTILITIES SHOWN HAVE BEEN LOCATED FROM FIELD SURVEY INFORMATION AND EXISTING DRAWINGS. THE SURVEYOR MAKES NO GUARANTEES THAT THE UNDERGROUND UTILITIES COMPRISE ALL SUCH UTILITIES IN THE AREA, EITHER IN—SERVICE OR ABANDONED. THE SURVEYOR FURTHER DOES NOT WARRANT THAT THE UNDERGROUND UTILITIES SHOWN ARE IN THE EXACT LOCATION INDICATED ALTHOUGH THE SURVEYOR DOES CERTIFY THAT THEY ARE LOCATED AS ACCURATELY AS POSSIBLE FROM INFORMATION AVAILABLE. THE 811 ONE-CALL PUBLIC UTILITY LOCATE SERVICE TICKET NUMBER 2407034585 CONTROL PLANS FOR SPECIFIC NOTES AND ADDITIONAL DETAILS

PRIOR TO ANY EXCAVATION FOR UNDERGROUND UTILITIES, THE CONTRACTOR EXISTING UTILITIES INCLUDING BUT NOT LIMITED TO GAS, WATER, AND SANITARY SEWER. ANY CONFLICTS SHALL BE REPORTED IMMEDIATELY TO THE ENGINEER AND THE APPROPRIATE AUTHORITIES.

THE PARCEL DESCRIBED AND SHOWN HEREIN LIES WITHIN ZONE "X" (UN-SHADED) AS SAID PARCEL PLOTS ON MAP NUMBER 18005C0151F (DATED FEBRUARY 23, 2023) & 18005C0153E (DATED DECEMBER, 2014) OF THE FLOOD INSURANCE 14. A PRE-CONSTRUCTION MEETING IS REQUIRED PRIOR TO CONSTRUCTION. CONTACT THE RATE MAPS FOR BARTHOLOMEW COUNTY, INDIANA. THE ACCURACY OF THIS FLOOD HAZARD STATEMENT IS SUBJECT TO MAP SCALE UNCERTAINTY AND TO ANY OTHER UNCERTAINTY IN LOCATION OR ELEVATION ON THE REFERENCED FLOOD INSURANCE

NOT TO SCALE

BE INSTALLED AS SOON AS PRACTICAL UNDER THE CIRCUMSTANCES. 6. THE DURATION OF TIME WHICH AN AREA REMAINS EXPOSED SHALL BE KEPT TO A PRACTICAL MINIMUM DEPENDING UPON THE WEATHER. IF CONSTRUCTION ACTIVITY IS TO CEASE FOR MORE THAN 7 DAYS, THE DISTURBED AREAS SHALL BE TEMPORARILY SEEDED.

7. ALL STORM SEWER INLET PROTECTION DEVICES SHALL BE PUT IN PLACE AT THE TIME EACH INLET IS CONSTRUCTED. 8. THE CONTRACTOR SHALL MAINTAIN EROSION CONTROL MEASURES AND DEVICES DURING

CONSTRUCTION AND UNTIL SILTATION OF THE STREETS AND STORM SEWERS WILL NO 9. ONCE ONSITE EROSION AND SILTATION OF THE STREETS AND STORM SEWERS WILL NO LONGER OCCUR, THE CONTRACTOR SHALL REMOVE AND DISPOSE OF THE TEMPORARY

SURVEYOR HAS NOT PHYSICALLY LOCATED THE UNDERGROUND UTILITIES. INDIANA 10. THESE GENERAL PROCEDURES MAY NOT COVER ALL SITUATIONS. REFER TO EROSION 11. EROSION CONTROL TO COMPLY WITH IDEM CONSTRUCTION STORMWATER GENERAL PERMIT. SHALL EXPOSE AND VERIFY LOCATIONS (HORIZONTAL AND VERTICAL) OF ALL 12. ALL PROPOSED EROSION AND SEDIMENT CONTROL SHALL BE IN CONFORMANCE WITH THE CITY OF COLUMBUS TYPICAL CONSTRUCTION GUIDELINES. DISCREPANCIES BETWEEN THE PLANS AND THE MANUAL SHALL NOT ALLEVIATE THE CONTRACTOR FROM ADHERING TO THE REQUIREMENTS AS SET FORTH IN THE MANUAL.

13. ADDITIONAL EROSION CONTROL MEASURES MAY BE REQUIRED IN THE FIELD BY THE

CITY OF COLUMBUS ENGINEERING DEPARTMENT TO SCHEDULE. (812) 376-2540.

EROSION CONTROL DEVICES.

 $\langle 7 \rangle$ LIMITS OF CONSTRUCTION

(9) PERMANENT RIP RAP APRON

(8) TEMPORARY FILTER SOCK.

PROPOSED GRAVEL CONSTRUCTION ENTRANCE

PERMANENT/ TEMPORARY SEEDING AREAS

EROSION CONTROL BLANKET W/ GRASS SEED PROPOSED LIMITS OF DISTURBANCE

PROPOSED SILT FENCE

FS PROPOSED FILTER SOCK PROPOSED INLET PROTECTION

PROPOSED CONCRETE WASHOUT

MAJOR STORMWATER DISCHARGE POINT SCALE IN FEET







REVISIONS:


2 02/12/2025 - ADDENDUM #04

ISSUE DATE | DRAWN BY | CHECKED BY 1/15/2025 MP/RT

DRAWING TITLE: **OVERALL** STORMWATER POLLUTION **PREVENTION**

CERTIFIED BY: MAN M. A REGISTERS OF No. PE12100829 STATE OF ... ANAIDN... Jarth Jark 01/15/25

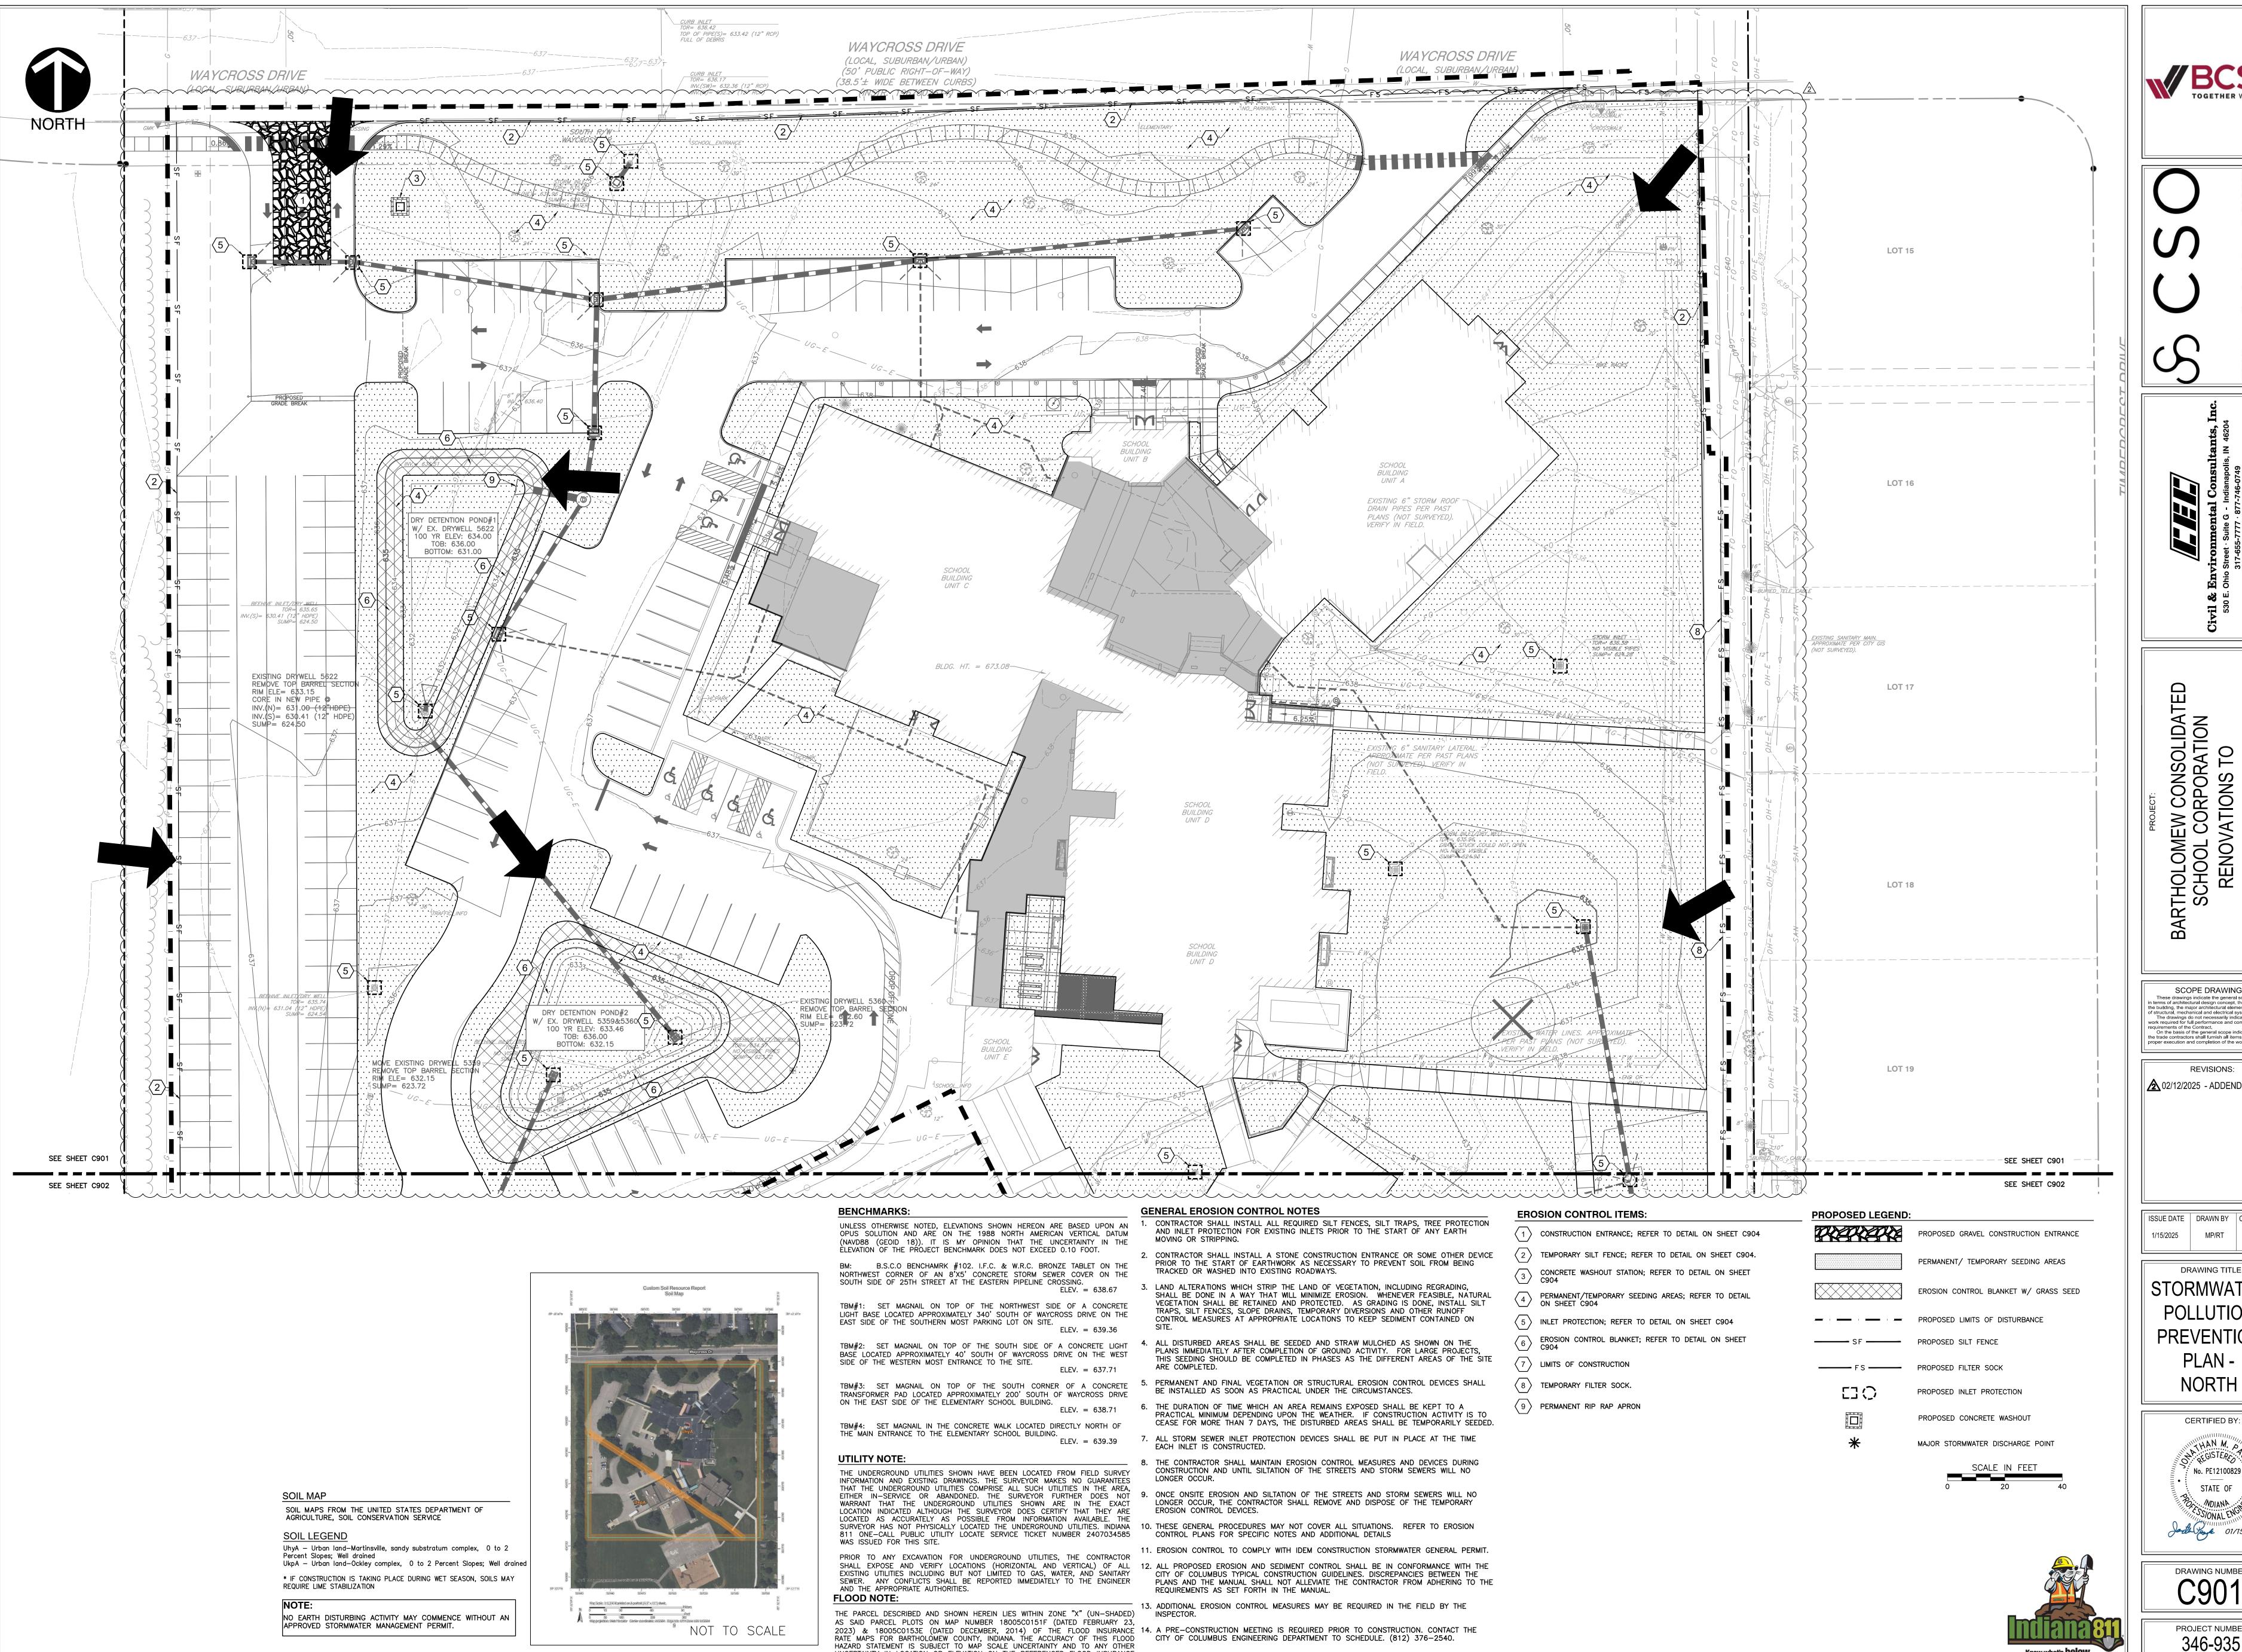DRAWING NUMBER



UNCERTAINTY IN LOCATION OR ELEVATION ON THE REFERENCED FLOOD INSURANCE

02/12/2025 - ADDENDUM #04

ISSUE DATE | DRAWN BY | CHECKED BY 1/15/2025 MP/RT

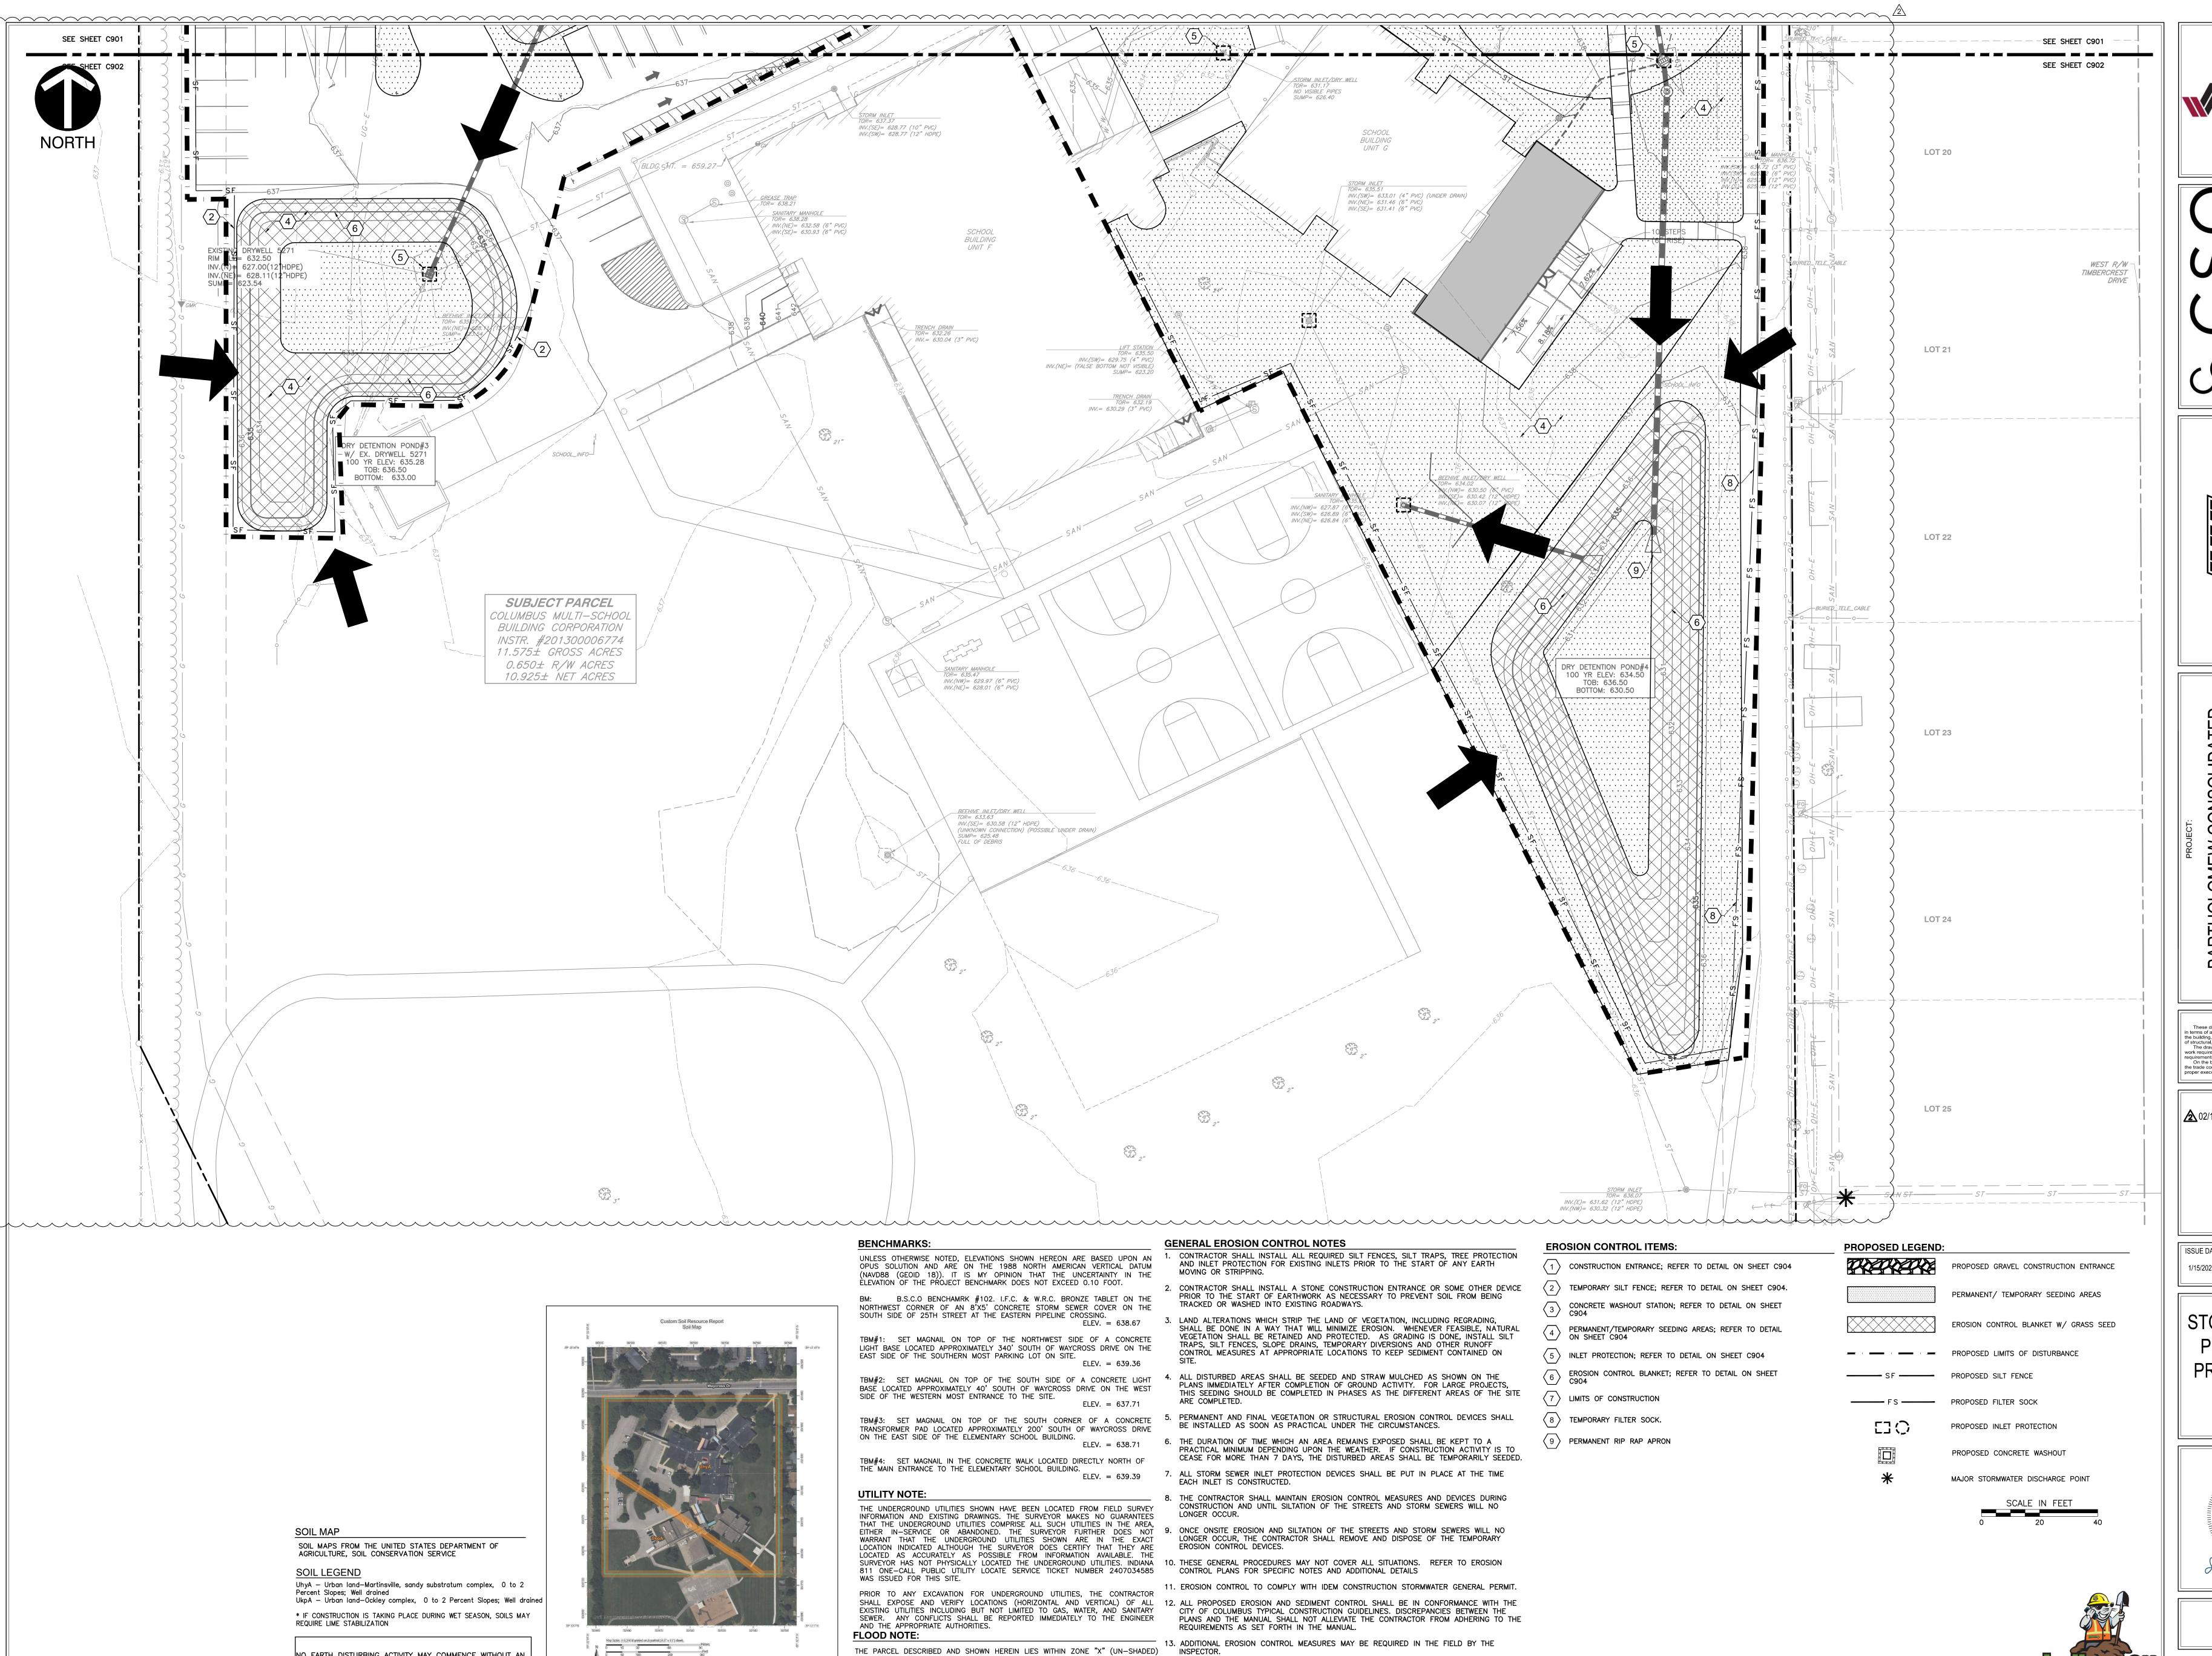
DRAWING TITLE: STORMWATER POLLUTION PREVENTION PLAN -

> CERTIFIED BY: MAN M. A REGISTERS OF No. PE12100829 STATE OF ... ANAIDN... Jarth Jark 01/15/25

DRAWING NUMBER

PROJECT NUMBER

Know what's **below. Call** before you dig.



AS SAID PARCEL PLOTS ON MAP NUMBER 18005C0151F (DATED FEBRUARY 23.

RATE MAPS FOR BARTHOLOMEW COUNTY, INDIANA. THE ACCURACY OF THIS FLOOD HAZARD STATEMENT IS SUBJECT TO MAP SCALE UNCERTAINTY AND TO ANY OTHER

UNCERTAINTY IN LOCATION OR ELEVATION ON THE REFERENCED FLOOD INSURANCE

2023) & 18005C0153E (DATED DECEMBER, 2014) OF THE FLOOD INSURANCE 14. A PRE-CONSTRUCTION MEETING IS REQUIRED PRIOR TO CONSTRUCTION. CONTACT THE

CITY OF COLUMBUS ENGINEERING DEPARTMENT TO SCHEDULE. (812) 376-2540.

NOT TO SCALE

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APPROVED STORMWATER MANAGEMENT PERMIT.

REVISIONS: 2 02/12/2025 - ADDENDUM #04

ISSUE DATE | DRAWN BY | CHECKED BY 1/15/2025 MP/RT

DRAWING TITLE: STORMWATER POLLUTION

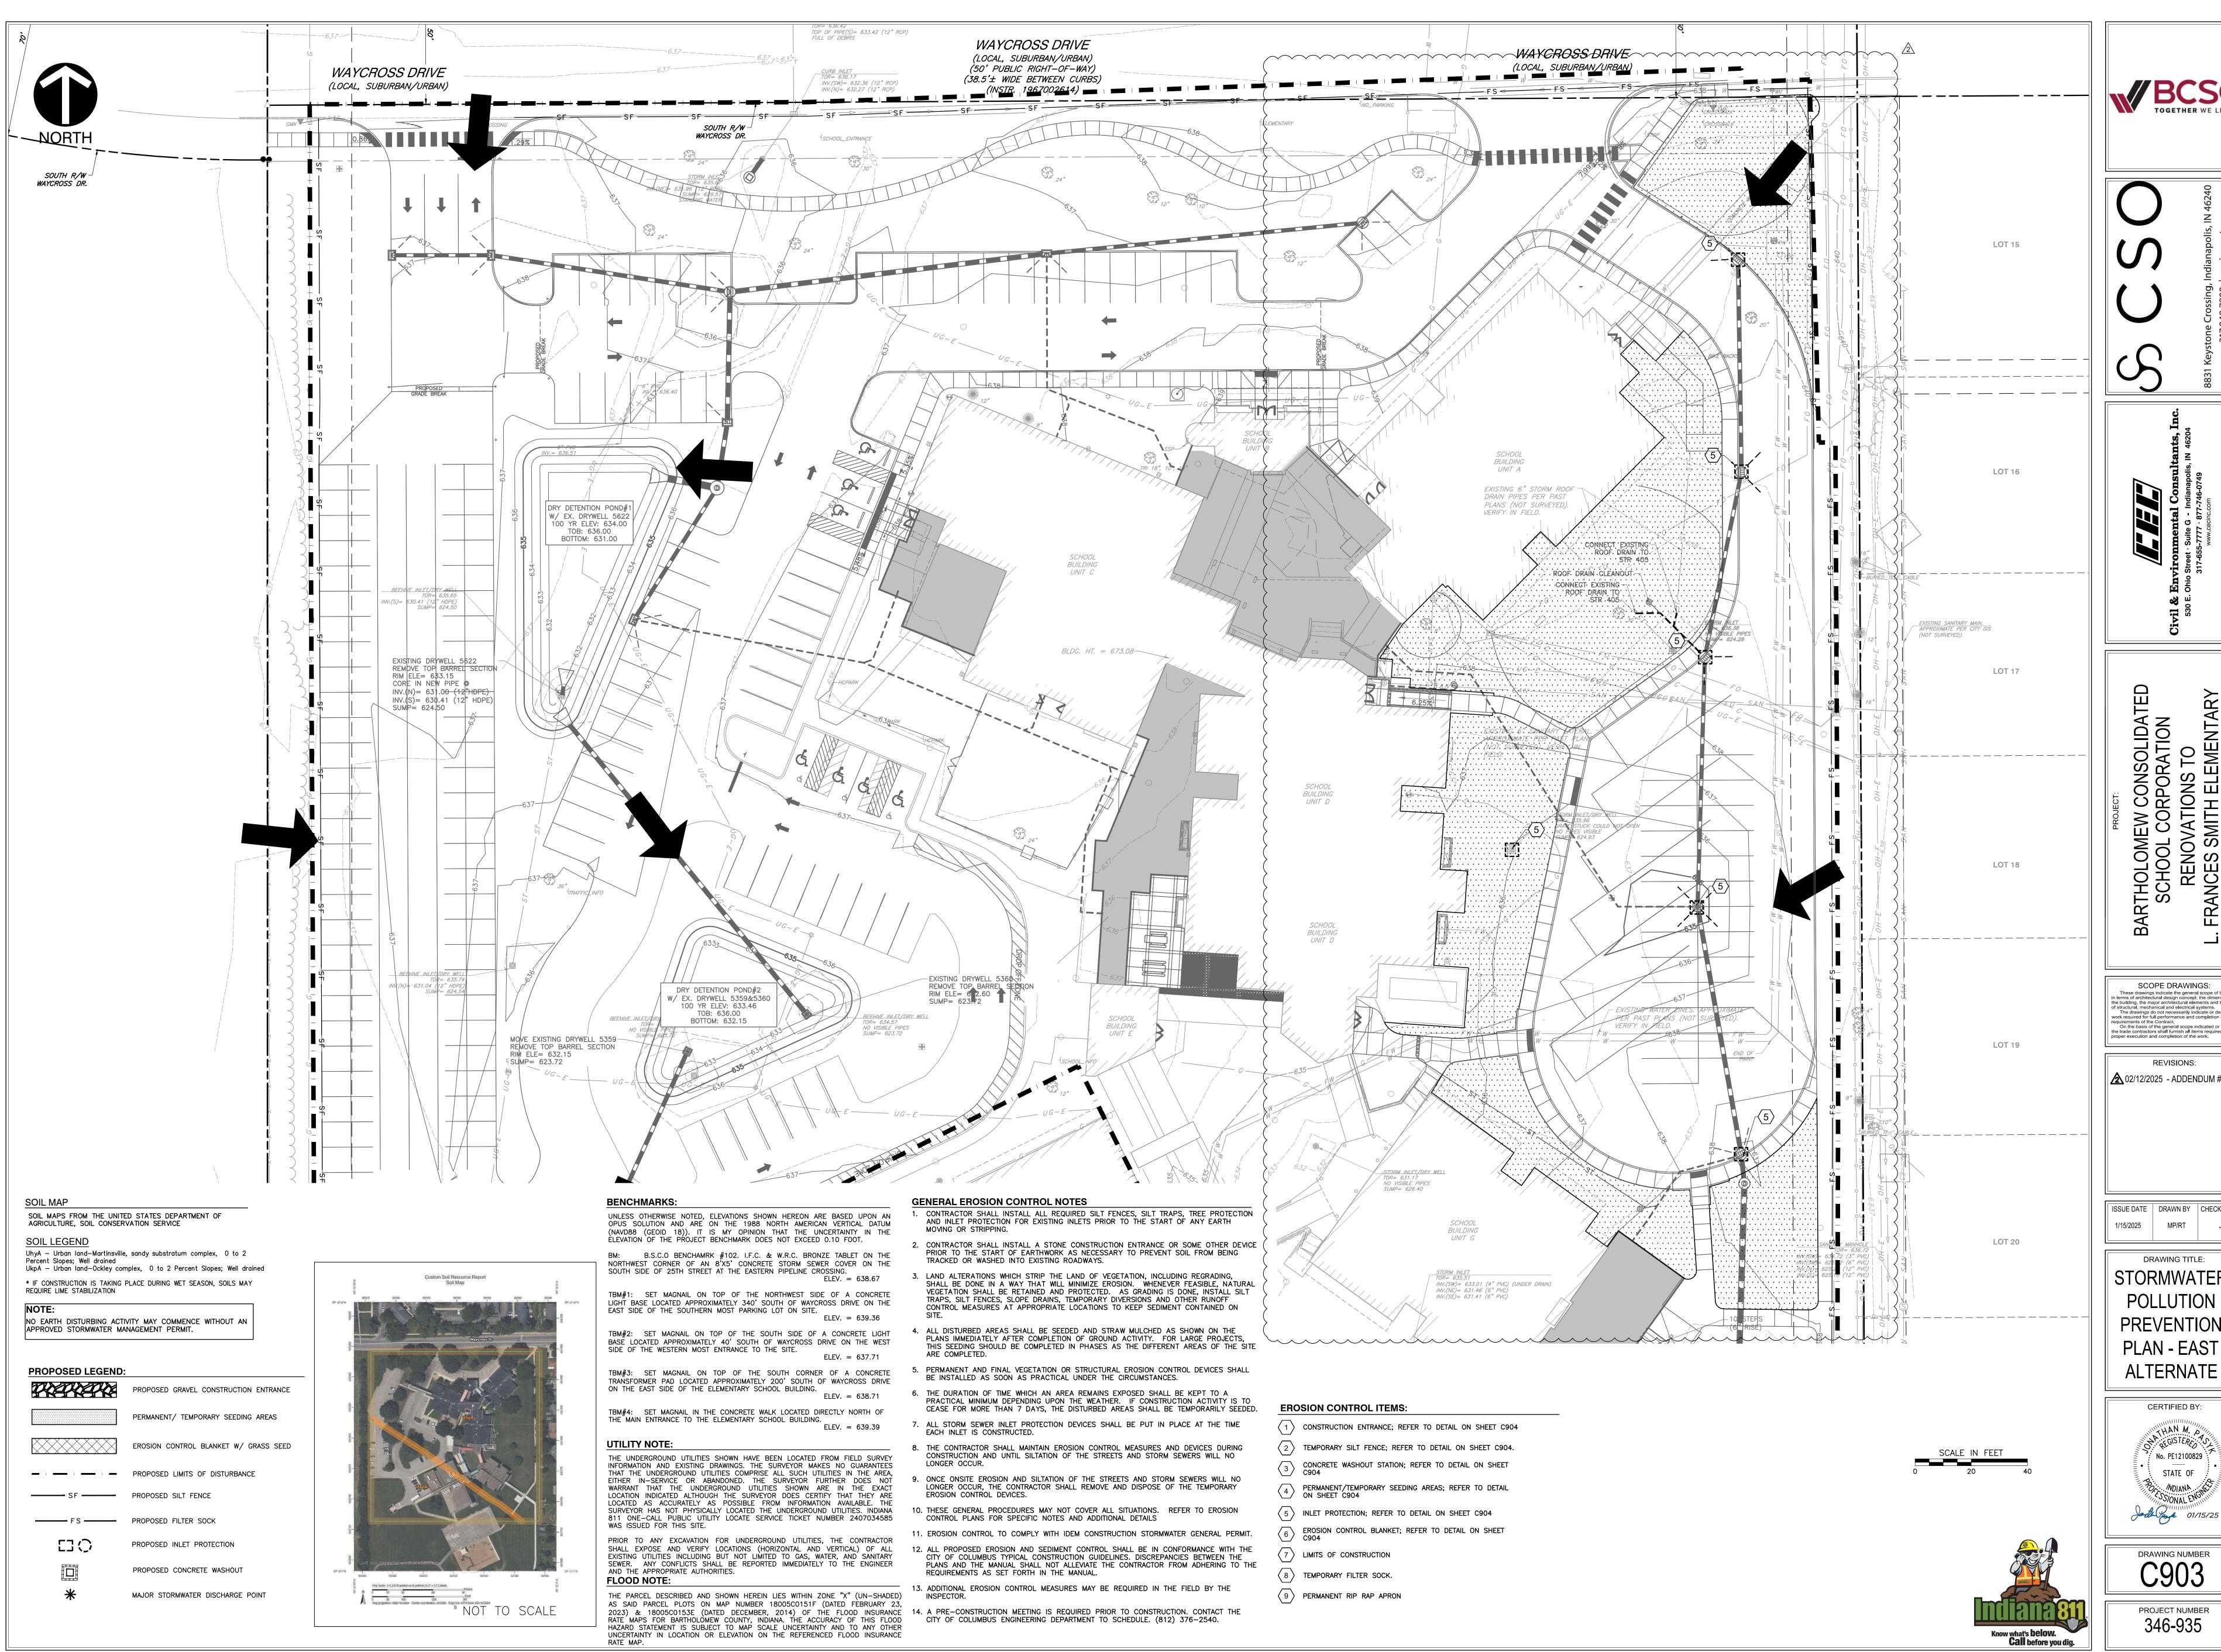
PREVENTION PLAN -

CERTIFIED BY: MAN M. A REGISTERS OF No. PE12100829 STATE OF ... ANAIDN... Josth York 01/15/25

DRAWING NUMBER

PROJECT NUMBER

Know what's **below. Call** before you dig.




REVISIONS: 2 02/12/2025 - ADDENDUM #04

ISSUE DATE | DRAWN BY | CHECKED BY 1/15/2025 MP/RT

DRAWING TITLE: STORMWATER POLLUTION PREVENTION PLAN - EAST

> CERTIFIED BY: MAHAN M. A REGISTERS OF No. PE12100829 STATE OF ... ANAIDW ... SSIONAL ENGIN

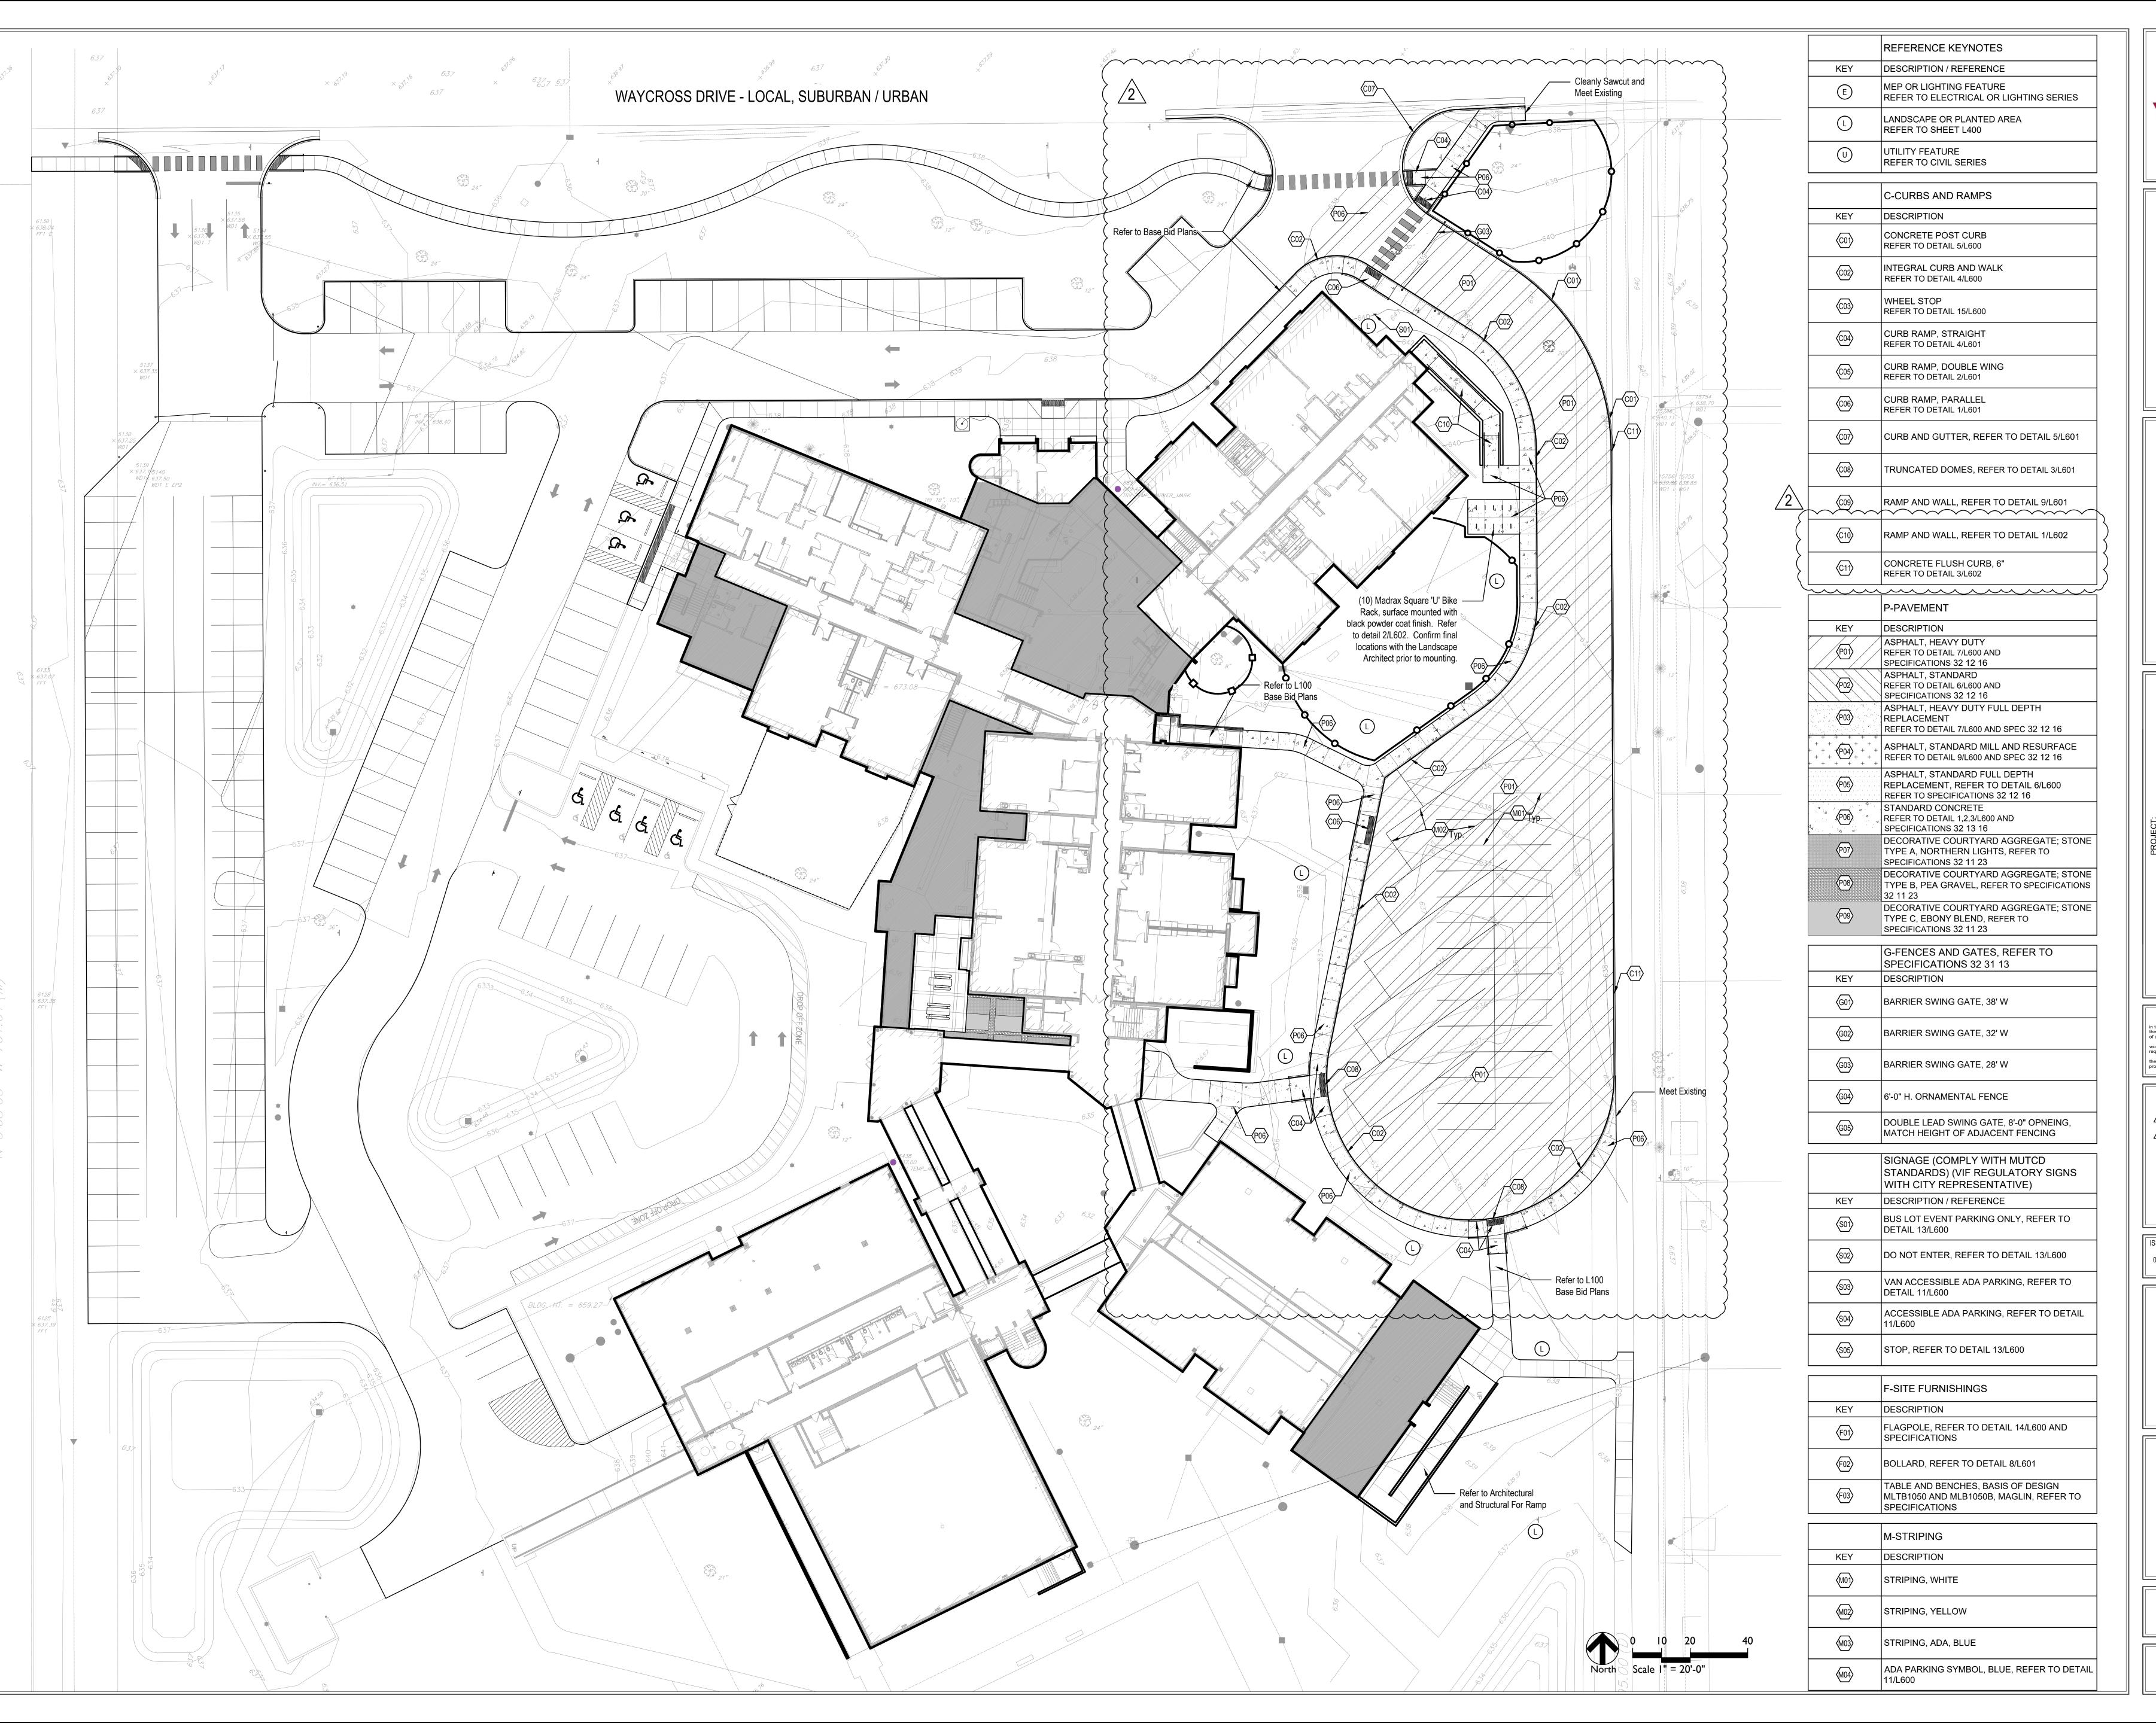DRAWING NUMBER





| C N | 8831 Keystone Crossing, Indianapo | 17.848.7800 | csoinc.n.

D E S I 5825 Lawton Loop E. Dr. | Indianapolis, IN 317-485-6900 | www.context-design

SCOPE DRAWINGS:

These drawings indicate the general scope of the project in terms of architectural design concept, the dimensions of the building, the major architectural elements and the type of structural, mechanical and electrical systems.

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REVISIONS:

Addendum 03 02/10/2025

Addendum 04 02/12/2025

ISSUE DATE | DRAWN BY | CHECKED BY

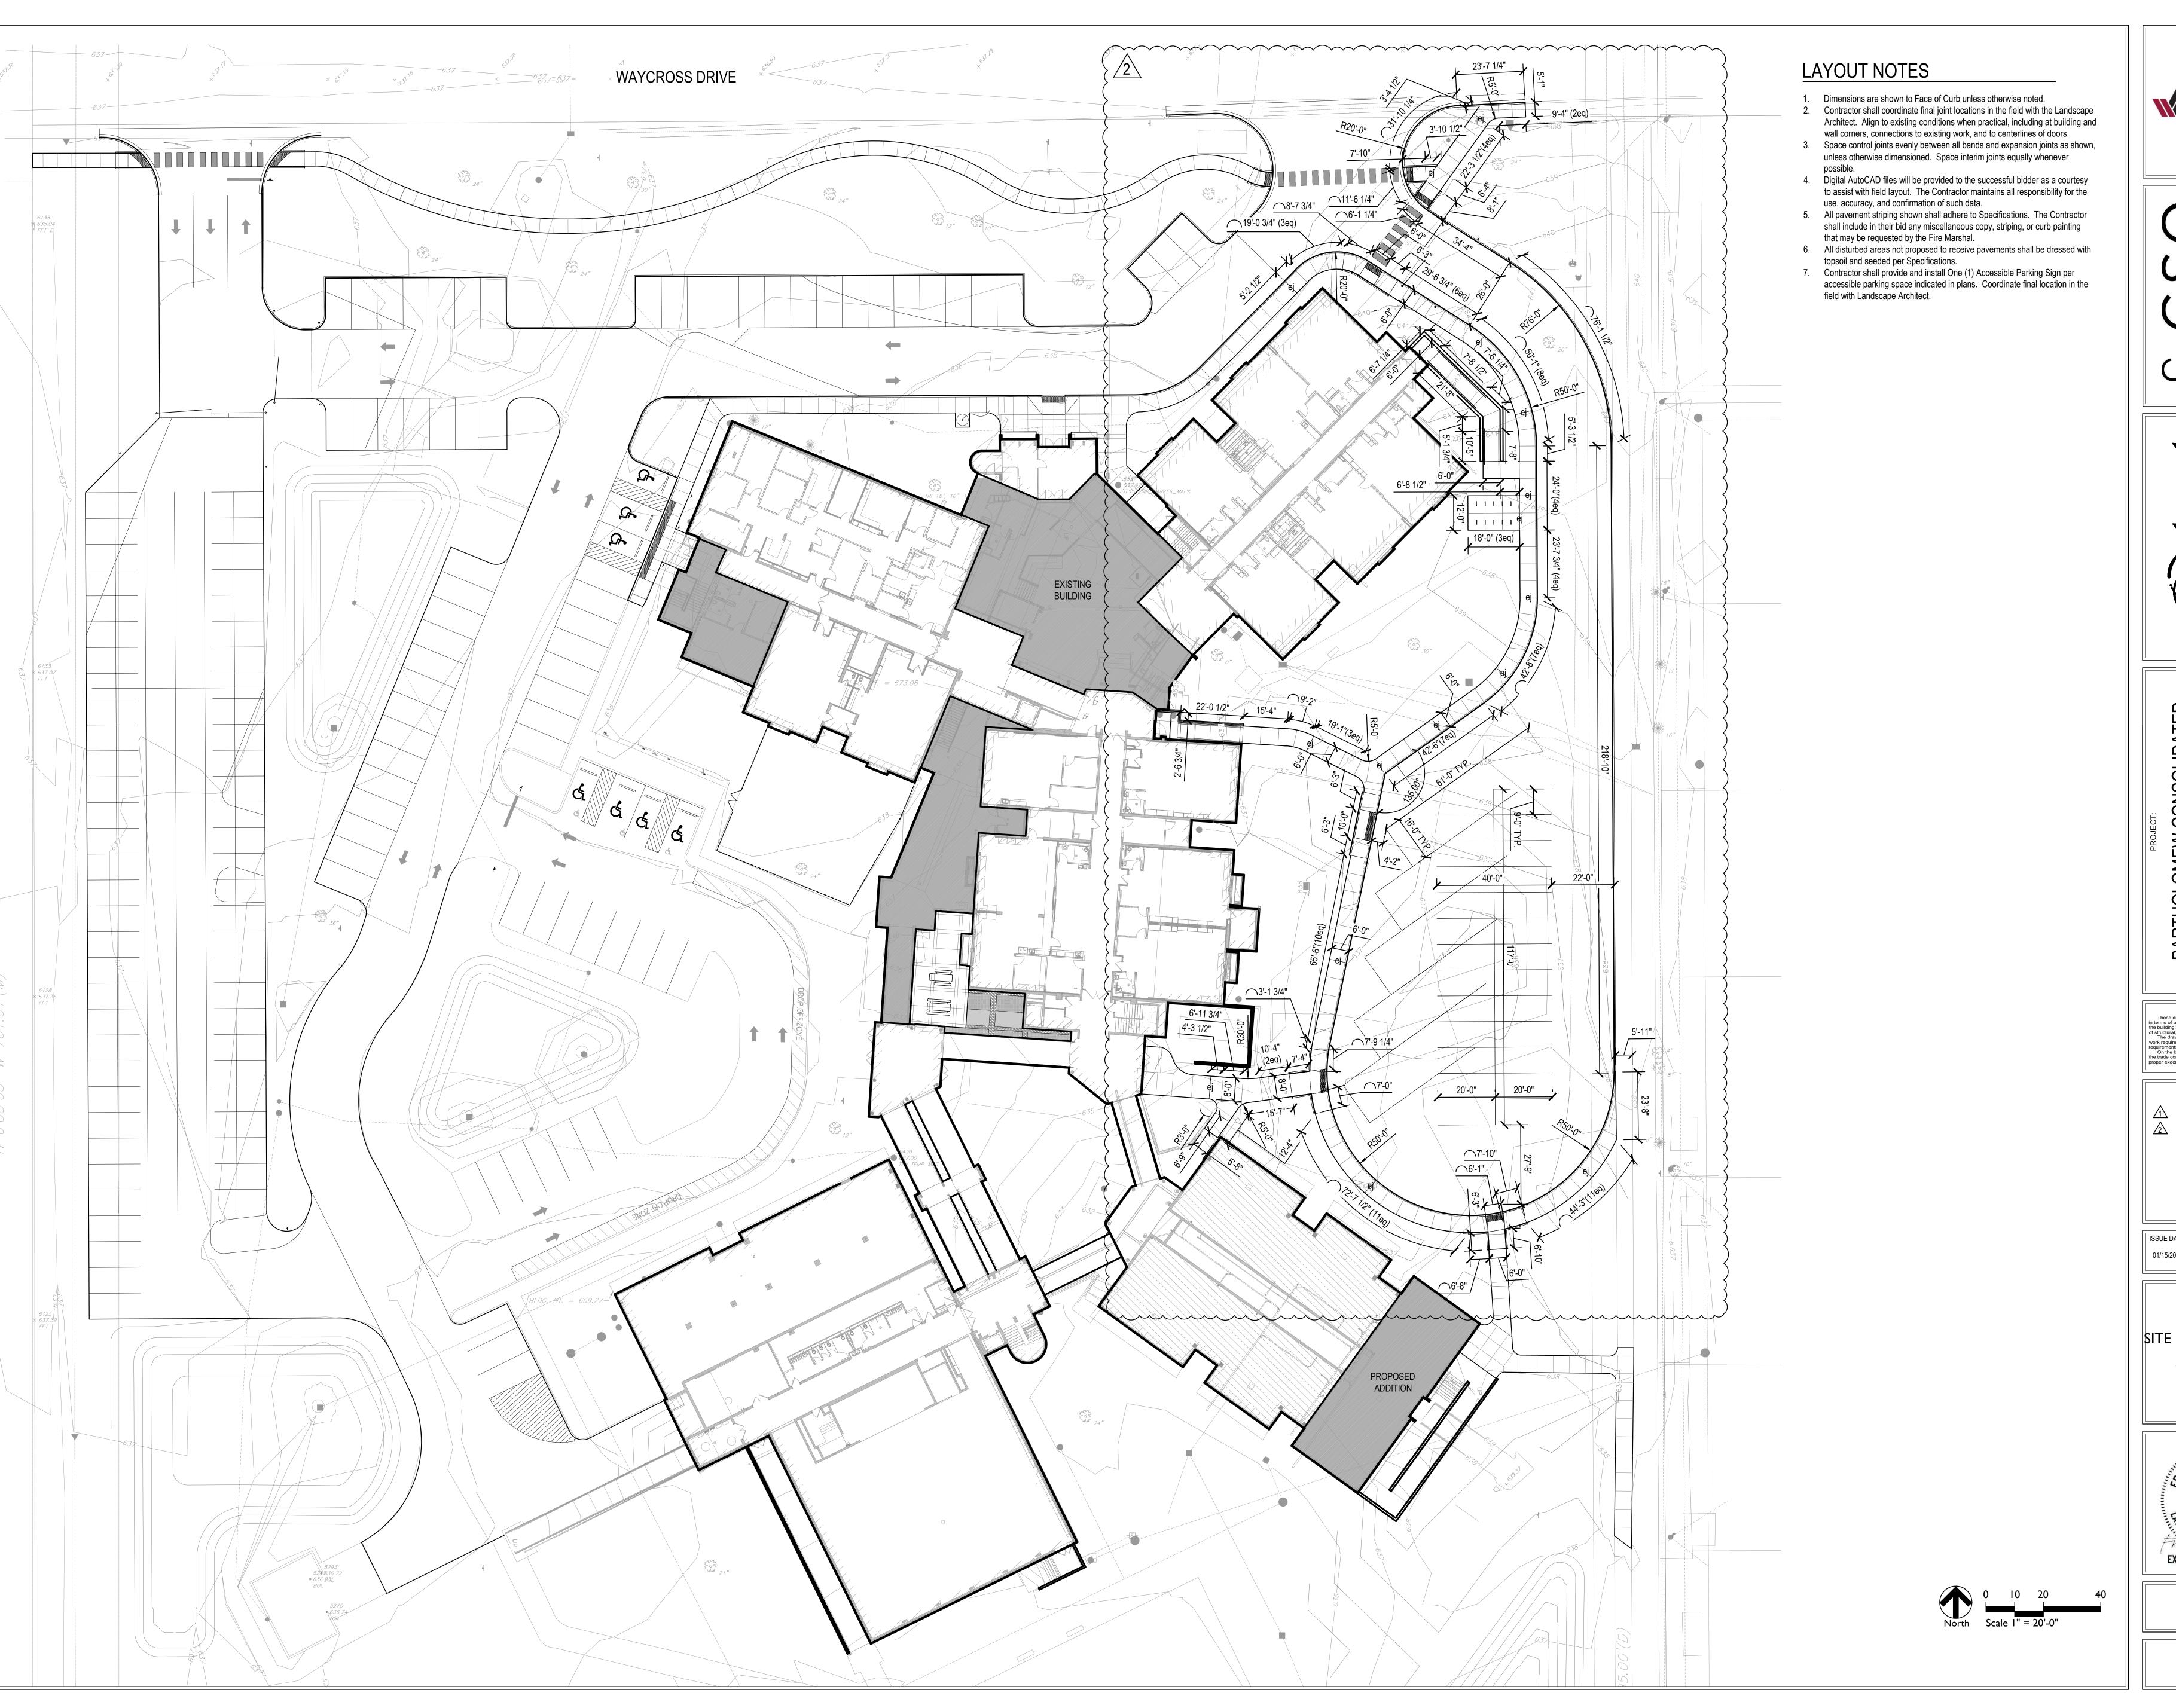
01/15/2025 MA / DC LM

DRAWING TITLE:

SITE MATERIALS PLAN ALTERNATE



DRAWING NUMBER LIOOa





Crossing, Indianapolis, IN 46240
848.7800 | csoinc.net

DESIGN

DESIGN

1 Loop E. Dr. | Indianapolis, IN 46216

00 | www.context-design.com

SCHOOL CORPORATION
RENOVATIONS TO
L. FRANCES SMITH ELEMENTARY
4505 WAYCROSS DRIVE, COLUMBUS, IN 47203

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REVISIONS:


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Addendum 04 02/12/2025


ISSUE DATE DRAWN BY CHECKED BY
01/15/2025 MA / DC LM

DRAWING TITLE:

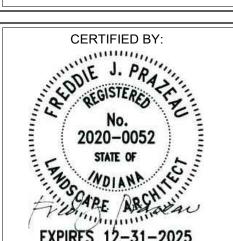SITE LAYOUT PLANS ALTERNATE



L200a

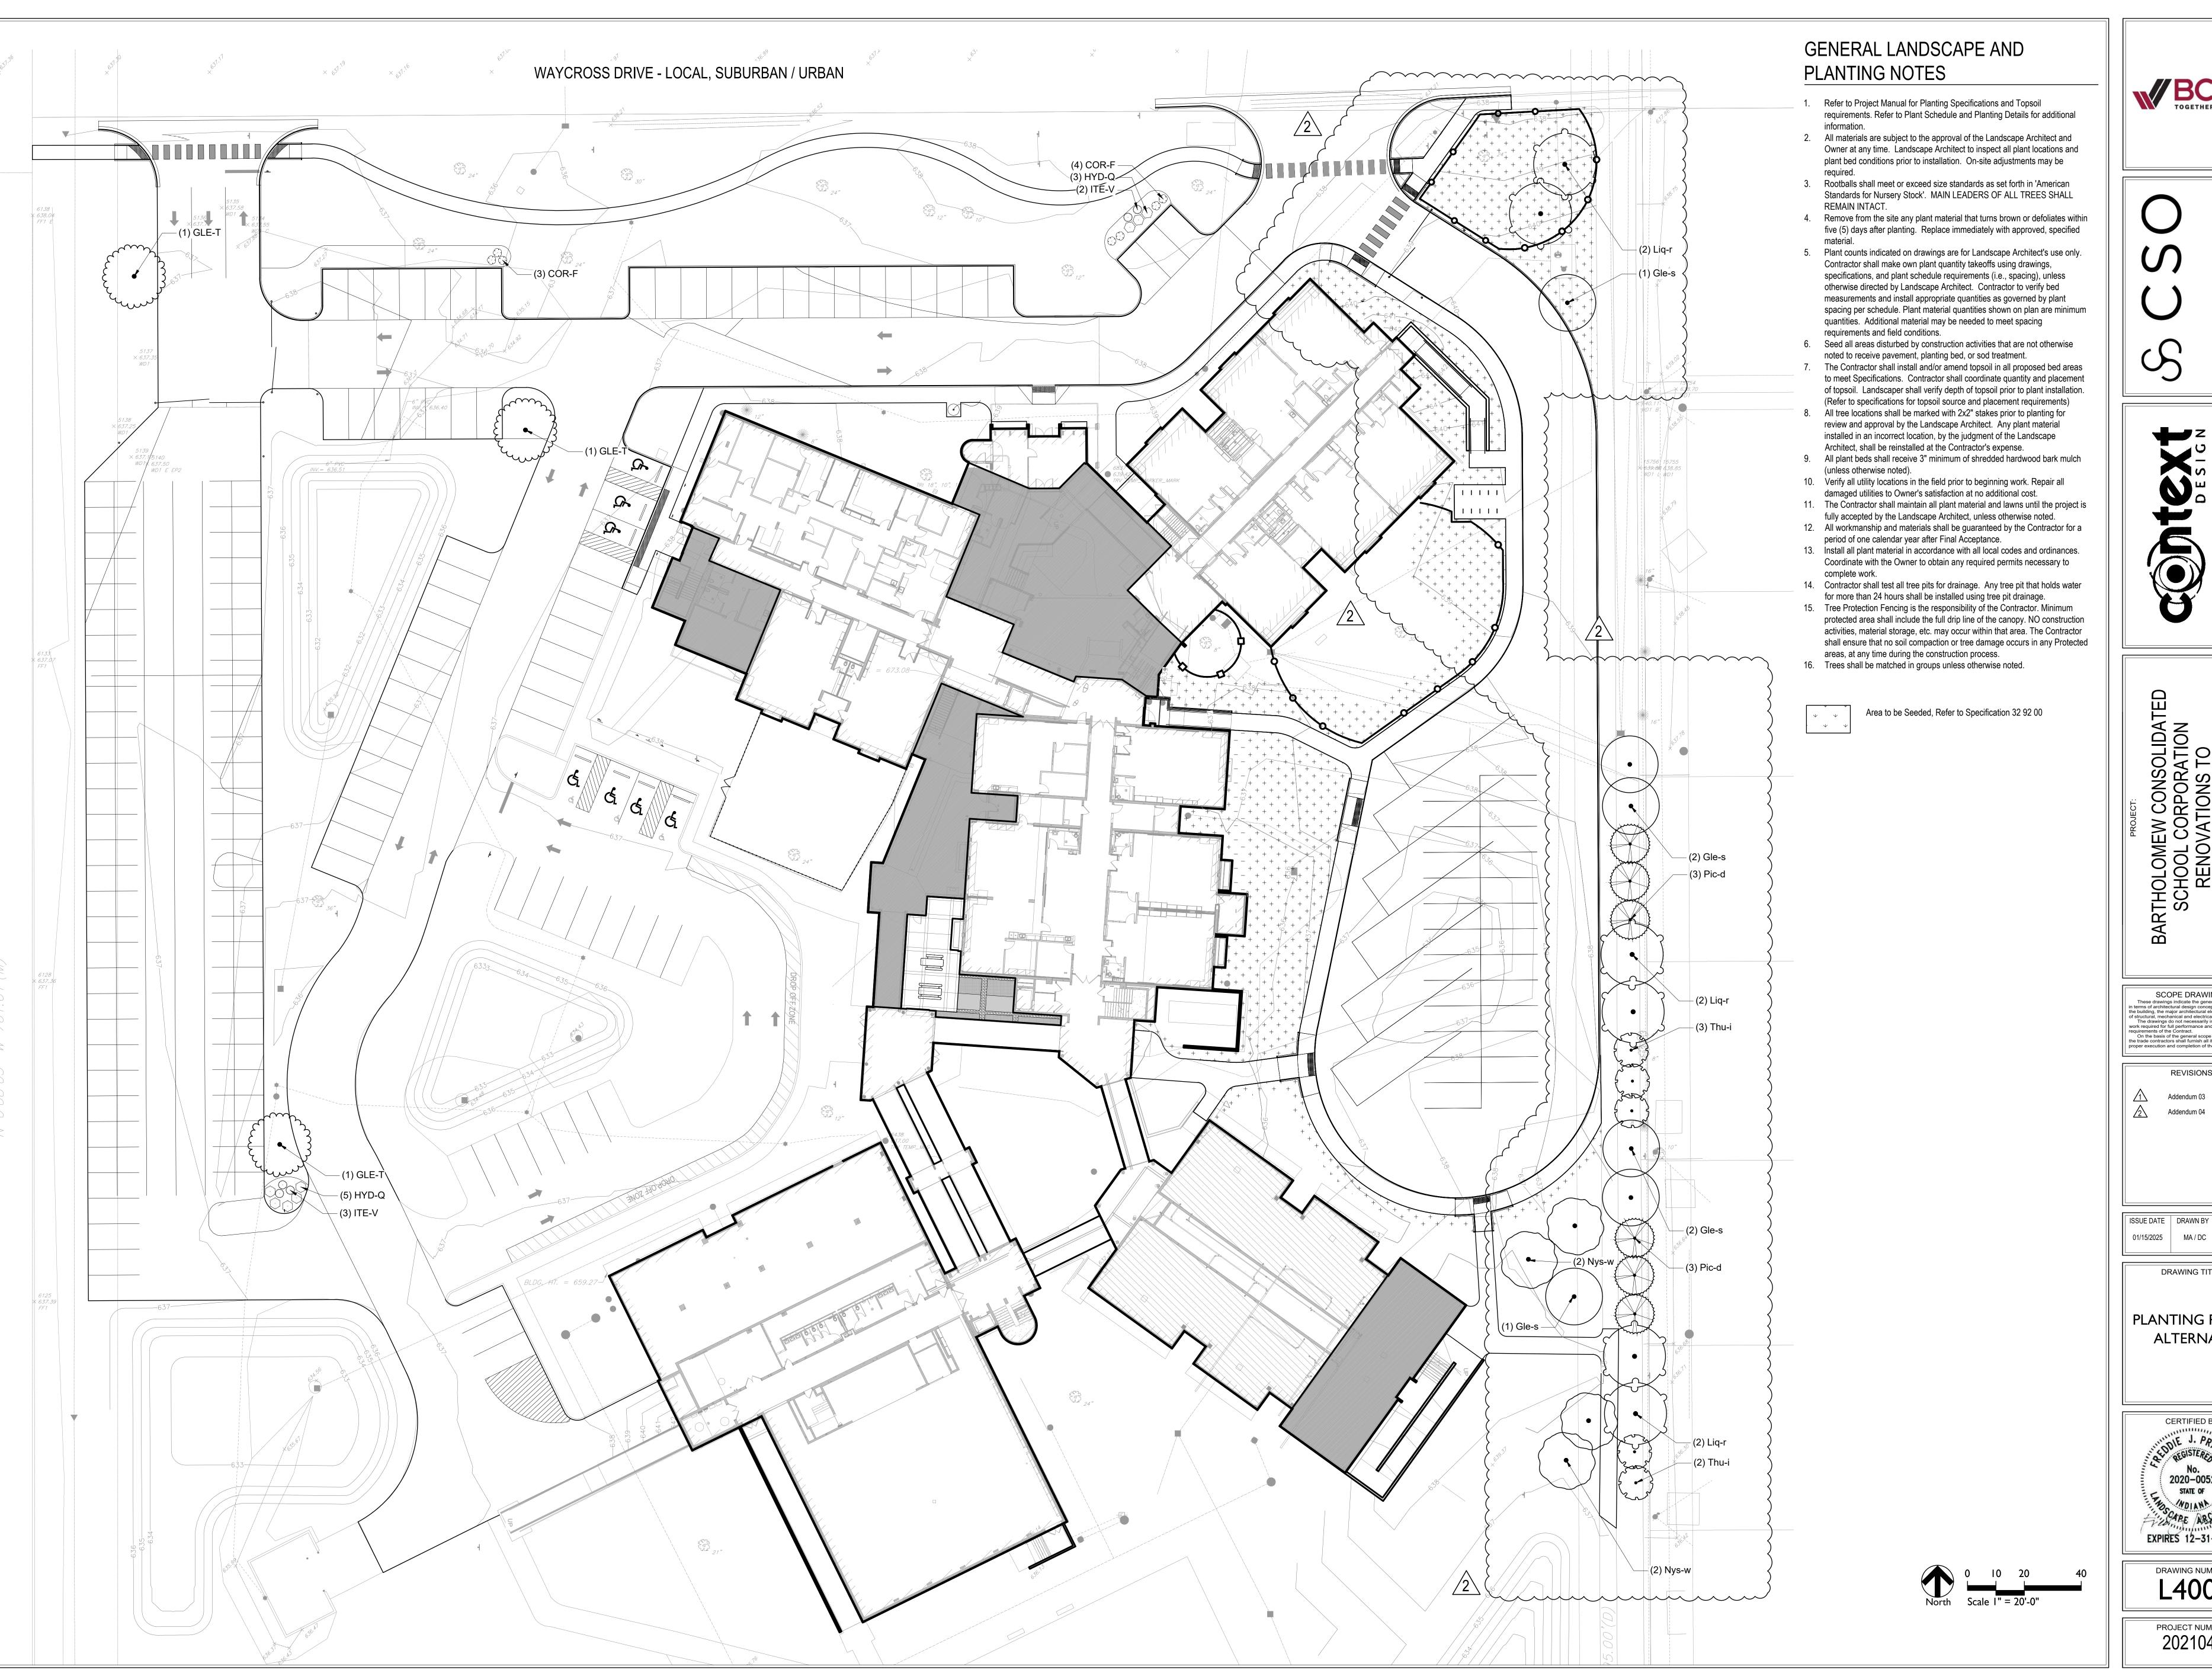




Addendum 04

DRAWING TITLE:

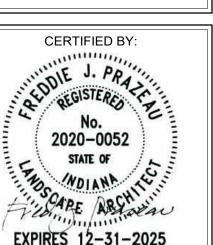
PLANTING PLANS ALTERNATE




DRAWING NUMBER L400a

BASE	BID	PLANT SCHEDULE			
CODE	QTY	BOTANICAL NAME	COMMON NAME	CONT	REMARKS
TREES					
CLA-K	5	Cladrastis kentukea	American Yellowwood	B & B	
GLE-T	2	Gleditsia triacanthos inermis	Thornless Honey Locust	B & B	
CODE	QTY	BOTANICAL NAME	COMMON NAME	SIZE	REMARKS
SHRUBS					
COR-F	36	Cornus sericea 'Farrow'	Arctic Fire® Red Twig Dogwood	pot	
HYD-Q	31	Hydrangea quercifolia	Oakleaf Hydrangea	pot	
HYD-P	20	Hydrangea quercifolia 'Pee Wee'	Pee Wee Oakleaf Hydrangea	pot	
ITE-V	27	Itea virginica 'Henry's Garnet'	Henry's Garnet Sweetspire	pot	
POT-F	15	Potentilla fruticosa 'Goldfinger'	Goldfinger Bush Cinquefoil	pot	

ALTE	RNA	TE PLANT SCHEDULE				
CODE	QTY	BOTANICAL NAME	COMMON NAME	CONT	CAL	REMARKS
TREES						
GLE-T	3	Gleditsia triacanthos inermis	Thornless Honey Locust	B & B		
BUFFERY	ARD					
Gle-s	6	Gleditsia triacanthos inermis 'Shademaster'	Shademaster Honey Locust	B & B	2.5"Cal	\
Liq-r	6	Liquidambar styraciflua 'Rotundiloba'	Round-Lobed Sweet Gum	B & B	2.5"Cal	{
Nys-w	4	Nyssa sylvatica 'Wildfire'	Wildfire Tupelo	B & B	2.5"Cal	
Pic-d	6	Picea glauca `Densata`	Black Hills Spruce	B & B	min. 6` ht.	full, strong central leader, matched, symmetrical
Thu-i	5	Thuja x 'Green Giant'	Green Giant Arborvitae	6` ht.		
CODE	QTY	BOTANICAL NAME	COMMON NAME	SIZE	HEIGHT	REMARKS
SHRUBS						
COR-F	7	Cornus sericea 'Farrow'	Arctic Fire® Red Twig Dogwood	pot		
HYD-Q	8	Hydrangea quercifolia	Oakleaf Hydrangea	pot		
ITE-V	5	Itea virginica 'Henry's Garnet'	Henry's Garnet Sweetspire	pot		

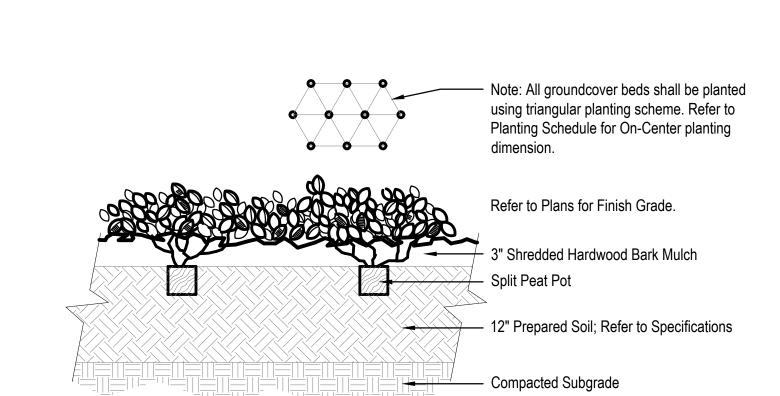





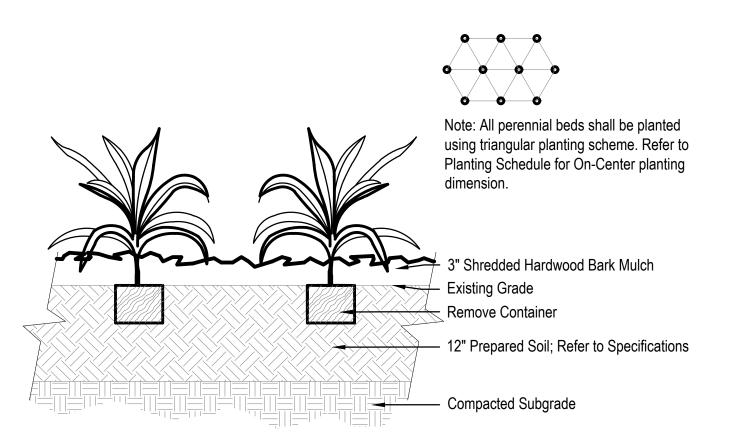

PERENNIAL PLANTING

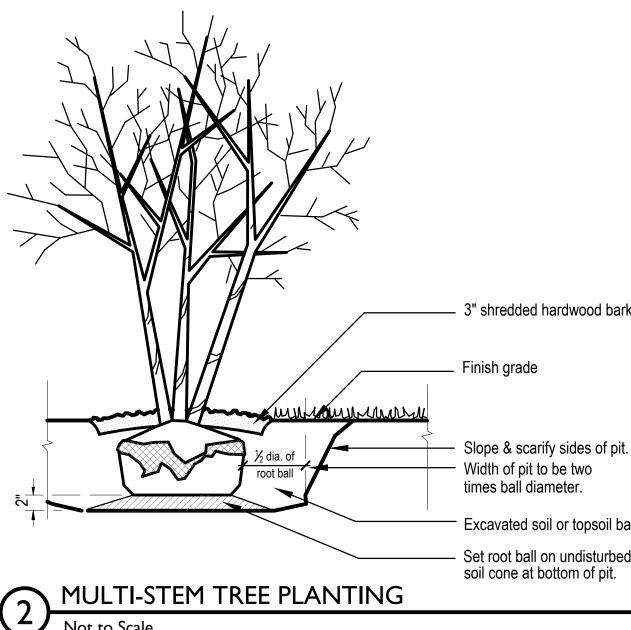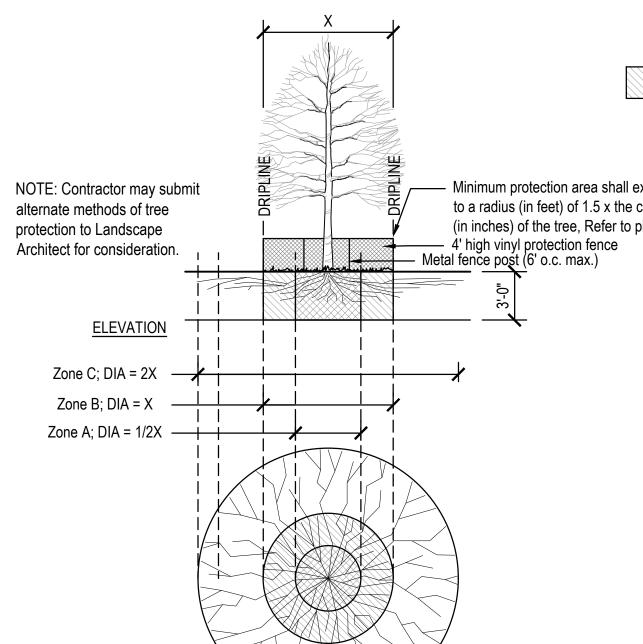Not to Scale





<u>PLAN</u>

TREE PROTECTION

Not To Scale

— Minimum protection area shall extend to a radius (in feet) of 1.5 x the caliper (in inches) of the tree, Refer to plan. 4' high vinyl protection fence at the greater of Zone B (Dripline) or to a radius (in feet) of 1.5x the caliper (in inches) of the tree, minimum, and at Zone C (Feeder Root Zone) if possible.

2. Trenching allowed as follows: - Excavation by hand or with hand-driver trencher may be required. - Limit trench width. Do not disturb Zone A, maintain 2/3 or more of Zone B in undisturbed condition. Tunneling or boring may be required for trenches deeper than 3'-0". ZONE C (FEEDER ROOT ZONE) Operation of heavy equipment and/or stockpiling of materials subject to Landscape Architect's approval. Surface Protection* measures required. 2. Trenching with heavy equipment allowed as follows:

ZONE B (DRIPLINE)

TRENCHING/EXCAVATION

methods to minimize root damage.

- Minimize trench width. - Maintain 2/3 or more of Zone C in undisturbed condition. FENCING/ROOT PROTECTION

Refer to Detail this Sheet. Upon Landscape Architect's approval, a plywood box (8' minimum height) may be used

where fencing cannot be achieved. Landscape Architect's approval required for use/access within Zone B. Permission for

ZONE A (CRITICAL ROOT ZONE)

1. NO DISTURBANCE ALLOWED without site-specific inspection and approval of

3. Tunneling or boring required to install utilities 3'-0" below grade or deeper.

Architect's approval. Surface Protection* measures required.

Severance of roots larger than 2" diameter requires Landscape Architect's approval.

Operation of heavy equipment and/or stockpiling of materials subject to Landscape

use/access requires Surface Protection Measures for all unfenced, unpaved surfaces within Zone B.

*SURFACE PROTECTION MEASURES Mulch Layer, 6"-8" Depth

3/4" Plywood
 Steel Plates

NOTE:

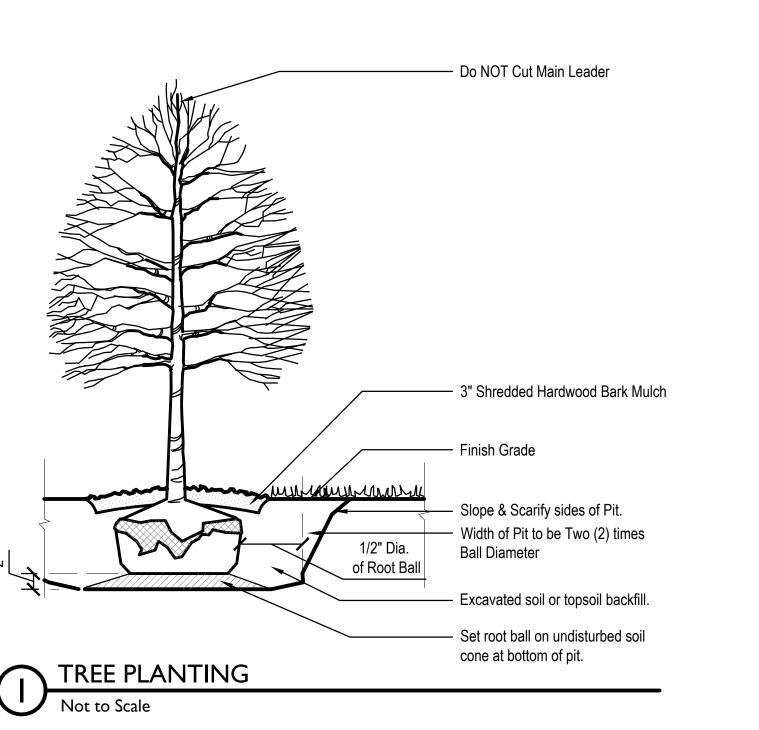
1. Refer to tree protection specifications. 2. Contractor may submit alternate methods of tree protection

to Landscape Architect for Consideration.

— 3" shredded hardwood bark mulch Slope & scarify sides of pit. Excavated soil or topsoil backfill Set root ball on undisturbed soil cone at bottom of pit.

NOTE: Remove burlap from top 1/3 of root ball or carefully remove container. — 3" shredded hardwood bark mulch 3" high topsoil saucer for individual plants. —— Finish grade. Slope & scarify sides of pit. Width of pit to be two times ball diameter. Excavated soil or topsoil backfill. Set root ball on undisturbed soil cone at bottom of pit. 4 SHRUB PLANTING

Not to Scale



SCOPE DRAWINGS: These drawings indicate the general scope of the project in terms of architectural design concept, the dimensions of the building, the major architectural elements and the type of structural prochaginal and legislating legislating. of structural, mechanical and electrical systems.

The drawings do not necessarily indicate or describe all

> **REVISIONS:** Addendum 04

ISSUE DATE | DRAWN BY | CHECKED BY

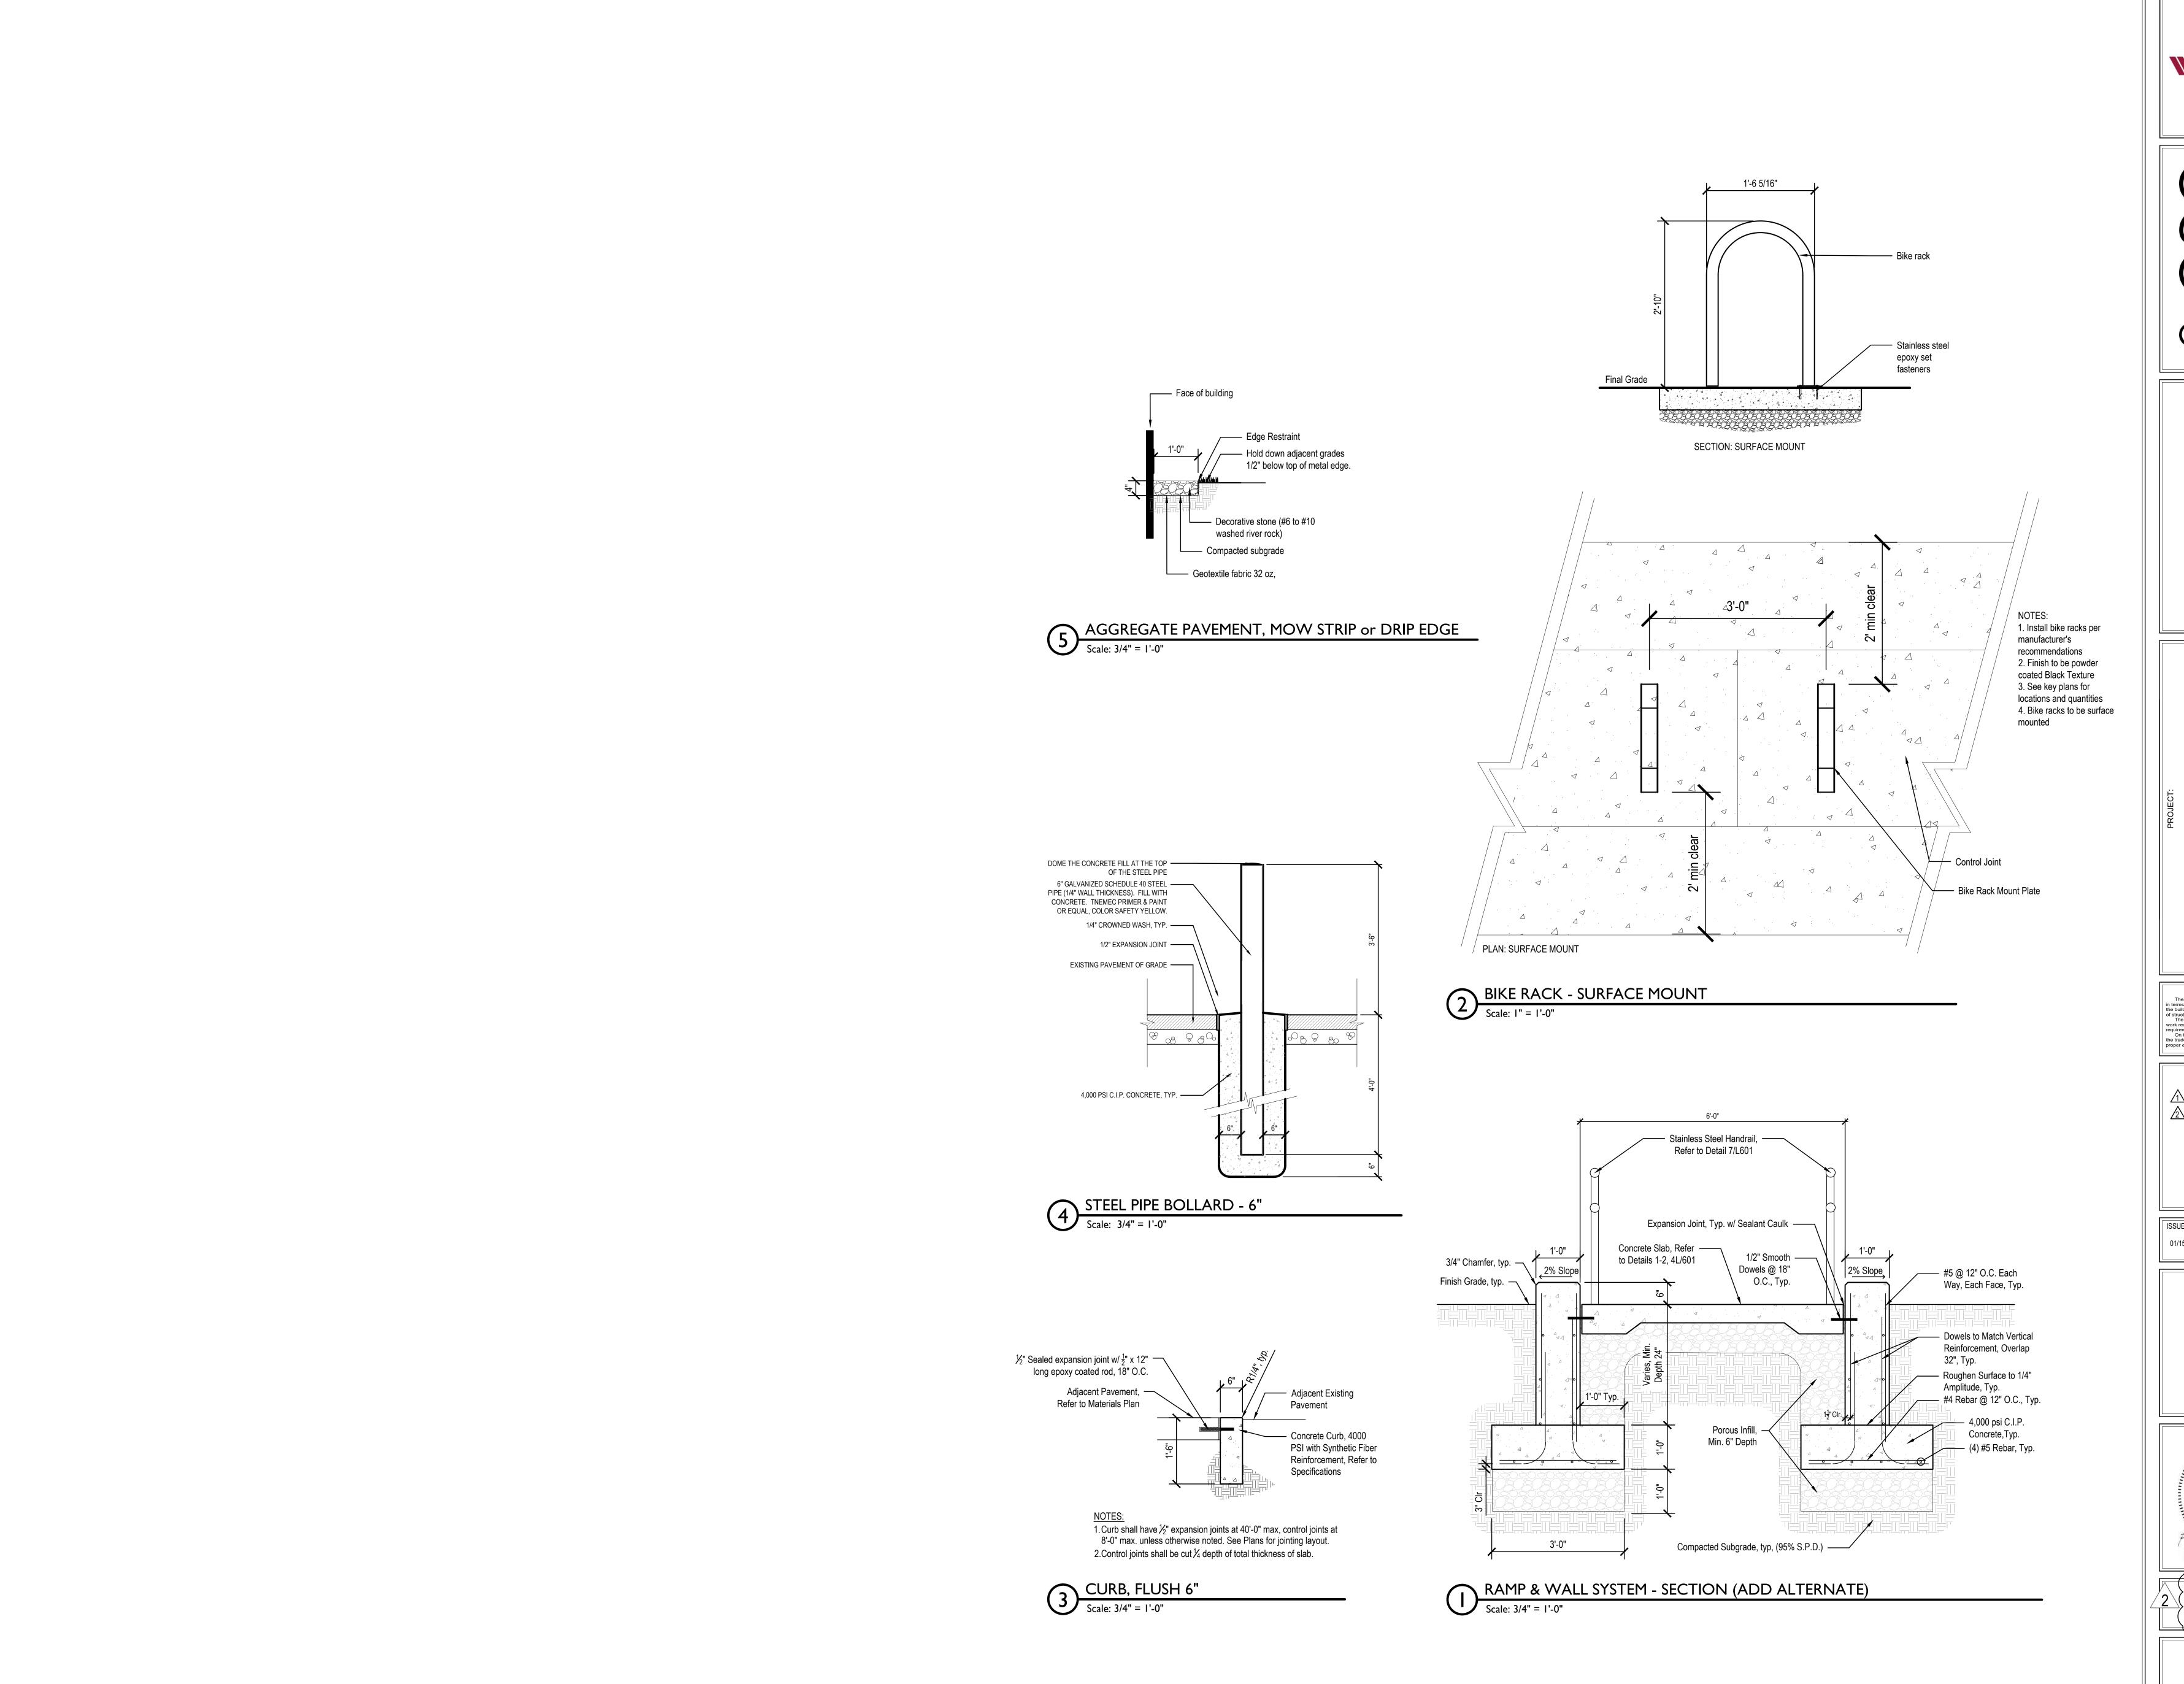
01/15/2025 MA / DC LM

PLANTING **DETAILS & SCHEDULE**

DRAWING TITLE:

CERTIFIED BY: ALDDIE J. PAA 2020-0052 STATE OF EXPIRES 12-31-2025

DRAWING NUMBER L410



SCOPE DRAWINGS:

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ISSUE DATE DRAWN BY CHECKED BY 01/15/2025 | MA / DC | LM

DRAWING TITLE: SITE DETAILS



DRAWING NUMBER L602



RENOVATION LEGEND:

WORK TO BE INSTALLED

WORK TO REMAIN

GENERAL NOTES:

1. SEE E001 FOR GENERAL NOTES. 2. CONNECT LIGHT FIXTURE(S) AT CLASSROOM ENTRY WAYS TO EXISTING CIRCUIT AND CONTROLS IN THE AREA. REWORK AS REQUIRED AND PROVIDE WIRING.

3. UNLESS NOTED OTHERWISE, TYPE 'X4' LIGHT FIXTURES TO BE

PLAN NOTES:

 CONNECT TO EXISTING LIGHTING CIRCUIT IN CORRIDOR AND PROVIDE WIRING. 2. LIGHT FIXTURE TO BE INSTALLED +8'-0" AFF.

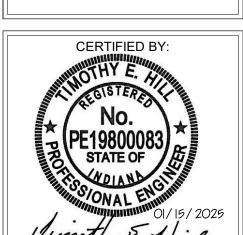
3. MOUNT LIGHT FIXTURE TO EXISTING WIREMOLD RACEWAY IN CORRIDOR.

LIGHT FIXTURE(S) TO BE MOUNTED +8'-0" AFF. PROVIDE PHOTOCELL -AT SAME HEIGHT AS LIGHT FIXTURE FOR CONTROLS.

WBCSC TOGETHER WE LEARN

1 ADDENDUM #01 01/29/25 4 ADDENDUM #04 02/12/25

DRAWING TITLE: LIGHTING



E201C

PROJECT NUMBER 2024023

KEY PLAN NORTH

MDF B310 | MDF B310 UNIT A UNIT B FLEX CLASSROOM #224 1ST / 2ND GRADE CLASSROOM #226 1ST / 2ND GRADE CLASSROOM #222 A206 A209 A202 A204 STAFF TOILET A222 A201 A219 STORAGE 1ST / 2ND GRADE CLASSROOM #225 ACTIVITY COMMONS #223 CLASSROOM #221 A212 A215 A220 UNIT B MDF B310

GROUND LEVEL DISTRIBUTION PLAN -1 UNIT A 1/8" = 1'-0"

GENERAL PATHWAYS NOTES

A ALL CABLING SHALL BE TERMINATED IN THE ER/TR NOTED IN THE TELECOM SCHEDULES.

B CONTRACTOR SHALL SUPPLY ALL CONDUIT, BOXES, AND CABLE TRAY AS REQUIRED TO ENSURE ALL TRANSMISSION MEDIA IS FULLY SUPPORTED FROM ALL DEVICE LOCATIONS TO THE POINT OF TERMINATION.

C ALL TELECOM PATHWAY SYSTEMS SHALL BE INDEPENDENTLY SUPPORTED FROM AND ATTACHED TO

THE BUILDING STRUCTURE. D ALL TELECOM PATHWAY SYSTEMS SHALL BE COMPLETELY AND PROPERLY LABELED AS REQUIRED IN REFERENCED STANDARDS.

E CONDUIT SYSTEMS SHALL BE PROVIDED FOR ALL PATHWAYS IN INACCESSIBLE CEILING SPACES AND WHERE EXPOSED TO PUBLIC VIEW. ALL CONDUIT SYSTEMS THROUGHOUT THE BUILDING SHALL INCLUDE PROPERLY SIZED SLEEVED PENETRATIONS WITH BUSHINGS THROUGH ALL BARRIERS.

F ALL TELECOM OUTLET BOXES SHALL BE A MINIMUM 4-11/16" SQUARE BOX NO LESS THAN 2-1/8" DEEP WITH A MINIMUM 1-1/4" CONDUIT STUBBED ABOVE ACCESSIBLE CEILING UNLESS NOTED OTHERWISE WITHIN THE T-SERIES DRAWINGS. G CORRIDOR CABLE TRAY SHALL BE PROVIDED AS

REQUIRED BY THE CONTRACT DRAWINGS. REFER TO DIVISION 27 SPECIFICATIONS FOR ADDITIONAL PRODUCT DETAILS AND REQUIREMENTS. H CONTRACTOR SHALL NOT EXCEED 40% FILL RATIO WITHIN ANY CONDUIT MEANT FOR

TELECOMMUNICATIONS CABLING. I CONTRACTOR SHALL CALCULATE FILL RATIOS BASED ON ACTUAL CATEGORY 6A CABLING USED. TYPICAL FILL RATIOS FOR CATEGORY 6A CABLE ARE SHOWN HERE FOR REFERENCE PURPOSES ONLY: 1" EMT = 5 CABLES; 1-1/4" EMT = 9 CABLES; 2" EMT = 21 CABLES; 3" EMT = 57 CABLES;

4" EMT = 93 CABLES J CONDUIT RUNS SHALL NOT EXCEED 100 FEET WITHOUT A PULLING POINT AND SHALL NOT INCLUDE MORE THAN TWO 90° BENDS BETWEEN PULLING POINTS. IF THE PATH OF THE CONDUIT RUN REQUIRES BENDS EXCEEDING A TOTAL OF 180°, INSTALLATION OF AN APPROPRIATELY SIZED JUNCTION BOX IS REQUIRED.

K CONTRACTOR SHALL PROVIDE PROPERLY RATED FIRE STOP SYSTEMS FOR ALL CONDUIT AND/OR CABLE TRAY ENTERING THE TELECOMMUNICATIONS ROOMS. EACH CONTRACTOR IS RESPONSIBLE FOR SEALING PENETRATIONS AFTER EACH SCOPE OF WORK IS COMPLETED.

L CONTRACTOR SHALL PROVIDE FIRE STOPS TO SEAL ALL PENETRATIONS THROUGH FLOORS, WALLS, STAIRS, AND ELEVATORS AS NECESSARY TO MEET CODE REQUIREMENTS. FIRE STOPS SHALL BE PROVIDED IN ACCORDANCE WITH ALL APPLICABLE CODES AND STANDARDS.

KEY PLAN NORTH

1650 E. 49TH ST.
INDIANAPOLIS, IN
46205
317.536.8000
DESIGN27.COM

SCOPE DRAWINGS:

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REVISIONS: Addendum 04 02/12/2025

ISSUE DATE | DRAWN BY | CHECKED BY MKD

DRAWING TITLE: GROUND LEVEL DISTRIBUTION PLAN - UNIT A





DRAWING NUMBER T101A

GROUND LEVEL DISTRIBUTION PLAN UNIT D
1/8" = 1'-0"

GENERAL PATHWAYS NOTES

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KEY PLAN NORTH

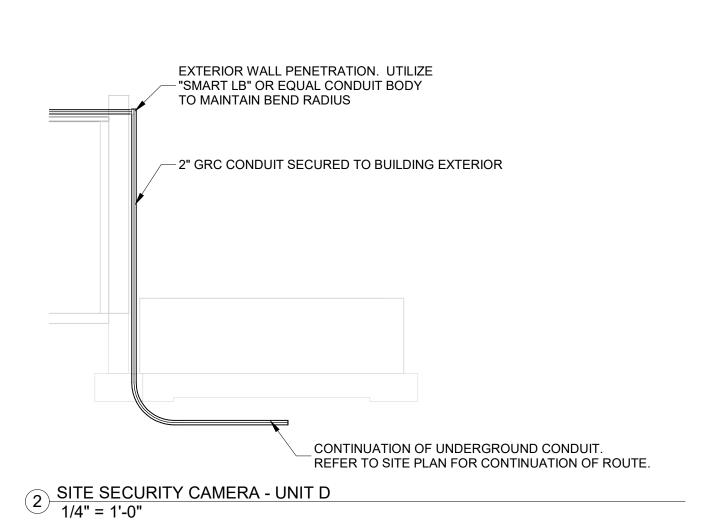
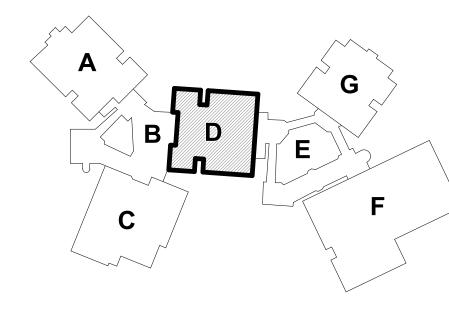
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REVISIONS: Addendum 04 02/12/2025

ISSUE DATE | DRAWN BY | CHECKED BY MKD

01/15/25

DRAWING TITLE: GROUND LEVEL DISTRIBUTION PLAN - UNIT D



DRAWING NUMBER T101D



A MINIMUM CATEGORY 6A COMPLIANT 4-PAIR UNSHIELDED TWISTED PAIR (UTP). ALL HORIZONTAL

CABLING MUST BE PLENUM RATED. B CONTRACTOR SHALL PROVIDE A DOCUMENTED MANUFACTURER CERTIFIED SOLUTION INCLUDING THE MINIMUM PERFORMANCE AND APPLICATIONS

WARRANTY. PAINTING OF THE STRUCTURED CABLING WILL VOID THE WARRANTY. ENSURE PROPER COORDINATION

WITH PAINTING CONTRACTOR SO THAT ALL STRUCTURED CABLING IS PROTECTED PRIOR TO ANY PAINTING. D PROVIDE A MINIMUM 10 FOOT MAINTENANCE LOOP ON EACH HORIZONTAL CABLING RUN. MAINTENANCE LOOPS SHALL BE STORED ABOVE ACCESIBLE CEILINGS, IN CABLE TRAY, AND IN

APPROPRIATE SUPPORTS AND SHALL NOT TOUCH THE E ALL PIN/PAIR ASSIGNMENTS SHALL BE T568B.

F REFER TO SPECIFICATION SECTION 27 15 13 FOR CABLE JACKET COLOR REQUIREMENTS G LABELING SHALL BE COMPLETED AS DEFINED IN THE CONTRACT DOCUMENTS AND SHALL BE COORDINATED WITH THE OWNER.

TELECOMMUNICATION ROOM CABLE TRAY. CABLING ABOVE CEILING SHALL BE SUSPENDED FROM

H PROVIDE ALL TELECOMMUNICATION OUTLETS AS SHOWN ON THE DRAWINGS AND AS REQUIRED TO PROVIDE CONNECTIONS FOR EACH DEVICE SHOWN ON THE DRAWINGS.

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J ALL WIRELESS ACCESS POINTS SHALL BE OWNER FURNISHED AND OWNER INSTALLED. K ALL CLOCK LOCATIONS SHOWN ON T200 SERIES SHEETS SHALL BE INSTALLED UTILIZING EXISITING CLOCKS REMOVED AND STORED DURING DEMOLITION. RETURN ALL REMAINING CLOCKS TO OWNER AT END

TECHNOLOGY LEGEND

OF PROJECT.

- ABOVE CEILING SECURITY DATA LOCATION

▼ DATA LOCATION - FLUSH MOUNTED

■ DATA LOCATION - SURFACE MOUNTED DATA RE-CABLE LOCATION - FLUSH MOUNTED

DATA RE-CABLE LOCATION - SURFACE MOUNTED

FILOOR BOX LOCATION MONITOR LOCATION

WALL PHONE LOCATION

WIRELESS ACCESS POINT - CEILING MOUNTED

WIRELESS ACCESS POINT - WALL MOUNTED

AV INPUT LOCATION TYPE 1 - FLUSH MOUNTED

AV INPUT LOCATION TYPE 2 - FLUSH MOUNTED

AV INPUT LOCATION TYPE 1 - SURFACE MOUNTED

AV FLOOR BOX LOCATION

CALL SWITCH LOCATION CLOCK LOCATION

CLASSROOM AUDIO SYSTEM LOCATION (BY

PAGING SPEAKER - CEILING MOUNTED (BY OTHERS)

PAGING SPEAKER - WALL FLUSH MOUNTED

PAGING SPEAKER - WALL SURFACE MOUNTED

S PROGRAM SPEAKERS (BY OTHERS) VIDEO BOARD LOCATION - FLUSH MOUNTED

VIDEO BOARD LOCATION - SURFACE MOUNTED

CR CARD READER LOCATION

CR CARD READER - MULLION MOUNTED

DOOR POSITION SENSOR LOCATION DB DURESS AND DOOR RELEASE BUTTON ASSEMBLY

MH) MAGNETIC HOLD LOCATION

(sc) SECURITY CAMERA - CEILING MOUNTED

SECURITY CAMERA - WALL MOUNTED

VI VIDEO INTERCOM DOOR STATION

(AS) VIDEO INTERCOM ANSWERING STATION

SHEET NOTES

1 EXISTING LENELS2 MICRONODE PLUS AND ALL CONNECTED DEVICES TO REMAIN.

KEY PLAN NORTH

ISSUE DATE | DRAWN BY | CHECKED BY

01/15/25

SCOPE DRAWINGS:

These drawings indicate the general scope of the project in terms of architectural design concept, the dimensions of the building, the major architectural elements and the type of structural, mechanical and electrical systems.

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REVISIONS:

Addendum 04 02/12/2025

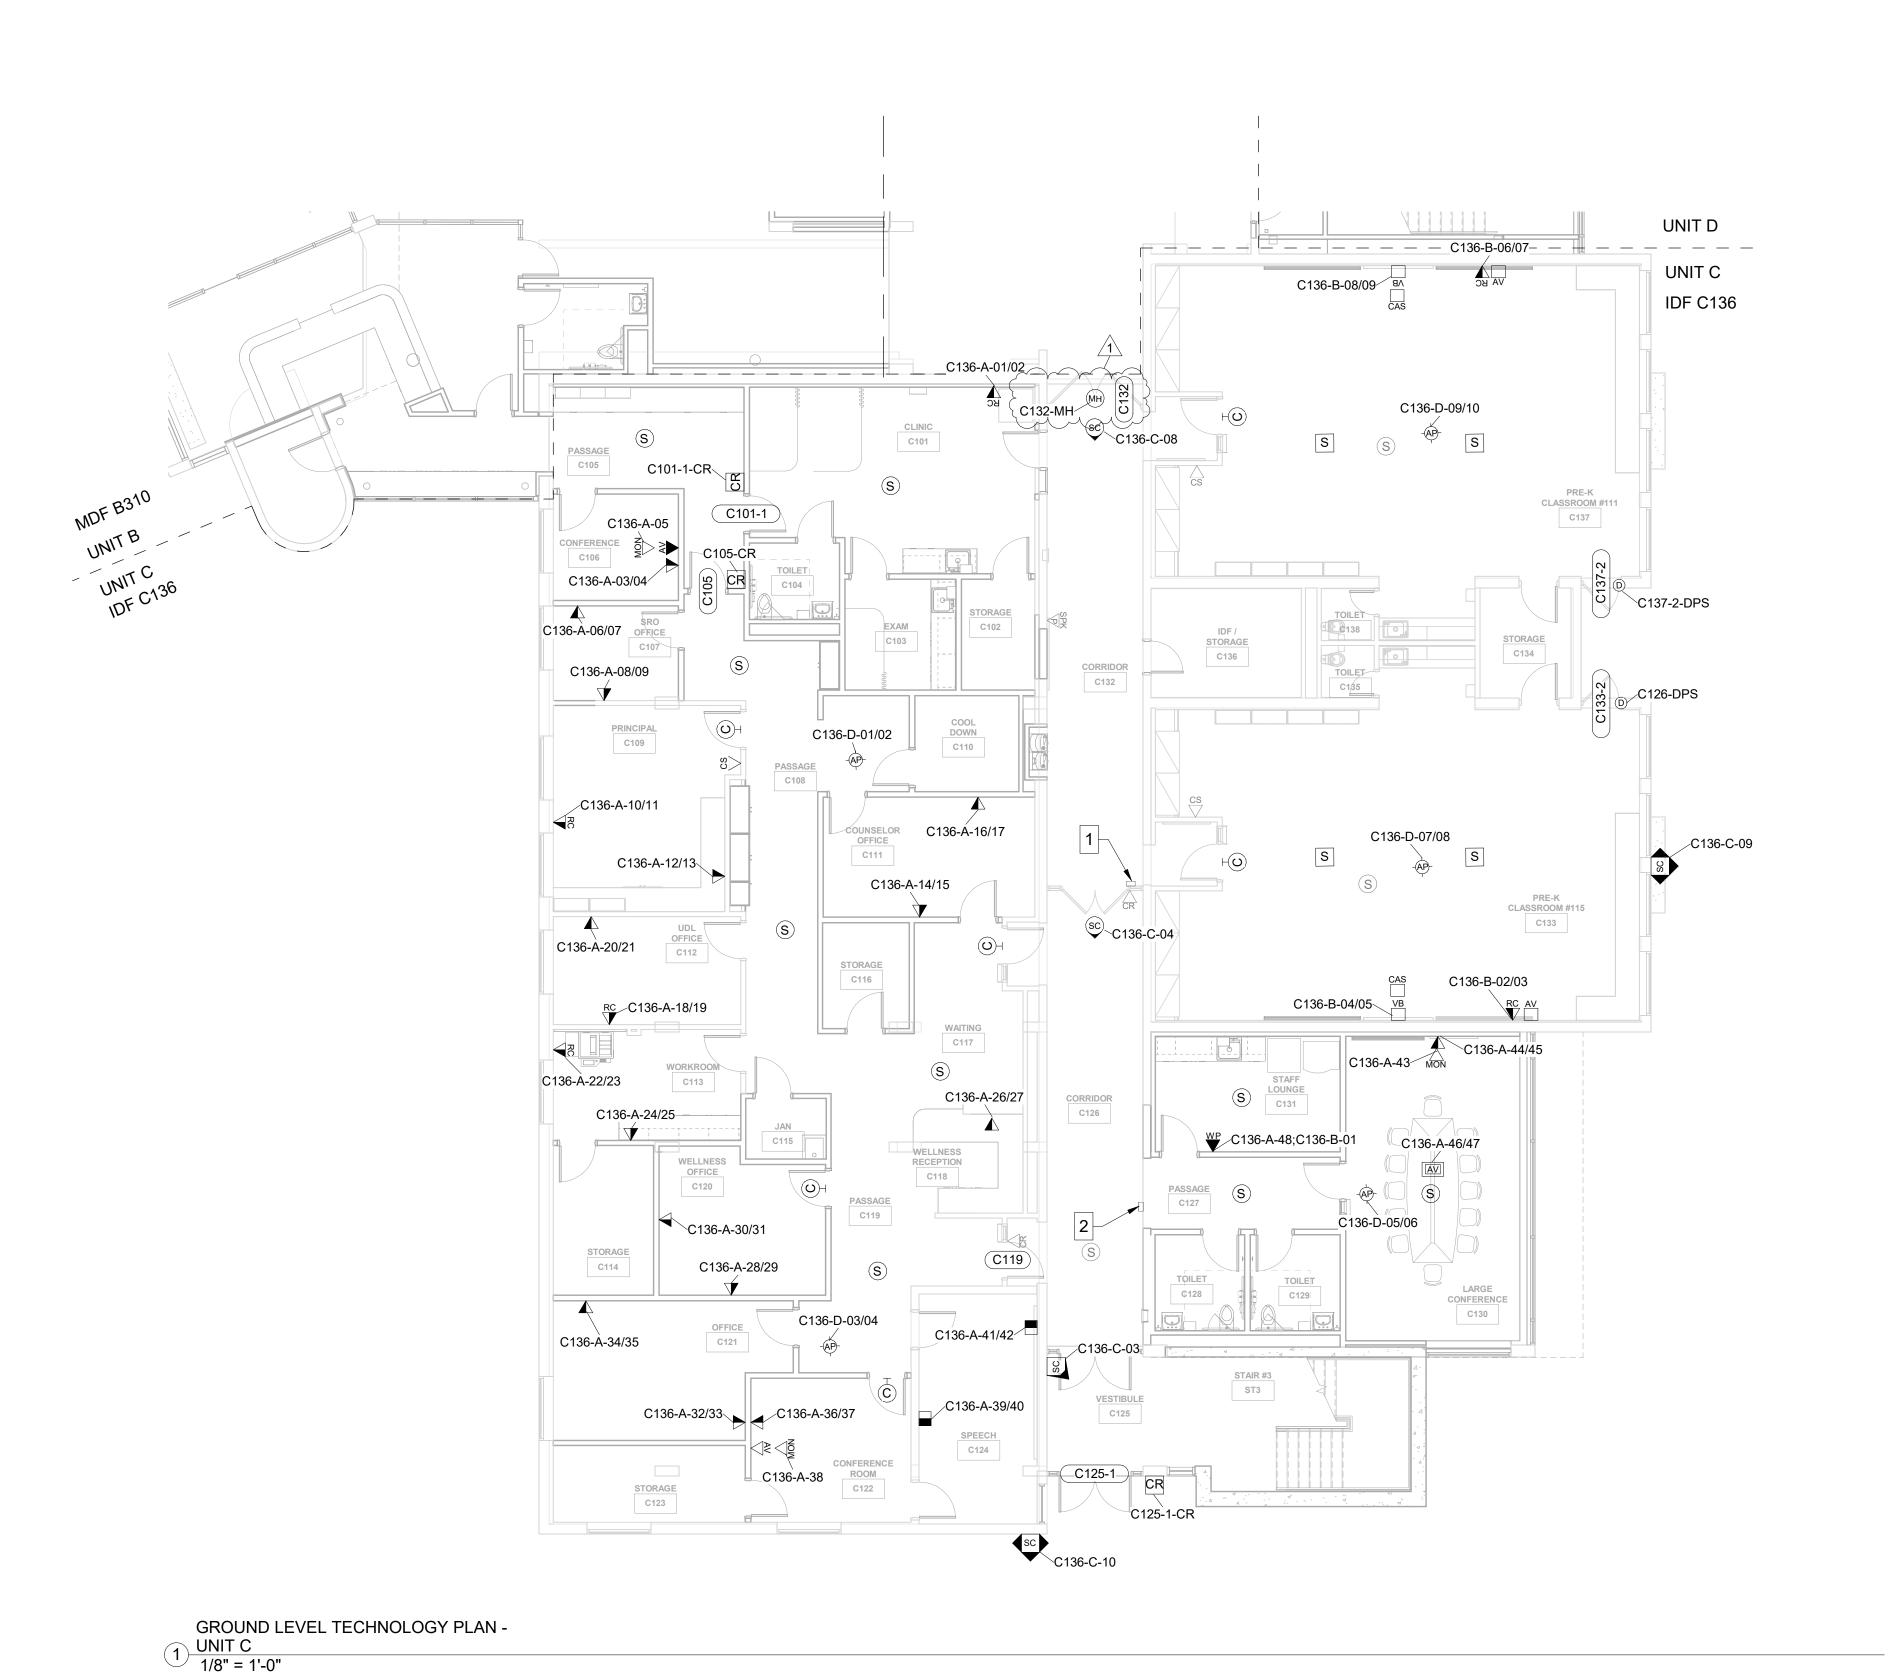
DRAWING TITLE: GROUND LEVEL

MKD

TECHNOLOGY PLAN - UNIT A



DRAWING NUMBER T201A



- A MINIMUM CATEGORY 6A COMPLIANT 4-PAIR UNSHIELDED TWISTED PAIR (UTP). ALL HORIZONTAL CABLING MUST BE PLENUM RATED.
- CABLING MUST BE PLENUM RATED.

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- MANUFACTURER CERTIFIED SOLUTION INCLUDING MINIMUM PERFORMANCE AND APPLICATIONS WARRANTY.
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- J ALL WIRELESS ACCESS POINTS SHALL BE OWNER FURNISHED AND OWNER INSTALLED.

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TECHNOLOGY LEGEND

120111102001 220

OF PROJECT.

- ABOVE CEILING SECURITY DATA LOCATION

 DATA LOCATION FLUSH MOUNTED
- DATA LOCATION SURFACE MOUNTED
- DATA RE-CABLE LOCATION FLUSH MOUNTED
- DATA RE-CABLE LOCATION SURFACE MOUNTED
- FB FLOOR BOX LOCATION
- MONITOR LOCATION
- ₩P WALL PHONE LOCATION
- WIRELESS ACCESS POINT CEILING MOUNTED
- WIRELESS ACCESS POINT WALL MOUNTED
- AV INPUT LOCATION TYPE 1 FLUSH MOUNTED
- AV INPUT LOCATION TYPE 2 FLUSH MOUNTED
- AV INPUT LOCATION TYPE 1 SURFACE MOUNTED
- AV FLOOR BOX LOCATION
- CLOCK LOCATION
- CLASSROOM AUDIO SYSTEM LOCATION (BY
- PAGING SPEAKER CEILING MOUNTED (BY OTHERS)
- PAGING SPEAKER WALL FLUSH MOUNTED
- PAGING SPEAKER WALL SURFACE MOUNTED

 S PROGRAM SPEAKERS (BY OTHERS)
- VIDEO BOARD LOCATION FLUSH MOUNTED
- VIDEO BOARD LOCATION SURFACE MOUNTED
- CR CARD READER LOCATION
- CR CARD READER MULLION MOUNTED
- D DOOR POSITION SENSOR LOCATION
- DURESS AND DOOR RELEASE BUTTON ASSEMBLY
- MH MAGNETIC HOLD LOCATION

 SECURITY CAMERA CELLING MOUNTED
- SECURITY CAMERA CEILING MOUNTED
- SECURITY CAMERA WALL MOUNTED
- VI VIDEO INTERCOM DOOR STATION
- (AS) VIDEO INTERCOM ANSWERING STATION

SHEET NOTES

- 1 NEW LENELS2 MICRONODE PLUS TO SERVE CARD READER AT DOOR C126 AND MONITORING AT DOORS
- C133-2 AND C137-2.

2 NEW LENELS2 MICRONODE PLUS TO SERVE CARD READERS AT DOORS C119 AND C125-1.

KEY PLAN NORTH

ISSUE DATE DRAWN BY CHECKED BY
01/15/25 MKD JKK

GROUND LEVEL
TECHNOLOGY
PLAN - UNIT C



T201C

PROJECT NUMBER 2024023



8831 Keystone Crossing, Indianapolis, IN 4

1650 E. 49TH ST.
INDIANAPOLIS, IN
46205
317.536.8000
ACOUSTICS DESIGN27.COM

SCHOOL CORPORATION

RENOVATIONS TO

FRANCES SMITH ELEMENTA

505 WAYCROSS DRIVE, COLUMBUS, IN 4720

SCOPE DRAWINGS:


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REVISIONS:

Addendum 04 02/12/2025



GROUND LEVEL TECHNOLOGY PLAN UNIT D
1/8" = 1'-0"

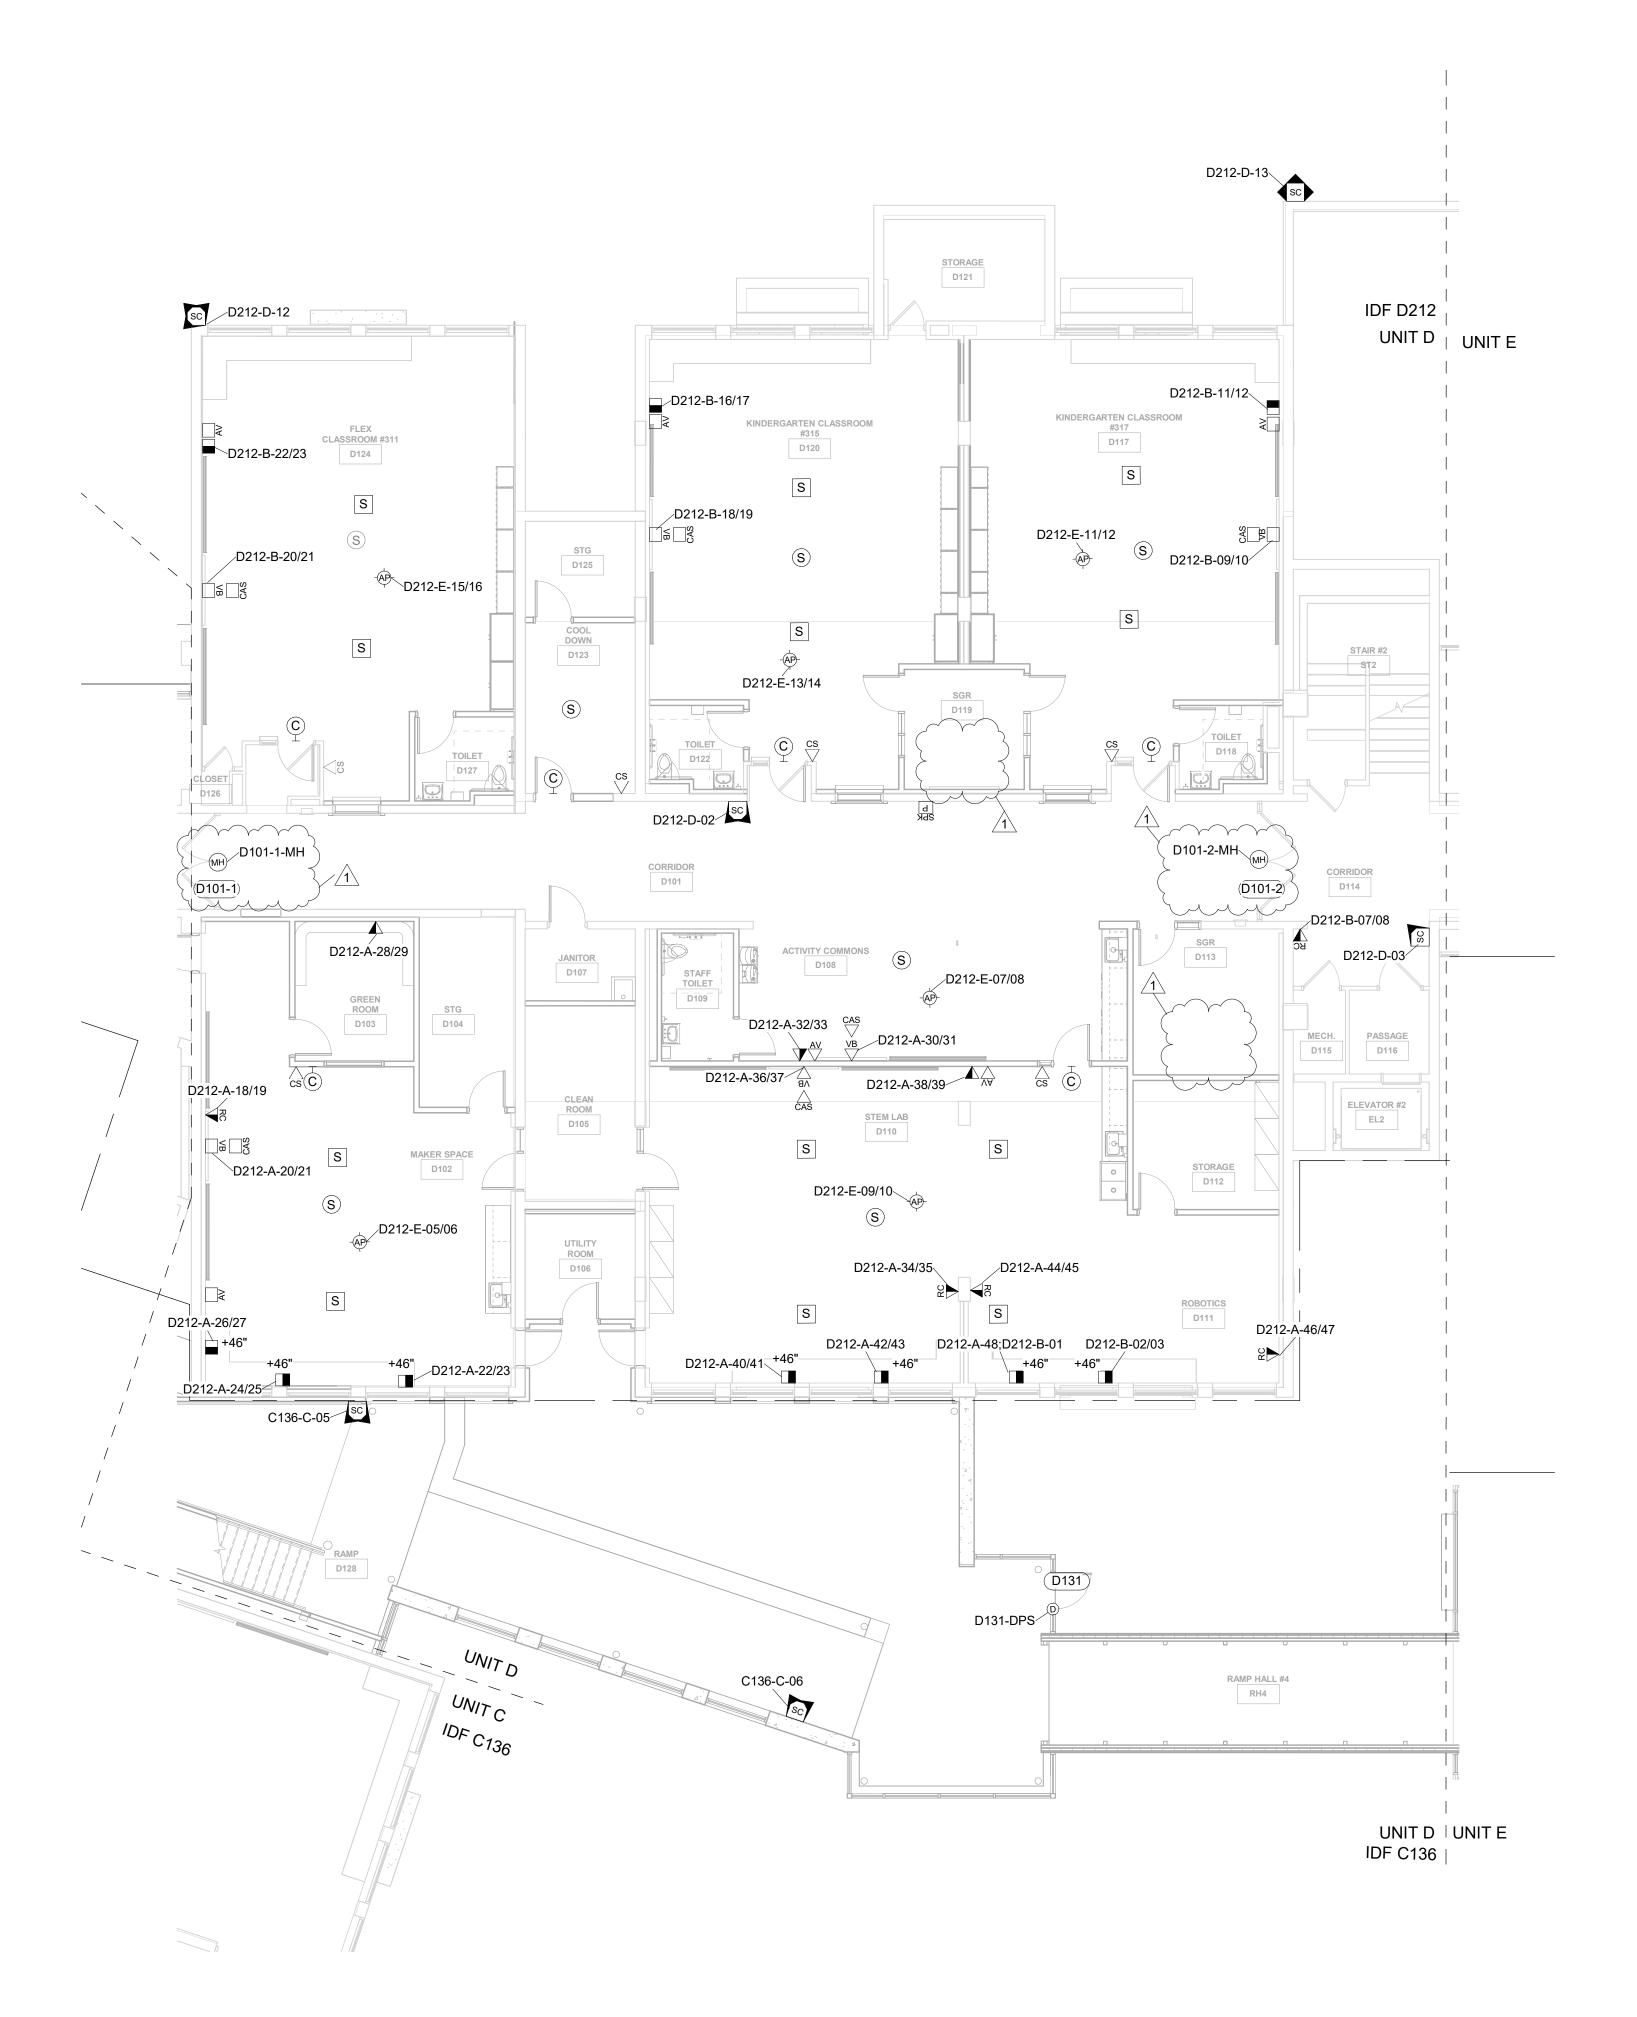GENERAL HORIZONTAL CABLING NOTES

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- DATA LOCATION SURFACE MOUNTED
- DATA COCATION SURFACE MOUNTED

 RC

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- FB FLOOR BOX LOCATION

 MONITOR LOCATION
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- ₩ WIRELESS ACCESS POINT WALL MOUNTED
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- © CLOCK LOCATION
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- VI VIDEO INTERCOM DOOR STATION
- (AS) VIDEO INTERCOM ANSWERING STATION



Keystone Crossing, Indianapolis, IN 46240

TECHNOLOGY 1650 E. 49TH ST. INDIANAPOLIS, IN 46205

TECHNOLOGY 317.536.8000

TECHNOLOGY DESIGN27.COM

BARTHOLOMEW CONSOLIDATED
SCHOOL CORPORATION
RENOVATIONS TO
FRANCES SMITH ELEMENTAF

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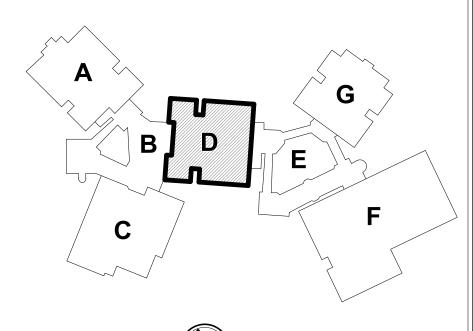
REVISIONS:


ISSUE DATE DRAWN BY CHECKED BY
01/15/25 MKD JKK

GROUND LEVEL
TECHNOLOGY
PLAN - UNIT D



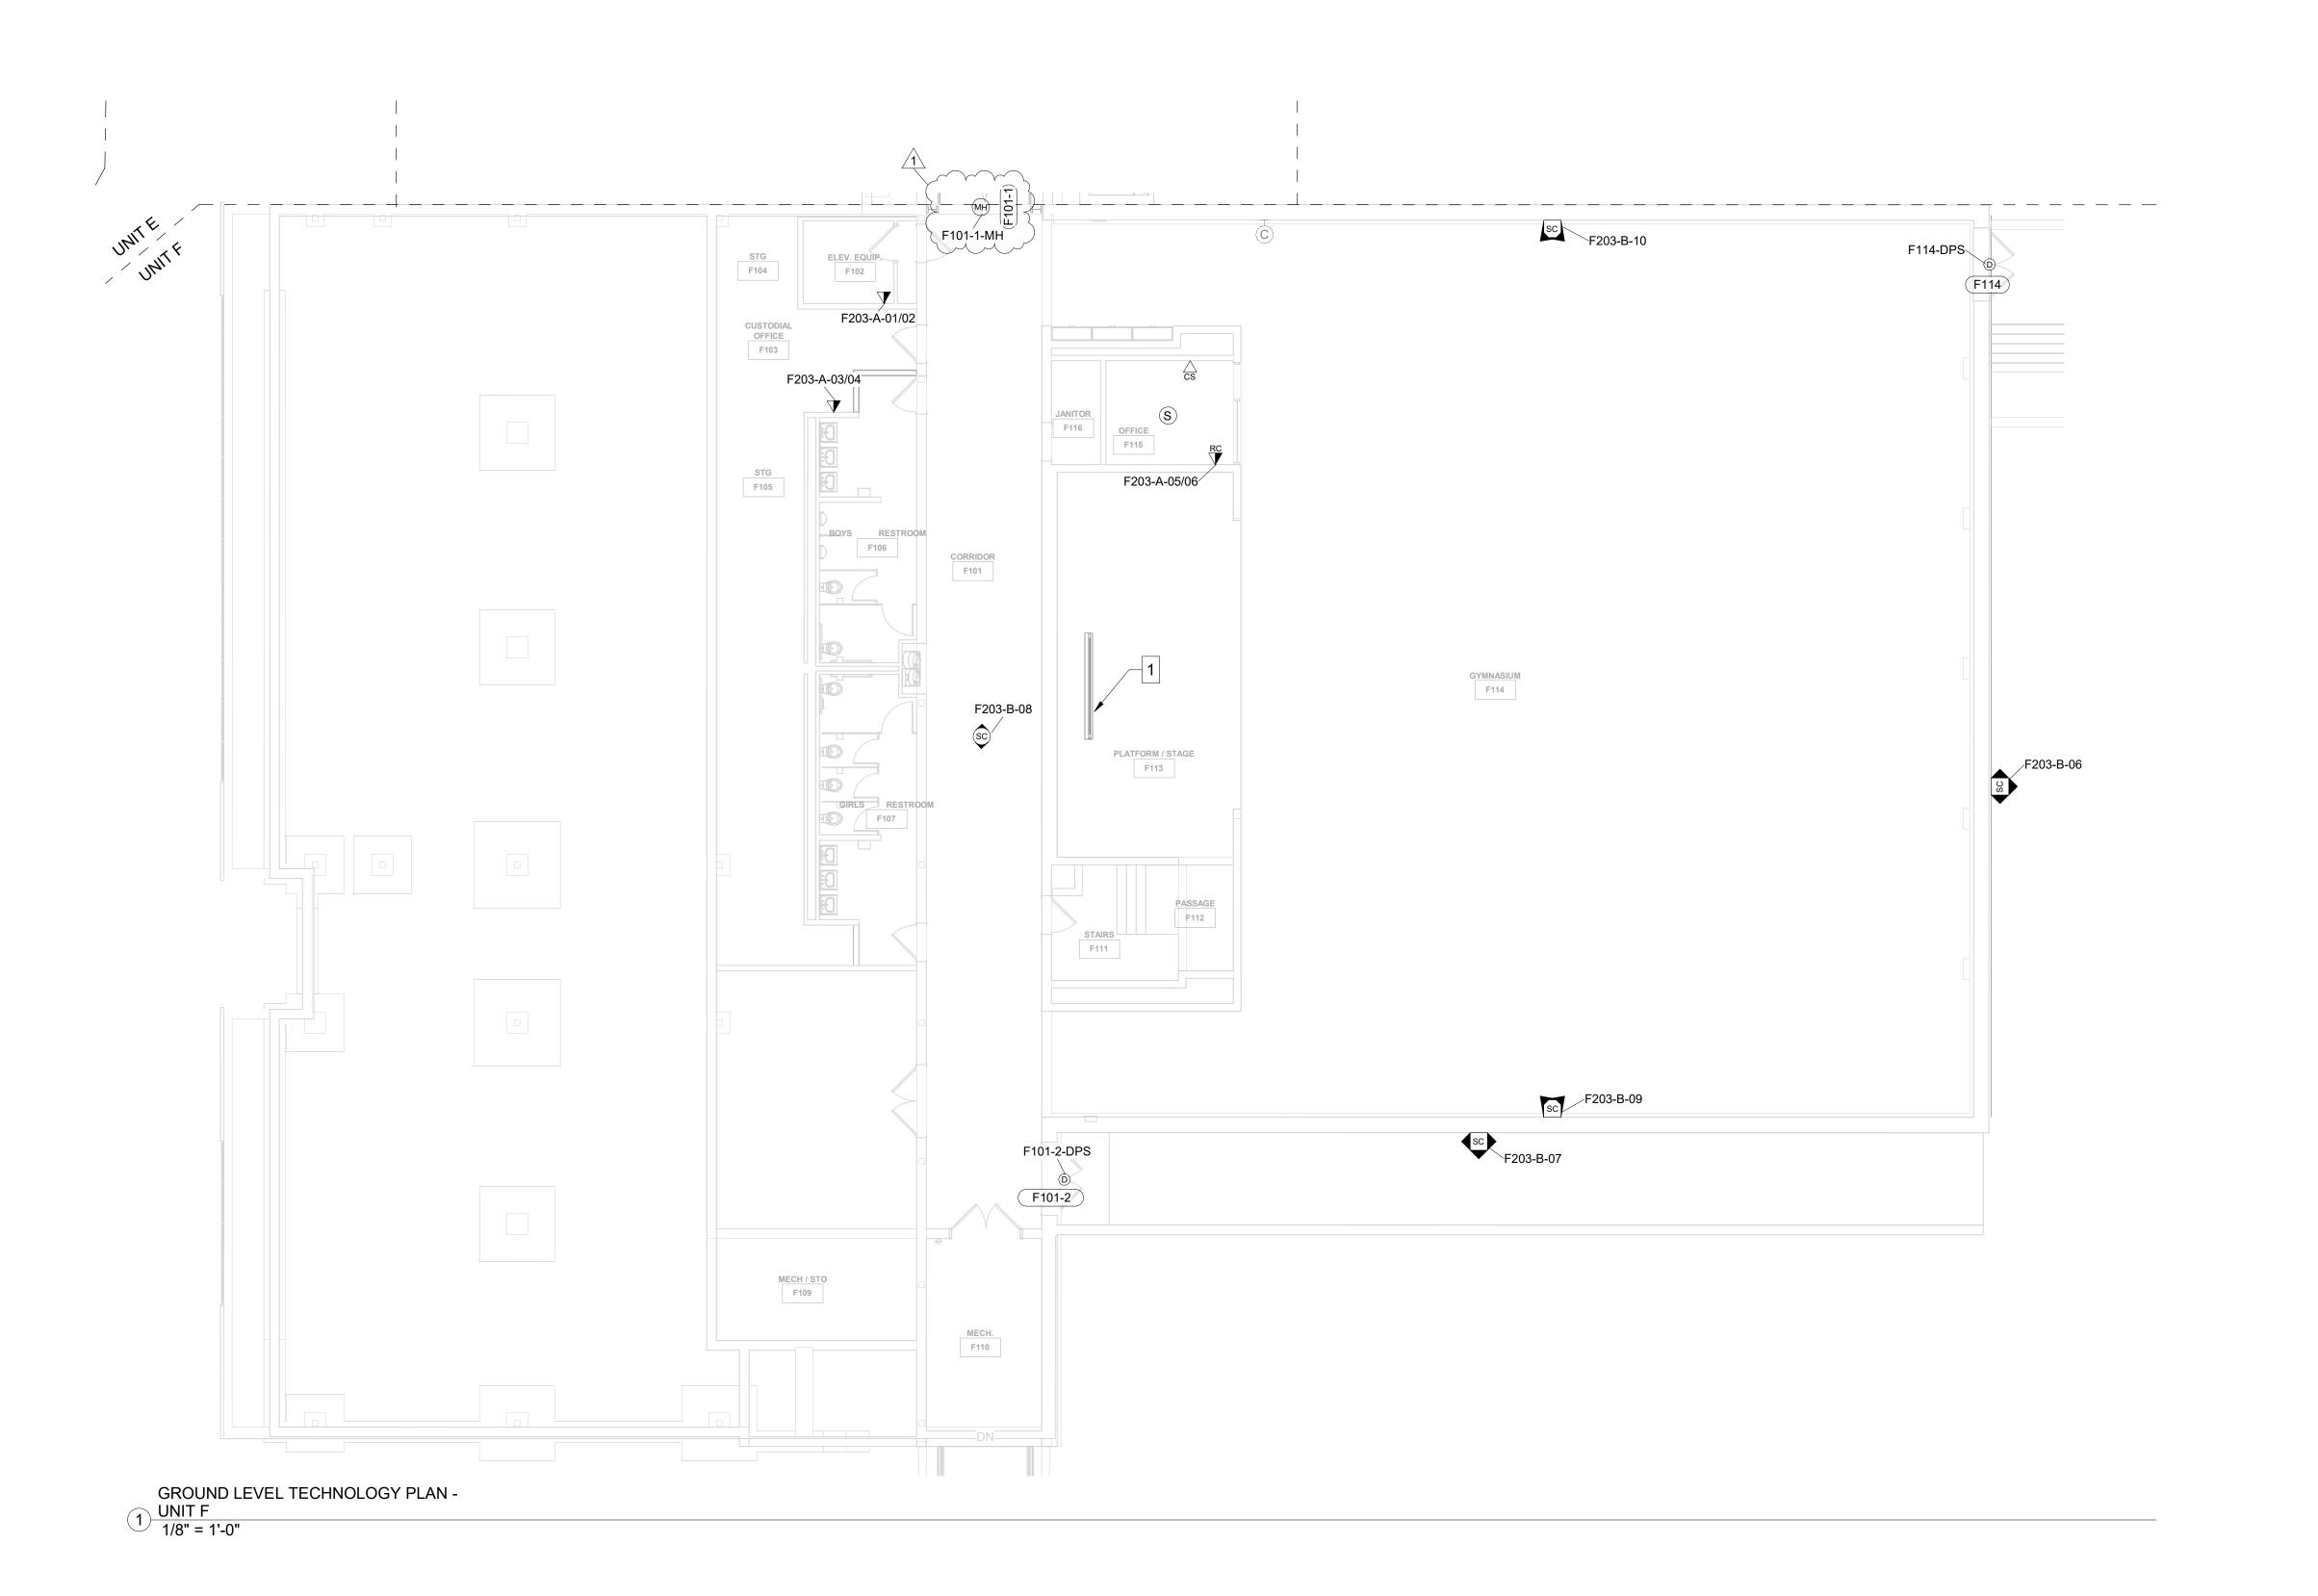T201D





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TECHNOLOGY LEGEND

- ABOVE CEILING SECURITY DATA LOCATION
- DATA LOCATION FLUSH MOUNTED
- DATA LOCATION SURFACE MOUNTED
- DATA RE-CABLE LOCATION FLUSH MOUNTED
- CRC DATA RE-CABLE LOCATION SURFACE MOUNTED
- FB FLOOR BOX LOCATION
- MONITOR LOCATION
- ₩P WALL PHONE LOCATION
- WIRELESS ACCESS POINT CEILING MOUNTED
- WIRELESS ACCESS POINT WALL MOUNTED
- AV INPUT LOCATION TYPE 1 FLUSH MOUNTED
- AV INPUT LOCATION TYPE 2 FLUSH MOUNTED
- AV AVINDUT LOCATION TYPE 1 SUPEACE MOUNTED
- AV INPUT LOCATION TYPE 1 SURFACE MOUNTED
- AV FLOOR BOX LOCATION
- CALL SWITCH LOCATION
- © CLOCK LOCATION
- CAS CLASSROOM AUDIO SYSTEM LOCATION (BY OTHERS)
- PAGING SPEAKER CEILING MOUNTED (BY
- PAGING SPEAKER WALL FLUSH MOUNTED
- PAGING SPEAKER WALL SURFACE MOUNTED
- S PROGRAM SPEAKERS (BY OTHERS)

 VIDEO BOARD LOCATION FLUSH MOUNTED
- VIDEO BOARD LOCATION SURFACE MOUNTED
- VIDEO BOARD LOCATION SURFACE MOUNT
- CR CARD READER LOCATION
- CR CARD READER MULLION MOUNTED
- DOOR POSITION SENSOR LOCATIONDURESS AND DOOR RELEASE BUTTON ASSEMBLY
- MH MAGNETIC HOLD LOCATION
- SC SECURITY CAMERA CEILING MOUNTED
- SECURITY CAMERA WALL MOUNTE
- SECURITY CAMERA WALL MOUNTED
- VI VIDEO INTERCOM DOOR STATION
- (AS) VIDEO INTERCOM ANSWERING STATION

SHEET NOTES

1 EXISTING CEILING MOUNTED PROJECTOR SCREEN TO REMAIN.

ISSUE DATE DRAWN BY CHECKED BY
01/15/25 MKD JKK

GROUND LEVEL
TECHNOLOGY
PLAN - UNIT F



DRAWING NUMBER
T201F

PROJECT NUMBER 2024023



BARTHOLOMEW CONSOLIDATEI
SCHOOL CORPORATION
RENOVATIONS TO
FRANCES SMITH ELEMENTA


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Addendum 04 02/12/2025



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- MONITOR LOCATION

OF PROJECT.

- WALL PHONE LOCATION
- WIRELESS ACCESS POINT CEILING MOUNTED
- WIRELESS ACCESS POINT WALL MOUNTED AV INPUT LOCATION TYPE 1 - FLUSH MOUNTED
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- VIDEO BOARD LOCATION FLUSH MOUNTED
- VIDEO BOARD LOCATION SURFACE MOUNTED CR CARD READER LOCATION
- CR CARD READER MULLION MOUNTED
- D DOOR POSITION SENSOR LOCATION DB DURESS AND DOOR RELEASE BUTTON ASSEMBLY
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KEY PLAN NORTH

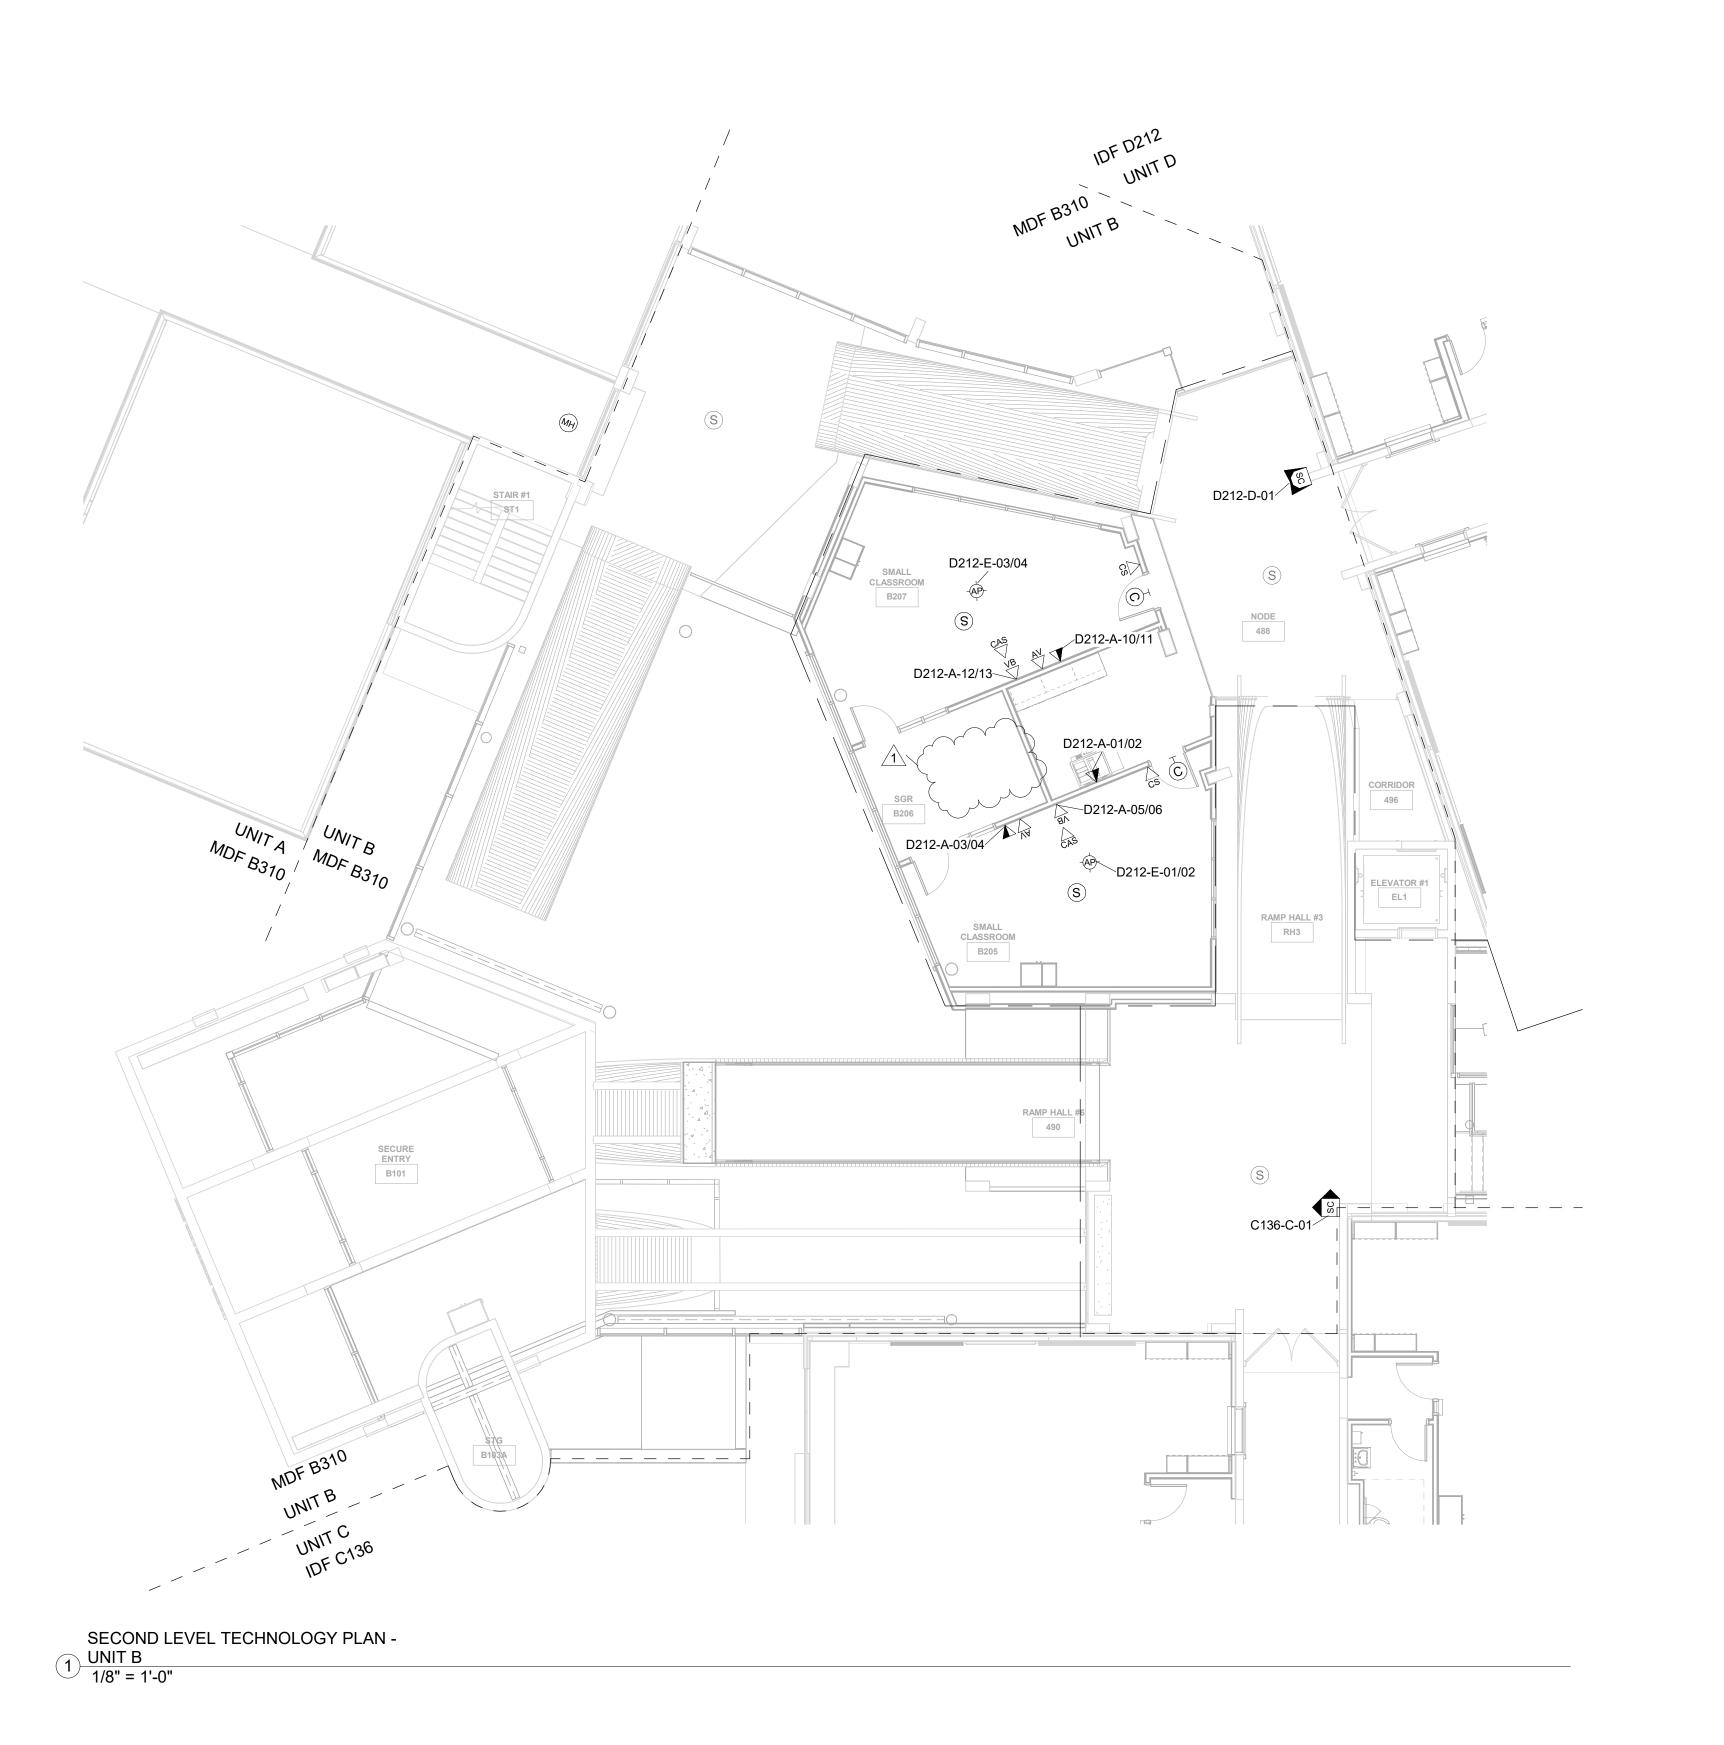- (sc) SECURITY CAMERA CEILING MOUNTED
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REVISIONS:

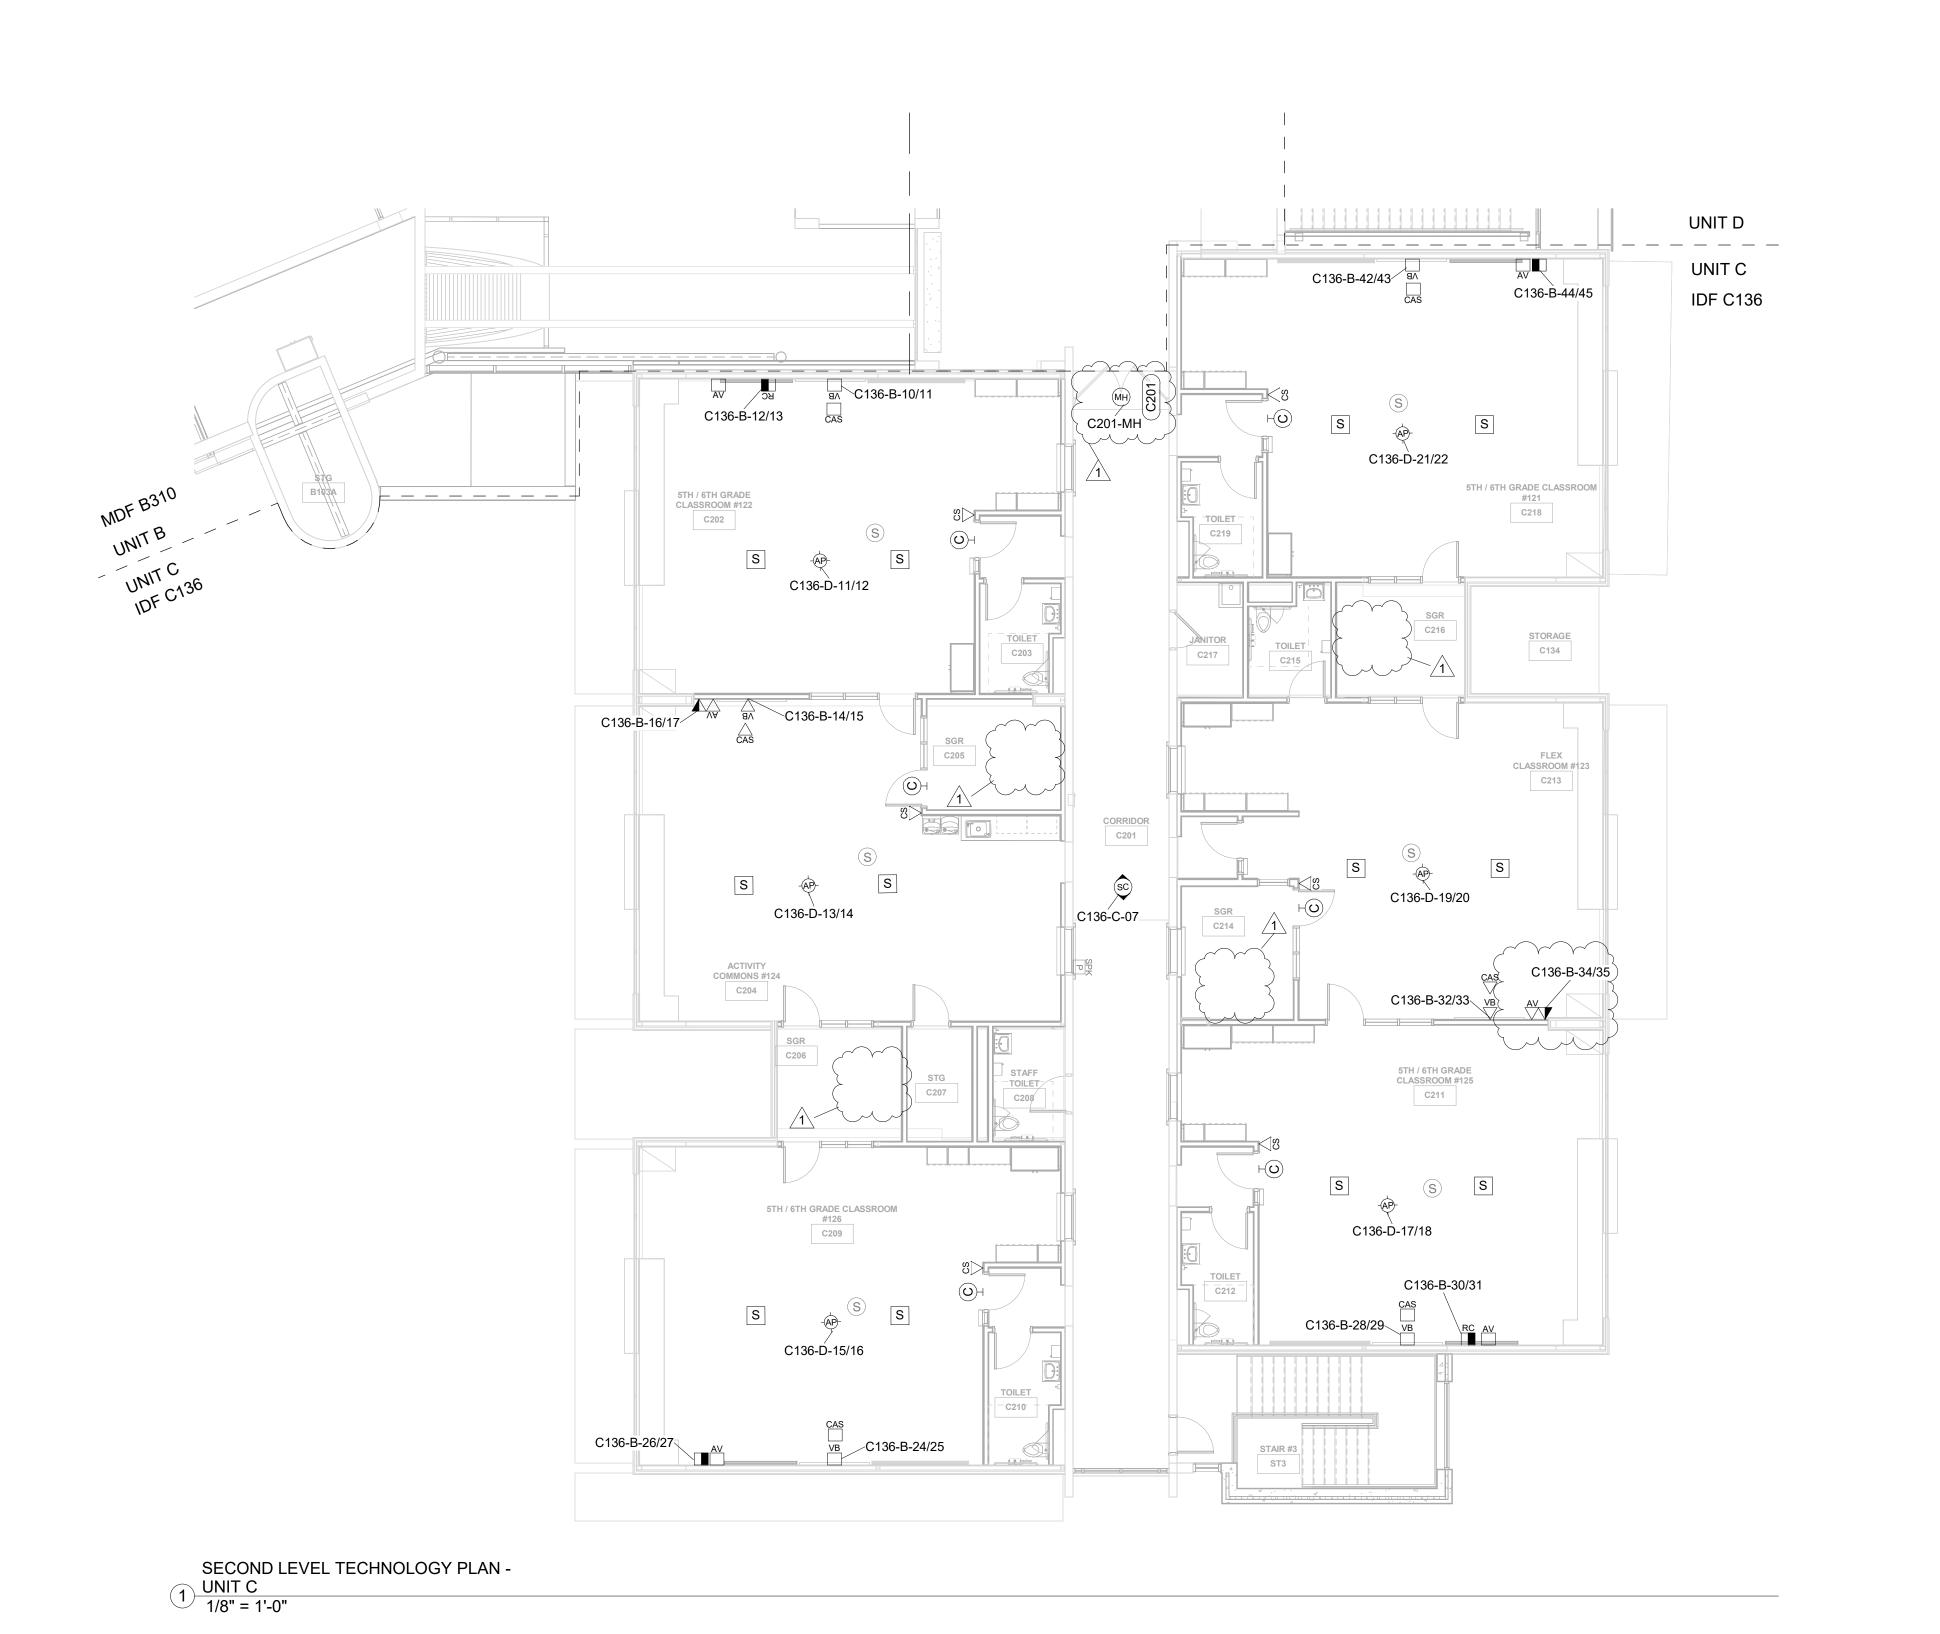
Addendum 04 02/12/2025

ISSUE DATE DRAWN BY CHECKED BY MKD 01/15/25

DRAWING TITLE: SECOND LEVEL TECHNOLOGY PLAN - UNIT B



DRAWING NUMBER T202B



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- DATA LOCATION FLUSH MOUNTED

OF PROJECT.

- DATA LOCATION SURFACE MOUNTED
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 RC

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KEY PLAN NORTH

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- SECURITY CAMERA WALL MOUNTED
- SECURITY CAMERA WALL MOUNTED

 VI VIDEO INTERCOM DOOR STATION
- VIDEO INTERCOM DOOR STATION

 VIDEO INTERCOM ANSWERING STATIC
- (AS) VIDEO INTERCOM ANSWERING STATION



stone Crossing, Indianapolis, IN 46240

INDIANAPOLIS, IN
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TECHNOLOGY
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SCHOOL CORPORATION
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4505 WAYCROSS DRIVE, COLUMBUS, IN 4720

SCOPE DRAWINGS:

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REVISIONS:
Addendum 04 02/12/2025

ISSUE DATE | DRAWN BY | CHECKED BY

MKD

01/15/25

DRAWING TITLE:
SECOND LEVEL
TECHNOLOGY
PLAN - UNIT C



T202C

- A MINIMUM CATEGORY 6A COMPLIANT 4-PAIR UNSHIELDED TWISTED PAIR (UTP). ALL HORIZONTAL CABLING MUST BE PLENUM RATED.
- B CONTRACTOR SHALL PROVIDE A DOCUMENTED MANUFACTURER CERTIFIED SOLUTION INCLUDING THE MINIMUM PERFORMANCE AND APPLICATIONS
- WARRANTY. PAINTING OF THE STRUCTURED CABLING WILL VOID
- THE WARRANTY. ENSURE PROPER COORDINATION WITH PAINTING CONTRACTOR SO THAT ALL STRUCTURED CABLING IS PROTECTED PRIOR TO ANY PAINTING. D PROVIDE A MINIMUM 10 FOOT MAINTENANCE LOOP ON
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- E ALL PIN/PAIR ASSIGNMENTS SHALL BE T568B. F REFER TO SPECIFICATION SECTION 27 15 13 FOR
- CABLE JACKET COLOR REQUIREMENTS G LABELING SHALL BE COMPLETED AS DEFINED IN THE CONTRACT DOCUMENTS AND SHALL BE COORDINATED WITH THE OWNER.
- H PROVIDE ALL TELECOMMUNICATION OUTLETS AS SHOWN ON THE DRAWINGS AND AS REQUIRED TO PROVIDE CONNECTIONS FOR EACH DEVICE SHOWN ON THE DRAWINGS.
- I ALL TESTING OF HORIZONTAL CABLING SHALL BE COMPLETED AS DIRECTED BY THE PROJECT SPECIFICATIONS. ALL CABLING MUST BE TESTED AND CERTIFIED TO THE APPLICABLE STANDARDS.
- J ALL WIRELESS ACCESS POINTS SHALL BE OWNER FURNISHED AND OWNER INSTALLED. K ALL CLOCK LOCATIONS SHOWN ON T200 SERIES SHEETS SHALL BE INSTALLED UTILIZING EXISITING
- CLOCKS REMOVED AND STORED DURING DEMOLITION. RETURN ALL REMAINING CLOCKS TO OWNER AT END OF PROJECT.

TECHNOLOGY LEGEND

- ABOVE CEILING SECURITY DATA LOCATION
- ▼ DATA LOCATION FLUSH MOUNTED
- DATA LOCATION SURFACE MOUNTED
- DATA RE-CABLE LOCATION FLUSH MOUNTED
- DATA RE-CABLE LOCATION SURFACE MOUNTED
- FILOOR BOX LOCATION
- MONITOR LOCATION WALL PHONE LOCATION
- WIRELESS ACCESS POINT CEILING MOUNTED
- WIRELESS ACCESS POINT WALL MOUNTED
- AV INPUT LOCATION TYPE 1 FLUSH MOUNTED
- AV INPUT LOCATION TYPE 2 FLUSH MOUNTED
- AV INPUT LOCATION TYPE 1 SURFACE MOUNTED

SCOPE DRAWINGS:

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REVISIONS: Addendum 04 02/12/2025

ISSUE DATE | DRAWN BY | CHECKED BY

MKD

01/15/25

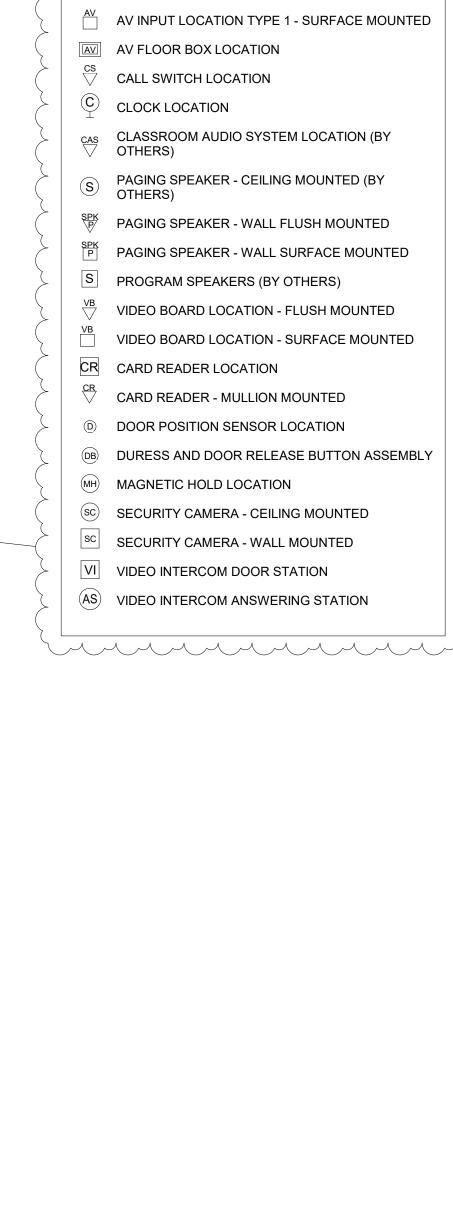
DRAWING TITLE: SECOND LEVEL TECHNOLOGY PLAN - UNIT D

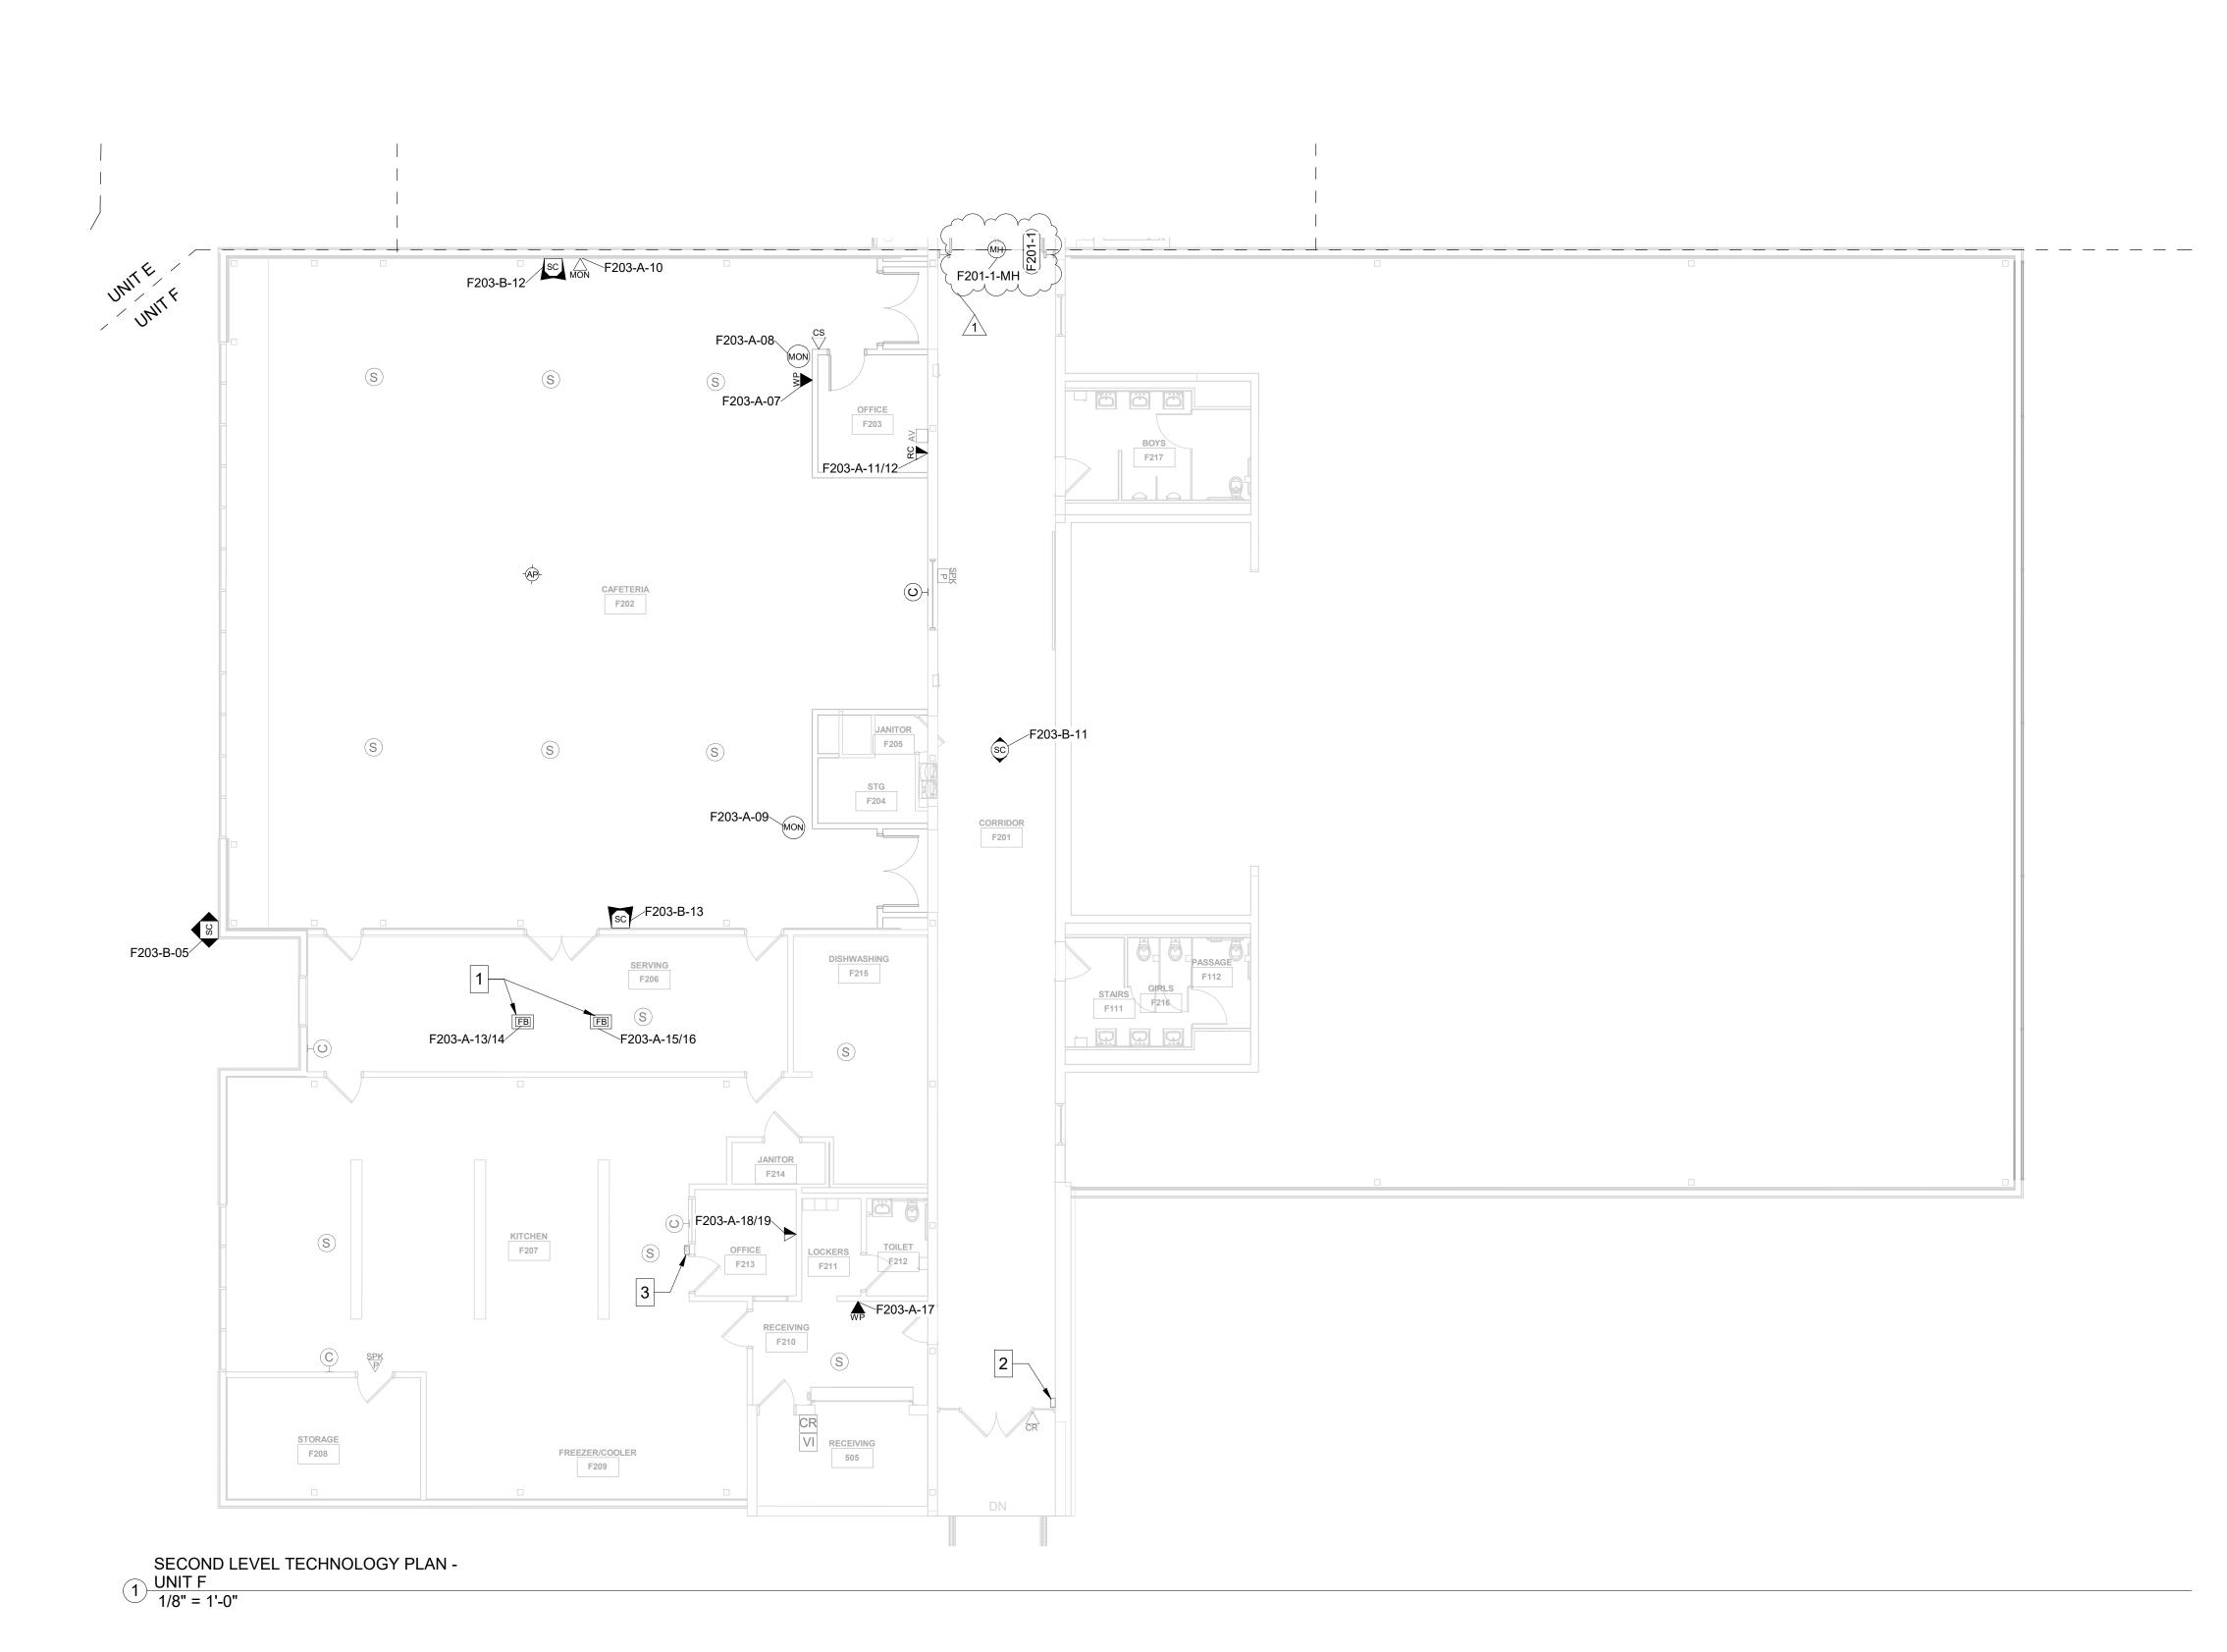
CERTIFIED BY: Jared Klingler
BICSI ID # 407182
EXPIRES 12-31-27

PRODD

RCDD

DRAWING NUMBER T202D





- A MINIMUM CATEGORY 6A COMPLIANT 4-PAIR UNSHIELDED TWISTED PAIR (UTP). ALL HORIZONTAL CABLING MUST BE PLENUM RATED.
- B CONTRACTOR SHALL PROVIDE A DOCUMENTED MANUFACTURER CERTIFIED SOLUTION INCLUDING THE MINIMUM PERFORMANCE AND APPLICATIONS
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TECHNOLOGY LEGEND

- ABOVE CEILING SECURITY DATA LOCATION
- ▼ DATA LOCATION FLUSH MOUNTED
- DATA LOCATION SURFACE MOUNTED

OF PROJECT.

- DATA RE-CABLE LOCATION FLUSH MOUNTED
- DATA RE-CABLE LOCATION SURFACE MOUNTED
- FILOOR BOX LOCATION MONITOR LOCATION
- WALL PHONE LOCATION
- WIRELESS ACCESS POINT CEILING MOUNTED
- WIRELESS ACCESS POINT WALL MOUNTED
- AV INPUT LOCATION TYPE 1 FLUSH MOUNTED
- AV INPUT LOCATION TYPE 2 FLUSH MOUNTED
- AV INPUT LOCATION TYPE 1 SURFACE MOUNTED
- AV FLOOR BOX LOCATION
- CALL SWITCH LOCATION C CLOCK LOCATION
- CLASSROOM AUDIO SYSTEM LOCATION (BY
- PAGING SPEAKER CEILING MOUNTED (BY OTHERS)
- PAGING SPEAKER WALL FLUSH MOUNTED
- PAGING SPEAKER WALL SURFACE MOUNTED
- S PROGRAM SPEAKERS (BY OTHERS)
- VIDEO BOARD LOCATION FLUSH MOUNTED
- VIDEO BOARD LOCATION SURFACE MOUNTED
- CR CARD READER LOCATION
- CR CARD READER MULLION MOUNTED
- DOOR POSITION SENSOR LOCATION
- DB DURESS AND DOOR RELEASE BUTTON ASSEMBLY MH) MAGNETIC HOLD LOCATION
- (sc) SECURITY CAMERA CEILING MOUNTED
- SECURITY CAMERA WALL MOUNTED
- VI VIDEO INTERCOM DOOR STATION
- (AS) VIDEO INTERCOM ANSWERING STATION

SHEET NOTES

- 1 NEW DATA CABLES INSTALLED IN EXISTING FLOOR
- 2 NEW LENELS2 MICRONODE PLUS TO SERVE CARD READERS AT DOORS F201-2 AND F210-2, AND MONITORING AT DOORS F101-2 AND F114. 3 EXISTING VIDEO INTERCOM ANSWERING STATION.

RETERMINATE CABLE TO NEW LENELS2 NODE AS REQUIRED FOR RELEASE OF DOOR B101-1.

ISSUE DATE DRAWN BY CHECKED BY 01/15/25 MKD

SCOPE DRAWINGS:

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REVISIONS:

Addendum 04 02/12/2025

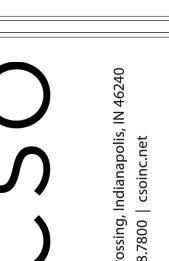
DRAWING TITLE: SECOND LEVEL TECHNOLOGY PLAN - UNIT F

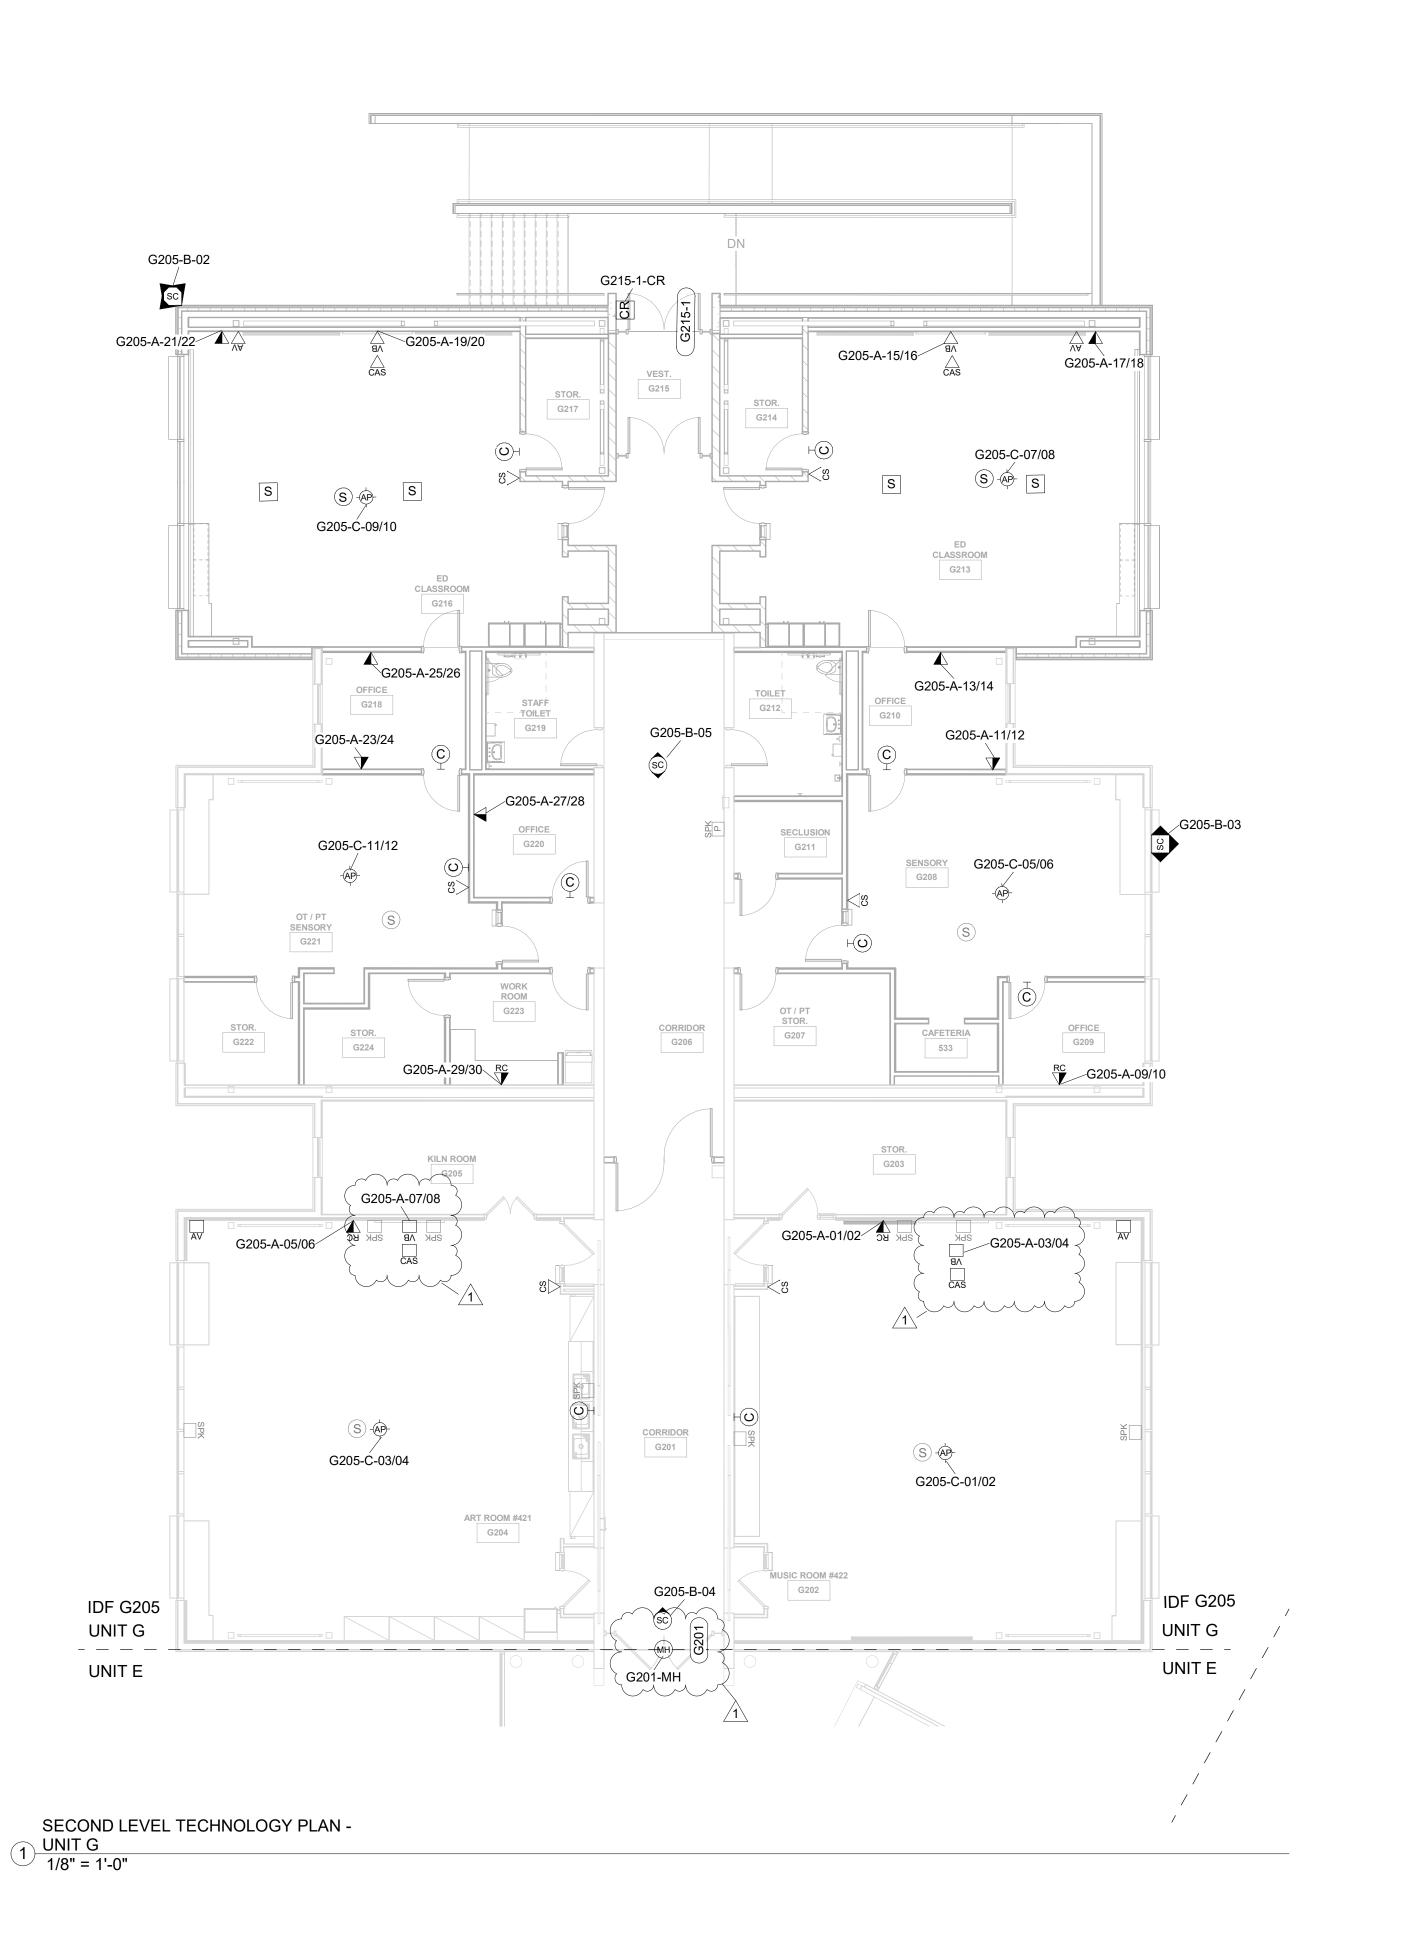
CERTIFIED BY: Jared Klingler
BICSI ID # 407182
EXPIRES 12-31-27

Parod Margles
RCDD

DRAWING NUMBER T202F







- A MINIMUM CATEGORY 6A COMPLIANT 4-PAIR UNSHIELDED TWISTED PAIR (UTP). ALL HORIZONTAL CABLING MUST BE PLENUM RATED.
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APPROPRIATE SUPPORTS AND SHALL NOT TOUCH THE

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TECHNOLOGY LEGEND

OF PROJECT.

- ABOVE CEILING SECURITY DATA LOCATION
- ▼ DATA LOCATION FLUSH MOUNTED
- DATA LOCATION SURFACE MOUNTED
- DATA RE-CABLE LOCATION FLUSH MOUNTED
- DATA RE-CABLE LOCATION SURFACE MOUNTED
- FILOOR BOX LOCATION
- MONITOR LOCATION
- WP WALL PHONE LOCATION
- WIRELESS ACCESS POINT CEILING MOUNTED
- WIRELESS ACCESS POINT WALL MOUNTED
- AV INPUT LOCATION TYPE 1 FLUSH MOUNTED
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- AV INPUT LOCATION TYPE 1 SURFACE MOUNTED
- AV FLOOR BOX LOCATION
- CALL SWITCH LOCATION
- CLOCK LOCATION CAS CLASSROOM AUDIO SYSTEM LOCATION (BY
- PAGING SPEAKER CEILING MOUNTED (BY OTHERS)
- PAGING SPEAKER WALL FLUSH MOUNTED
- PAGING SPEAKER WALL SURFACE MOUNTED
- S PROGRAM SPEAKERS (BY OTHERS) VIDEO BOARD LOCATION - FLUSH MOUNTED
- VIDEO BOARD LOCATION SURFACE MOUNTED
- CR CARD READER LOCATION
- CR CARD READER MULLION MOUNTED
- D DOOR POSITION SENSOR LOCATION DB DURESS AND DOOR RELEASE BUTTON ASSEMBLY
- MH) MAGNETIC HOLD LOCATION
- (sc) SECURITY CAMERA CEILING MOUNTED
- SECURITY CAMERA WALL MOUNTED
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ISSUE DATE | DRAWN BY | CHECKED BY

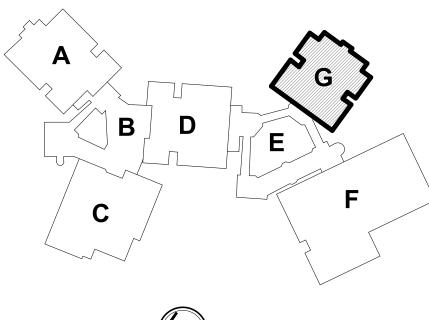
MKD

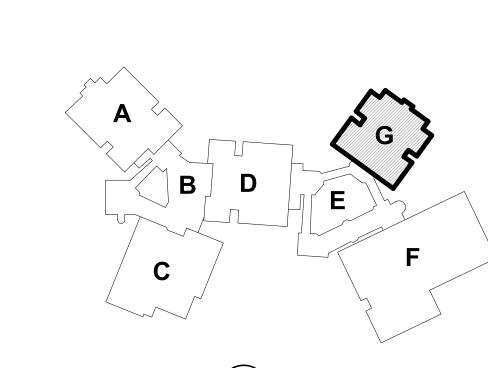
01/15/25

DRAWING TITLE: SECOND LEVEL TECHNOLOGY PLAN - UNIT G



DRAWING NUMBER T202G







8831 Keystone Crossing, Indianapolis, IN 46240

TECHNOLOGY 1650 E. 49TH ST.
INDIANAPOLIS, IN
46205
317.536.8000
+ACOUSTICS DESIGN27.COM

BARTHOLOMEW CONSOLIDATED
SCHOOL CORPORATION
RENOVATIONS TO
4505 WAYCROSS DRIVE, COLUMBUS, IN 47201

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REVISIONS: 1 Addendum 04 02/12/2025

ISSUE DATE DRAWN BY CHECKED BY 01/15/25 MKD JKK

SECURITY
DIAGRAMS

CERTIFIED BY:

CATIONS DISTABLING

DISTABLING


BICSI ID # 407182

EXPIRES 12-31-27

RCDD


RCDD

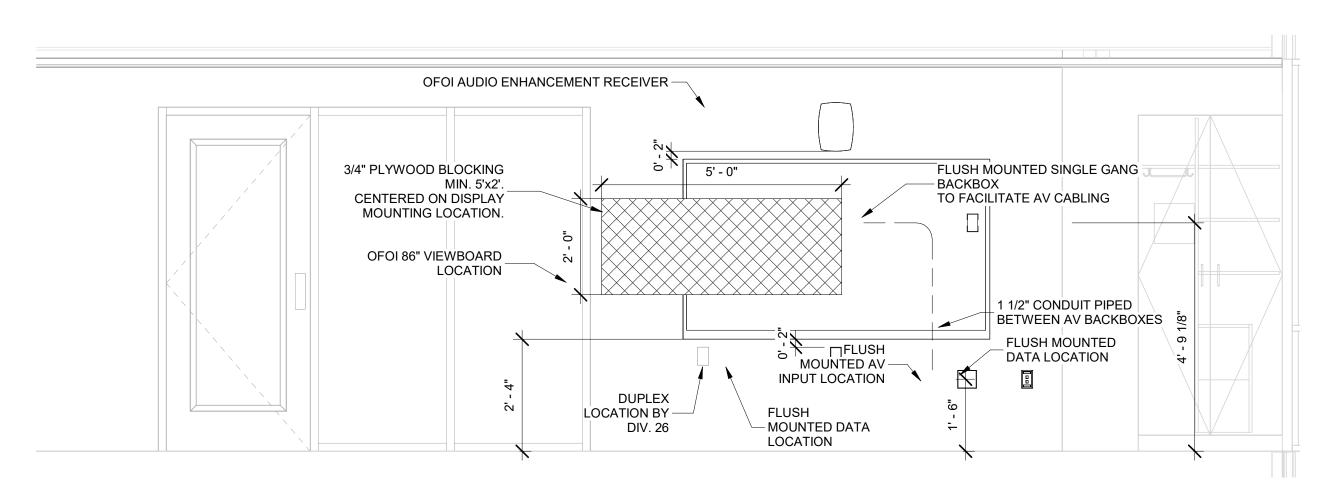
T302



NOTE: DIMENSIONS AND DEVICE LOCATIONS SHOWN IN THIS DETAIL ARE FOR INFORMATION REGARDING MOUNTING HEIGHTS AND CABLE ROUTING ONLY. REFER TO FLOOR PLANS FOR DEVICE LOCATIONS WITHIN SPECIFIC ROOMS.

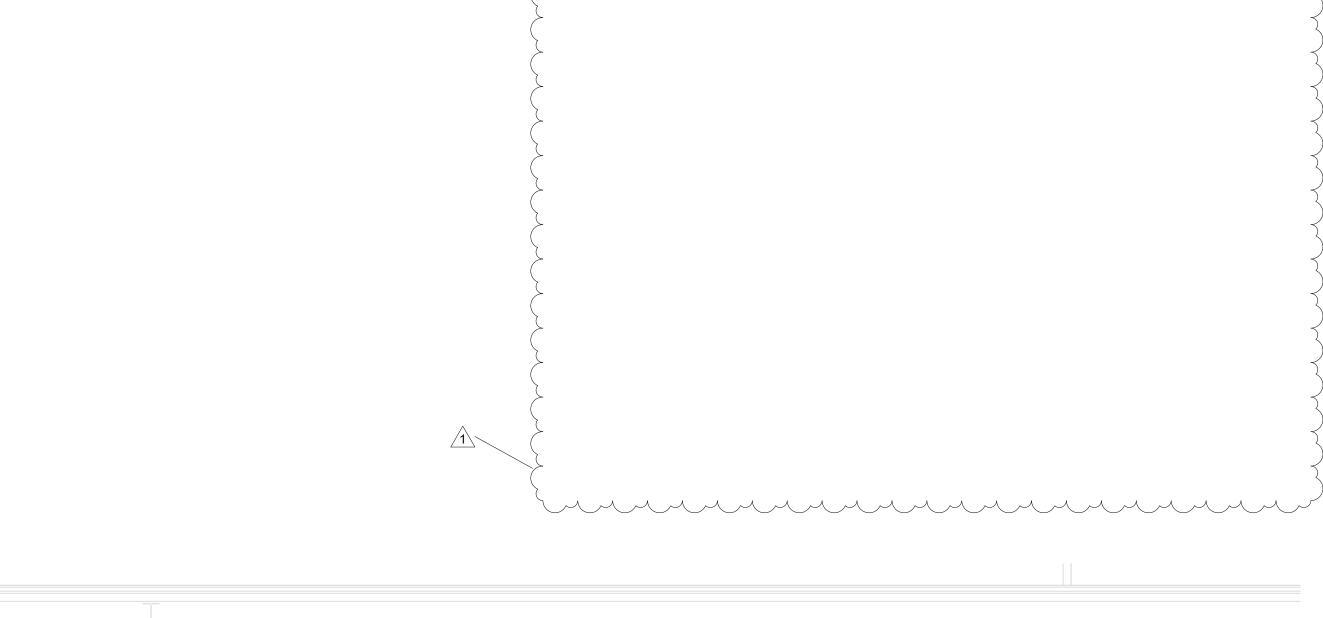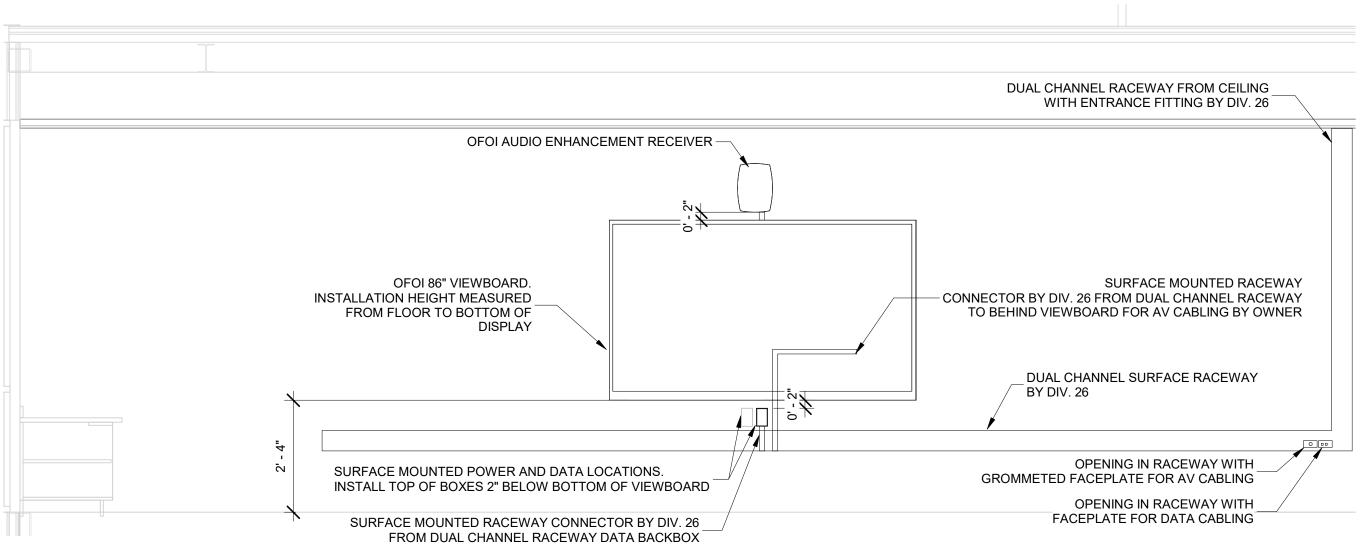
TYPICAL TEACHING WALL ELEVATION -2 FLUSH MOUNTED 1/2" = 1'-0"





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TYPICAL TEACHING WALL ELEVATION -3 SURFACE MOUNTED 1/2" = 1'-0"

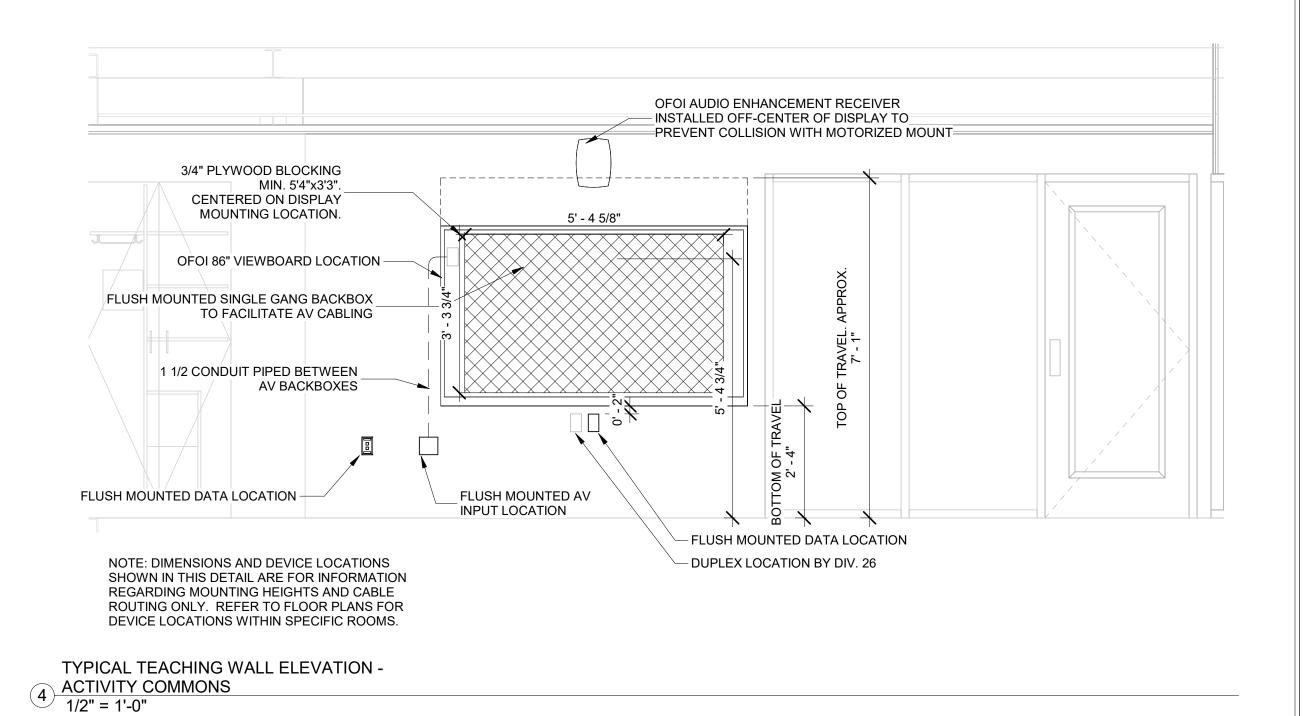

BARTHOLOMEW CONSOLIDATED
SCHOOL CORPORATION

-. FRANCES SMITH ELEMENTARY
4505 WAYCROSS DRIVE, COLUMBUS, IN 47201

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MKD

DRAWING TITLE:

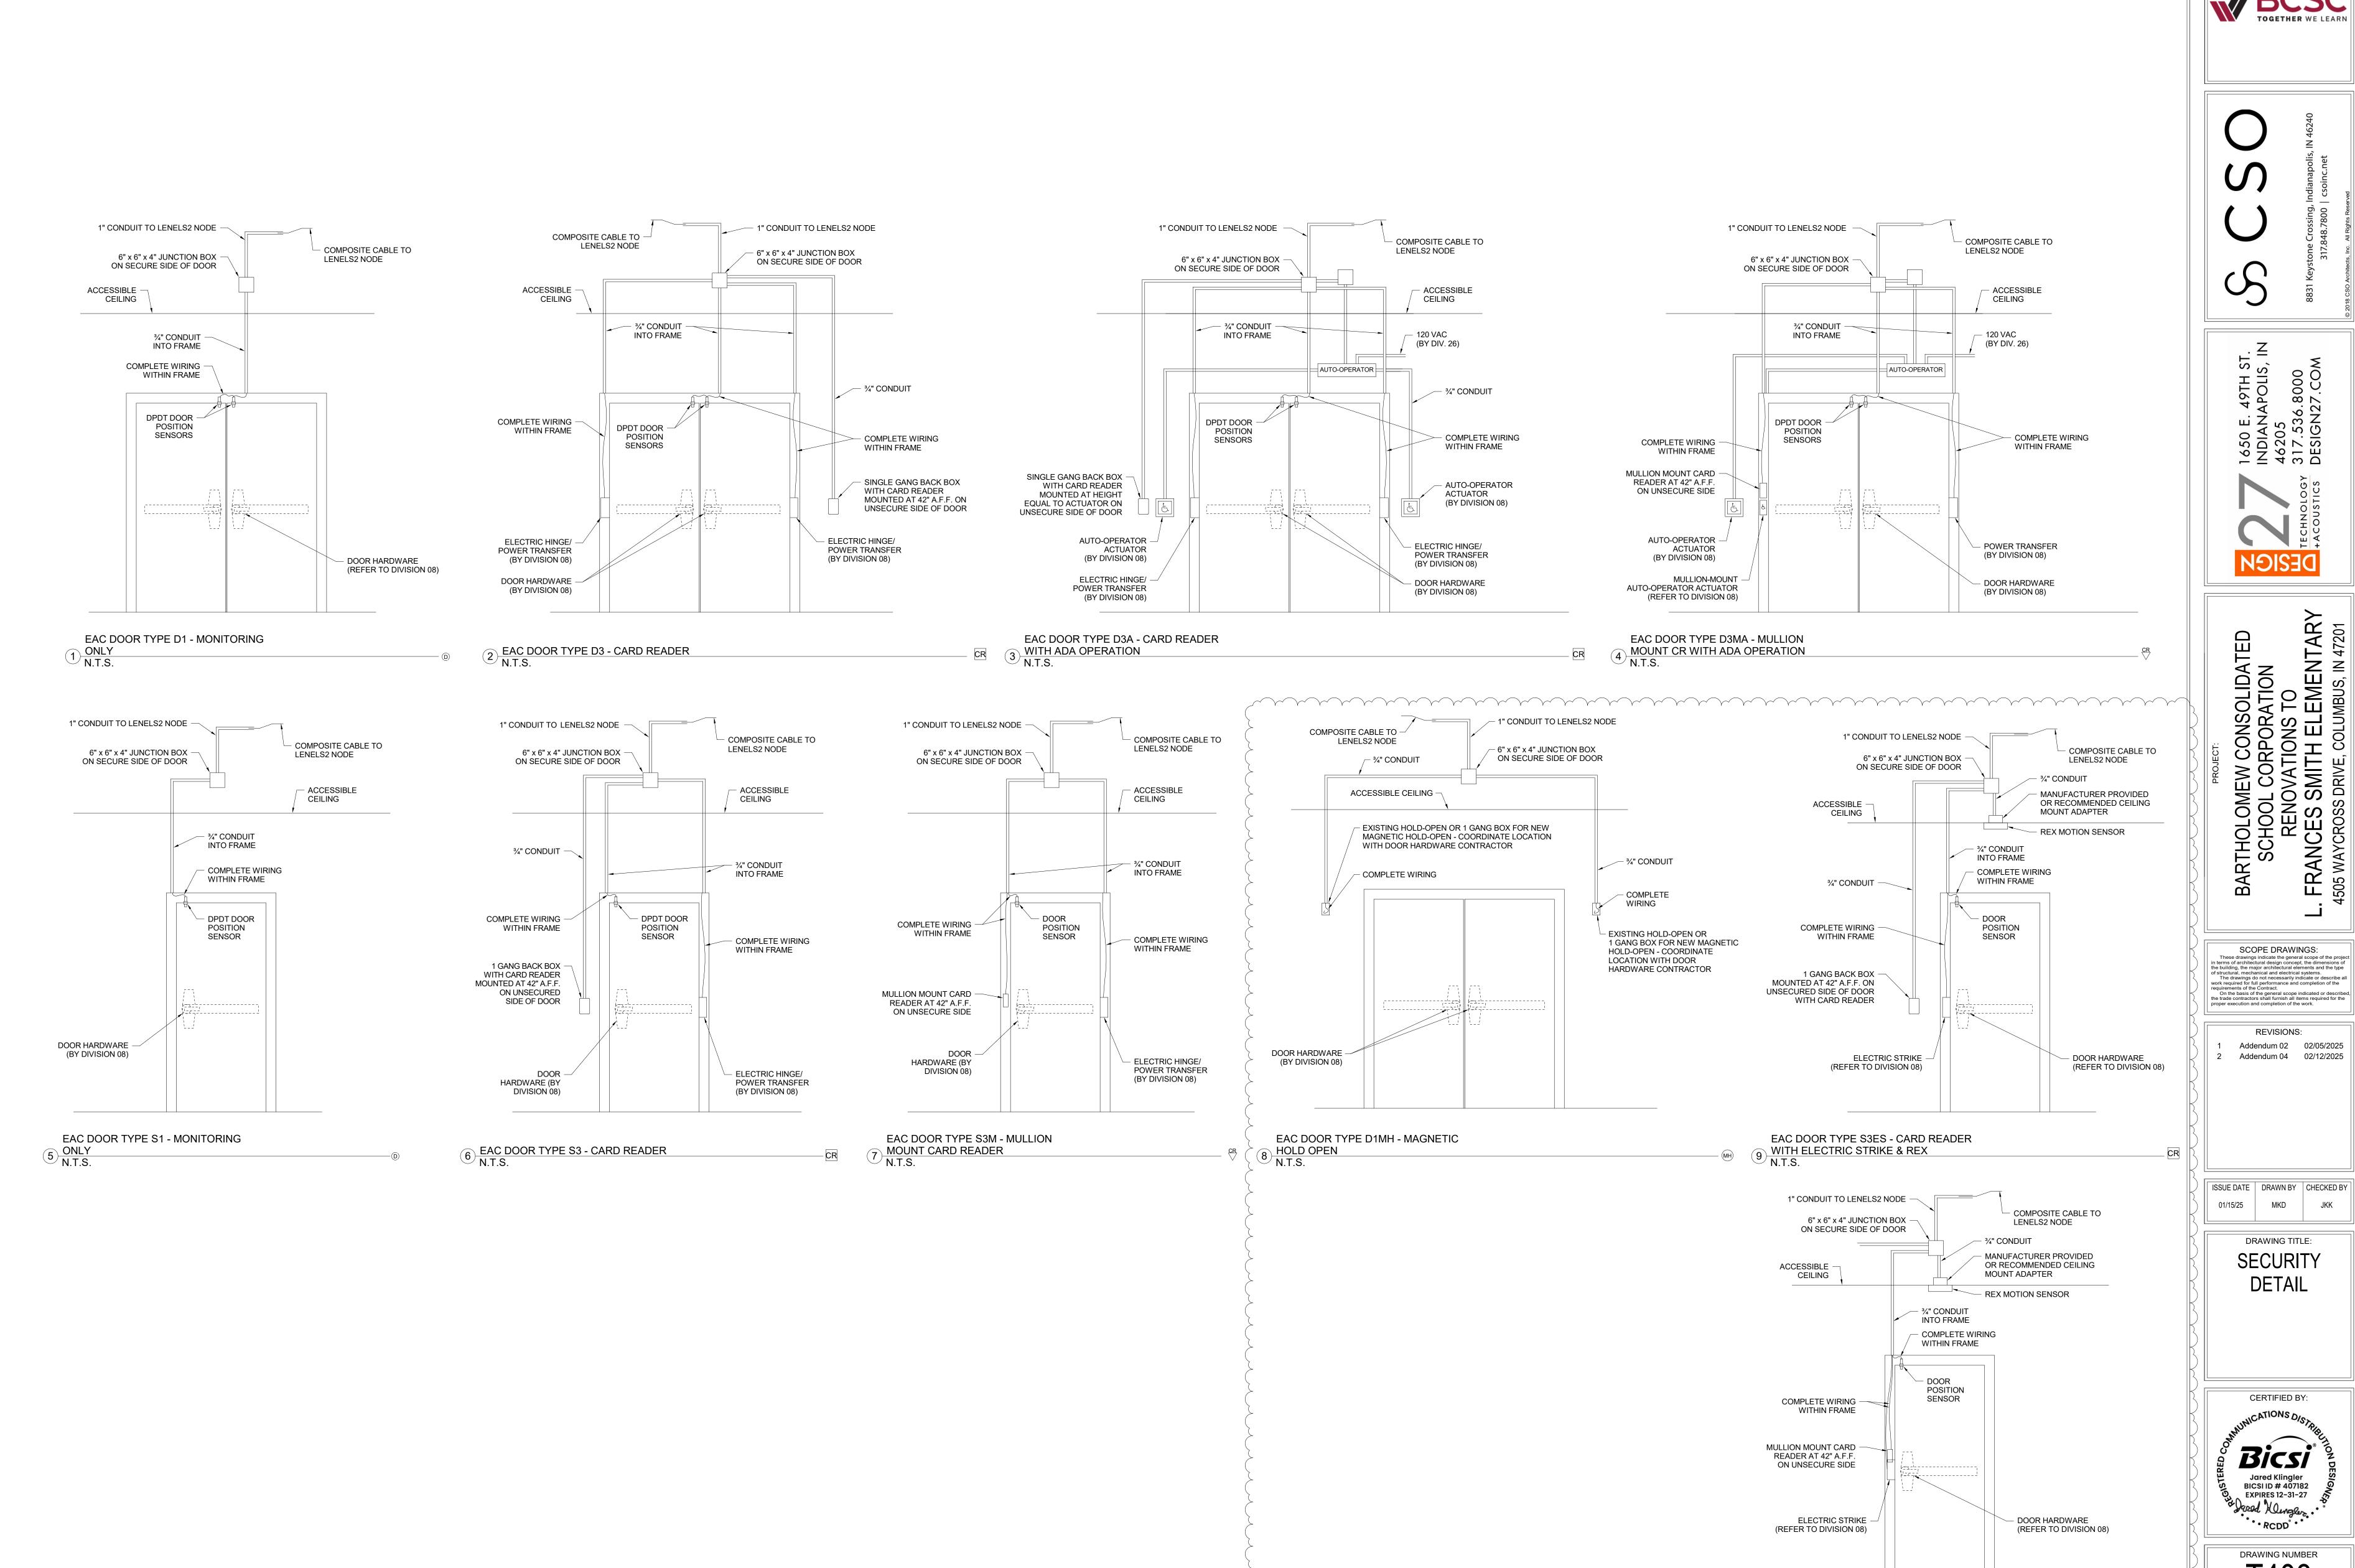
AV ELEVATIONS

01/15/25

Addendum 04 02/12/2025

CERTIFIED BY: CATIONS DIS Jared Klingler BICSI ID # 407182 EXPIRES 12-31-27 PCDD RCDD

DRAWING NUMBER



Jared Klingler BICSI ID # 407182 EXPIRES 12-31-27 Dared Mengles. RCDD DRAWING NUMBER

T403 PROJECT NUMBER

2024023

EAC DOOR TYPE S3MES - MULLION

10 STRIKE & REX N.T.S.

The transfer of the transfer o

MOUNT CARD READER WITH ELECTRIC

ROOM NUMBER	LABEL	TELECOM ROOM	DATA PORTS	COMMENTS
A202	B310-A-01/02	B310	2	VIDEO BOARD LOCATION - SURFACE MOUNTED
A202	B310-A-03/04	B310	2	DATA LOCATION - SURFACE MOUNTED
A206	B310-A-08/09	B310	2	VIDEO BOARD LOCATION - FLUSH MOUNTED
A206	B310-A-10/11	B310	2	DATA LOCATION - FLUSH MOUNTED
A209	B310-A-15/16	B310	2	VIDEO BOARD LOCATION - SURFACE MOUNTED
A209	B310-A-17/18	B310	2	DATA LOCATION - SURFACE MOUNTED
A212	B310-A-19/20	B310	2	VIDEO BOARD LOCATION - SURFACE MOUNTED
A212	B310-A-21/22	B310	2	DATA LOCATION - SURFACE MOUNTED
A215	B310-A-23/24	B310	2	VIDEO BOARD LOCATION - FLUSH MOUNTED
A215	B310-A-25/26	B310	2	DATA LOCATION - FLUSH MOUNTED
A220	B310-A-33/34	B310	2	VIDEO BOARD LOCATION - SURFACE MOUNTED
A220	B310-A-35/36	B310	2	DATA LOCATION - SURFACE MOUNTED
B101	B310-A-37	B310	1	VIDEO INTERCOM DOOR STATION
B101	B310-B-38/39	B310	2	DATA LOCATION - FLUSH MOUNTED
B103	B310-A-38/39	B310	2	DATA LOCATION - FLUSH MOUNTED
B103	B310-A-40/41	B310	2	DATA LOCATION - FLUSH MOUNTED
B103	B310-A-42/43	B310	2	DATA LOCATION - FLUSH MOUNTED
B103	B310-A-42/45	B310	2	FLOOR BOX LOCATION
B107	B310-A-46/47	B310	2	DATA LOCATION - FLUSH MOUNTED
B108	B310-A-48; B310-B-01	B310	2	DATA LOCATION - FLUSH MOUNTED
B201	B310-B-02/03	B310	2	DATA LOCATION - SURFACE MOUNTED
B302	B310-B-04/05	B310	2	DATA LOCATION - SURFACE MOUNTED
B302	B310-B-06/07	B310	2	DATA LOCATION - SURFACE MOUNTED
B302	B310-B-08/09	B310	2	VIDEO BOARD LOCATION - SURFACE MOUNTED
B306	B310-B-10/11	B310	2	DATA LOCATION - SURFACE MOUNTED
B308	B310-B-12/13	B310	2	DATA LOCATION - SURFACE MOUNTED
B308	B310-B-14/15	B310	2	DATA LOCATION - FLUSH MOUNTED
B310	B310-B-16/17	B310	2	DATA SURFACE RACEWAY LOCATION
B310	B310-B-18/19	B310	2	DATA SURFACE RACEWAY LOCATION
B310	B310-B-20/21	B310	2	DATA SURFACE RACEWAY LOCATION
B313	B310-B-22/23	B310	2	DATA LOCATION - FLUSH MOUNTED
B313	B310-B-24/25	B310	2	DATA LOCATION - FLUSH MOUNTED
B314	B310-B-26/27	B310	2	DATA LOCATION - FLUSH MOUNTED
B314	B310-B-28/29	B310	2	DATA LOCATION - FLUSH MOUNTED
B315	B310-B-30/31	B310	2	DATA LOCATION - FLUSH MOUNTED
B315	B310-B-32/33	B310	2	DATA LOCATION - FLUSH MOUNTED
B316	B310-B-34/35	B310	2	DATA LOCATION - SURFACE MOUNTED
B316	B310-B-36/37	B310	2	DATA LOCATION - SUNT ACE MOUNTED
A201	B310-C-01	B310	1	SECURITY CAMERA - CEILING MOUNTED
A201	B310-C-02/03	B310	2	ABOVE CEILING SECURITY DATA LOCATION
B101	B310-C-04	B310	1	SECURITY CAMERA - WALL MOUNTED
B103	B310-C-05	B310	1	SECURITY CAMERA - WALL MOUNTED
B103	B310-C-06	B310	1	SECURITY CAMERA - CEILING MOUNTED
B107	B310-C-07	B310	1	SECURITY CAMERA - WALL MOUNTED
B201	B310-C-08	B310	1	SECURITY CAMERA - WALL MOUNTED
EXT	B310-C-09	B310	1	SECURITY CAMERA - WALL MOUNTED
EXT	B310-C-10	B310	1	SECURITY CAMERA - CEILING MOUNTED
EXT	B310-C-10	B310	1	SECURITY CAMERA - CEILING MOUNTED
EXT	B310-C-11	B310	1	SECURITY CAMERA - WALL MOUNTED
A202	B310-C-12 B310-D-01/02	B310	2	WIRELESS ACCESS POINT - CEILING MOUNTED
A202 A206	B310-D-01/02 B310-D-03/04	B310	2	WIRELESS ACCESS POINT - CEILING MOUNTED
			2	WIRELESS ACCESS POINT - CEILING MOUNTED WIRELESS ACCESS POINT - CEILING MOUNTED
A209	B310-D-05/06	B310		
A212	B310-D-07/08	B310	2	WIRELESS ACCESS POINT - CEILING MOUNTED
A215	B310-D-09/10	B310	2	WIRELESS ACCESS POINT - CEILING MOUNTED
A220	B310-D-11/12	B310	2	WIRELESS ACCESS POINT - CEILING MOUNTED
B302	B310-D-13/14	B310	2	WIRELESS ACCESS POINT - CEILING MOUNTED
B314	B310-D-15/16	B310	2	WIRELESS ACCESS POINT - CEILING MOUNTED

ROOM				
NUMBER	LABEL	TELECOM ROOM	DATA PORTS	COMMENTS
C101	C136-A-01/02	C136	2	DATA LOCATION - SURFACE MOUNTED
C106	C136-A-03/04	C136	2	DATA LOCATION - FLUSH MOUNTED
C106	C136-A-05	C136	1	MONITOR LOCATION
C107	C136-A-06/07 C136-A-08/09	C136 C136	2 2	DATA LOCATION - FLUSH MOUNTED DATA LOCATION - FLUSH MOUNTED
C107	C136-A-06/09	C136	2	DATA RE-CABLE - FLUSH MOUNTED
C109	C136-A-10/11	C136	2	DATA RE-CABLE - FLOSH MOUNTED DATA LOCATION - FLUSH MOUNTED
C111	C136-A-14/15	C136	2	DATA LOCATION - FLUSH MOUNTED
C111	C136-A-16/17	C136	2	DATA LOCATION - FLUSH MOUNTED
C112	C136-A-18/19	C136	2	DATA LOCATION - FLUSH MOUNTED
C112	C136-A-20/21	C136	2	DATA LOCATION - FLUSH MOUNTED
C113	C136-A-22/23	C136	2	DATA LOCATION - FLUSH MOUNTED
C113	C136-A-24/25	C136	2	DATA LOCATION - FLUSH MOUNTED
C118	C136-A-26/27	C136	2	DATA LOCATION - FLUSH MOUNTED
C120	C136-A-28/29	C136	2	DATA LOCATION - FLUSH MOUNTED
C120	C136-A-30/31	C136	2	DATA LOCATION - FLUSH MOUNTED
C121	C136-A-32/33	C136	2	DATA LOCATION - FLUSH MOUNTED
C121	C136-A-34/35	C136	2	DATA LOCATION - FLUSH MOUNTED
C122	C136-A-36/37	C136	2	DATA LOCATION - FLUSH MOUNTED
C122	C136-A-38	C136	1	MONITOR LOCATION
C124	C136-A-39/40	C136	2	DATA LOCATION - SURFACE MOUNTED
C124	C136-A-41/42	C136	2	DATA LOCATION - SURFACE MOUNTED
C130	C136-A-43	C136	1	MONITOR LOCATION - SURFACE MOUNTED
C130 C130	C136-A-44/45 C136-A-46/47	C136 C136	2 2	DATA LOCATION - FLUSH MOUNTED AV FLOOR BOX
C130	C136-A-46/47	C136	2	DATA LOCATION - FLUSH MOUNTED
0101	B-01	C 130	۷	DATA LOCATION - I LOOM MICOINTED
C133	C136-B-02/03	C136	2	DATA RE-CABLE - FLUSH MOUNTED
C133	C136-B-04/05	C136	2	VIDEO BOARD LOCATION - SURFACE MOUNTED
C137	C136-B-06/07	C136	2	DATA RE-CABLE - FLUSH MOUNTED
C137	C136-B-08/09	C136	2	VIDEO BOARD LOCATION - SURFACE MOUNTED
C202	C136-B-10/11	C136	2	VIDEO BOARD LOCATION - SURFACE MOUNTED
C202	C136-B-12/13	C136	2	DATA LOCATION - SURFACE MOUNTED
C204	C136-B-14/15	C136	2	VIDEO BOARD LOCATION - FLUSH MOUNTED
C204	C136-B-16/17	C136	2	DATA LOCATION - FLUSH MOUNTED
C209	C136-B-24/25	C136	2	VIDEO BOARD LOCATION - SURFACE MOUNTED
C209	C136-B-26/27	C136	2	DATA LOCATION - SURFACE MOUNTED
C211	C136-B-28/29	C136	2	VIDEO BOARD LOCATION - SURFACE MOUNTED
C211	C136-B-30/31	C136	2	DATA LOCATION - SURFACE MOUNTED
C213	C136-B-32/33	C136	2	VIDEO BOARD LOCATION - FLUSH MOUNTED
C213	C136-B-34/35	C136	2	DATA LOCATION - FLUSH MOUNTED
C218 C218	C136-B-42/43	C136 C136	2 2	VIDEO BOARD LOCATION - SURFACE MOUNTED
490	C136-B-44/45 C136-C-01	C136	1	DATA LOCATION - SURFACE MOUNTED SECURITY CAMERA - WALL MOUNTED
B106	C136-C-01	C136	1 1	SECURITY CAMERA - WALL MOUNTED
C125	C136-C-03	C136	1	SECURITY CAMERA - WALL MOUNTED
C126	C136-C-04	C136	1	SECURITY CAMERA - CEILING MOUNTED
C128	C136-C-05	C136	1	SECURITY CAMERA - WALL MOUNTED
C128	C136-C-06	C136	1	SECURITY CAMERA - WALL MOUNTED
C132	C136-C-08	C136	1	SECURITY CAMERA - CEILING MOUNTED
C201	C136-C-07	C136	1	SECURITY CAMERA - CEILING MOUNTED
EXT	C136-C-09	C136	1	SECURITY CAMERA - WALL MOUNTED
EXT	C136-C-10	C136	1	SECURITY CAMERA - WALL MOUNTED
SITE	C136-C-12	C136	1	SECURITY CAMERA - LIGHT POLE MOUNTED
SITE	C136-C-11	C136	1	SECURITY CAMERA - LIGHT POLE MOUNTED
C108	C136-D-01/02	C136	2	WIRELESS ACCESS POINT - CEILING MOUNTED
C119	C136-D-03/04	C136	2	WIRELESS ACCESS POINT - CEILING MOUNTED
C130	C136-D-05/06	C136	2	WIRELESS ACCESS POINT - CEILING MOUNTED
C133	C136-D-07/08	C136	2	WIRELESS ACCESS POINT - CEILING MOUNTED
C137	C136-D-09/10	C136	2	WIRELESS ACCESS POINT - CEILING MOUNTED
C202	C136-D-11/12	C136	2	WIRELESS ACCESS POINT - CEILING MOUNTED
C204	C136-D-13/14	C136	2	WIRELESS ACCESS POINT - CEILING MOUNTED
C209	C136-D-15/16	C136	2	WIRELESS ACCESS POINT - CEILING MOUNTED
C211 C213	C136-D-17/18	C136	2 2	WIRELESS ACCESS POINT - CEILING MOUNTED WIRELESS ACCESS POINT - CEILING MOUNTED
C213	C136-D-19/20 C136-D-21/22	C136 C136	2	WIRELESS ACCESS POINT - CEILING MOUNTED WIRELESS ACCESS POINT - CEILING MOUNTED
UZ 10	U 100-D-2 1/22	0130	∠	TAN INCLUDE ACCUSE FORNI - CEILING MOUNTED

ROOM				
NUMBER	LABEL	TELECOM ROOM	DATA PORTS	COMMENTS
488	D212-A-01/02	D212	2	DATA LOCATION - FLUSH MOUNTED
B205	D212-A-03/04	D212	2	DATA LOCATION - FLUSH MOUNTED
B205	D212-A-05/06	D212	2	VIDEO BOARD LOCATION - FLUSH MOUNTED
B207	D212-A-10/11	D212	2	DATA LOCATION - FLUSH MOUNTED
B207	D212-A-12/13	D212	2	VIDEO BOARD LOCATION - FLUSH MOUNTED
D003 D006	D212-A-14/15 D212-A-16/17	D212 D212	2	DATA RE-CABLE - FLUSH MOUNTED DATA RE-CABLE - FLUSH MOUNTED
D102	D212-A-10/17	D212 D212	2	DATA RE-CABLE - FLUSH MOUNTED
D102	D212-A-20/21	D212	2	VIDEO BOARD LOCATION - SURFACE MOUNTED
D102	D212-A-22/23	D212	2	DATA LOCATION - SURFACE MOUNTED
D102	D212-A-24/25	D212	2	DATA LOCATION - SURFACE MOUNTED
D102	D212-A-26/27	D212	2	DATA LOCATION - SURFACE MOUNTED
D103	D212-A-28/29	D212	2	DATA LOCATION - FLUSH MOUNTED
D108	D212-A-30/31	D212	2	VIDEO BOARD LOCATION - FLUSH MOUNTED
D108	D212-A-32/33	D212	2	DATA LOCATION - FLUSH MOUNTED
D110	D212-A-34/35	D212	2	DATA RE-CABLE - FLUSH MOUNTED
D110	D212-A-36/37	D212	2	VIDEO BOARD LOCATION - FLUSH MOUNTED
D110 D110	D212-A-38/39 D212-A-40/41	D212 D212	2	DATA LOCATION - FLUSH MOUNTED DATA LOCATION - SURFACE MOUNTED
D110	D212-A-40/41	D212 D212	2	DATA LOCATION - SURFACE MOUNTED
D111	D212-A-42/45	D212	2	DATA RE-CABLE - FLUSH MOUNTED
D111	D212-A-46/47	D212	2	DATA RE-CABLE - FLUSH MOUNTED
D111	D212-A-48;D212- B-01	D212	2	DATA LOCATION - SURFACE MOUNTED
D111	D212-B-02/03	D212	2	DATA LOCATION - SURFACE MOUNTED
D114	D212-B-07/08	D212	2	DATA LOCATION - SURFACE MOUNTED
D117	D212-B-09/10	D212	2	VIDEO BOARD LOCATION - SURFACE MOUNTED
D117 D120	D212-B-11/12 D212-B-16/17	D212 D212	2	DATA LOCATION - SURFACE MOUNTED DATA RE-CABLE - FLUSH MOUNTED
D120	D212-B-10/17	D212 D212	2	VIDEO BOARD LOCATION - SURFACE MOUNTED
D124	D212-B-10/19	D212	2	VIDEO BOARD LOCATION - SURFACE MOUNTED
D124	D212-B-22/23	D212	2	DATA LOCATION - SURFACE MOUNTED
D202	D212-B-24/25	D212	2	VIDEO BOARD LOCATION - SURFACE MOUNTED
D202	D212-B-26/27	D212	2	DATA LOCATION - SURFACE MOUNTED
D206	D212-B-31/32	D212	2	VIDEO BOARD LOCATION - SURFACE MOUNTED
D206	D212-B-33/34	D212	2	DATA LOCATION - SURFACE MOUNTED
D209	D212-B-38/39	D212	2	VIDEO BOARD LOCATION - SURFACE MOUNTED
D209	D212-B-40/41	D212	2	DATA LOCATION - SURFACE MOUNTED
D214	D212-B-42/43 D212-B-44/45	D212	2	VIDEO BOARD LOCATION - SURFACE MOUNTED
D214 D216	D212-B-44/45 D212-B-46/47	D212 D212	2	DATA LOCATION - SURFACE MOUNTED VIDEO BOARD LOCATION - FLUSH MOUNTED
D216	D212-B-48;	D212	2	DATA LOCATION - FLUSH MOUNTED
DZ 10	D212-C-01	5212	_	BATALEGGATION TEGGITIMOGNIEB
D221	D212-C-08/09	D212	2	VIDEO BOARD LOCATION - SURFACE MOUNTED
D221	D212-C-10/11	D212	2	DATA LOCATION - SURFACE MOUNTED
E101	D212-C-12/13	D212	2	DATA LOCATION - SURFACE MOUNTED
488	D212-D-01	D212	1	SECURITY CAMERA - WALL MOUNTED
D101	D212-D-02	D212	1	SECURITY CAMERA - WALL MOUNTED
D114	D212-D-03	D212	1	SECURITY CAMERA - WALL MOUNTED
D201	D212-D-04	D212	1	SECURITY CAMERA - CEILING MOUNTED
D211 E101	D212-D-05 D212-D-06	D212 D212	1	SECURITY CAMERA - WALL MOUNTED SECURITY CAMERA - CEILING MOUNTED
E101	D212-D-06 D212-D-07	D212	1	SECURITY CAMERA - CEILING MOUNTED
E102	D212-D-07	D212	1	SECURITY CAMERA - CEILING MOUNTED
E102	D212-D-09	D212	1	SECURITY CAMERA - CEILING MOUNTED
E102	D212-D-10/11	D212	2	ABOVE CEILING SECURITY DATA LOCATION
EXT	D212-D-12	D212	1	SECURITY CAMERA - WALL MOUNTED
EXT	D212-D-13	D212	1	SECURITY CAMERA - WALL MOUNTED
EXT	D212-D-14	D212	1	SECURITY CAMERA - WALL MOUNTED
SITE	D212-D-15	D212	1	SECURITY CAMERA - LIGHT POLE MOUNTED
B205	D212-E-01/02	D212	2	WIRELESS ACCESS POINT - CEILING MOUNTED
B207	D212-E-03/04	D212	2	WIRELESS ACCESS POINT - CEILING MOUNTED
D102	D212-E-05/06	D212	2	WIRELESS ACCESS POINT - CEILING MOUNTED
D108	D212-E-07/08	D212	2	WIRELESS ACCESS POINT - CEILING MOUNTED
D110 D117	D212-E-09/10 D212-E-11/12	D212 D212		WIRELESS ACCESS POINT - CEILING MOUNTED WIRELESS ACCESS POINT - CEILING MOUNTED
D117 D120	D212-E-11/12 D212-E-13/14	D212 D212	2 2	WIRELESS ACCESS POINT - CEILING MOUNTED WIRELESS ACCESS POINT - CEILING MOUNTED
D120	D212-E-13/14 D212-E-15/16	D212	2	WIRELESS ACCESS POINT - CEILING MOUNTED WIRELESS ACCESS POINT - CEILING MOUNTED
D124 D202	D212-E-13/10	D212	2	WIRELESS ACCESS POINT - CEILING MOUNTED
D202	D212-E-17/10	D212	2	WIRELESS ACCESS POINT - CEILING MOUNTED
D209	D212-E-21/22	D212	2	WIRELESS ACCESS POINT - CEILING MOUNTED
D214	D212-E-23/24	D212	2	WIRELESS ACCESS POINT - CEILING MOUNTED
		D212	2	WIRELESS ACCESS POINT - CEILING MOUNTED
D216	D212-E-25/26	DZ 12	_	

ROOM NUMBER	LABEL	TELECOM ROOM	DATA PORTS	COMMENTS
G202	G205-A-01/02	G205	2	DATA LOCATION - SURFACE MOUNTED
G202	G205-A-03/04	G205	2	VIDEO BOARD LOCATION - SURFACE MOUNTED
G204	G205-A-05/06	G205	2	DATA LOCATION - SURFACE MOUNTED
G204	G205-A-07/08	G205	2	VIDEO BOARD LOCATION - SURFACE MOUNTED
G209	G205-A-09/10	G205	2	DATA LOCATION - SURFACE MOUNTED
G210	G205-A-11/12	G205	2	DATA LOCATION - FLUSH MOUNTED
G210	G205-A-13/14	G205	2	DATA LOCATION - FLUSH MOUNTED
G213	G205-A-15/16	G205	2	VIDEO BOARD LOCATION - FLUSH MOUNTED
G213	G205-A-17/18	G205	2	DATA LOCATION - FLUSH MOUNTED
G216	G205-A-19/20	G205	2	VIDEO BOARD LOCATION - FLUSH MOUNTED
G216	G205-A-21/22	G205	2	DATA LOCATION - FLUSH MOUNTED
G218	G205-A-23/24	G205	2	DATA LOCATION - FLUSH MOUNTED
G218	G205-A-25/26	G205	2	DATA LOCATION - FLUSH MOUNTED
G220	G205-A-27/28	G205	2	DATA LOCATION - FLUSH MOUNTED
G223	G205-A-29/30	G205	2	DATA LOCATION - SURFACE MOUNTED
E203	G205-B-01	G205	1	SECURITY CAMERA - CEILING MOUNTED
EXT	G205-B-02	G205	1	SECURITY CAMERA - WALL MOUNTED
EXT	G205-B-03	G205	1	SECURITY CAMERA - WALL MOUNTED
G201	G205-B-04	G205	1	SECURITY CAMERA - CEILING MOUNTED
G206	G205-B-05	G205	1	SECURITY CAMERA - CEILING MOUNTED
G202	G205-C-01/02	G205	2	WIRELESS ACCESS POINT - CEILING MOUNTED
G204	G205-C-03/04	G205	2	WIRELESS ACCESS POINT - CEILING MOUNTED
G208	G205-C-05/06	G205	2	WIRELESS ACCESS POINT - CEILING MOUNTED
G213	G205-C-07/08	G205	2	WIRELESS ACCESS POINT - CEILING MOUNTED
G216	G205-C-09/10	G205	2	WIRELESS ACCESS POINT - CEILING MOUNTED
G221	G205-C-11/12	G205	2	WIRELESS ACCESS POINT - CEILING MOUNTED
Frand total			47	

ROOM			2474 20270	
NUMBER	LABEL	TELECOM ROOM	DATA PORTS	COMMENTS
F102	F203-A-01/02	F203	2	DATA LOCATION - FLUSH MOUNTED
F103	F203-A-03/04	F203	2	DATA LOCATION - FLUSH MOUNTED
F115	F203-A-05/06	F203	2	DATA LOCATION - SURFACE MOUNTED
F202	F203-A-07	F203	1	WALL PHONE LOCATION
F202	F203-A-08	F203	1	MONITOR LOCATION - CEILING MOUNTED
F202	F203-A-09	F203	1	MONITOR LOCATION - CEILING MOUNTED
F202	F203-A-10	F203	1	MONITOR LOCATION
F203	F203-A-11/12	F203	2	DATA LOCATION - SURFACE MOUNTED
F206	F203-A-13/14	F203	2	FLOOR BOX LOCATION
F206	F203-A-15/16	F203	2	FLOOR BOX LOCATION
F210	F203-A-17	F203	1	WALL PHONE LOCATION
F213	F203-A-18/19	F203	2	DATA LOCATION - FLUSH MOUNTED
E103	F203-B-01	F203	1	SECURITY CAMERA - WALL MOUNTED
E103	F203-B-02	F203	1	SECURITY CAMERA - WALL MOUNTED
E202	F203-B-03	F203	1	SECURITY CAMERA - CEILING MOUNTED
E202	F203-B-04	F203	1	SECURITY CAMERA - CEILING MOUNTED
EXT	F203-B-05	F203	1	SECURITY CAMERA - WALL MOUNTED
EXT	F203-B-06	F203	1	SECURITY CAMERA - WALL MOUNTED
EXT	F203-B-07	F203	1	SECURITY CAMERA - WALL MOUNTED
F101	F203-B-08	F203	1	SECURITY CAMERA - CEILING MOUNTED
F114	F203-B-09	F203	1	SECURITY CAMERA - WALL MOUNTED
F114	F203-B-10	F203	1	SECURITY CAMERA - WALL MOUNTED
F201	F203-B-11	F203	1	SECURITY CAMERA - CEILING MOUNTED
F202	F203-B-12	F203	1	SECURITY CAMERA - WALL MOUNTED
F202	F203-B-13	F203	1	SECURITY CAMERA - WALL MOUNTED
F202	F203-C-01/02	F203	2	WIRELESS ACCESS POINT - CEILING MOUN

MDF B310 ACCESS CONTROL SCHEDULE						
DOOR NUMBER	PANEL LOCATION	MARK	DOOR TYPE / DESCRIPTION			
A201-1	B310	A201-1-MH	EAC DOOR TYPE D1MH			
B101-1	B310	B101-1-CR	EAC TYPE D3A			
B101-2	B310	B101-2-CR	EAC TYPE D3MA			
B102-1	B310	B102-1-CR	EAC TYPE S3MES			
B102-2	B310	B102-2-CR	EAC TYPE S3MES			
B103	B310	B103-CR	EAC TYPE S3ES			
B109	B310	B109-CR	EAC TYPE S3			
ST1-2	B310	ST1-2-DPS	EAC TYPE S1			
ST1-3	B310	ST1-3-DPS	EAC TYPE S1			

DOOR NUMBER	PANEL LOCATION	MARK	DOOR TYPE / DESCRIPTION
C101-1	C136	C101-1-CR	EAC TYPE S3ES
C105	C136	C105-CR	EAC TYPE S3ES
C119	C136	C119-CR	EAC TYPE S3M
C125-1	C136	C125-1-CR	EAC TYPE D3
C126	C136	C136-C-12	EAC TYPE D3MA
C132	C136	C132-MH	EAC DOOR TYPE D1MH
C133-2	C136	C126-DPS	EAC TYPE S1
C137-2	C136	C137-2-DPS	EAC TYPE S1
C201	C136	C201-MH	EAC DOOR TYPE D1MH
D131	C136	D131-DPS	EAC TYPE S1

IDF G205 ACCESS CONTROL SCHEDULE							
DOOR NUMBER	PANEL LOCATION	MARK	DOOR TYPE / DESCRIPTION				
G201	G205	G201-MH	EAC DOOR TYPE D1MH				
G215-1	G205	G215-1-CR	EAC TYPE D3A				
rand total: 2							

Grand total: 6

IDF F203 ACCESS CONTROL SCHEDULE							
DOOR NUMBER	PANEL LOCATION	MARK	DOOR TYPE / DESCRIPTION				
E103	F203	E103-DPS	EAC TYPE D1				
E585	F203	E585-DPS	EAC TYPE S1				
F101-1	F203	F101-1-MH	EAC DOOR TYPE D1MH				
F101-2	F203	F101-2-DPS	EAC TYPE D1				
F114	F203	F114-DPS	EAC TYPE D1				
F201-1	F203	F201-1-MH	EAC DOOR TYPE D1MH				



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SCHOOL CORPORATION
RENOVATIONS TO
FRANCES SMITH ELEMENTA

SCOPE DRAWINGS:

These drawings indicate the general scope of the project in terms of architectural design concept, the dimensions of the building, the major architectural elements and the type of structural, mechanical and electrical systems.

The drawings do not necessarily indicate or describe all work required for full performance and completion of the requirements of the Contract.

On the basis of the general scope indicated or described, the trade contractors shall furnish all items required for the proper execution and completion of the work.

REVISIONS:


1 Addendum 02 02/05/2025
2 Addendum 04 02/12/2025

ISSUE DATE DRAWN BY CHECKED BY 01/15/25 MKD JKK

TECHNOLOGY/
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SCHEDULES


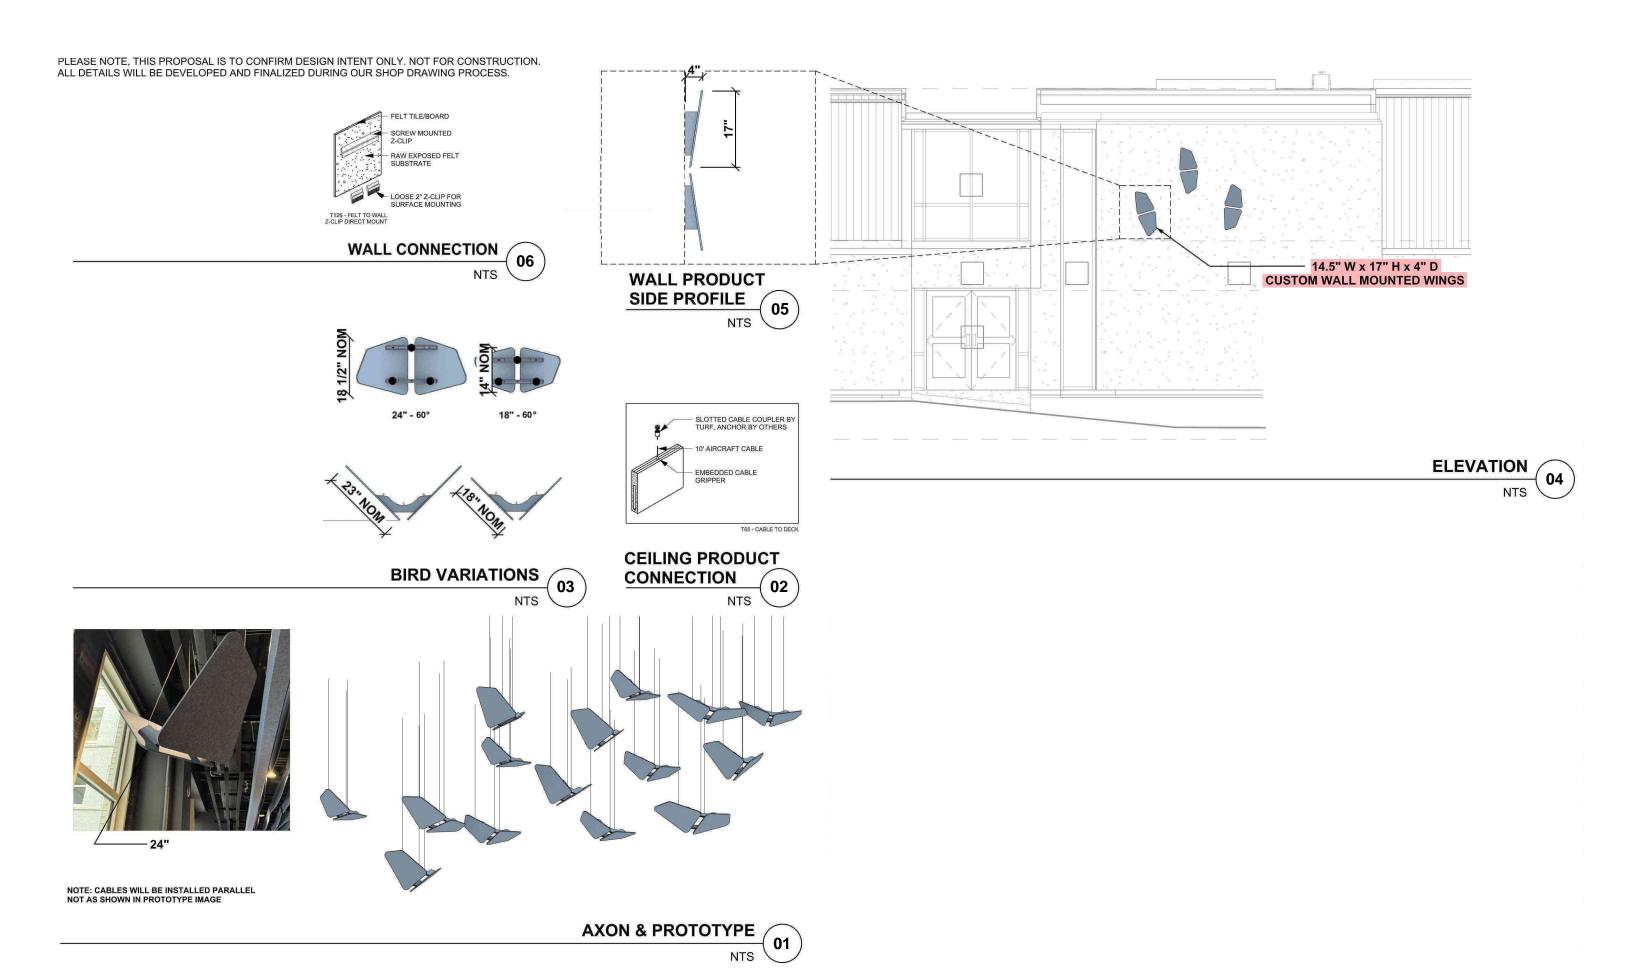
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