ADDENDUM NO.1

Center Grove High School Parking Lot and Canopy

Center Grove Community School Corporation Greenwood, Indiana

Project No. 224140.00

Index of Contents

Addendum No. 1, 1 item, 1 page
Revised Drawing Sheets: GD1.0, GD1.1, GD1.2, GD1.4, G1.0, G1.1, G1.2, G1.3, G1.4, G1.5, G2.0, G2.1, G2.3, G2.4, SU1.0, SU1.3, SU2.1, L1.00, E1.01
AECOM/Hunt Bidder Question Log

Date: June 18, 2025

I hereby certify that this Addendum was prepared by me or under my direct supervision and that I am a duly registered Architect/Engineer under the Laws of the State of Indiana.

FANNING/HOWEY ASSOCIATES, INC. ARCHITECTS/ENGINEERS/CONSULTANTS



Paul A. Miller Registration Number AR10800161

TO: ALL BIDDERS OF RECORD

ADDENDUM NO. 1 to Drawings and Project Manual, dated June 6, 2025, for Center Grove High School Parking Lot and Canopy for Center Grove Community School Corporation, 4800 West Stones Crossing Road, Greenwood, IN 46143; as prepared by Fanning/Howey Associates, Inc., Indianapolis, Indiana. This Addendum shall hereby be and become a part of the Contract Documents the same as if originally bound thereto.

The following clarifications, amendments, additions, revisions, changes, and modifications change the original Contract Documents only in the amount and to the extent hereinafter specified in this Addendum.

Each bidder shall acknowledge receipt of this Addendum in his proposal or bid.

NOTE: Bidders are responsible for becoming familiar with every item of this Addendum. (This includes miscellaneous items at the very end of this Addendum.)

RE: ALL BIDDERS

ITEM NO. 1. REVISED DRAWING SHEETS


A. Drawing Sheets: GD1.0, GD1.1, GD1.2, GD1.4, G1.0, G1.1, G1.2, G1.3, G1.4, G1.5, G2.0, G2.1, G2.3, G2.4, SU1.0, SU1.3, SU2.1, L1.00, E1.01 have been revised, dated 6/18/25 and are included with and hereby made a part of this Addendum. These Drawings supersede the original documents.

END OF ADDENDUM



AECOM HUNT

No.	Drawing/Spec Reference	Question/Issue	Response
1	N/A	Can Allowance funds be used to cover exclation costs?	Exclation costs must be estimated and factored into the bid price. This is a Lump Sum Bid.
2	Exhibit E	Are we doing soil stabilization?	Soil stabilization has not been designed into the project, any unsuitble soils will be determined by Owner's Engineering Testing Consultant
3	01 12 00	Does the owner want to retain soil on site?	No, all excess spoils need to be removed from the site as part of the base bid.
4	01 12 00	Is site fence required and will it have to be reconfigured?	Yes site fence is required as depicted on Exhibit B Site Logistics, and will need to be reconfigured as Phases are turned over. Contractors will need to sign the Civil Engineer's Data Waiver,
5	N/A	How does a contractor obtain the CAD files?	Contractors will need to sign the Civil Engineer's Data Waiver, email AECOM Hunt and we will forward the waiver and the design team will supply the CAD files.
6	N/A	Is binder and temporary striping acceptable to turn phases over to the owner for temporary use, with final paving to be completed at a later date?	Yes at no additional cost to the owner.
7	33 46 00	What is the process for backfilling the underground detention structures?	Contractor must follow manufacturers recommendations and applicable specifications
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SHALL BE VERIFIED BY CONTRACTOR PRIOR TO ANY AND

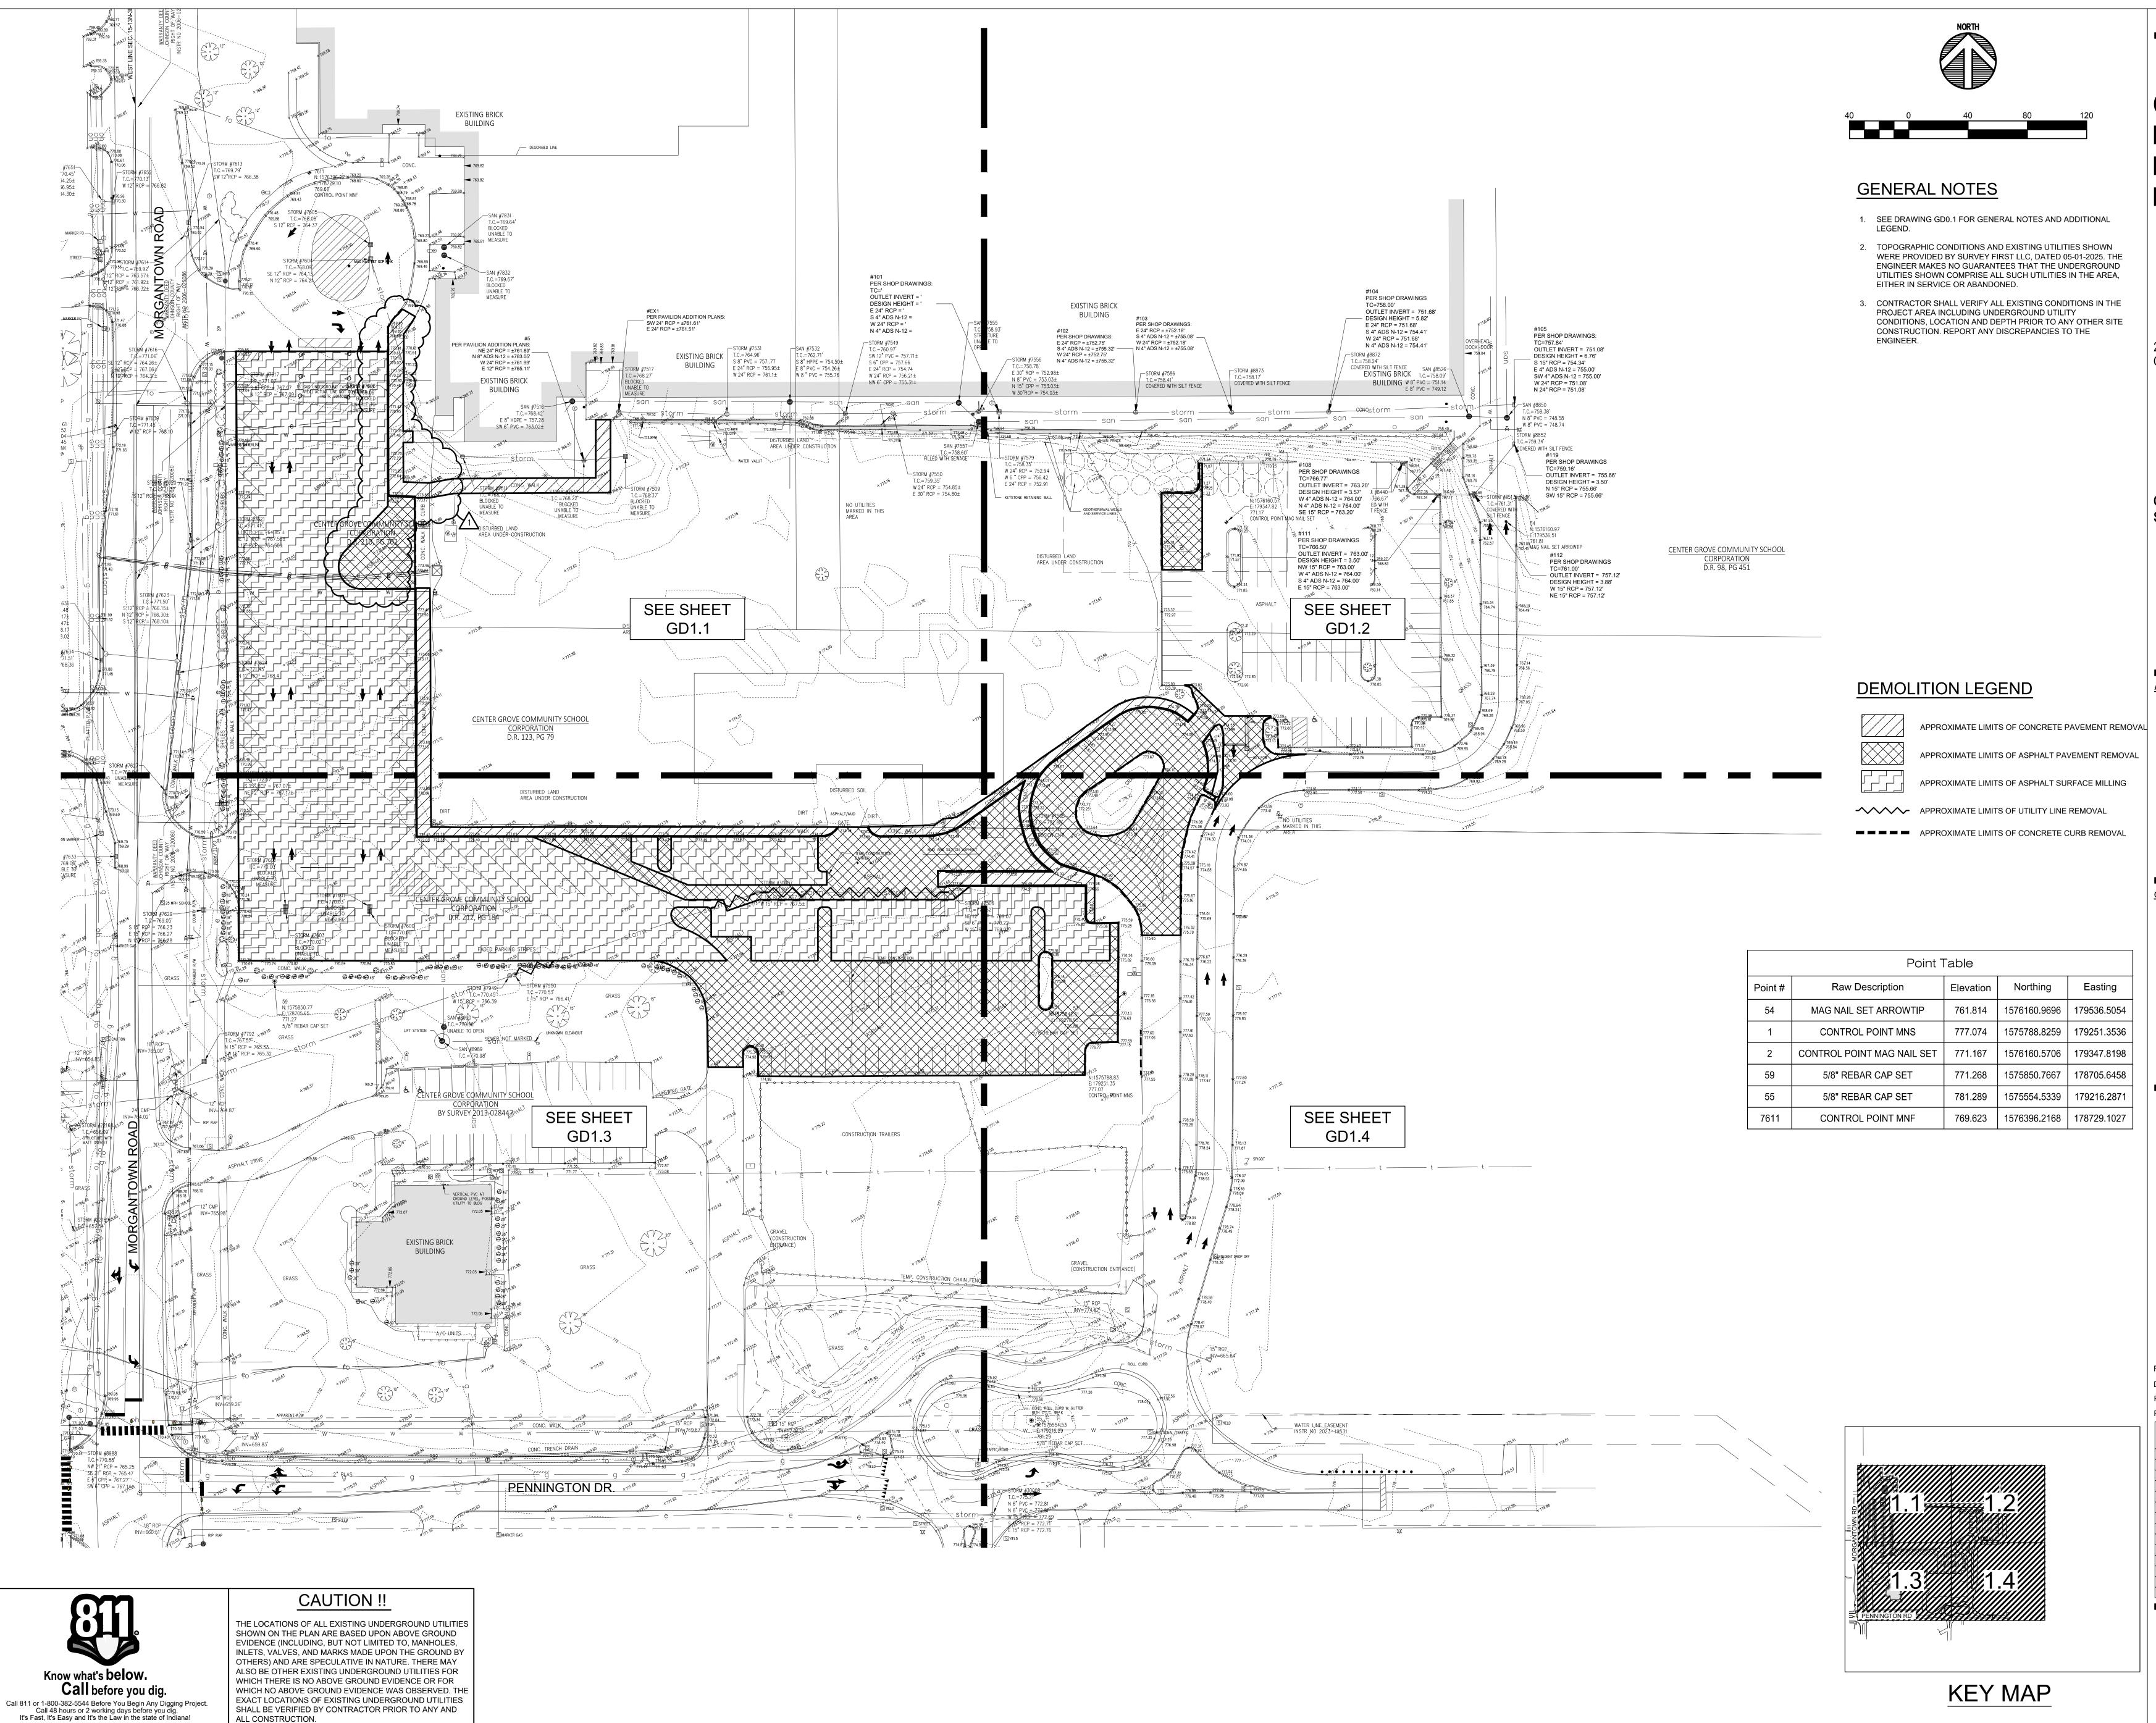ALL CONSTRUCTION.

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CENTER GROVE HIGH SCHOOL **PARKING LOT EXPANSION**

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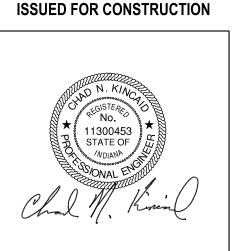
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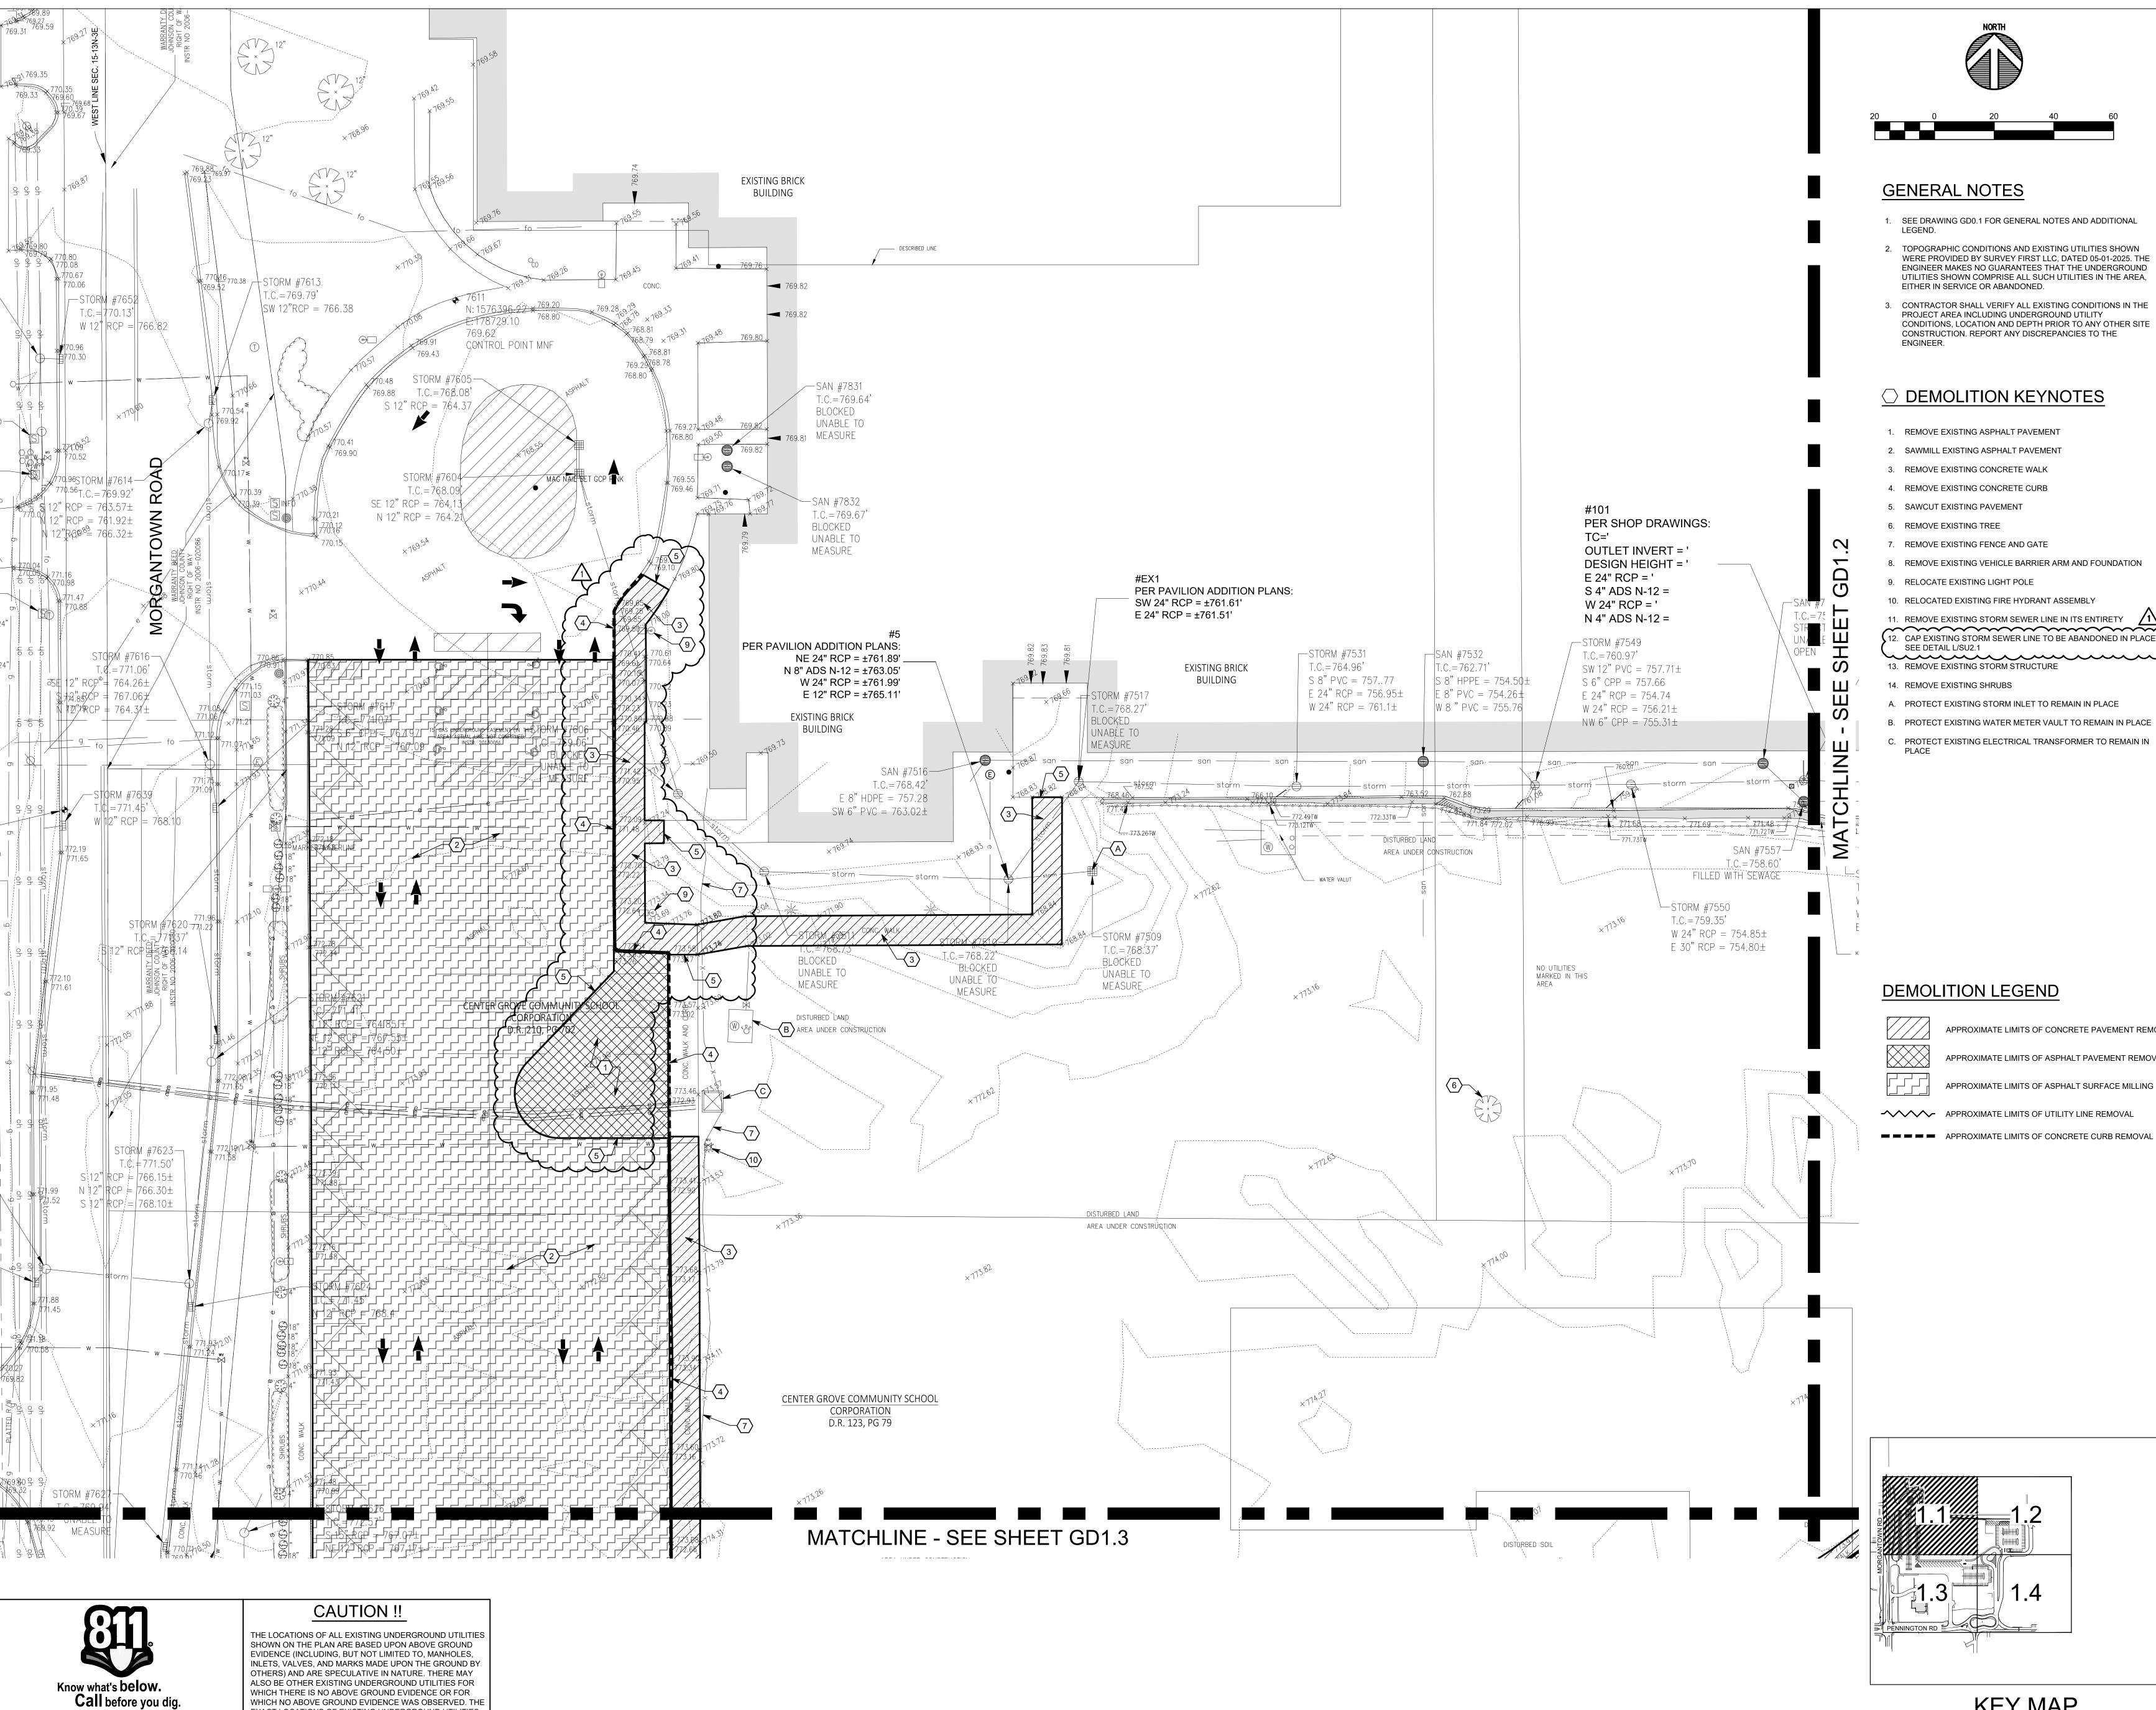
PROJECT MANAGER: CNK DRAWN BY: JHL PROJECT NUMBER: 224140.00 PROJECT ISSUE DATE: 06-06-2025


REV.

NO.△	DESCRIPTION	DATE
1	ADDENDUM 1	06/18/2025

OVERALL SITE DEMOLITION PLAN

GD1.0



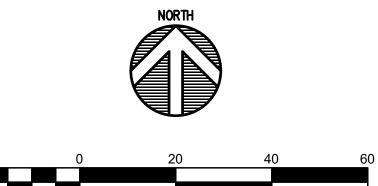

- 1. SEE DRAWING GD0.1 FOR GENERAL NOTES AND ADDITIONAL
- 2. TOPOGRAPHIC CONDITIONS AND EXISTING UTILITIES SHOWN WERE PROVIDED BY SURVEY FIRST LLC, DATED 05-01-2025. THE ENGINEER MAKES NO GUARANTEES THAT THE UNDERGROUND UTILITIES SHOWN COMPRISE ALL SUCH UTILITIES IN THE AREA, EITHER IN SERVICE OR ABANDONED.
- 3. CONTRACTOR SHALL VERIFY ALL EXISTING CONDITIONS IN THE PROJECT AREA INCLUDING UNDERGROUND UTILITY CONDITIONS, LOCATION AND DEPTH PRIOR TO ANY OTHER SITE CONSTRUCTION. REPORT ANY DISCREPANCIES TO THE

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CENTER GROVE

HIGH SCHOOL

PARKING LOT

EXPANSION

DEMOLITION KEYNOTES

- REMOVE EXISTING ASPHALT PAVEMENT
- 2. SAWMILL EXISTING ASPHALT PAVEMENT
- 3. REMOVE EXISTING CONCRETE WALK
- 6. REMOVE EXISTING TREE
- 7. REMOVE EXISTING FENCE AND GATE
- 8. REMOVE EXISTING VEHICLE BARRIER ARM AND FOUNDATION
- 9. RELOCATE EXISTING LIGHT POLE
- 10. RELOCATED EXISTING FIRE HYDRANT ASSEMBLY
- 11. REMOVE EXISTING STORM SEWER LINE IN ITS ENTIRETY

 12. CAP EXISTING STORM SEWER LINE TO BE ABANDONED IN PLACE -SEE DETAIL L/SU2.1
- 14. REMOVE EXISTING SHRUBS
- A. PROTECT EXISTING STORM INLET TO REMAIN IN PLACE
- B. PROTECT EXISTING WATER METER VAULT TO REMAIN IN PLACE
- PROTECT EXISTING ELECTRICAL TRANSFORMER TO REMAIN IN



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DEMOLITION LEGEND


APPROXIMATE LIMITS OF CONCRETE PAVEMENT REMOVAL

APPROXIMATE LIMITS OF ASPHALT PAVEMENT REMOVAL

APPROXIMATE LIMITS OF UTILITY LINE REMOVAL

APPROXIMATE LIMITS OF CONCRETE CURB REMOVAL

ISSUED FOR CONSTRUCTION

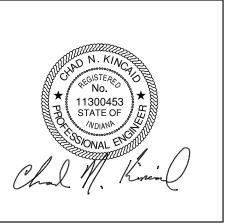

PROJECT MANAGER: CNK DRAWN BY: JHL PROJECT NUMBER: 224140.00 PROJECT ISSUE DATE: 06-06-2025

NO.	DESCRIPTION	DATE
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11	ADDENDUM 1	06/18/2025

SITE DEMOLITION PLAN 1 OF 4


GD1.1


WHICH NO ABOVE GROUND EVIDENCE WAS OBSERVED. THE EXACT LOCATIONS OF EXISTING UNDERGROUND UTILITIES SHALL BE VERIFIED BY CONTRACTOR PRIOR TO ANY AND

ALL CONSTRUCTION.

Call 811 or 1-800-382-5544 Before You Begin Any Digging Project.

Call 48 hours or 2 working days before you dig. It's Fast, It's Easy and It's the Law in the state of Indiana! **KEY MAP**

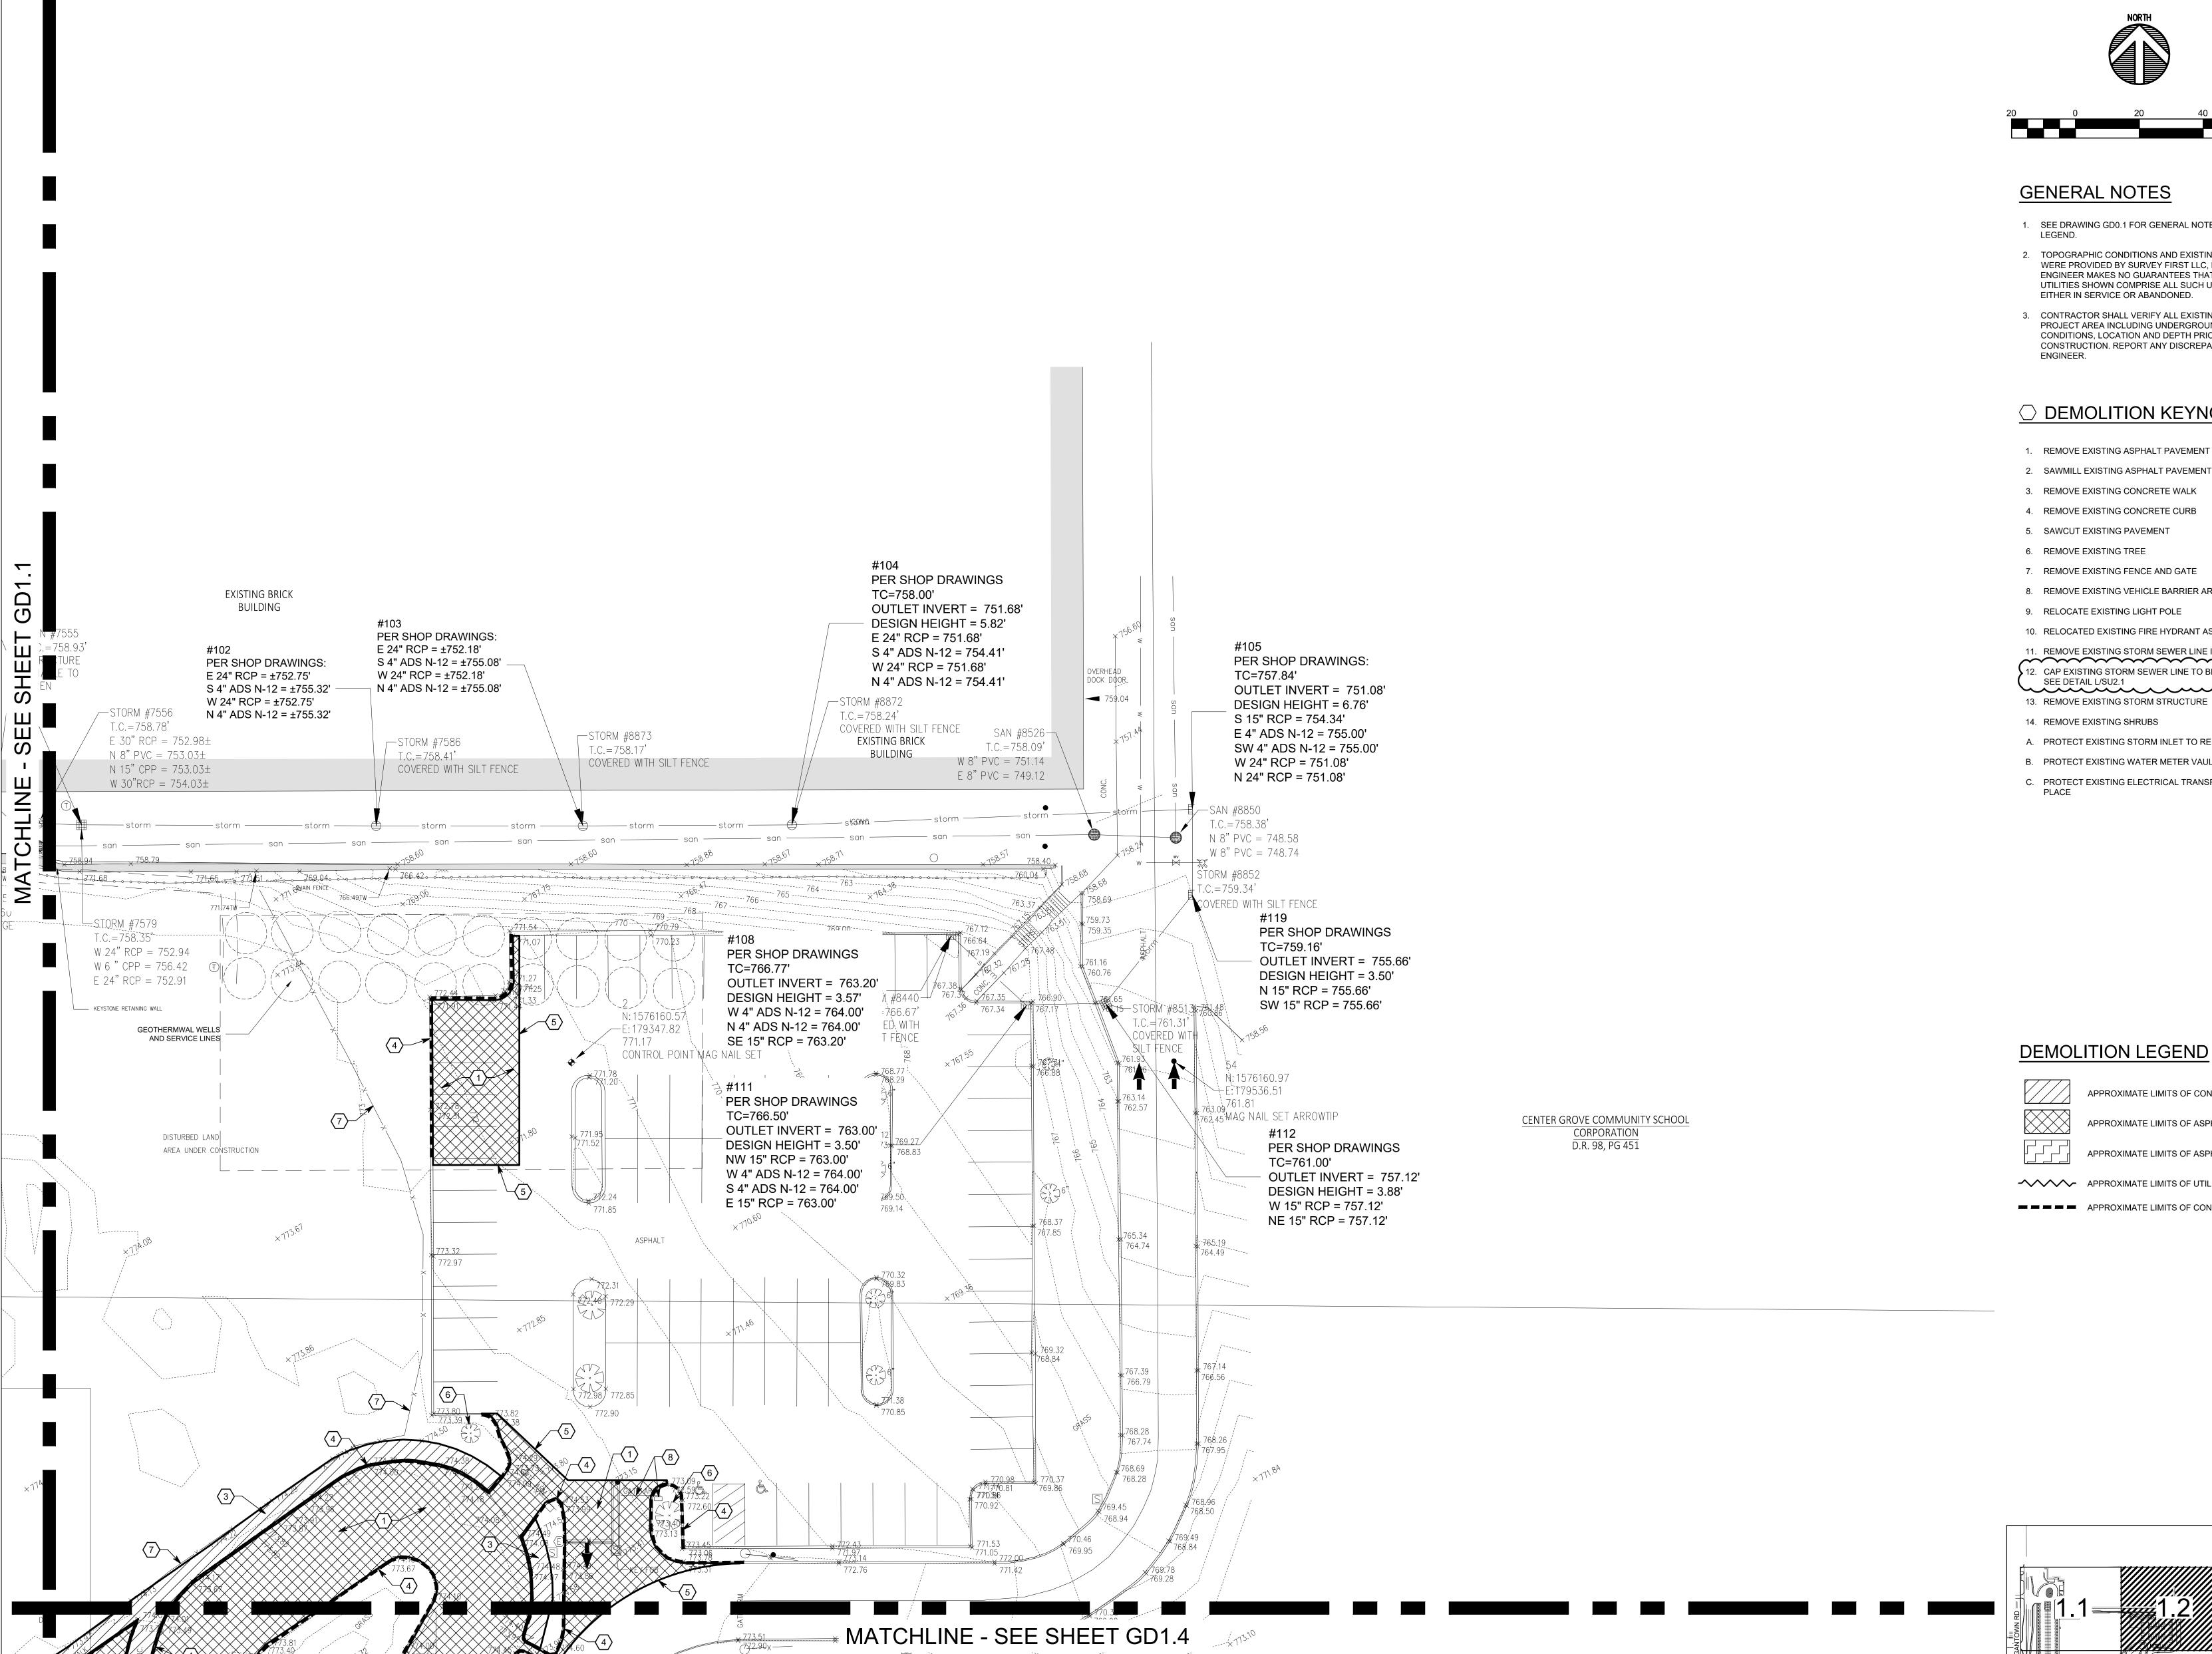

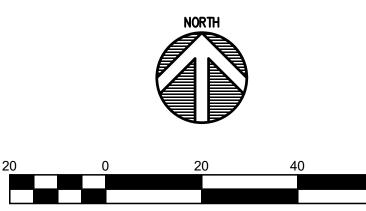

GENERAL NOTES

1. SEE DRAWING GD0.1 FOR GENERAL NOTES AND ADDITIONAL

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DEMOLITION KEYNOTES

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- 3. REMOVE EXISTING CONCRETE WALK
- 4. REMOVE EXISTING CONCRETE CURB
- 5. SAWCUT EXISTING PAVEMENT
- REMOVE EXISTING TREE
- 7. REMOVE EXISTING FENCE AND GATE
- 8. REMOVE EXISTING VEHICLE BARRIER ARM AND FOUNDATION
- 9. RELOCATE EXISTING LIGHT POLE
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11. REMOVE EXISTING STORM SEWER LINE IN ITS ENTIRETY 12. CAP EXISTING STORM SEWER LINE TO BE ABANDONED IN PLACE -SEE DETAIL L/SU2.1

- 13. REMOVE EXISTING STORM STRUCTURE 14. REMOVE EXISTING SHRUBS
- A. PROTECT EXISTING STORM INLET TO REMAIN IN PLACE B. PROTECT EXISTING WATER METER VAULT TO REMAIN IN PLACE
- C. PROTECT EXISTING ELECTRICAL TRANSFORMER TO REMAIN IN


CENTER GROVE HIGH SCHOOL **PARKING LOT**

EXPANSION

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APPROXIMATE LIMITS OF ASPHALT SURFACE MILLING


APPROXIMATE LIMITS OF CONCRETE PAVEMENT REMOVAL

APPROXIMATE LIMITS OF ASPHALT PAVEMENT REMOVAL

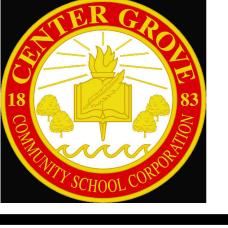APPROXIMATE LIMITS OF UTILITY LINE REMOVAL

APPROXIMATE LIMITS OF CONCRETE CURB REMOVAL

ISSUED FOR CONSTRUCTION

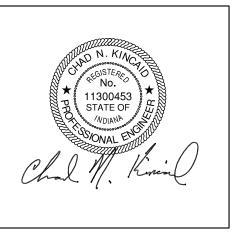

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SITE DEMOLITION PLAN 2 OF 4

GD1.2

KEY MAP


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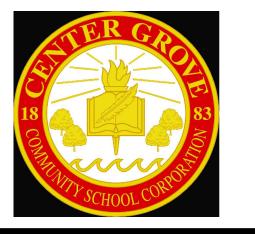
THE LOCATIONS OF ALL EXISTING UNDERGROUND UTILITIES SHOWN ON THE PLAN ARE BASED UPON ABOVE GROUND EVIDENCE (INCLUDING, BUT NOT LIMITED TO, MANHOLES, INLETS, VALVES, AND MARKS MADE UPON THE GROUND BY OTHERS) AND ARE SPECULATIVE IN NATURE. THERE MAY ALSO BE OTHER EXISTING UNDERGROUND UTILITIES FOR WHICH THERE IS NO ABOVE GROUND EVIDENCE OR FOR WHICH NO ABOVE GROUND EVIDENCE WAS OBSERVED. THE EXACT LOCATIONS OF EXISTING UNDERGROUND UTILITIES SHALL BE VERIFIED BY CONTRACTOR PRIOR TO ANY AND ALL CONSTRUCTION.



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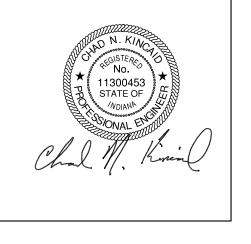


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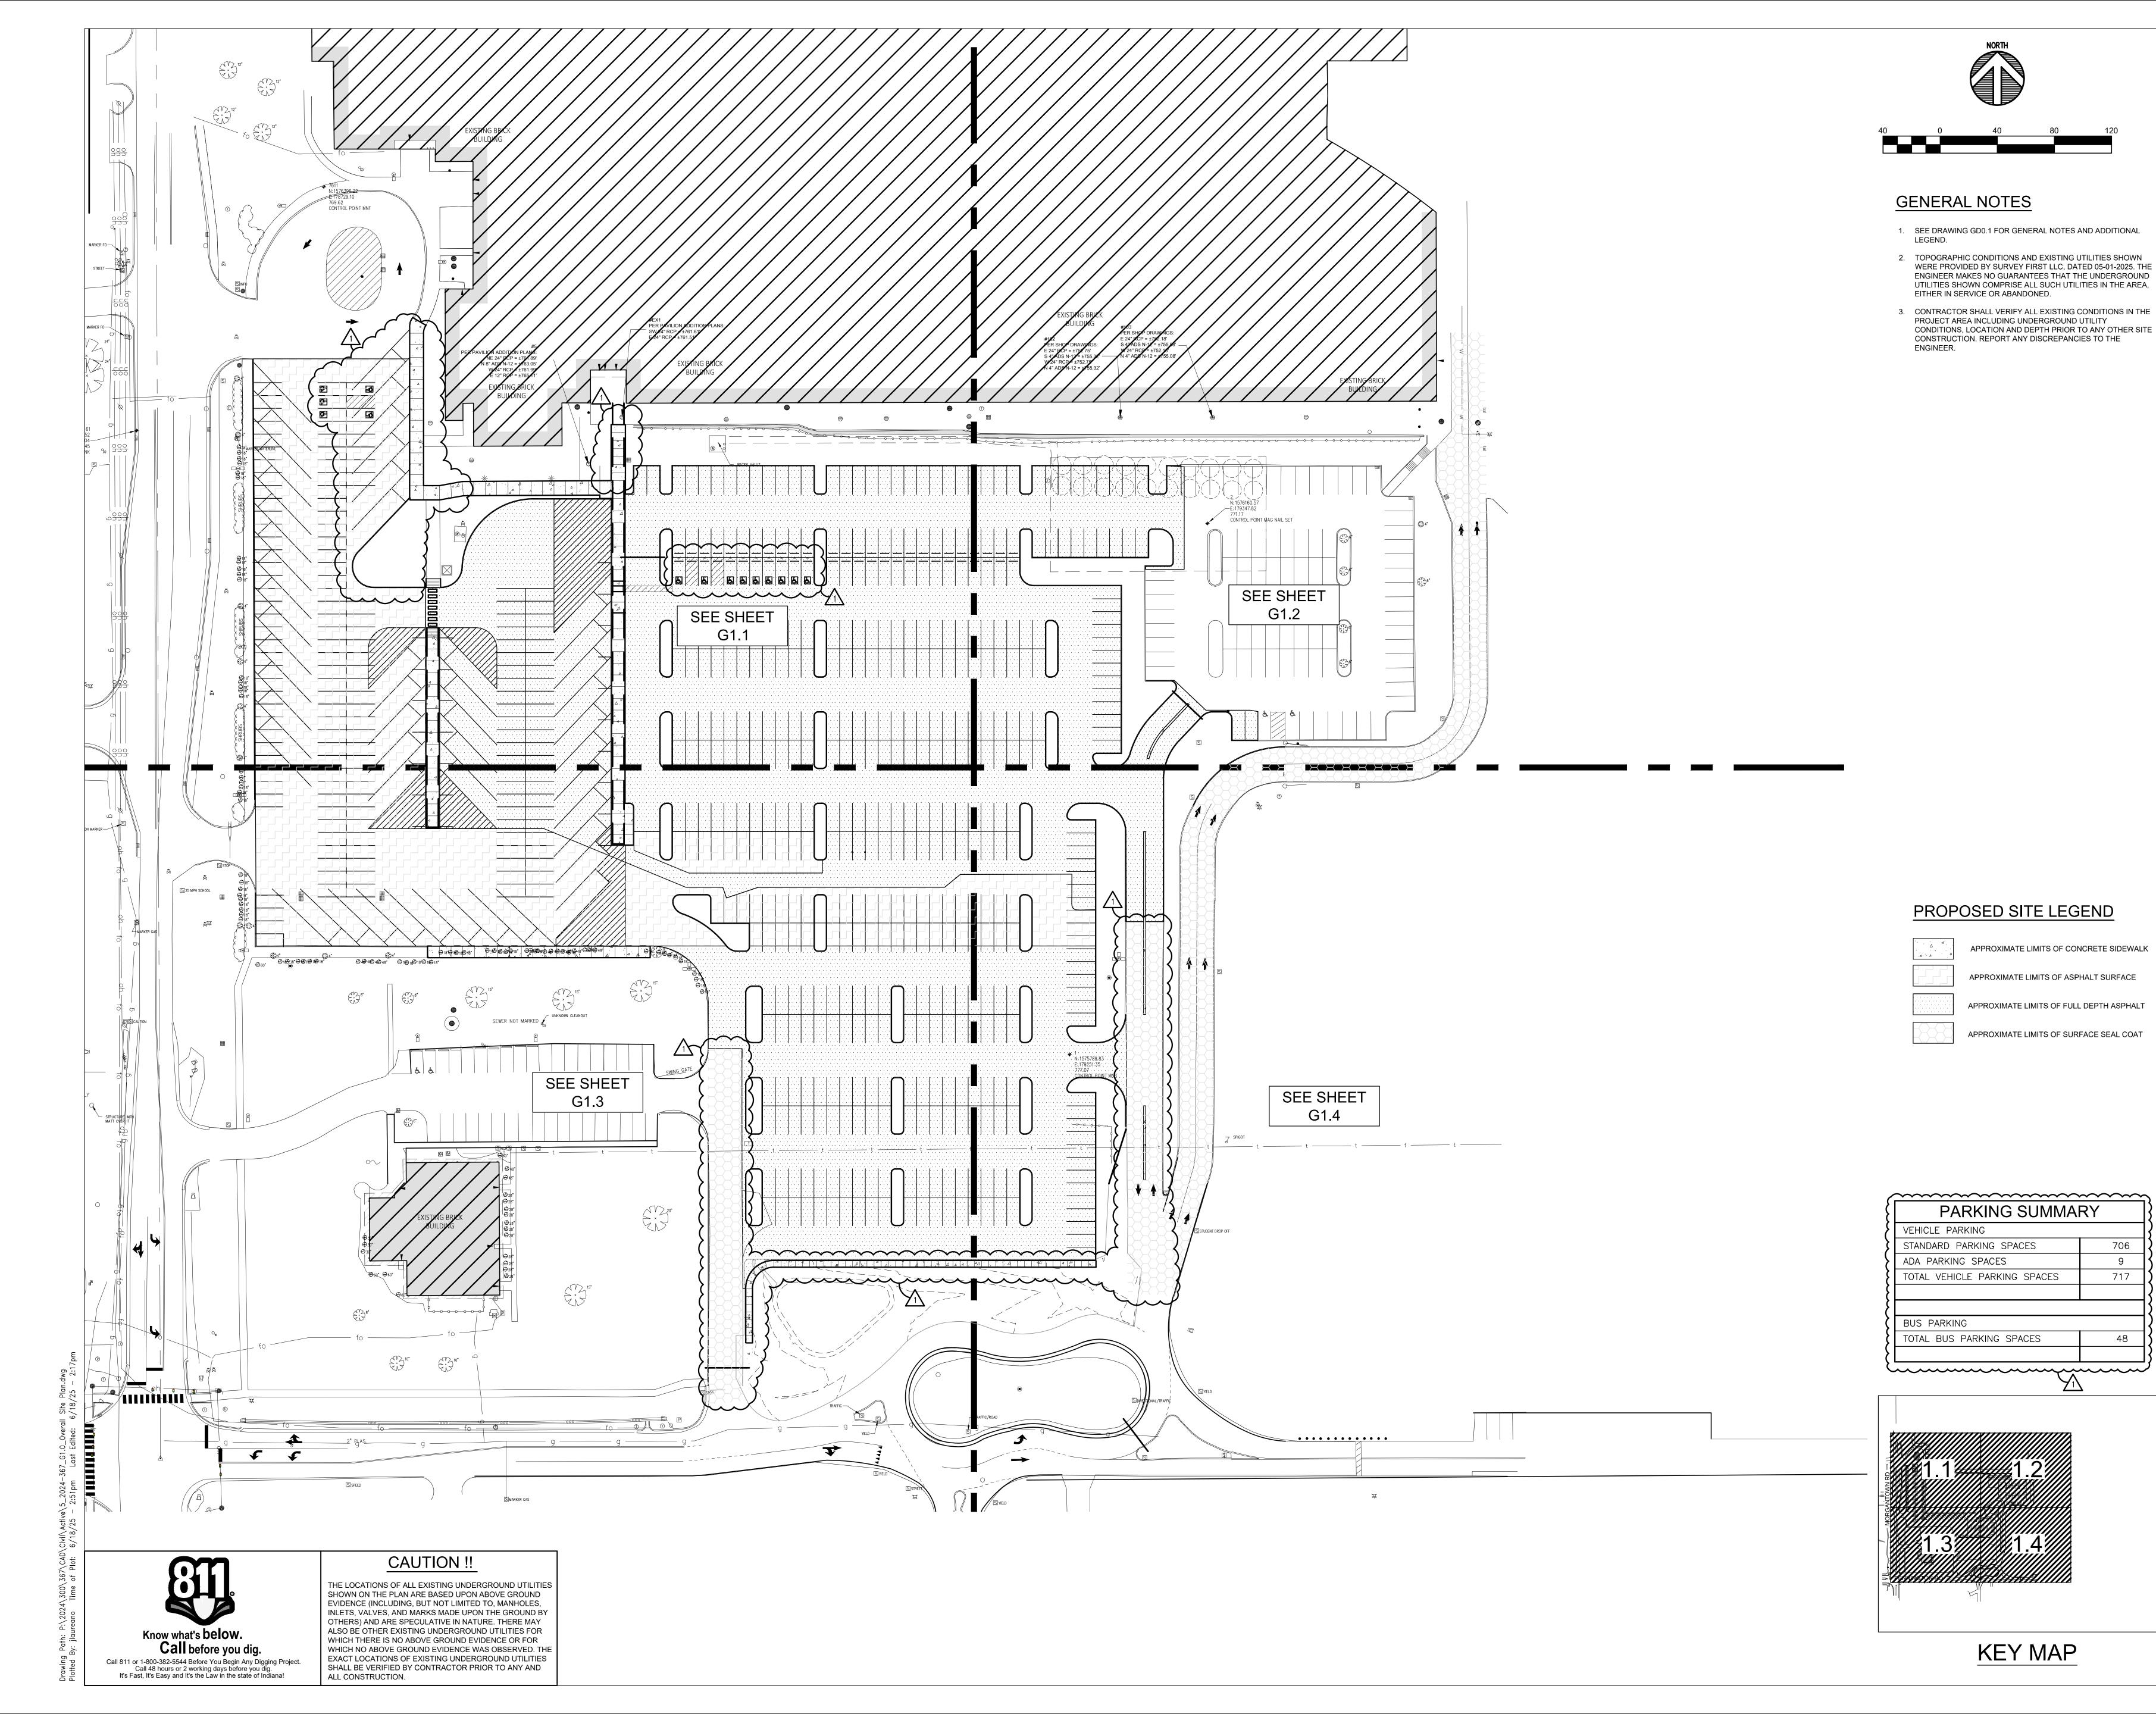
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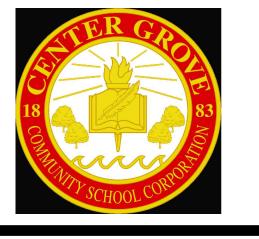
SITE DEMOLITION PLAN 4 OF 4

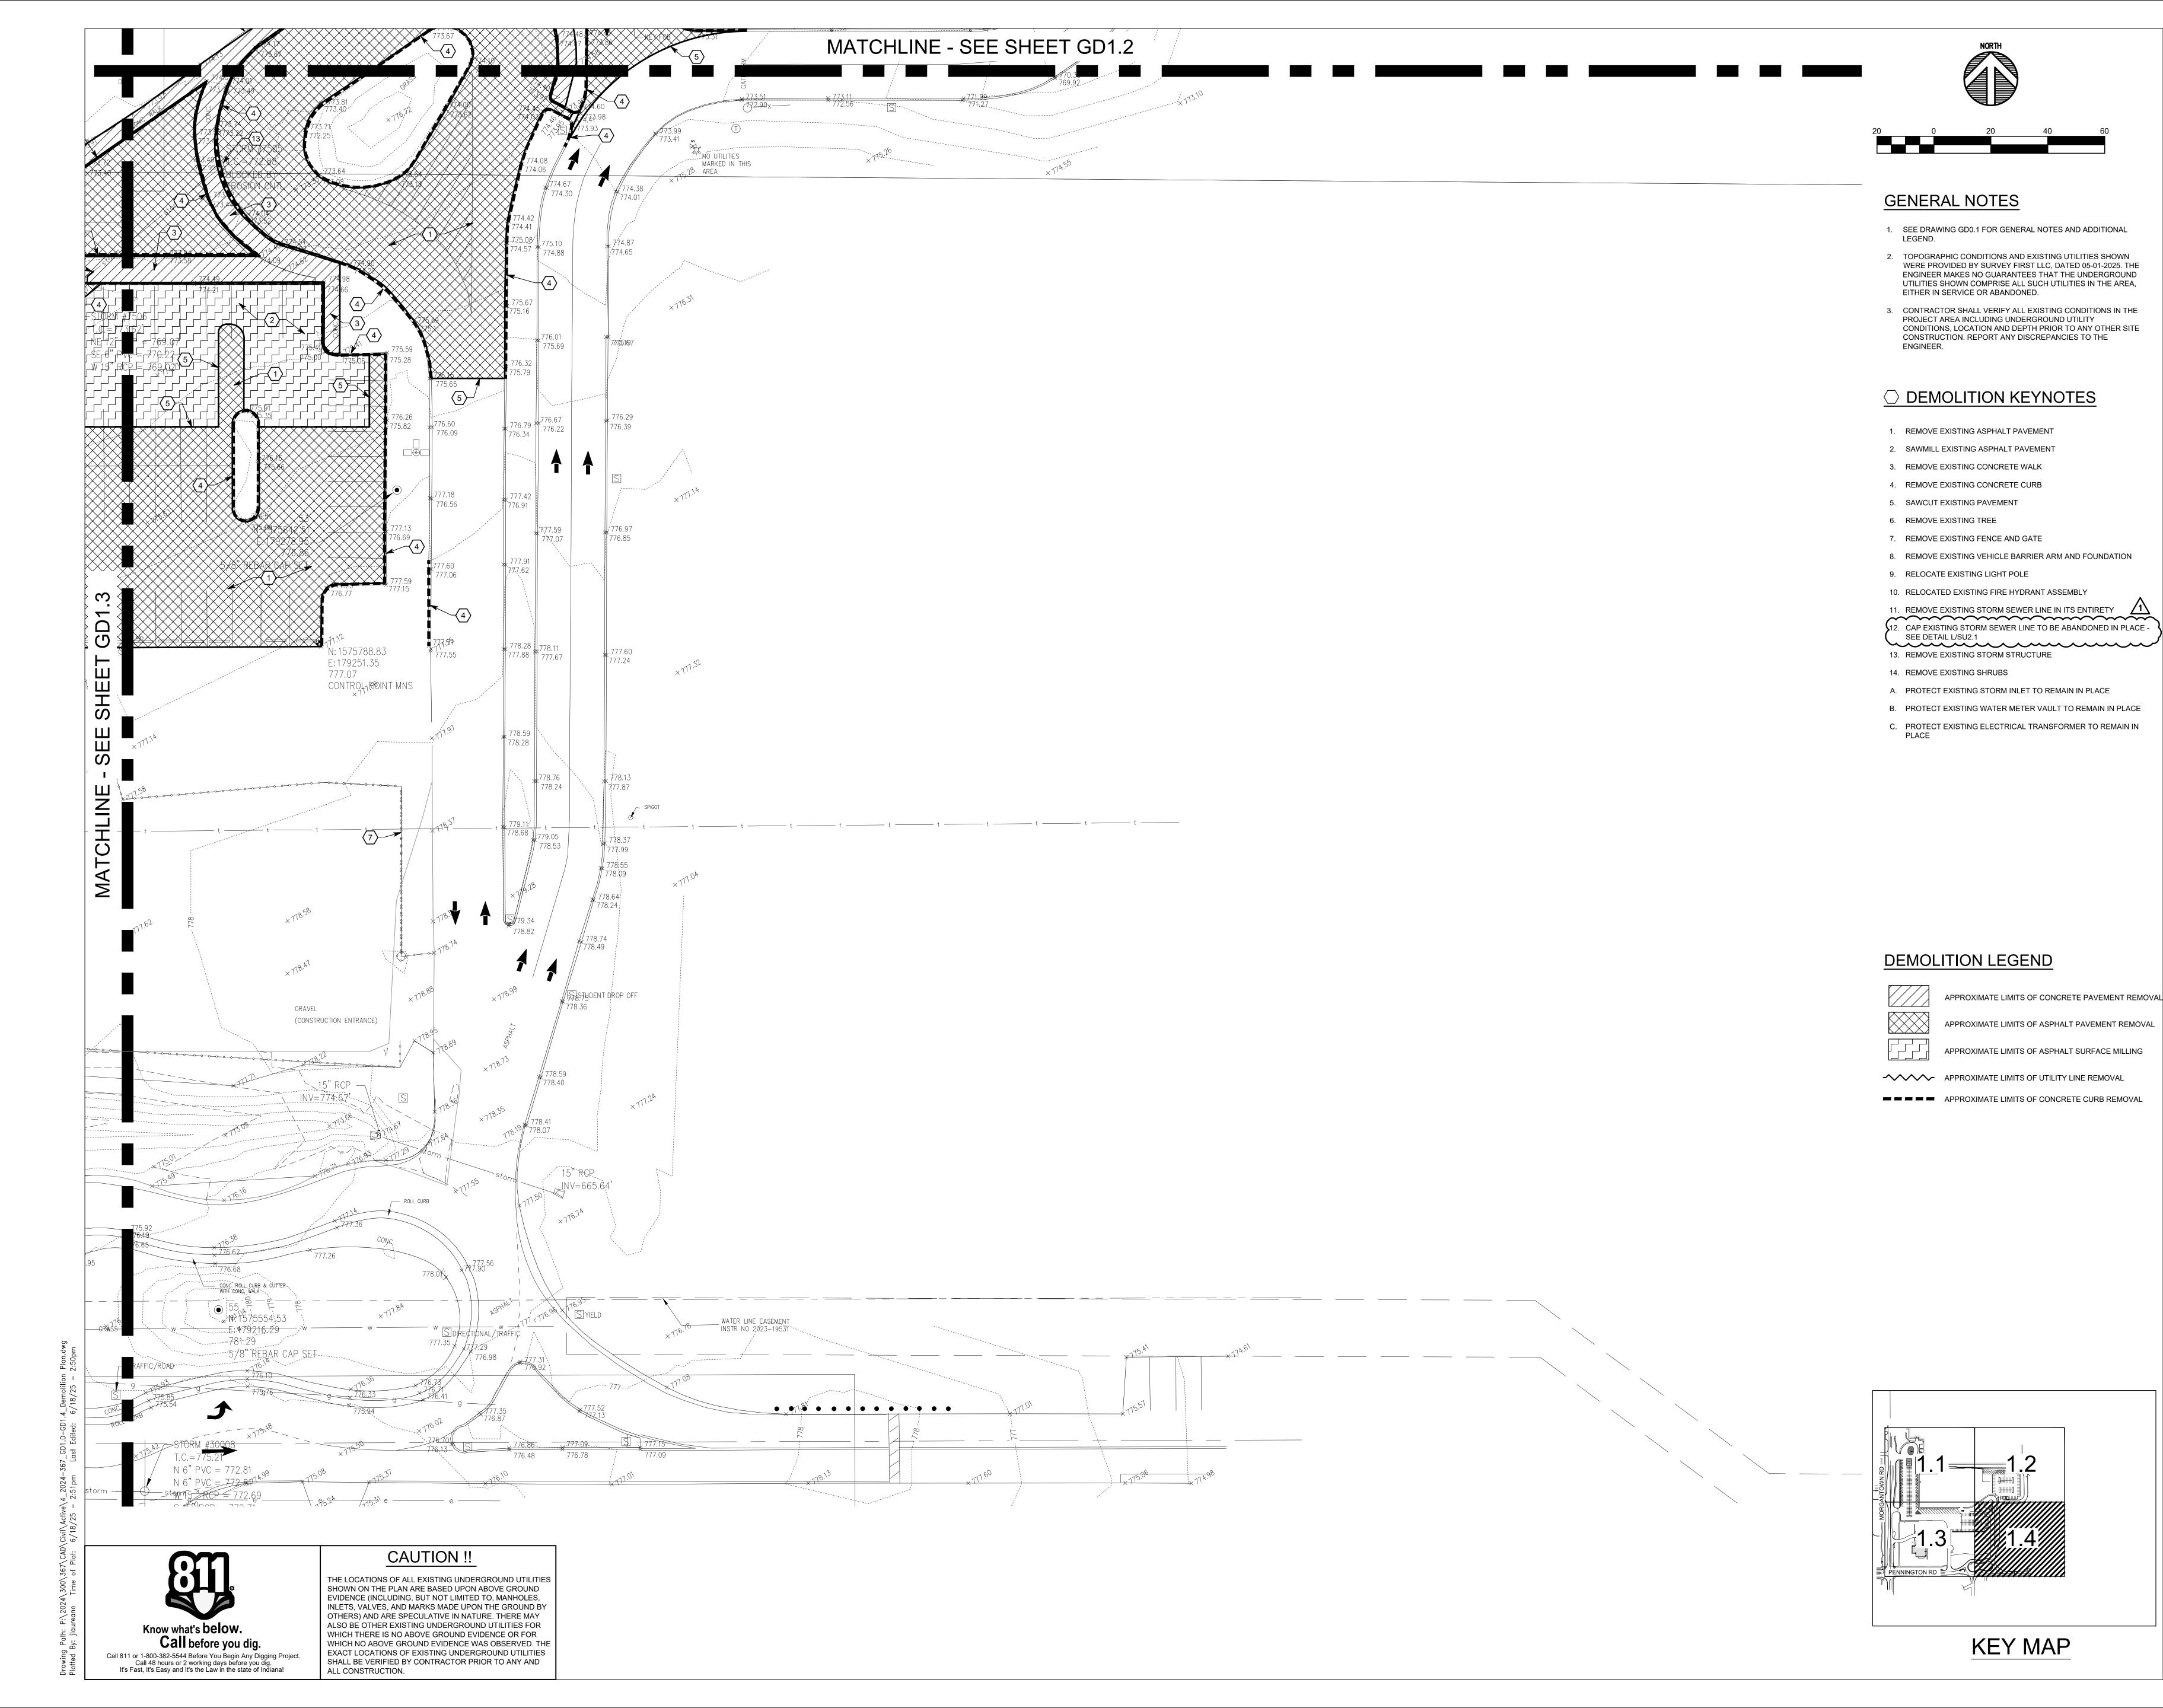

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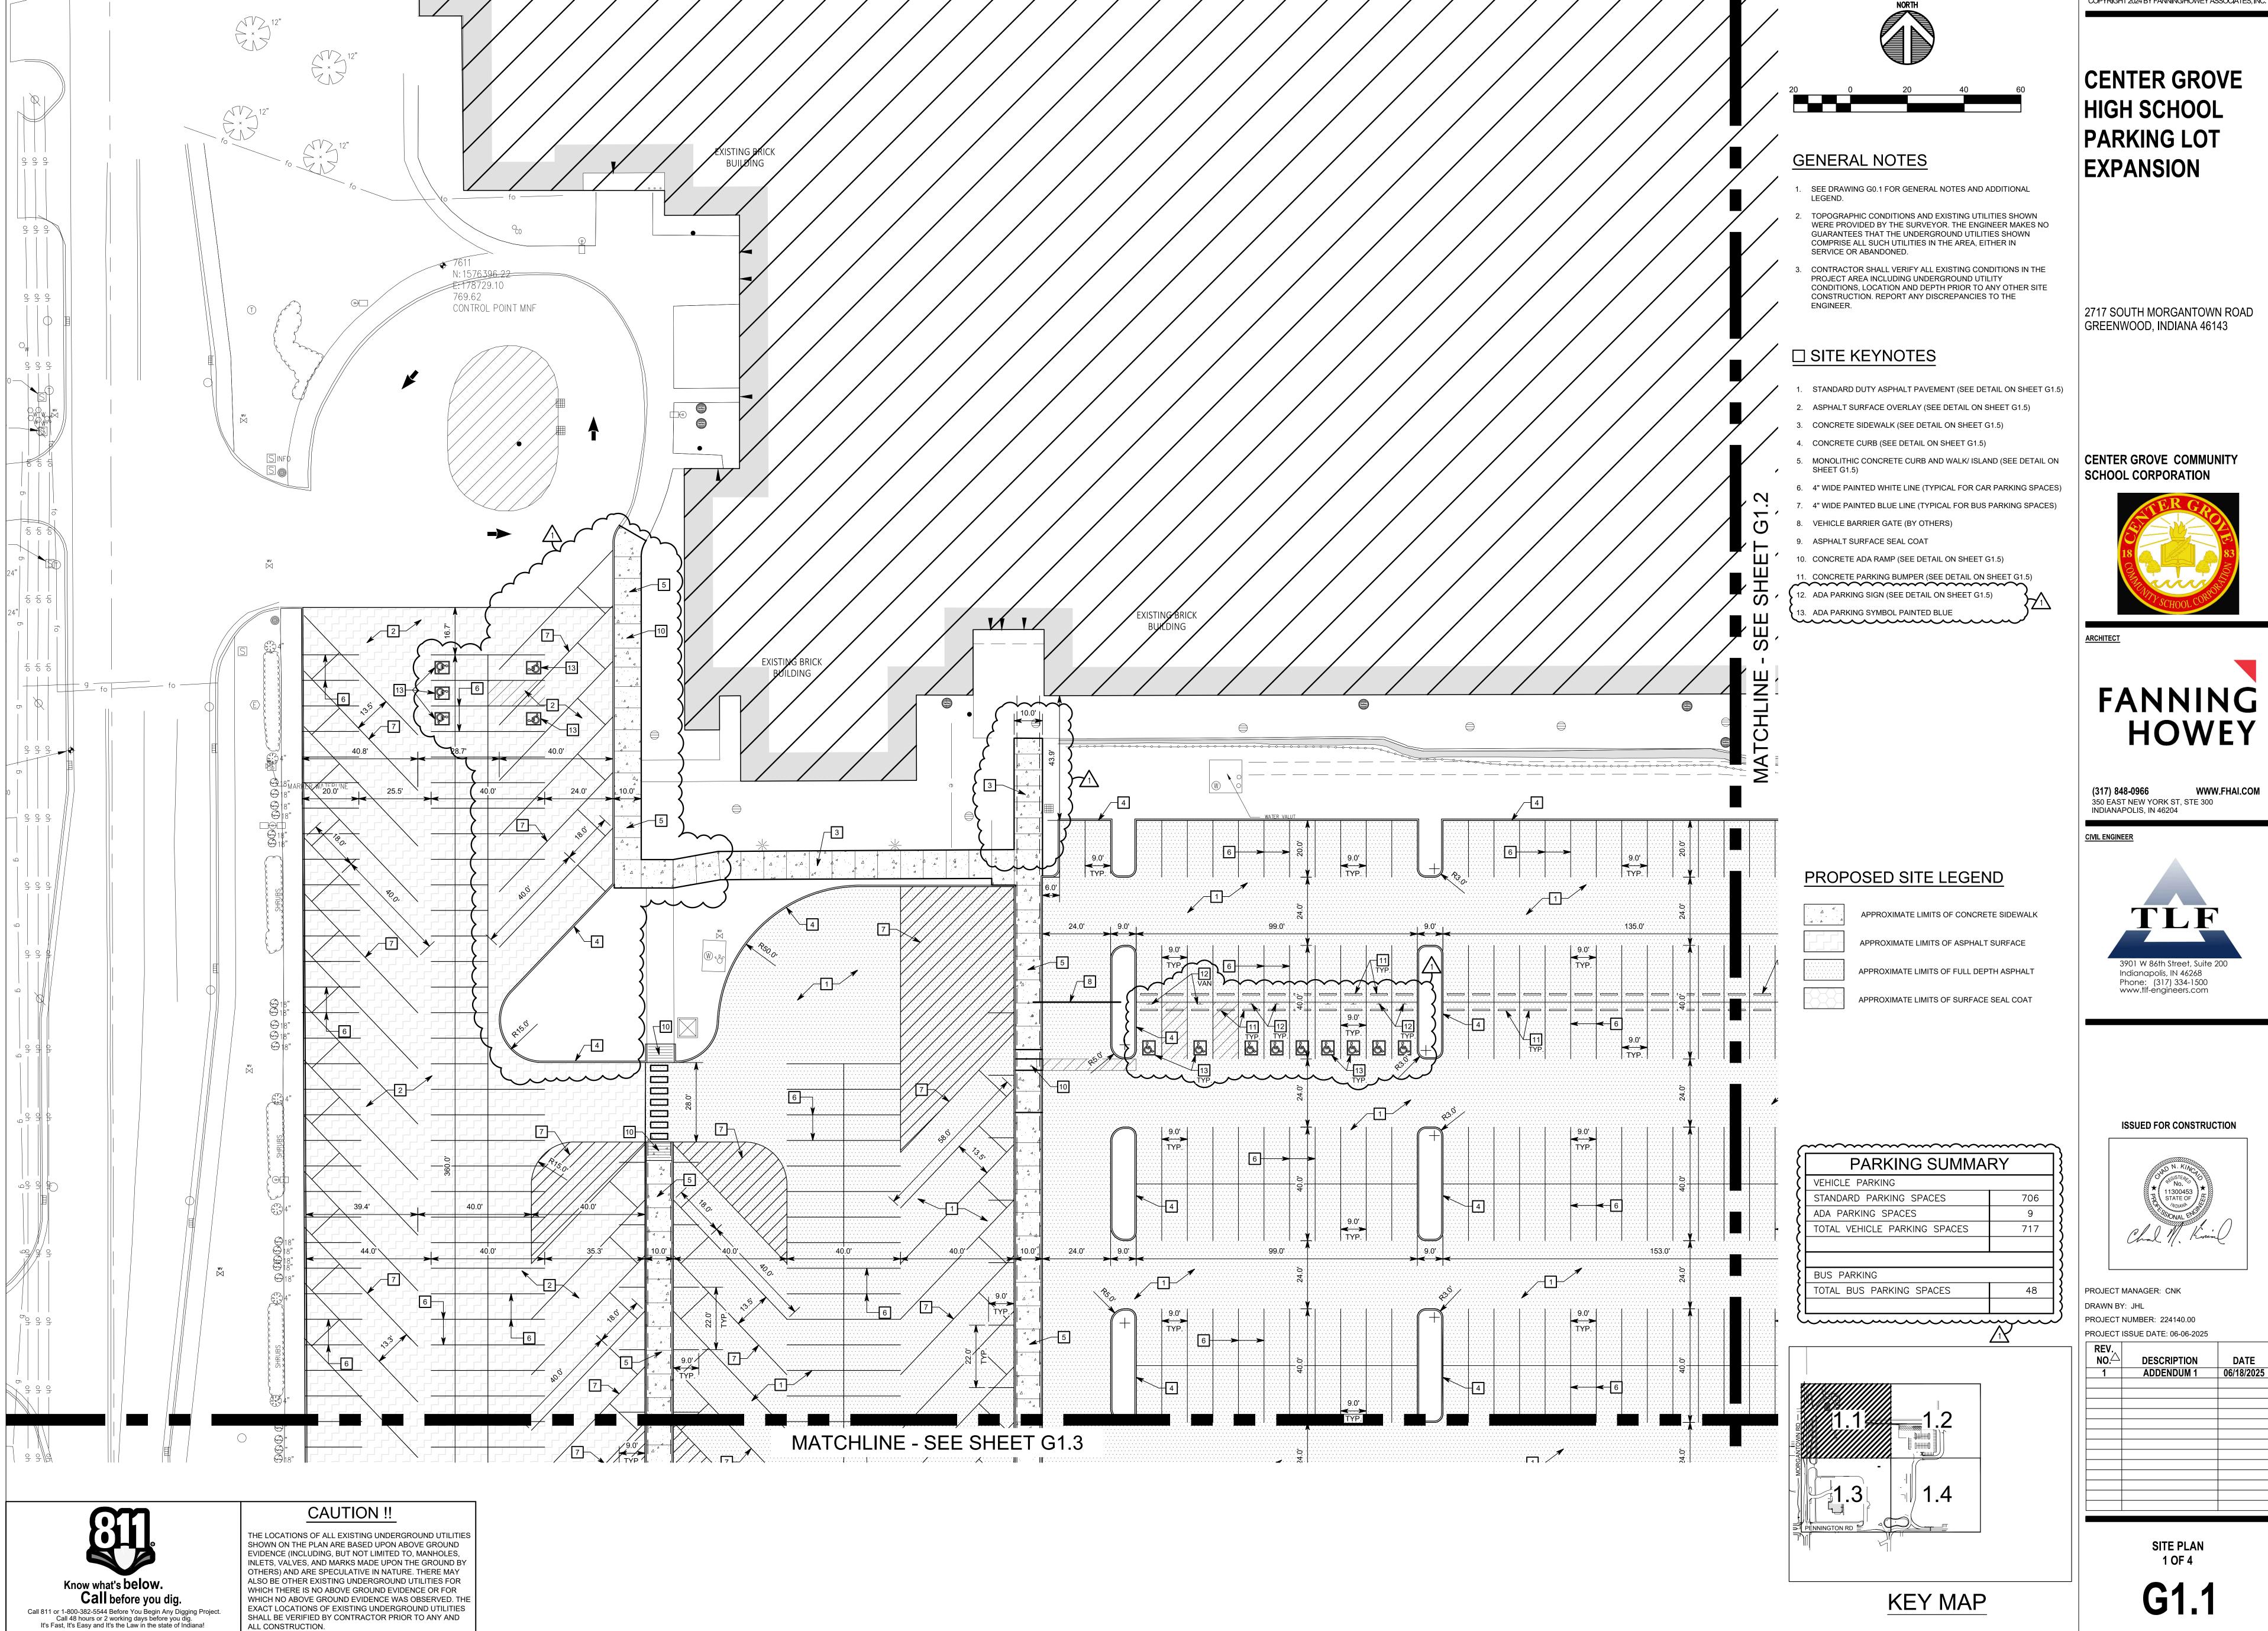
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NO.△	DESCRIPTION	DATE
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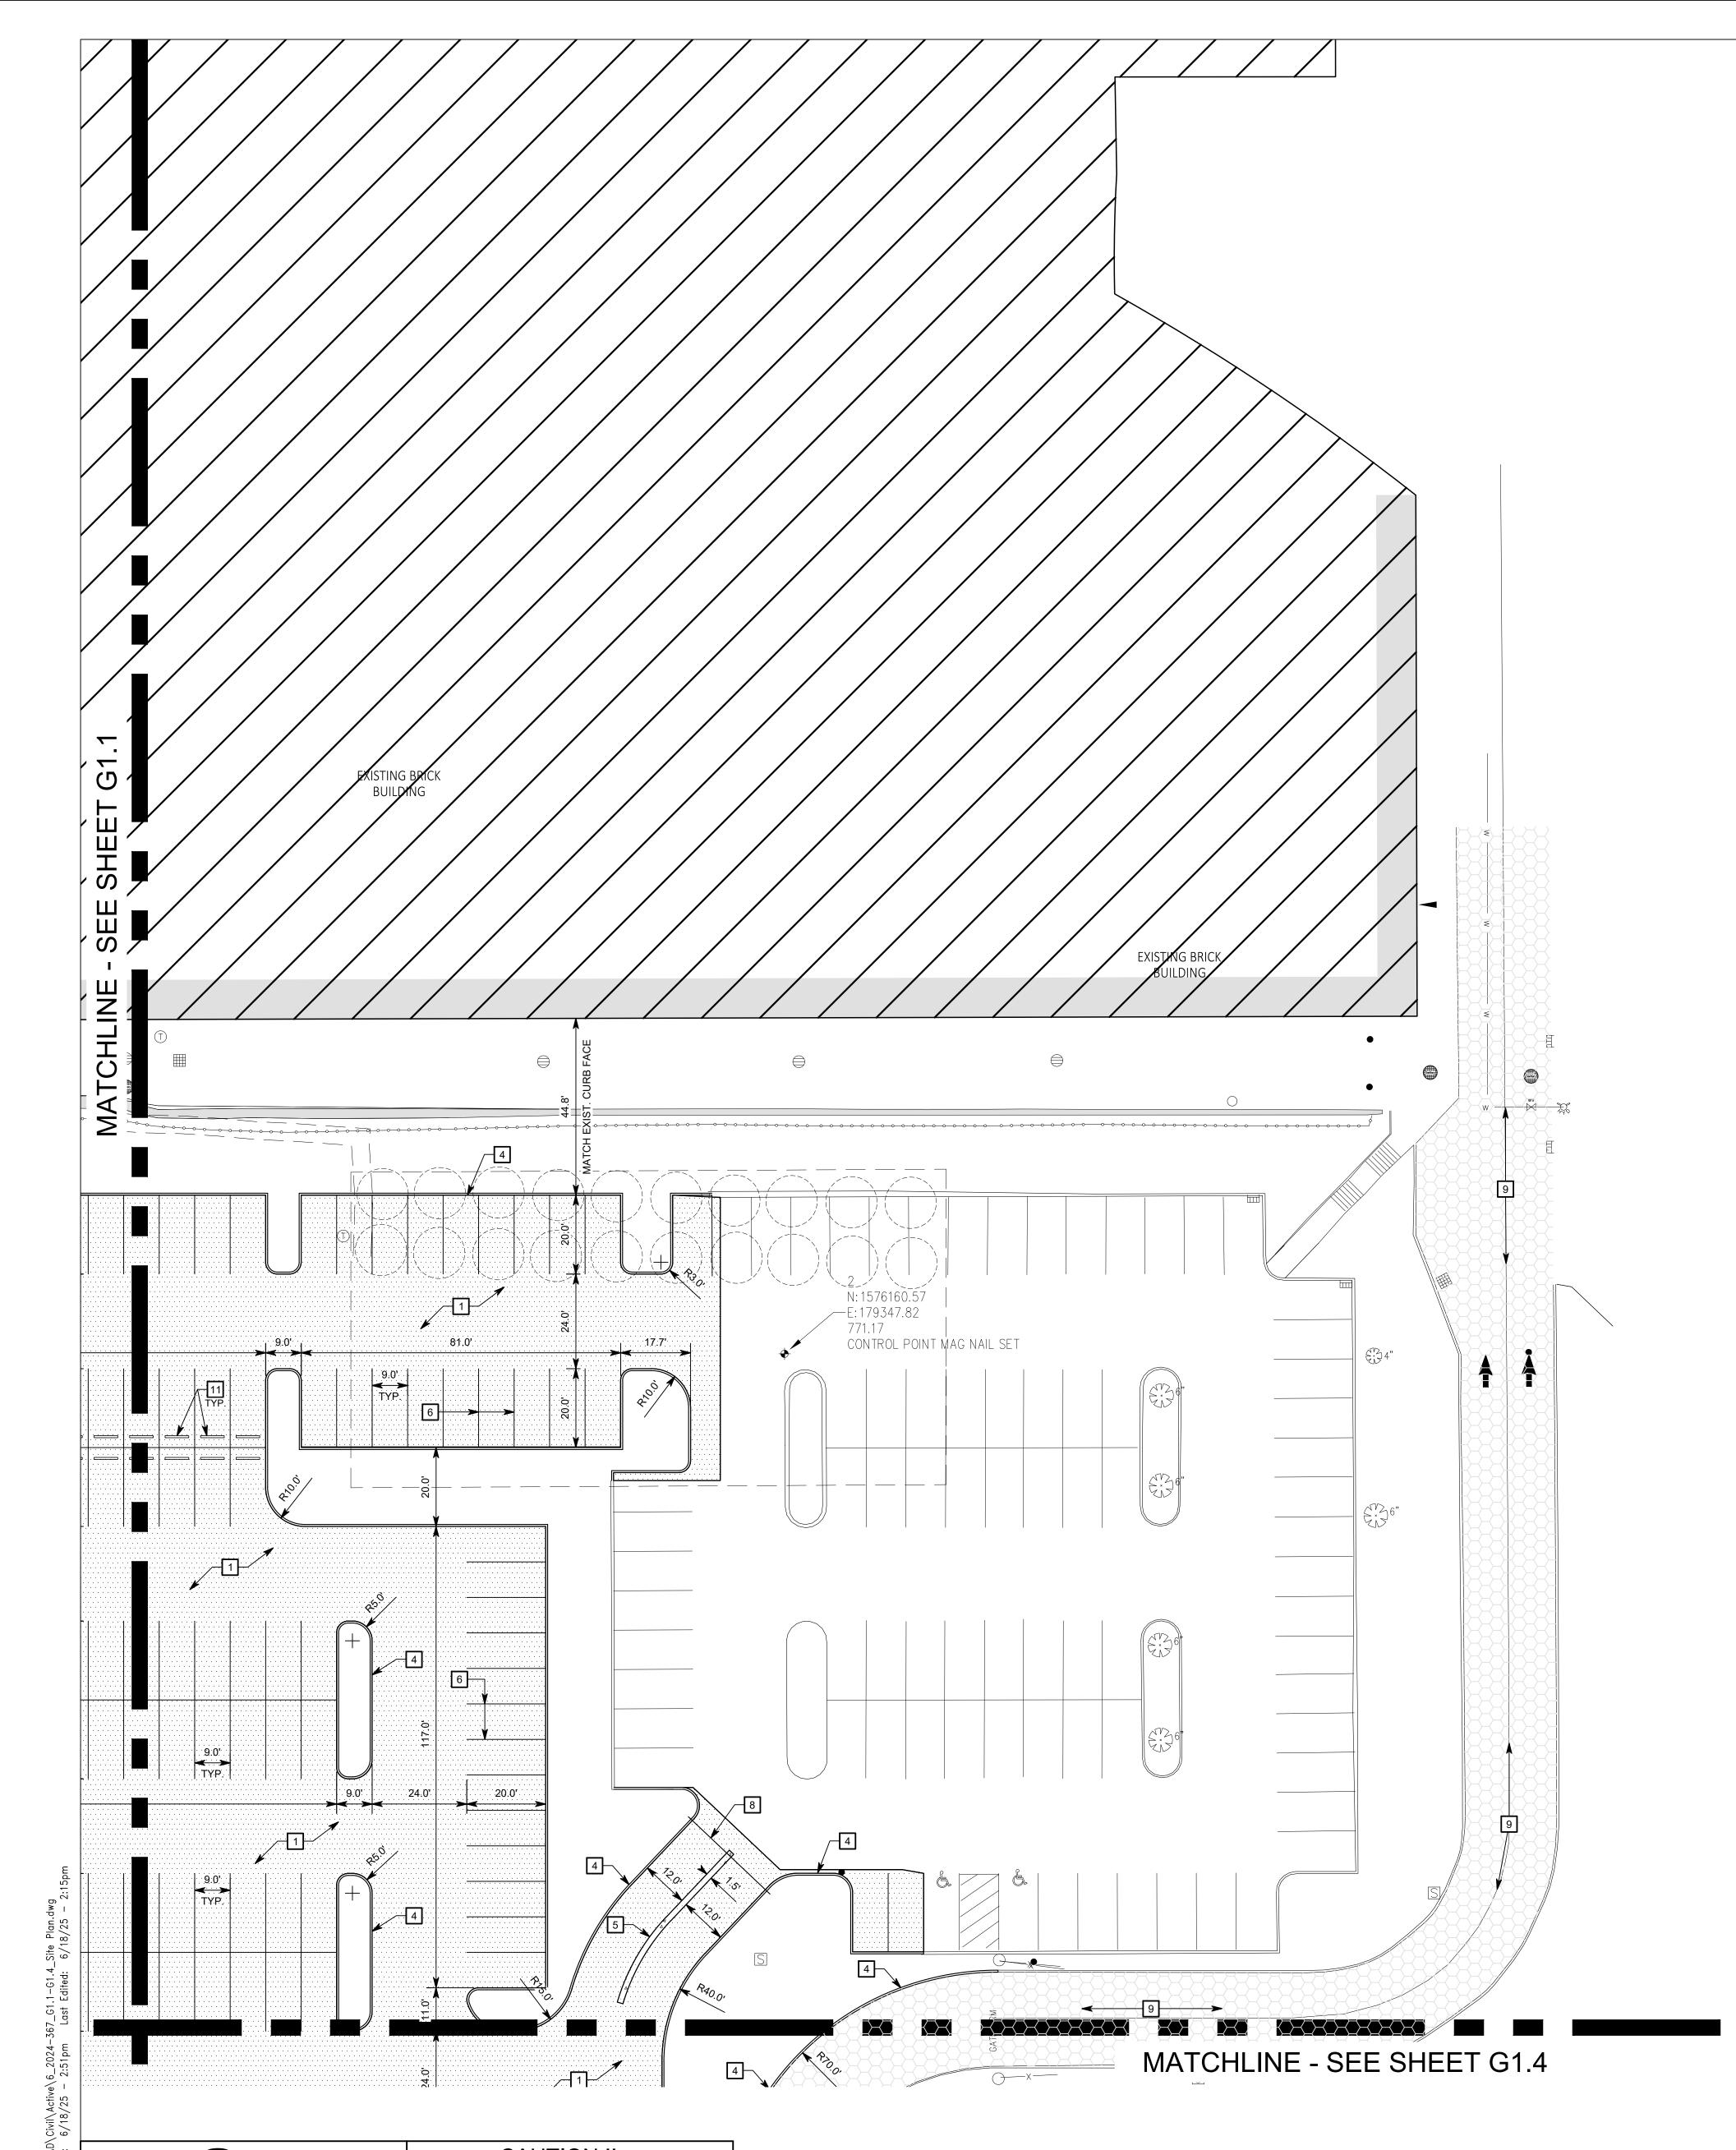
OVERALL SITE PLAN


G1.0



ALL CONSTRUCTION.

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☐ SITE KEYNOTES

- 1. STANDARD DUTY ASPHALT PAVEMENT (SEE DETAIL ON SHEET G1.5)
- 2. ASPHALT SURFACE OVERLAY (SEE DETAIL ON SHEET G1.5)
- 3. CONCRETE SIDEWALK (SEE DETAIL ON SHEET G1.5)
- 4. CONCRETE CURB (SEE DETAIL ON SHEET G1.5) 5. MONOLITHIC CONCRETE CURB AND WALK/ ISLAND (SEE DETAIL ON
- SHEET G1.5) 6. 4" WIDE PAINTED WHITE LINE (TYPICAL FOR CAR PARKING SPACES)
- 7. 4" WIDE PAINTED BLUE LINE (TYPICAL FOR BUS PARKING SPACES)
- 8. VEHICLE BARRIER GATE (BY OTHERS)
- ASPHALT SURFACE SEAL COAT
- 10. CONCRETE ADA RAMP (SEE DETAIL ON SHEET G1.5)
- 11. CONCRETE PARKING BUMPER (SEE DETAIL ON SHEET G1.5) 12. ADA PARKING SIGN (SEE DETAIL ON SHEET G1.5)
- 13. ADA PARKING SYMBOL PAINTED BLUE
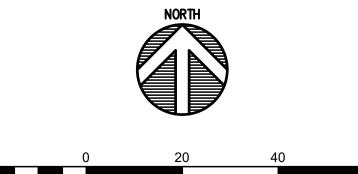
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PROPOSED SITE LEGEND


APPROXIMATE LIMITS OF CONCRETE SIDEWALK APPROXIMATE LIMITS OF ASPHALT SURFACE

APPROXIMATE LIMITS OF FULL DEPTH ASPHALT

APPROXIMATE LIMITS OF SURFACE SEAL COAT




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NO.△	DESCRIPTION	DATE
1	ADDENDUM 1	06/18/2025
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SITE PLAN 2 OF 4

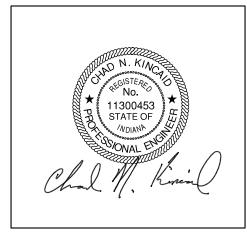

TOTAL BUS PARKING SPACES


1.1 ===	
MORGANI	
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PENNINGTON RD	
1	

KEY MAP

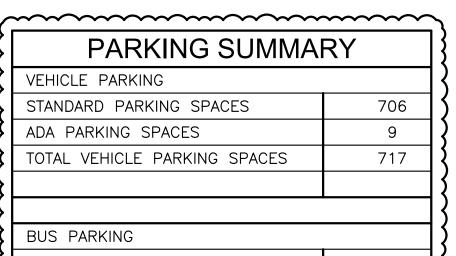
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CENTER GROVE HIGH SCHOOL PARKING LOT EXPANSION

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CENTER GROVE COMMUNITY SCHOOL CORPORATION

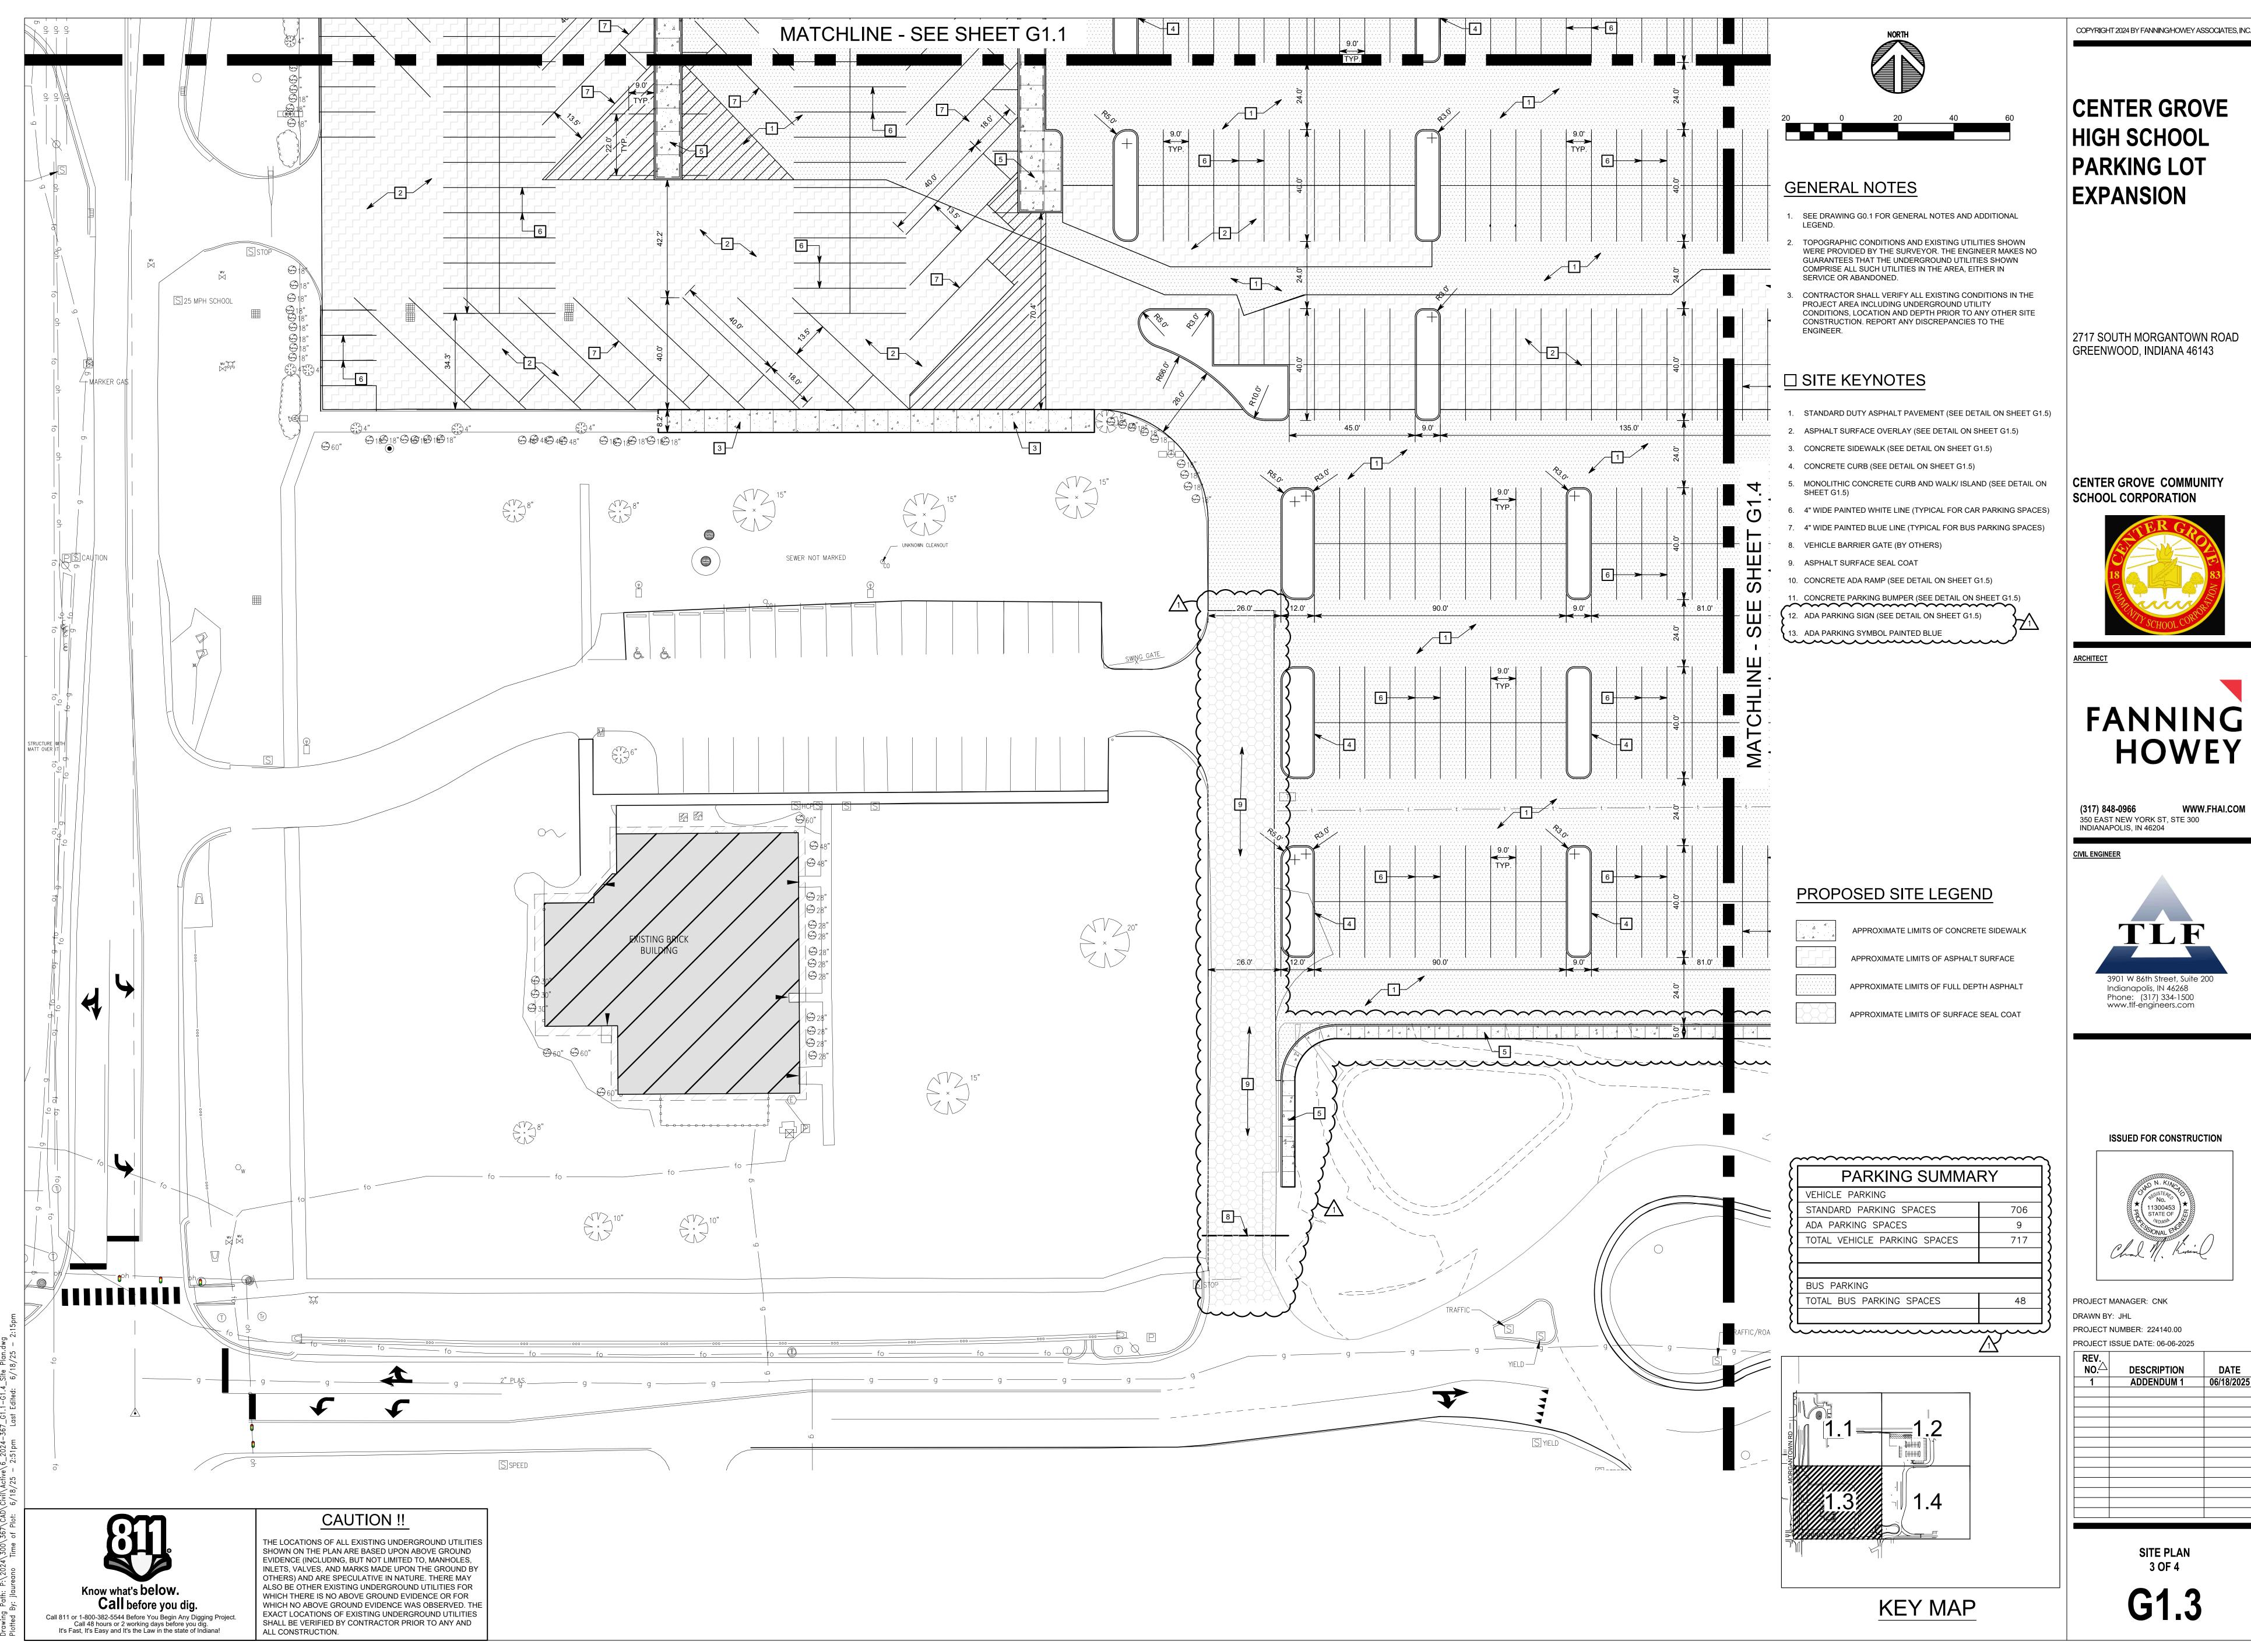


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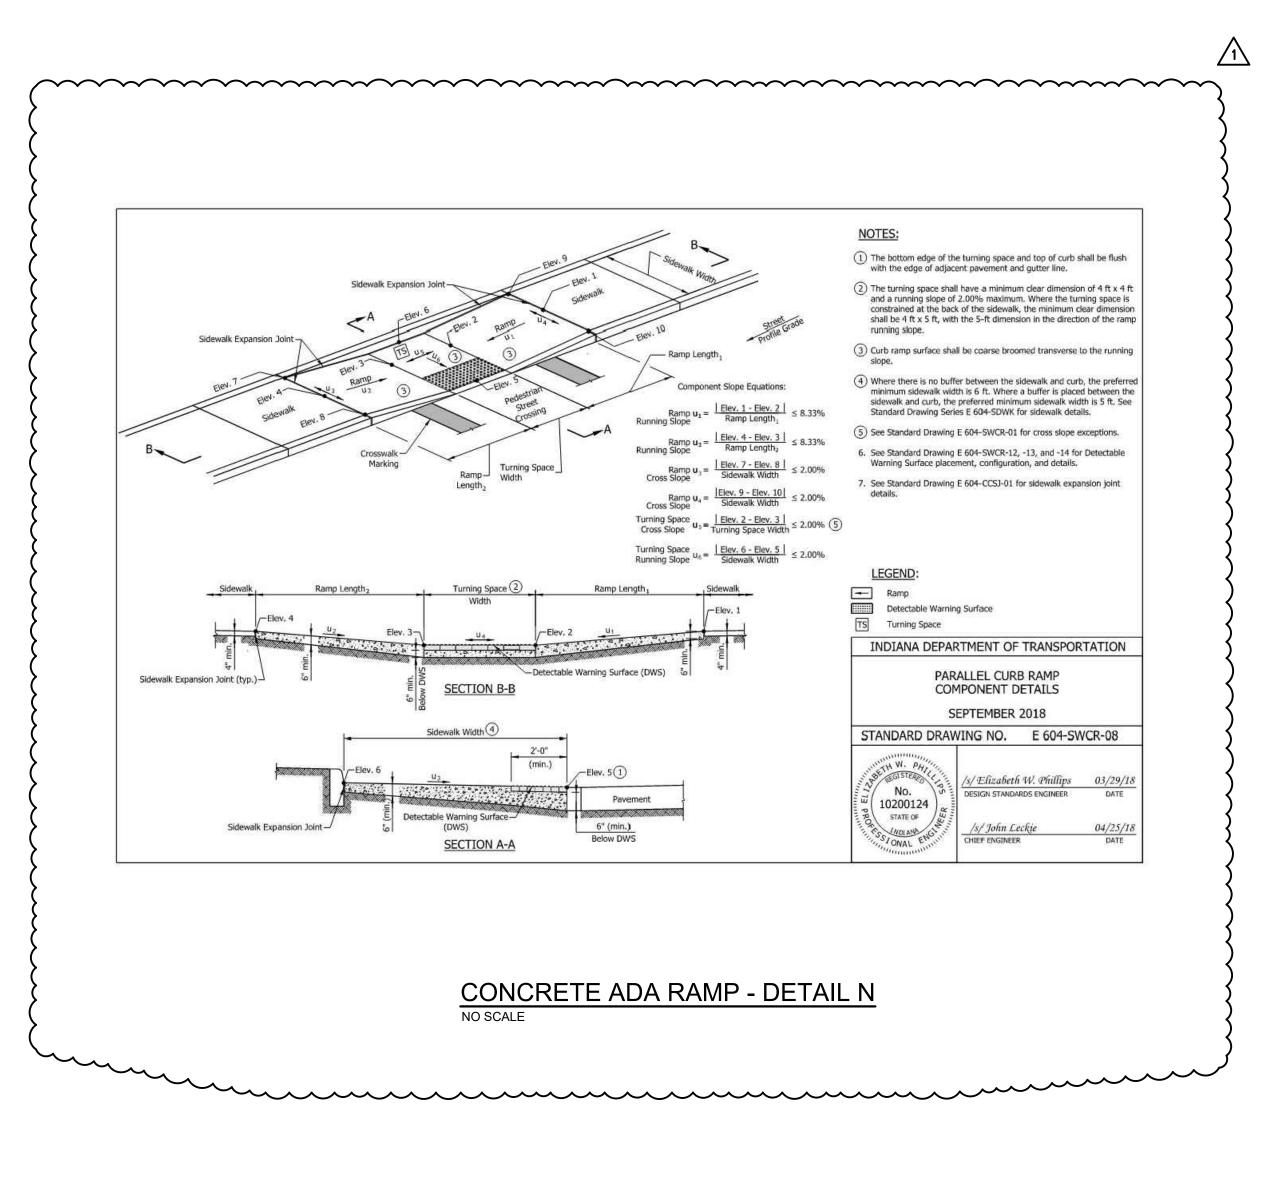



PROJECT MANAGER: CNK PROJECT NUMBER: 224140.00 PROJECT ISSUE DATE: 06-06-2025
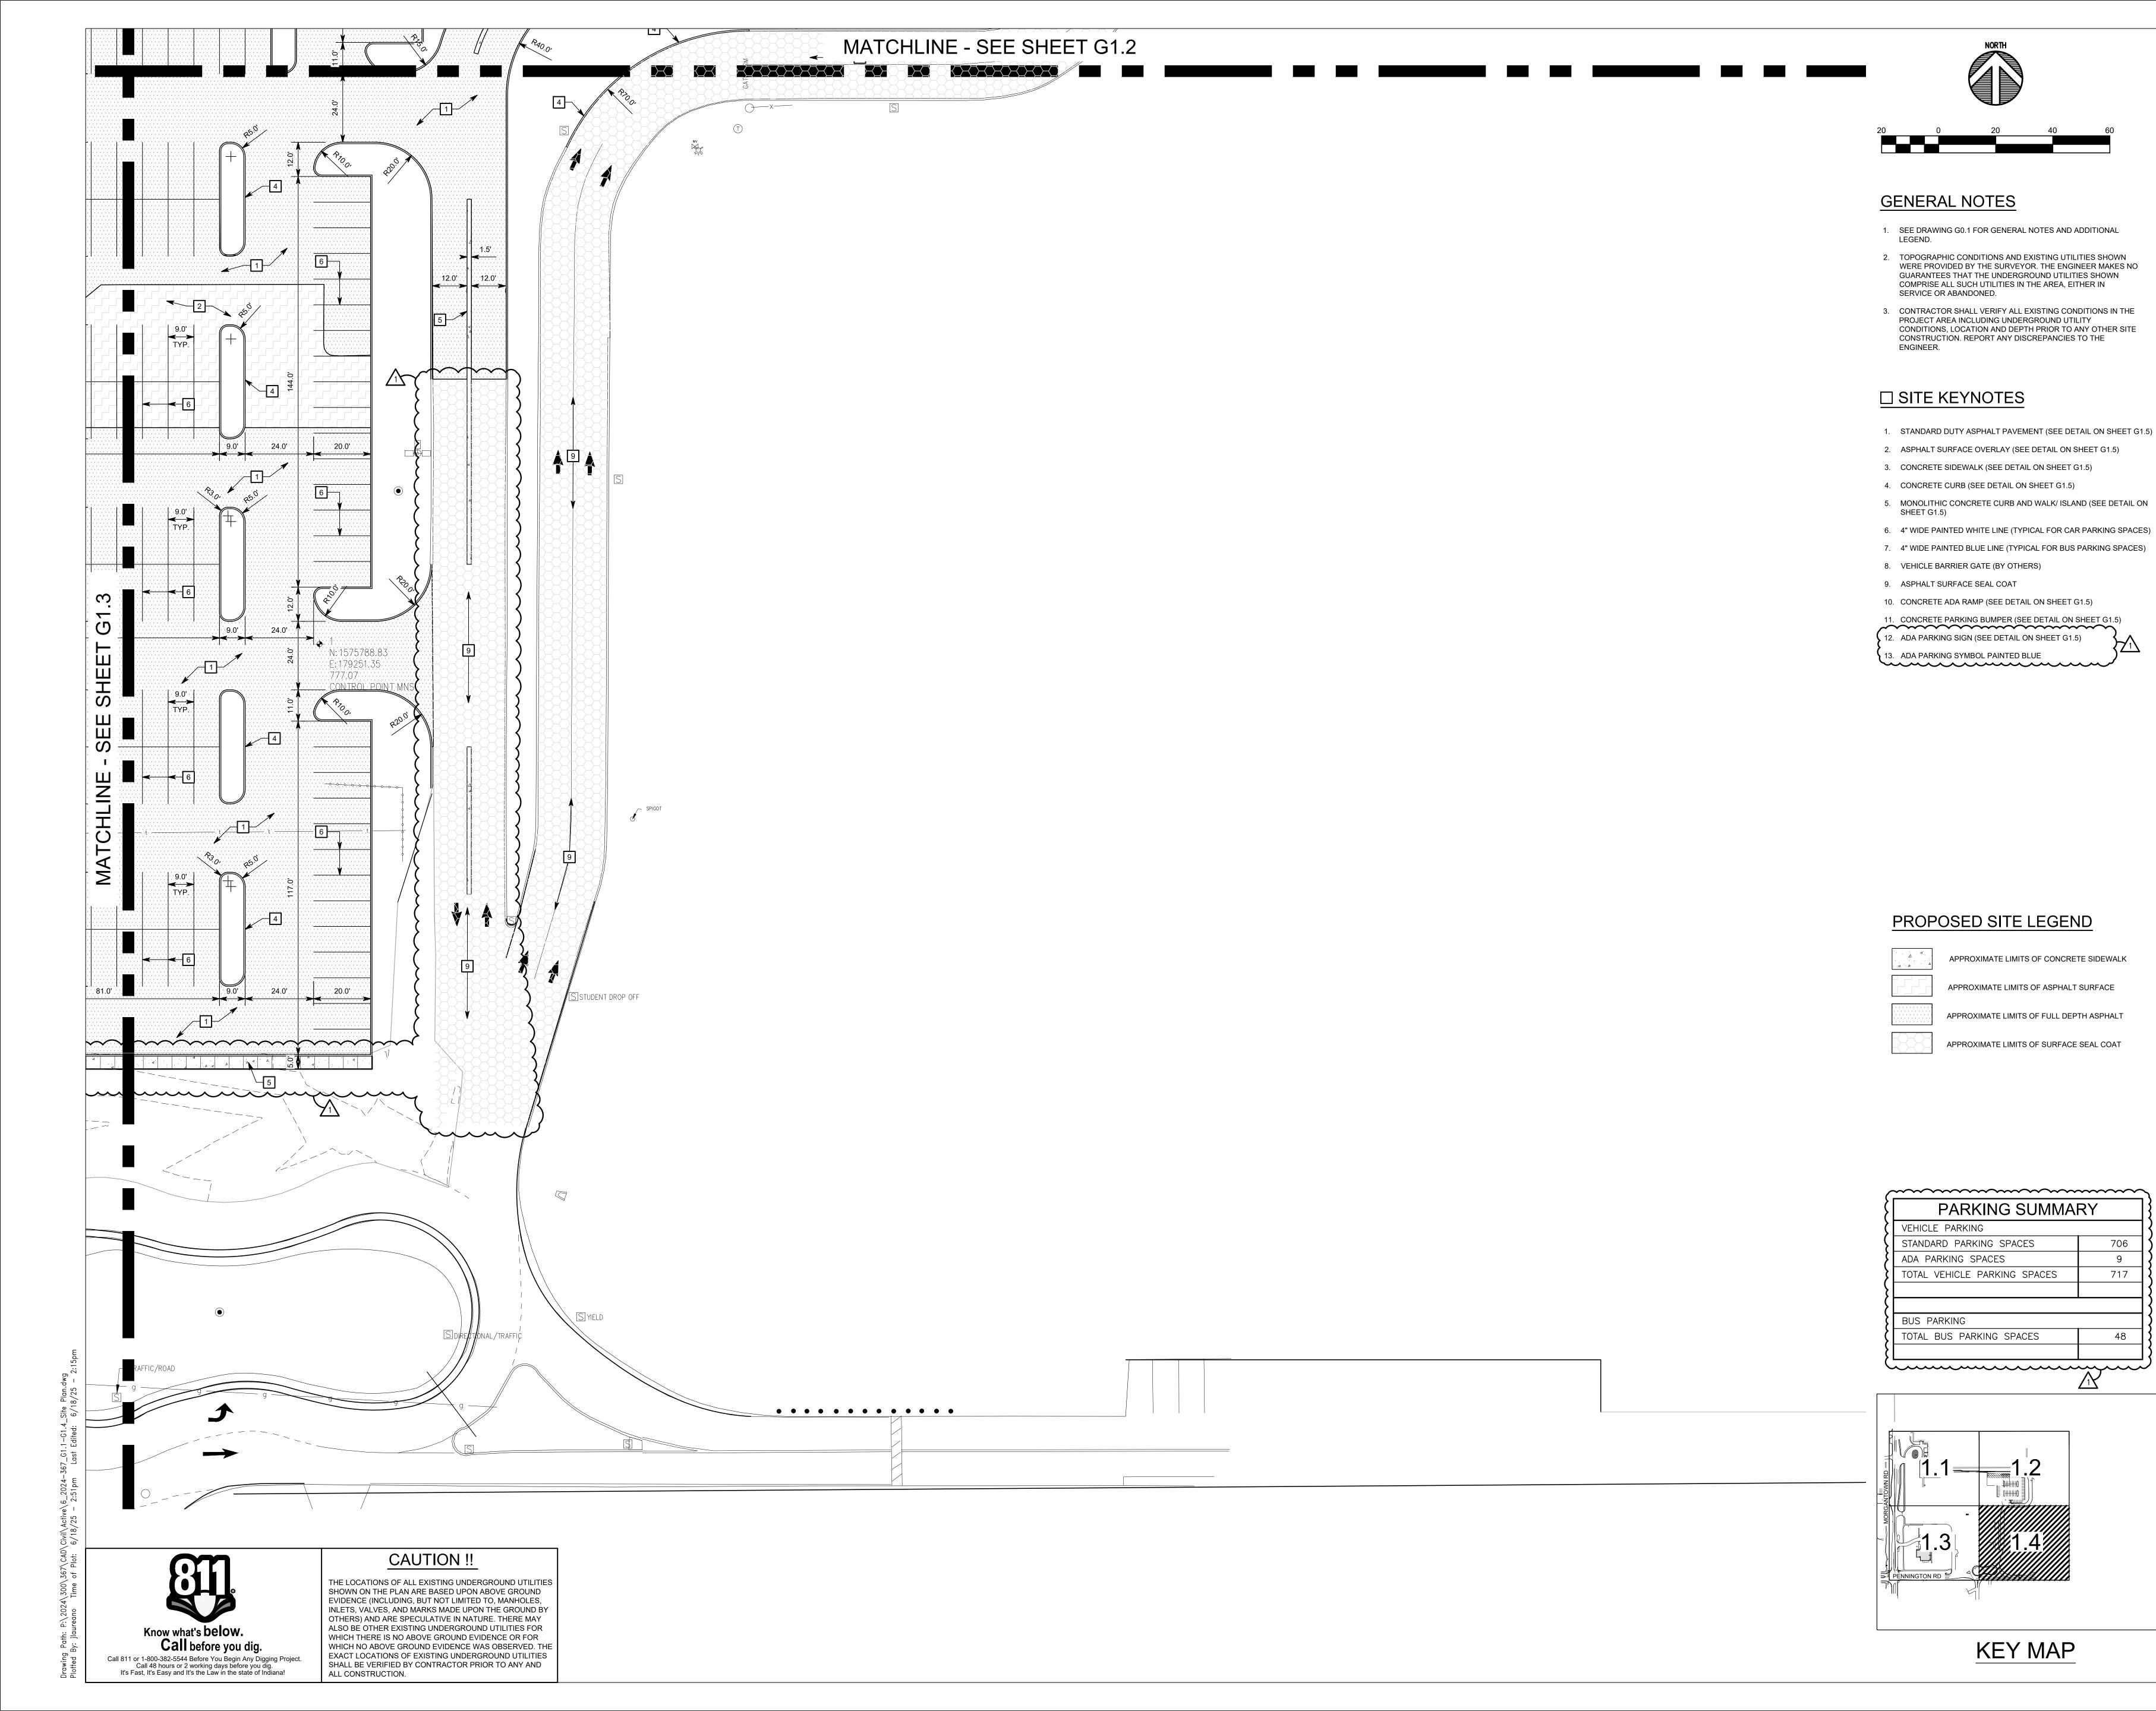
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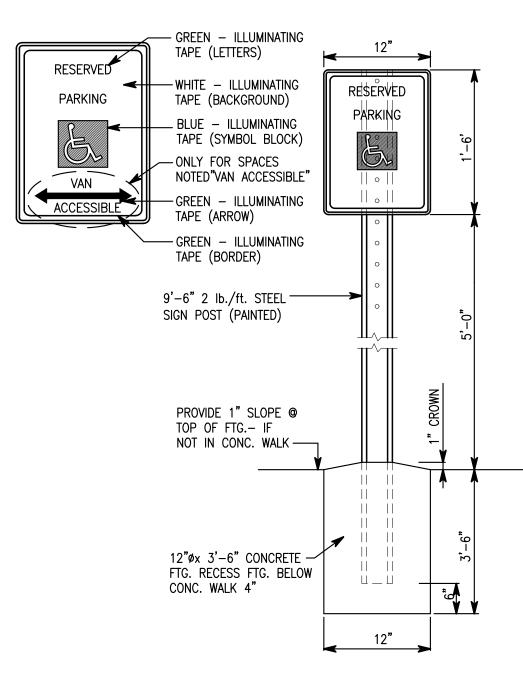
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SITE PLAN 4 OF 4




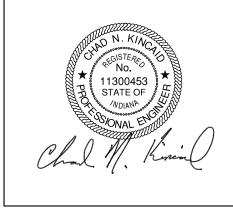



PAINTED HANDICAP SYMBOL - DETAIL K NO SCALE

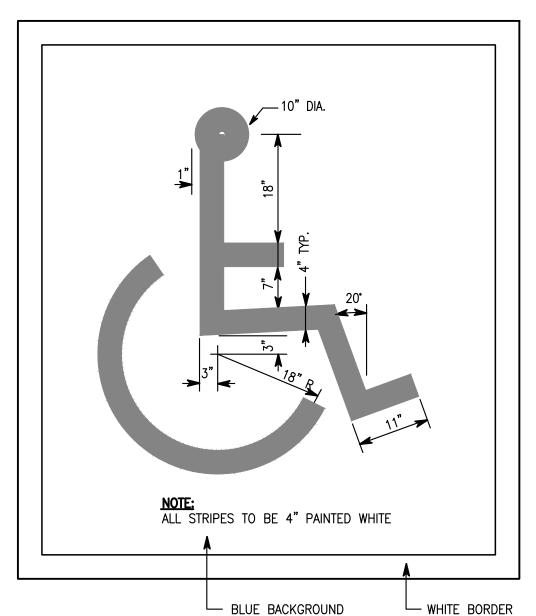


HANDICAP PARKING SIGN - DETAIL L NO SCALE

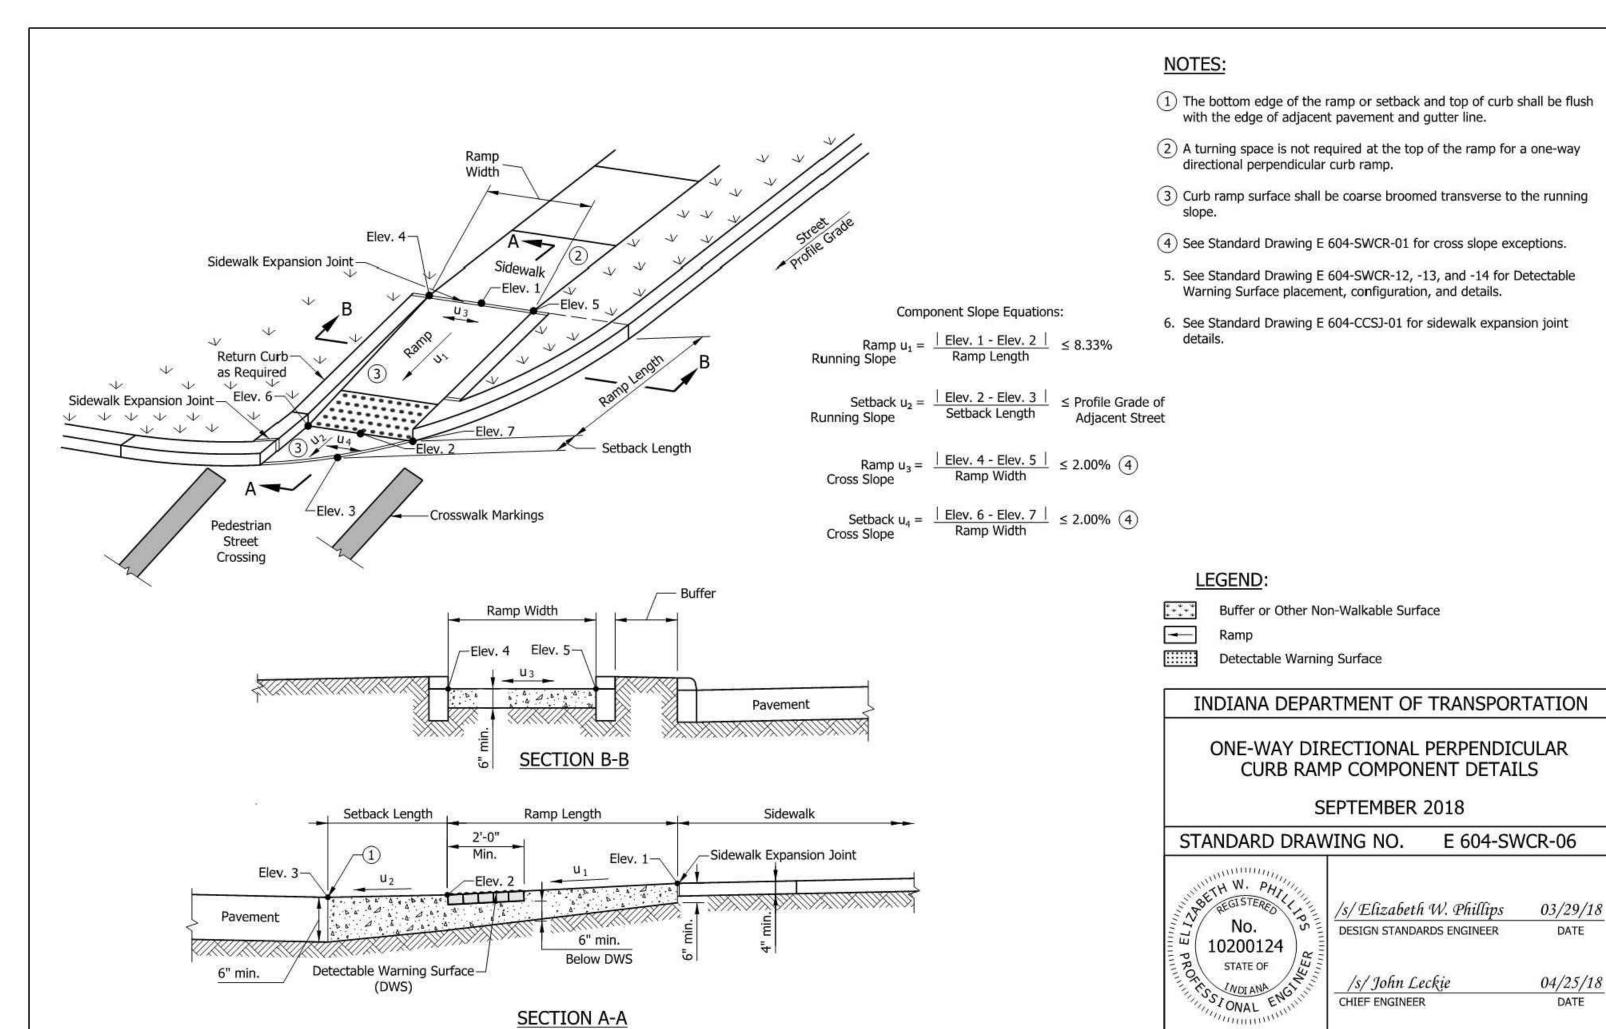


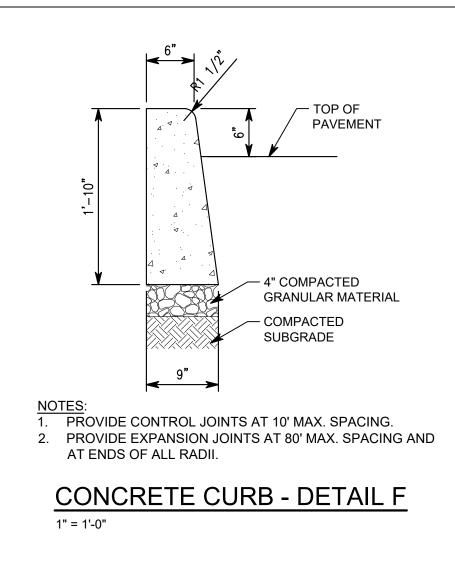

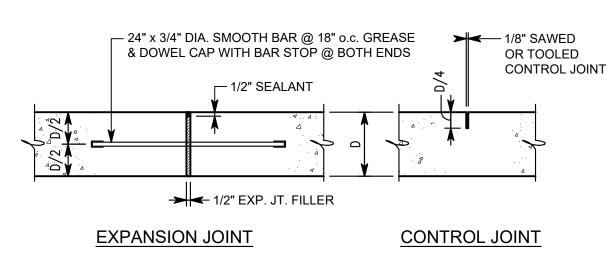


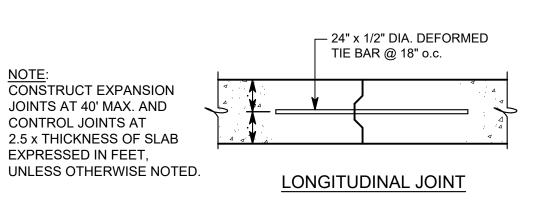


CONCRETE JOINTS - DETAIL G

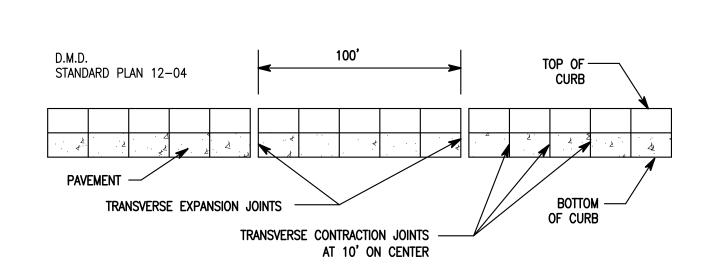


CURB JOINT - DETAIL H

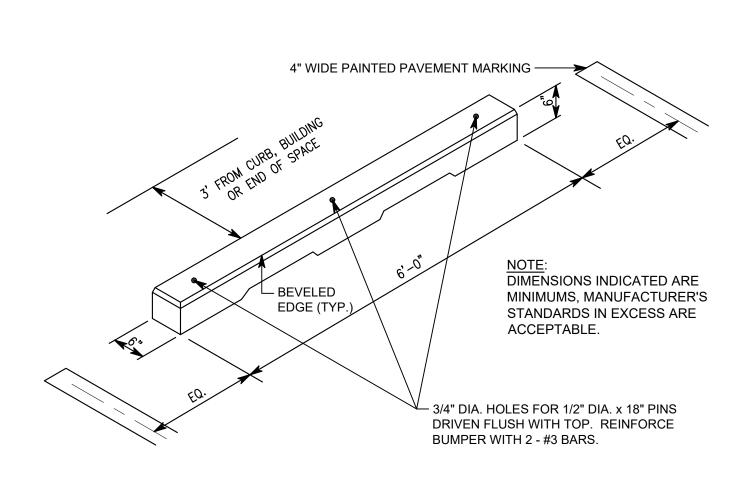

PARKING BUMPER - DETAIL J NO SCALE

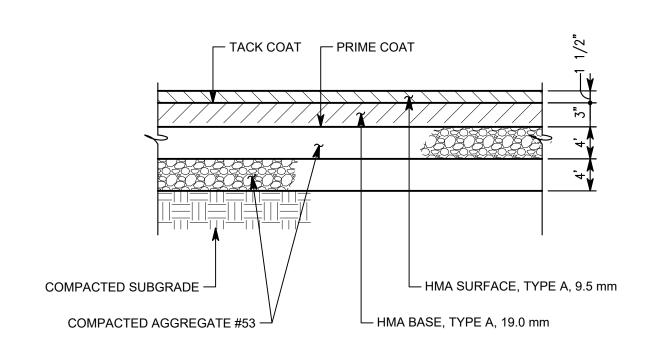


STANDARD DUTY ASPHALT PAVEMENT - DETAIL A

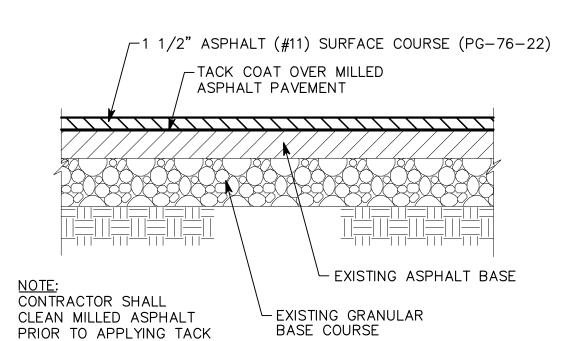


ASPHALT SURFACE OVERLAY - DETAIL B $1 \ 1/2" = 1'-0"$

COAT IF NECESSARY.

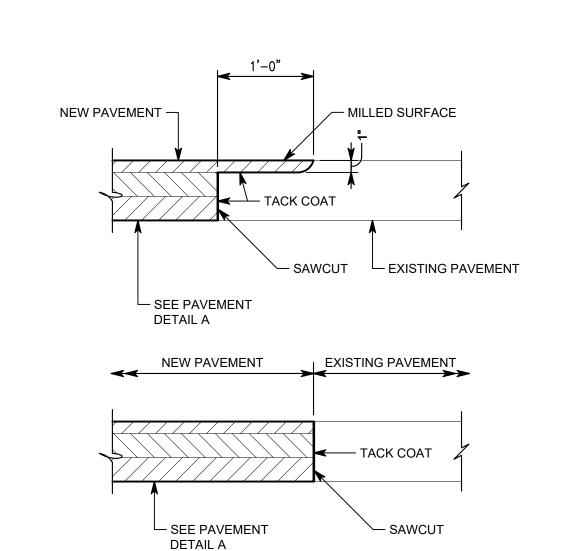


PAVEMENT INTERFACE - DETAIL C

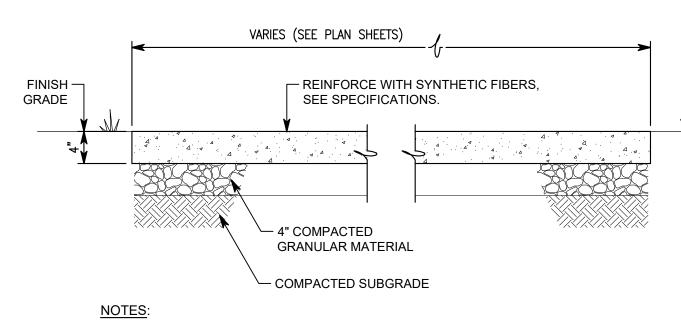


NOTES:
1. PROVIDE CONTROL JOINTS AT 6' MAX. SPACING; PROVIDE EXPANSION JOINTS AT 48' MAX. SPACING. 2. PROVIDE EXPANSION JOINT WHERE SIDEWALK ABUTS BUILDING OR WALLS, AT INTERSECTION WITH ANOTHER SIDEWALK, AND AT OTHER LOCATIONS

INDICATED ON THE DRAWINGS. 3. CONTROL JOINTS AND EDGES OF SIDEWALK SHALL BE HAND-TOOLED AFTER EACH FINISHING OPERATION.

CONCRETE SIDEWALK WITH FIBER - DETAIL D 1" = 1'-0"

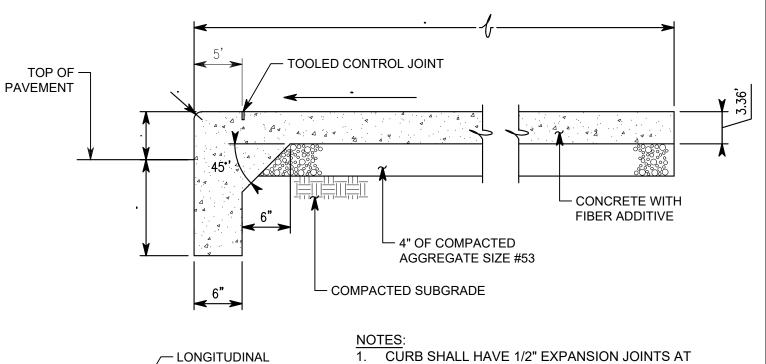

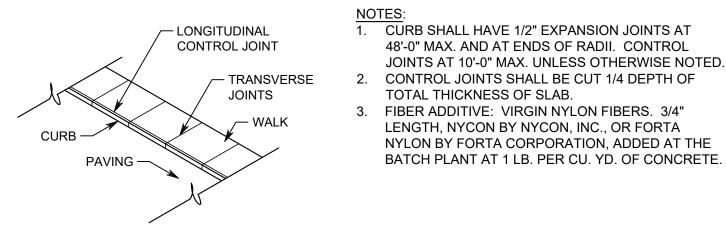

48'-0" MAX. AND AT ENDS OF RADII. CONTROL JOINTS AT 10'-0" MAX. UNLESS OTHERWISE NOTED. 2. CONTROL JOINTS SHALL BE CUT 1/4 DEPTH OF TOTAL THICKNESS OF SLAB. 3. FIBER ADDITIVE: VIRGIN NYLON FIBERS. 3/4" LENGTH, NYCON BY NYCON, INC., OR FORTA


MONOLITHIC CURB AND WALK - DETAIL E

CENTER GROVE HIGH SCHOOL **PARKING LOT EXPANSION**

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2717 SOUTH MORGANTOWN ROAD GREENWOOD, INDIANA 46143

CENTER GROVE COMMUNITY SCHOOL CORPORATION

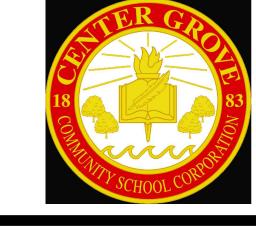


FANNING HOWEY

WWW.FHAI.COM (317) 848-0966 350 EAST NEW YORK ST, STE 300 INDIANAPOLIS, IN 46204

CIVIL ENGINEER



ISSUED FOR CONSTRUCTION

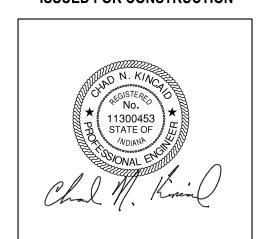


PROJECT MANAGER: CNK DRAWN BY: JHL PROJECT NUMBER: 224140.00 PROJECT ISSUE DATE: 06-06-2025

REV. NO.	DESCRIPTION	DATE
1	ADDENDUM 1	06/18/2025

SITE DETAILS

G1.5

CONCRETE ADA RAMP - DETAIL M

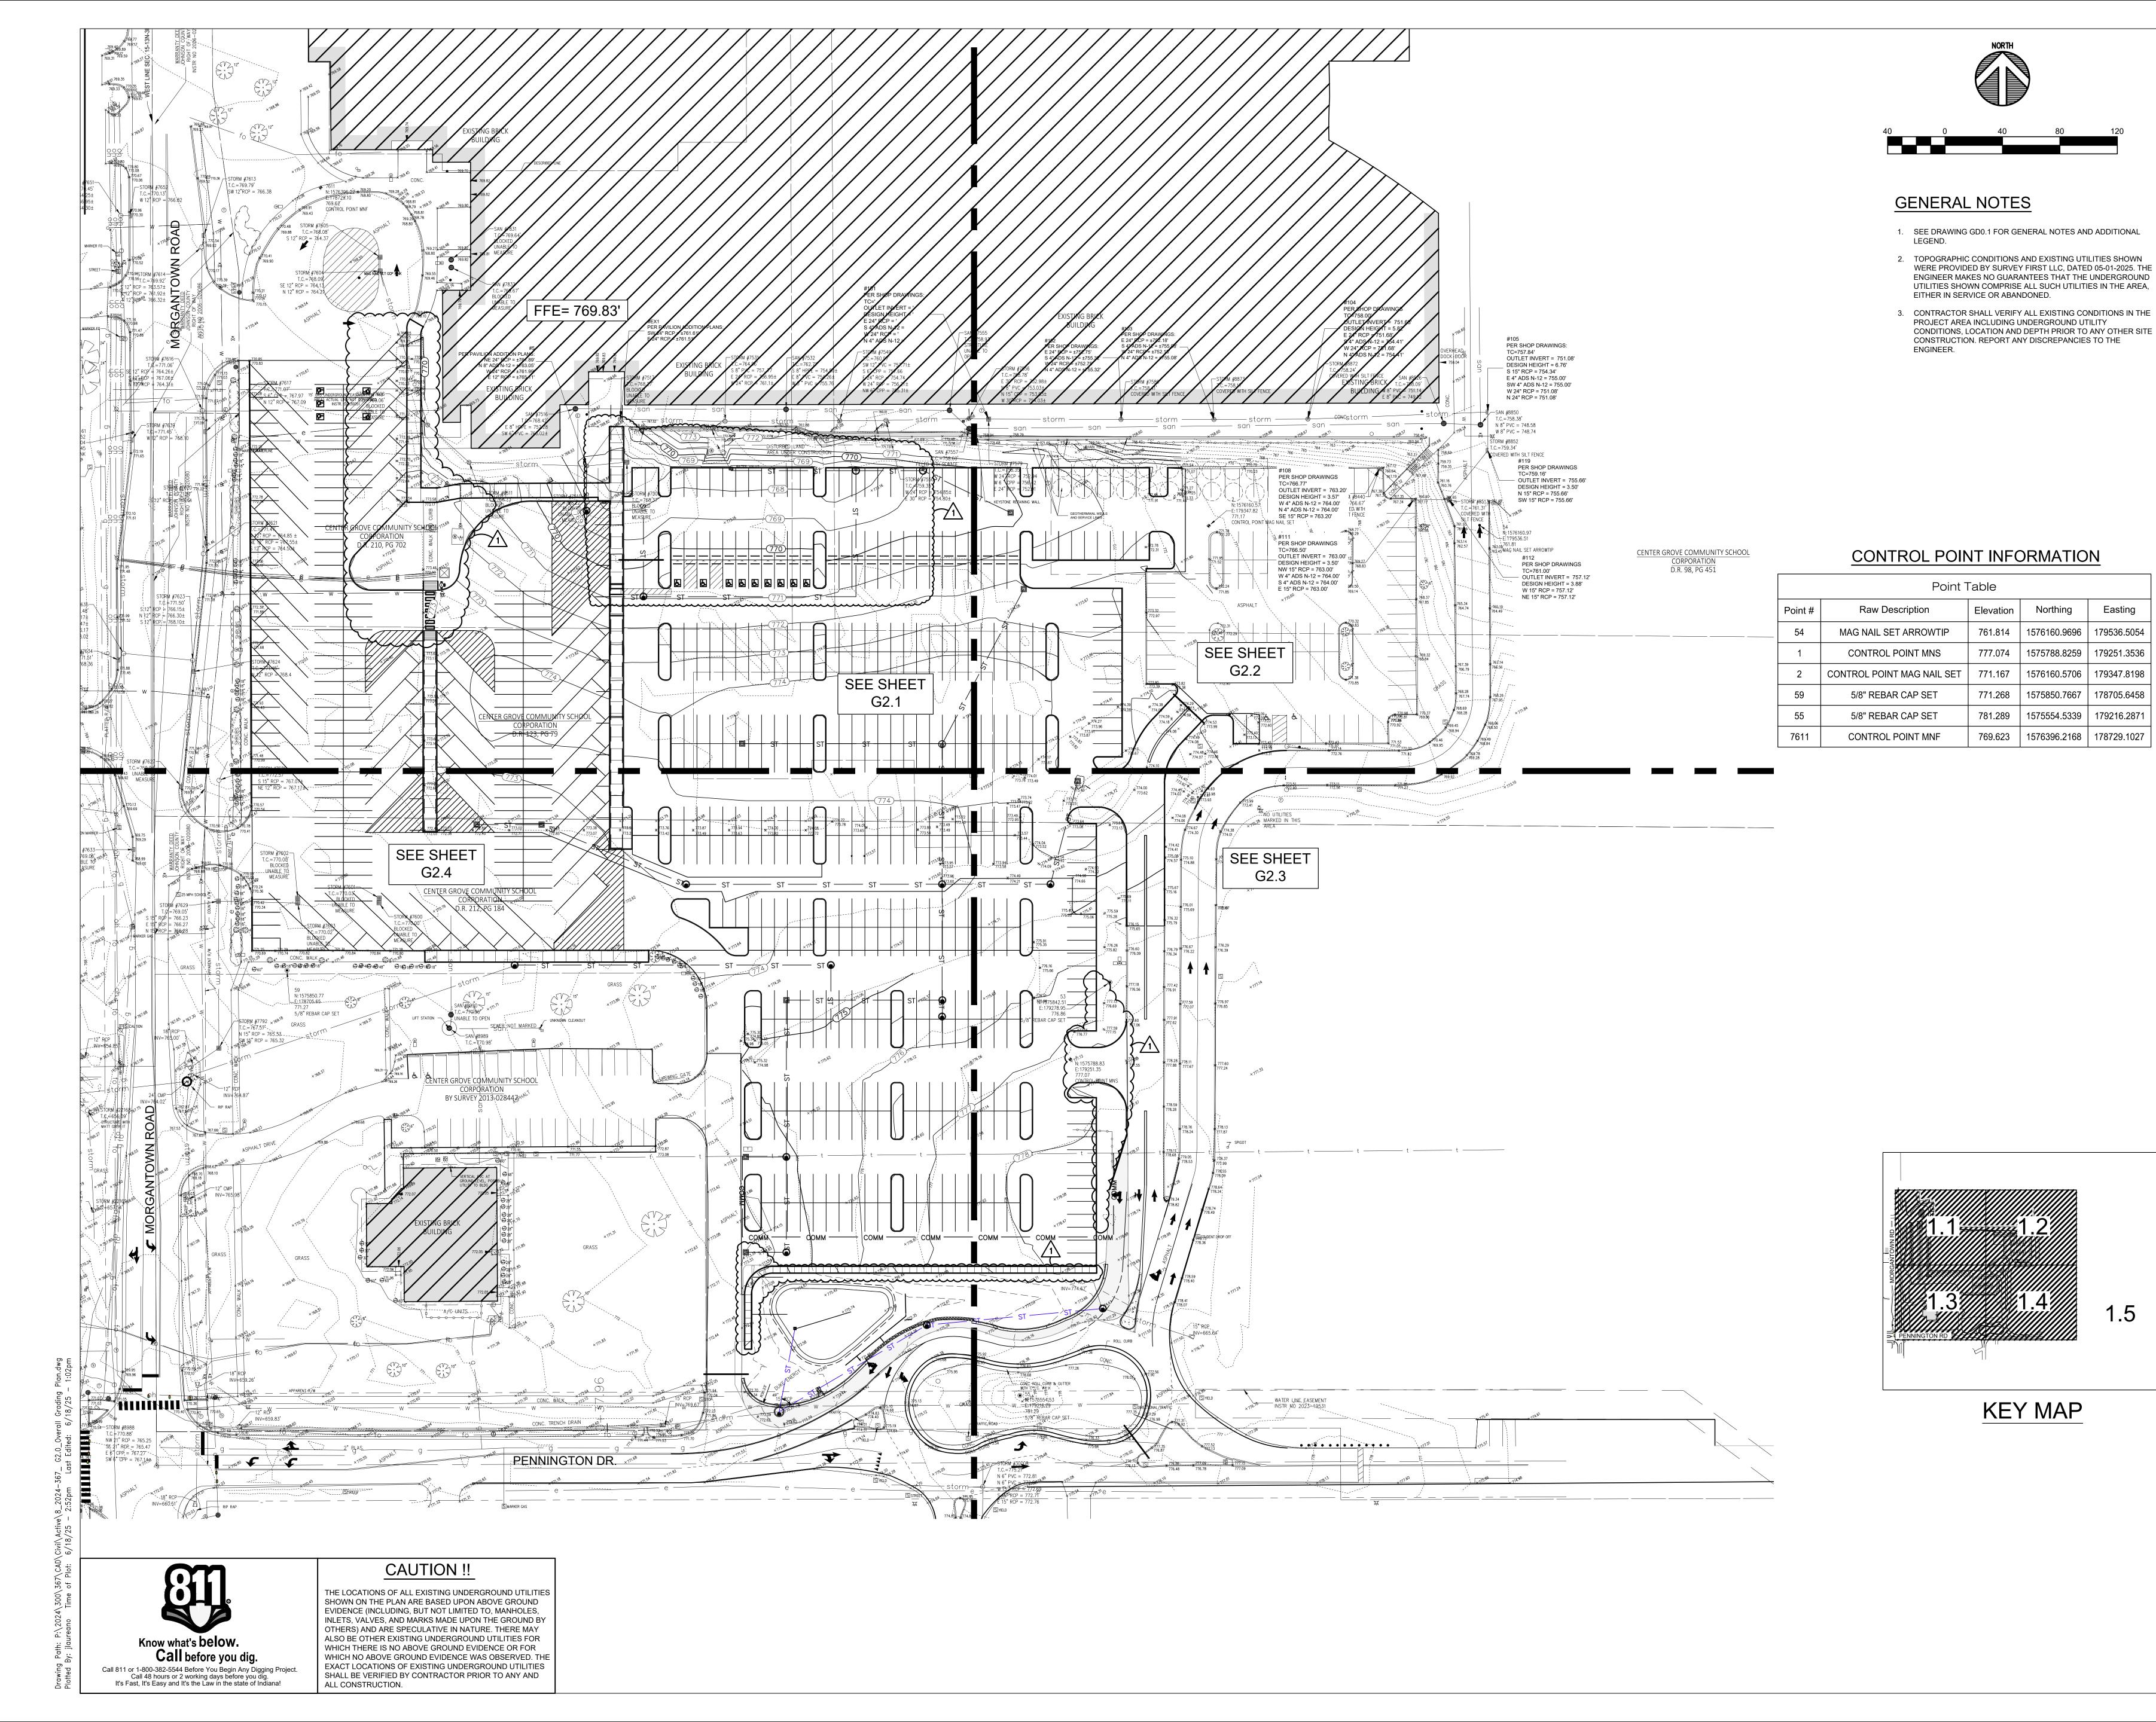

CENTER GROVE
HIGH SCHOOL
PARKING LOT
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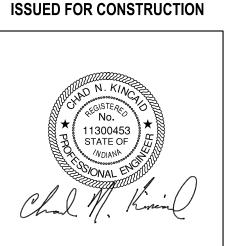
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PROJECT MANAGER: CNK

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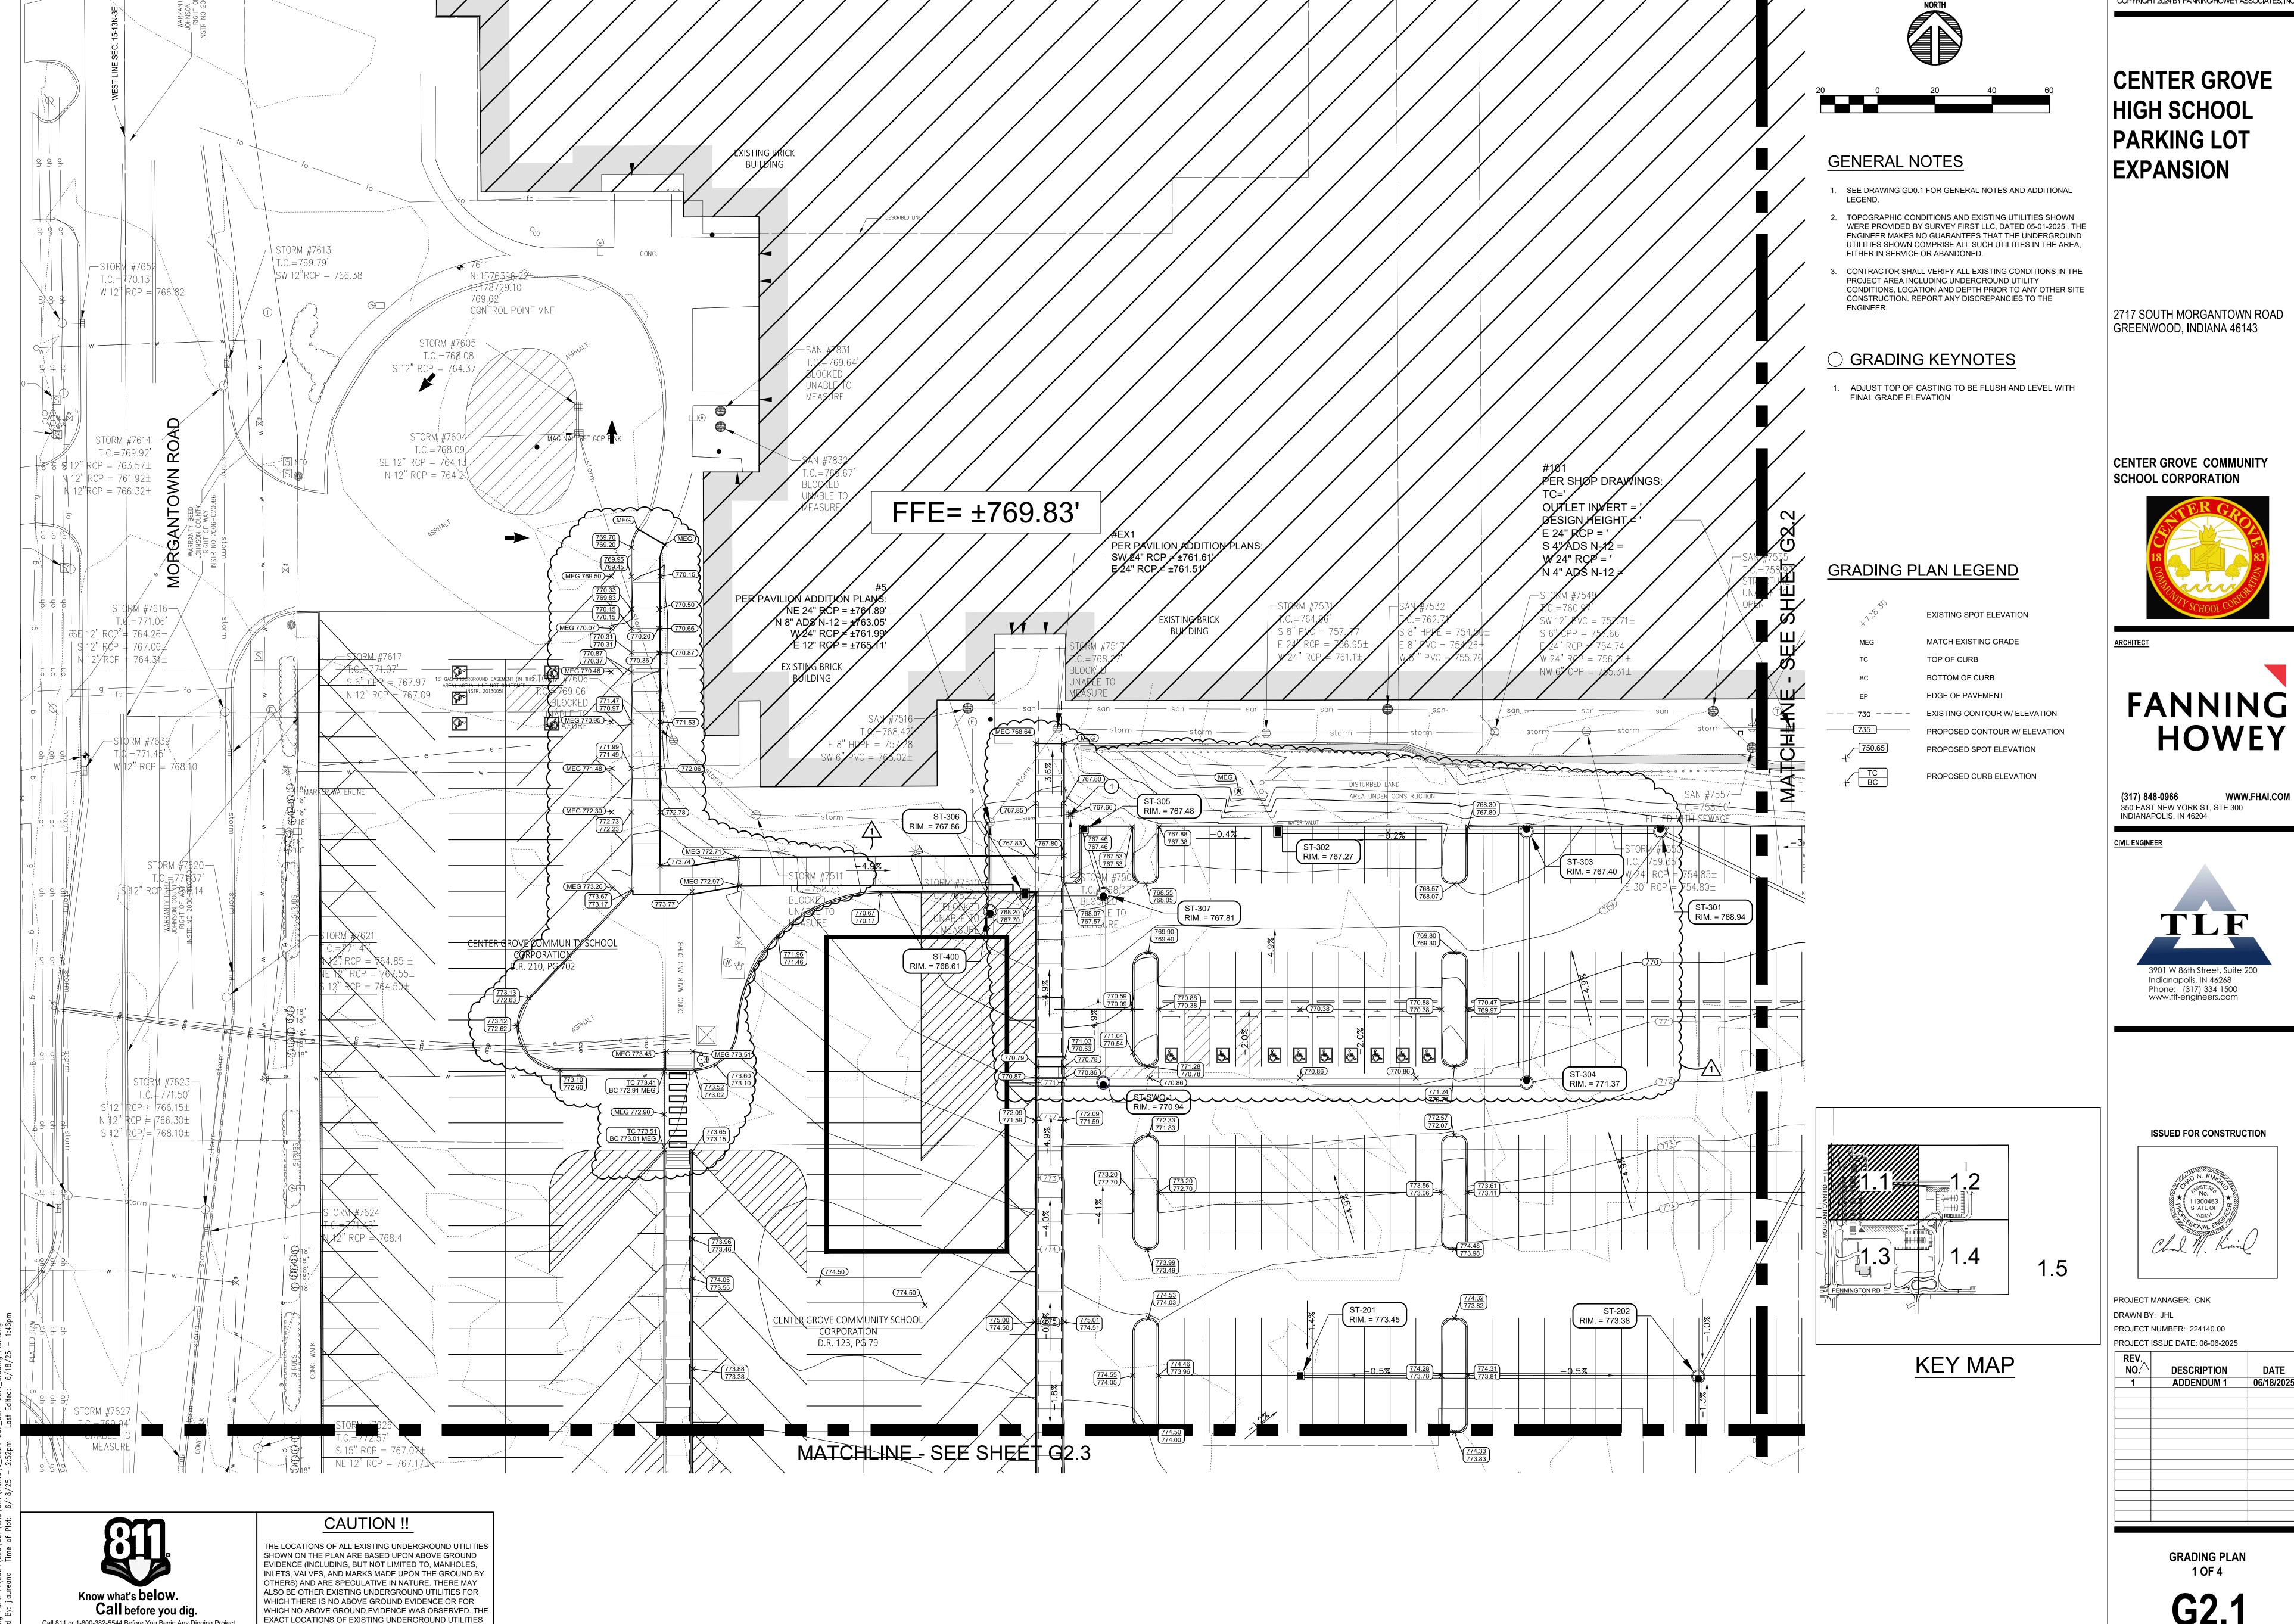
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OVERALL GRADING PLAN

G2.0



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Call 48 hours or 2 working days before you dig.

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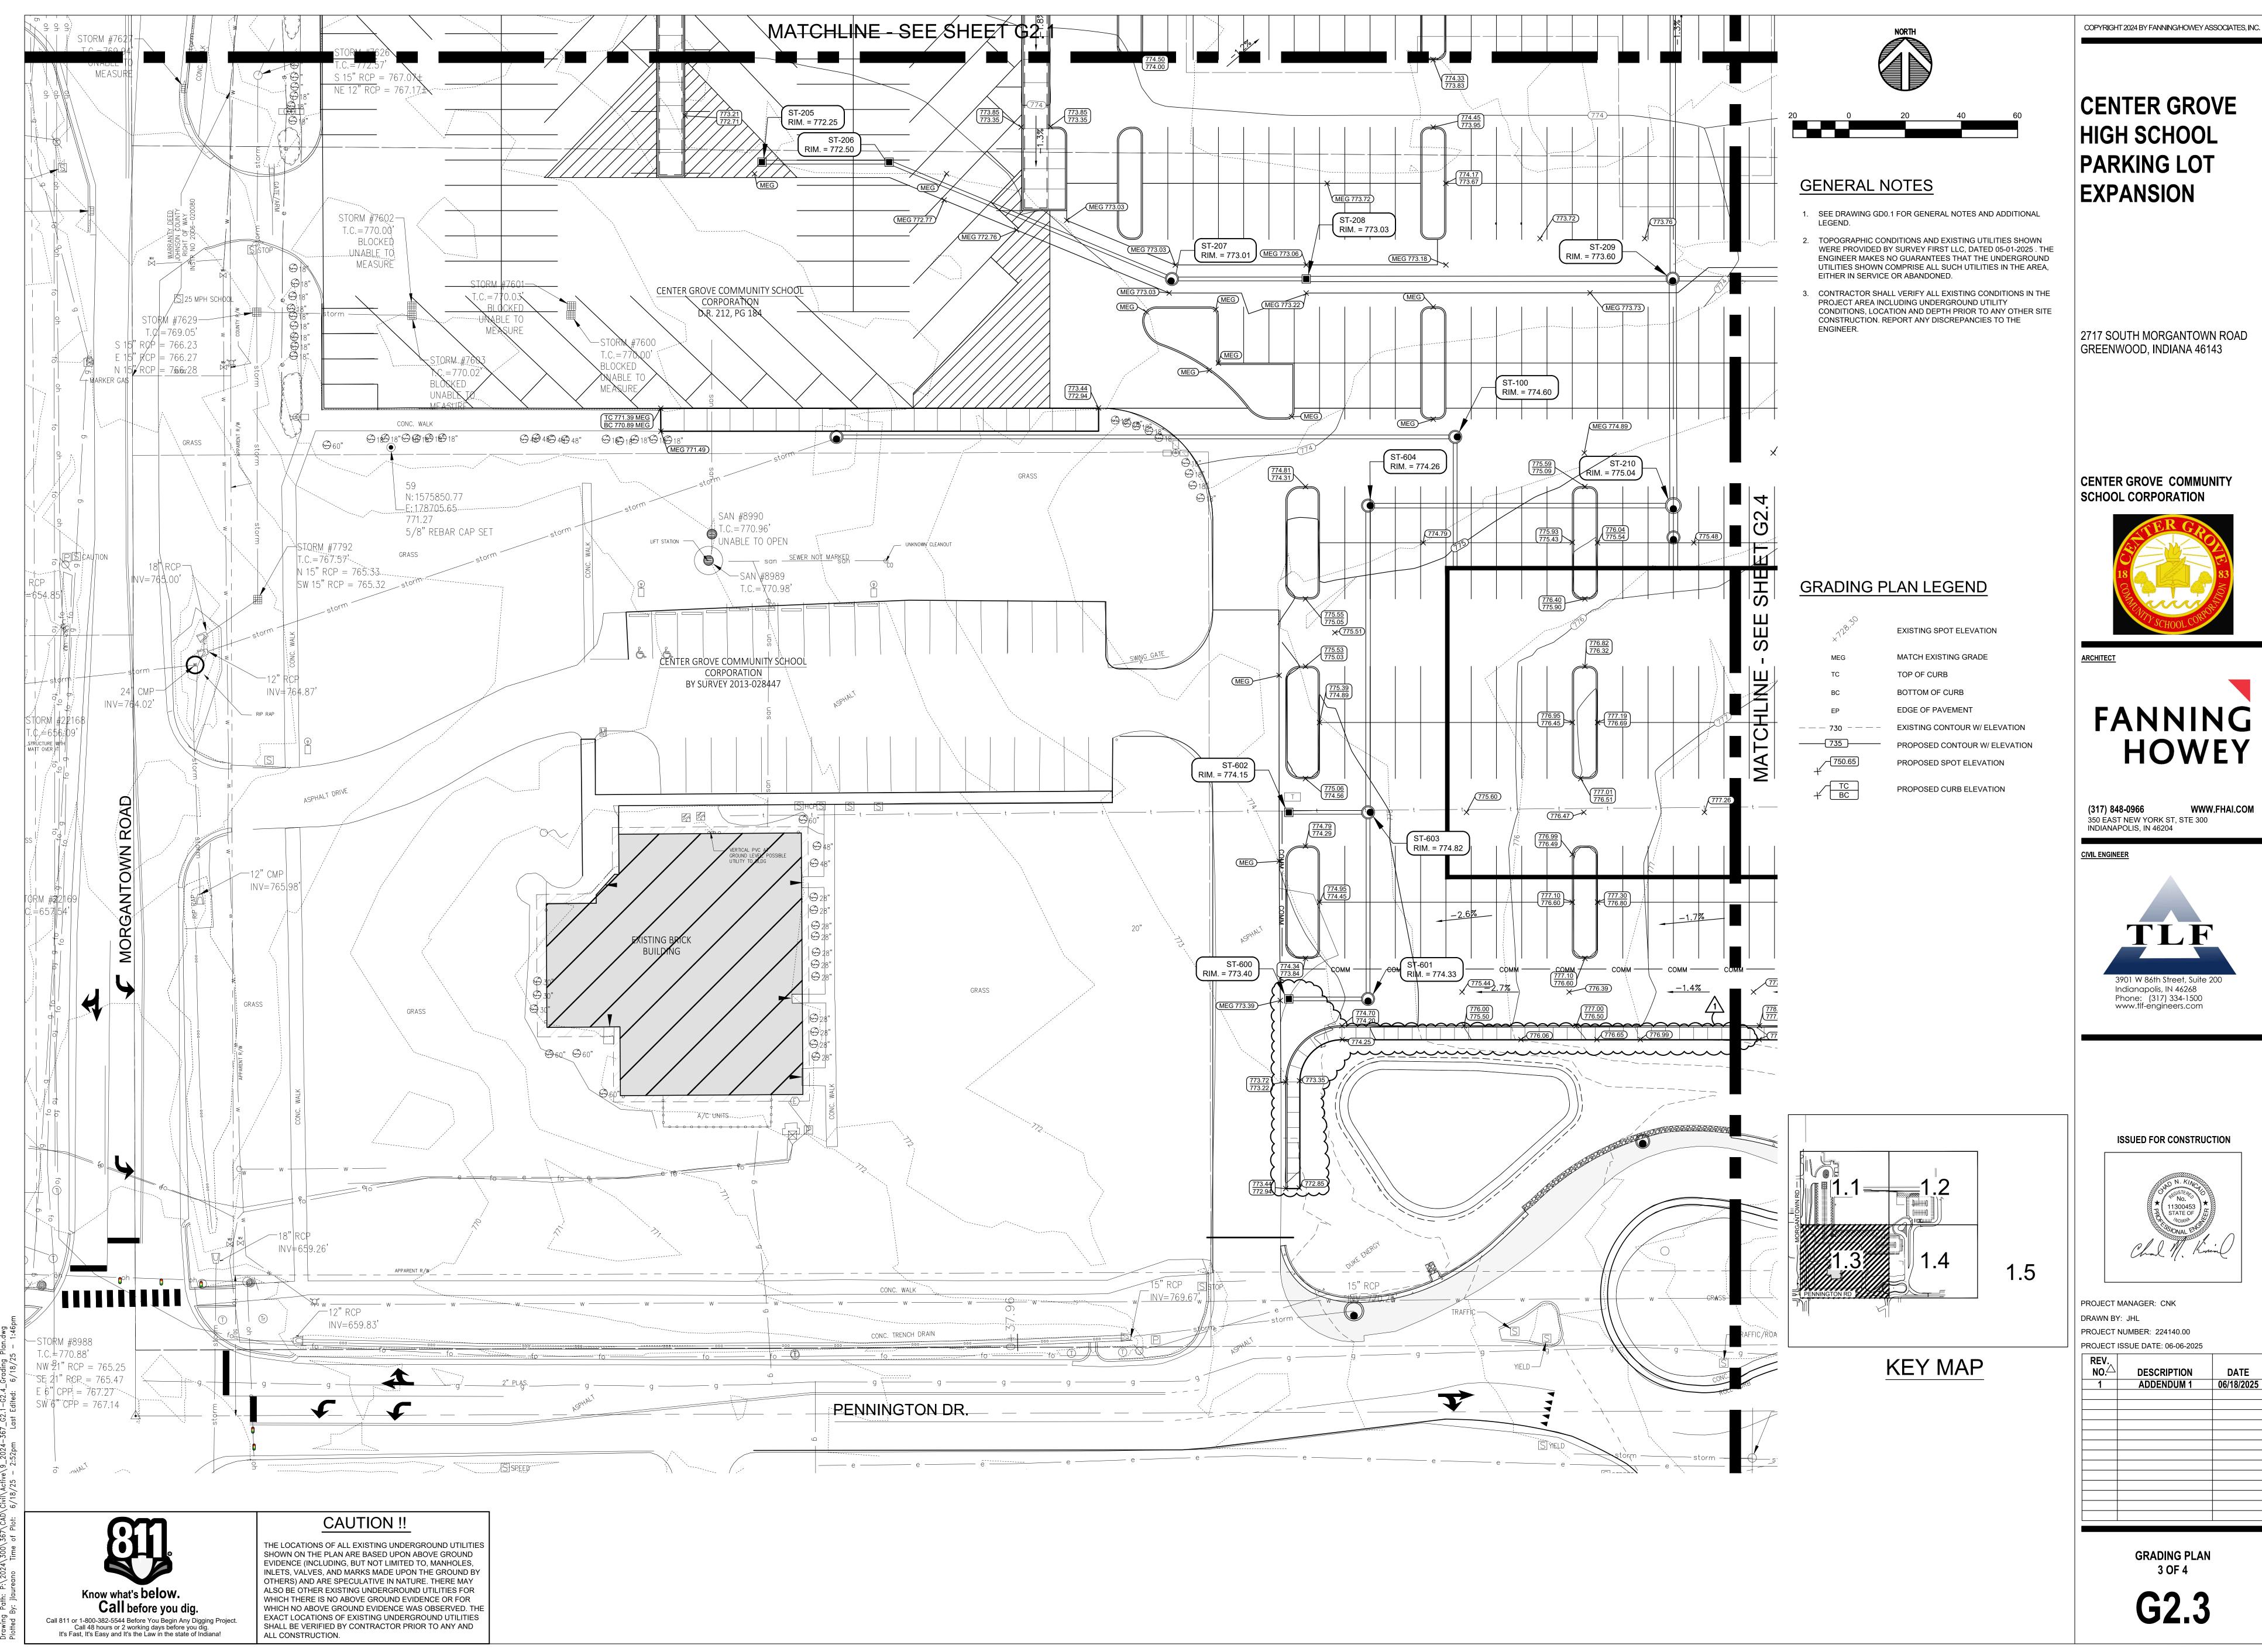
SHALL BE VERIFIED BY CONTRACTOR PRIOR TO ANY AND


ALL CONSTRUCTION.

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1	ADDENDUM 1	06/18/2025





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ARCHITECT

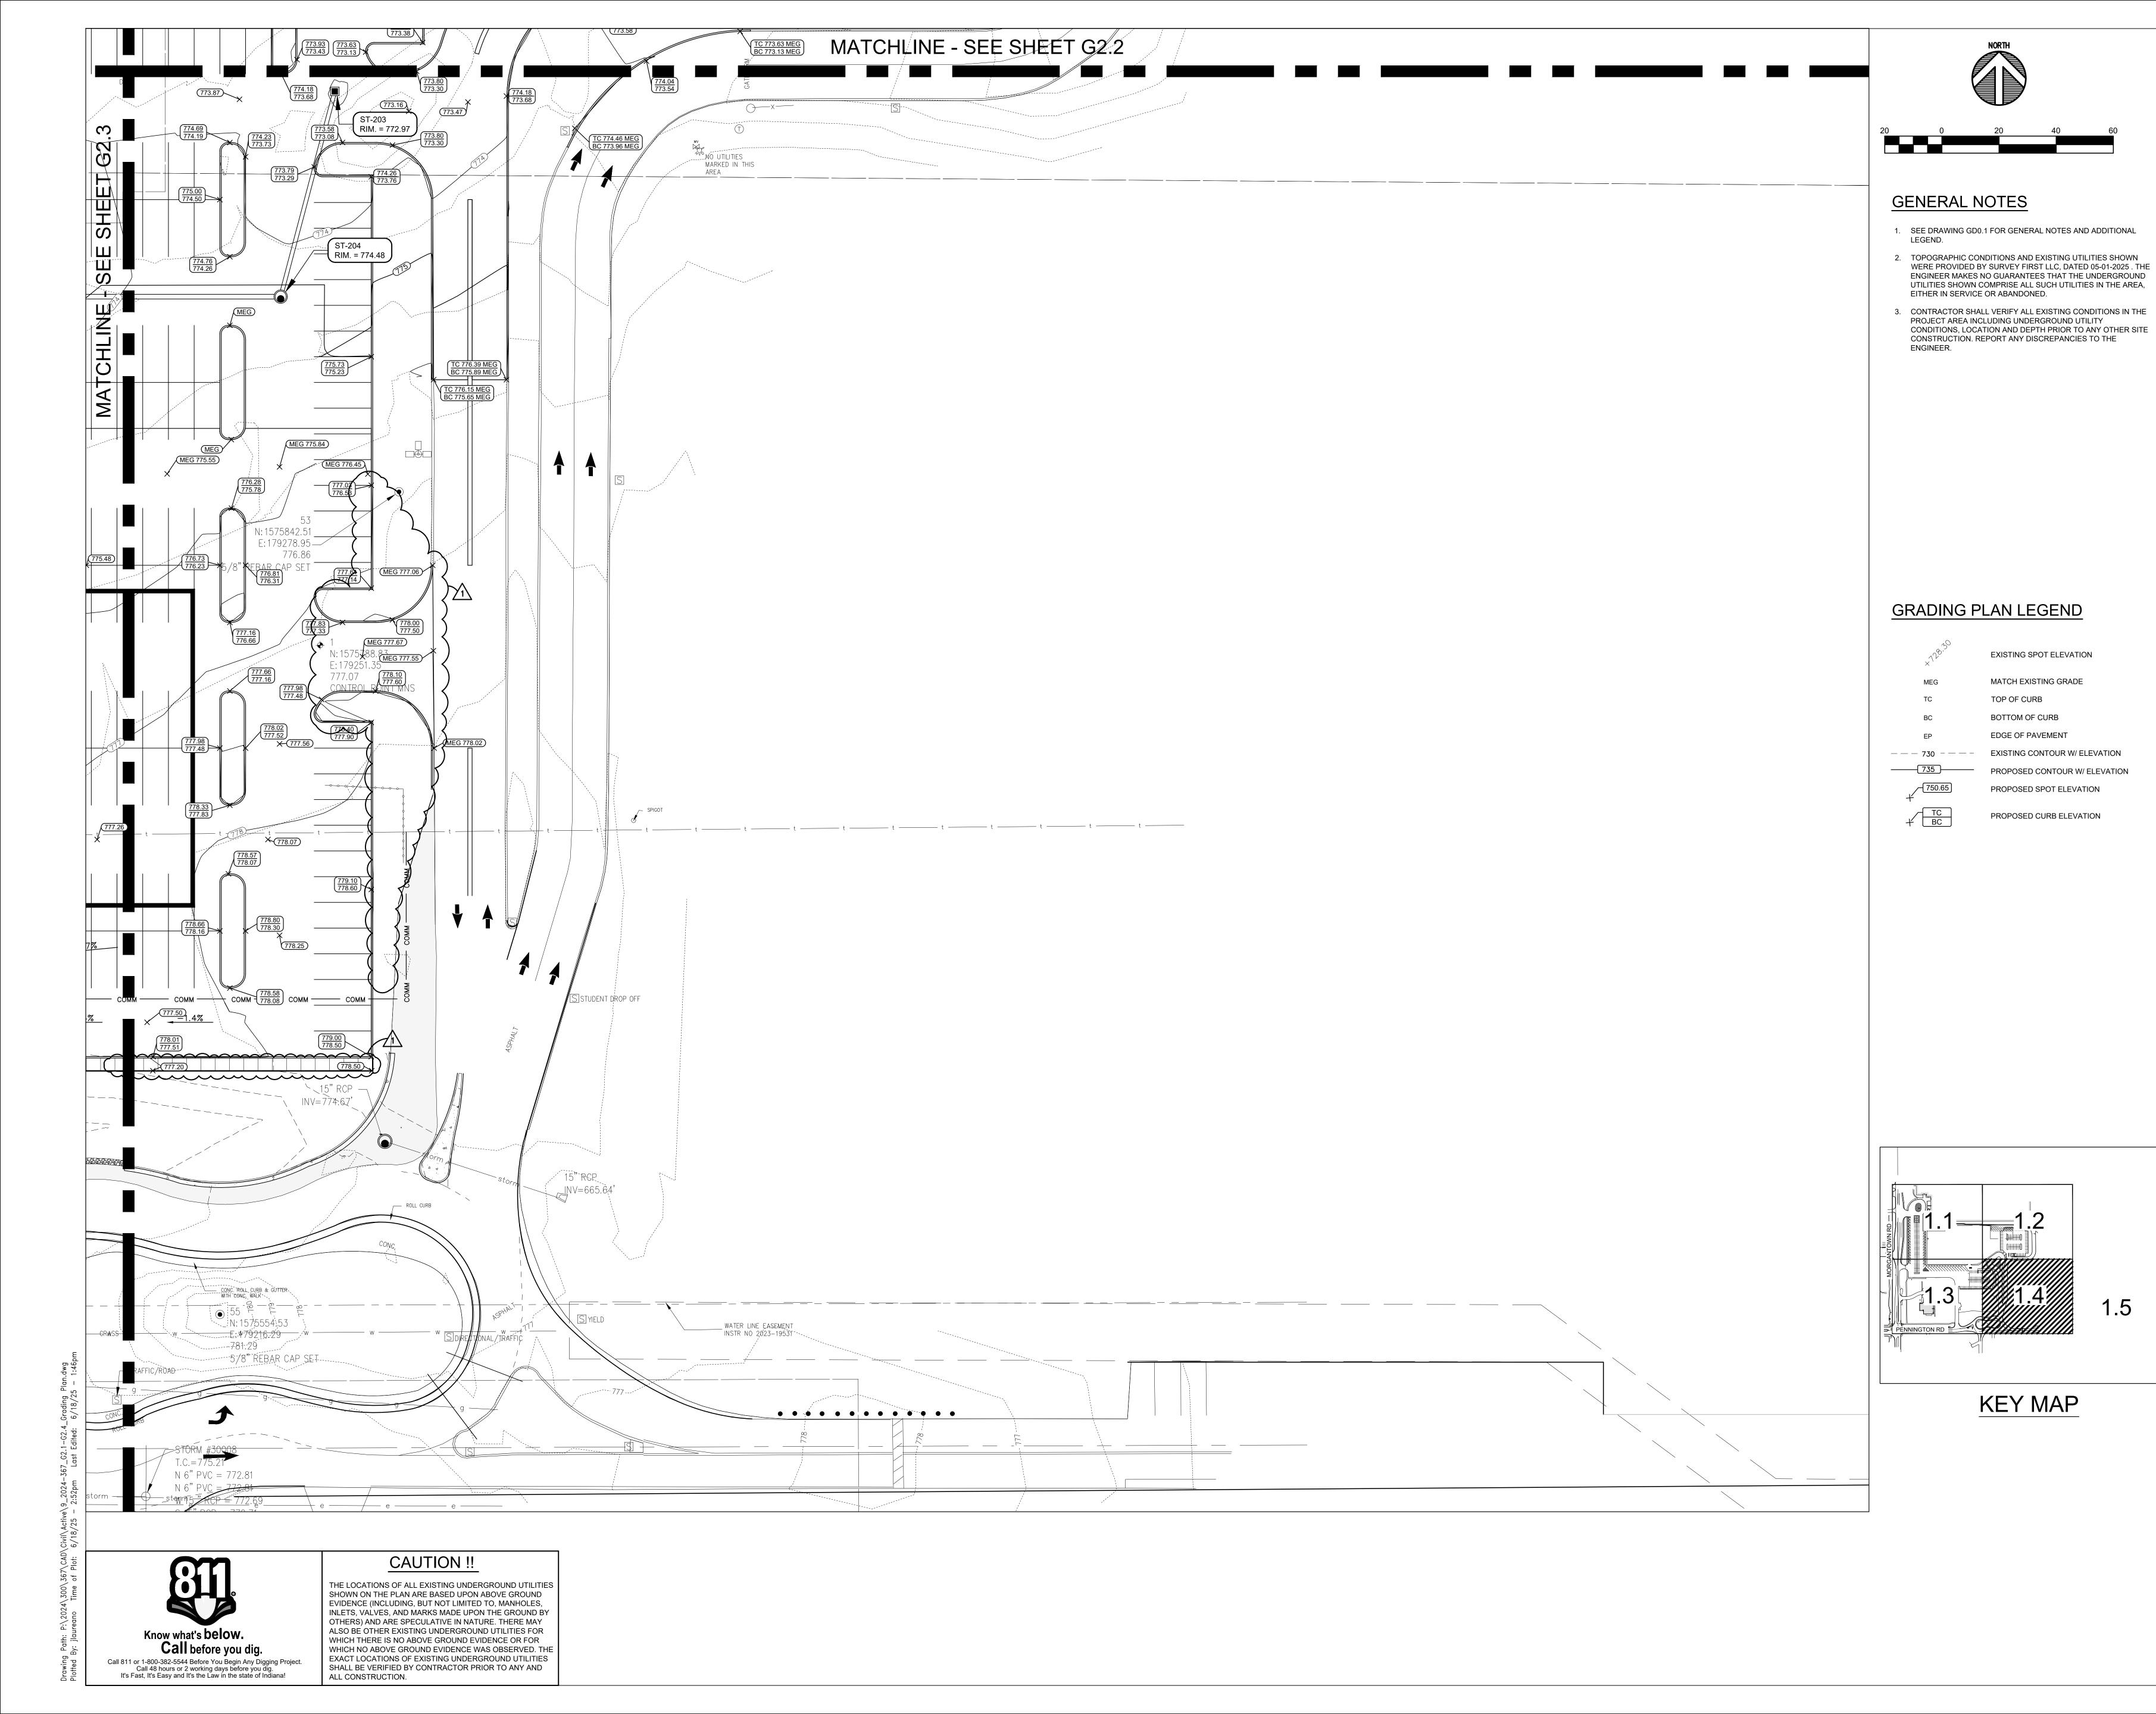


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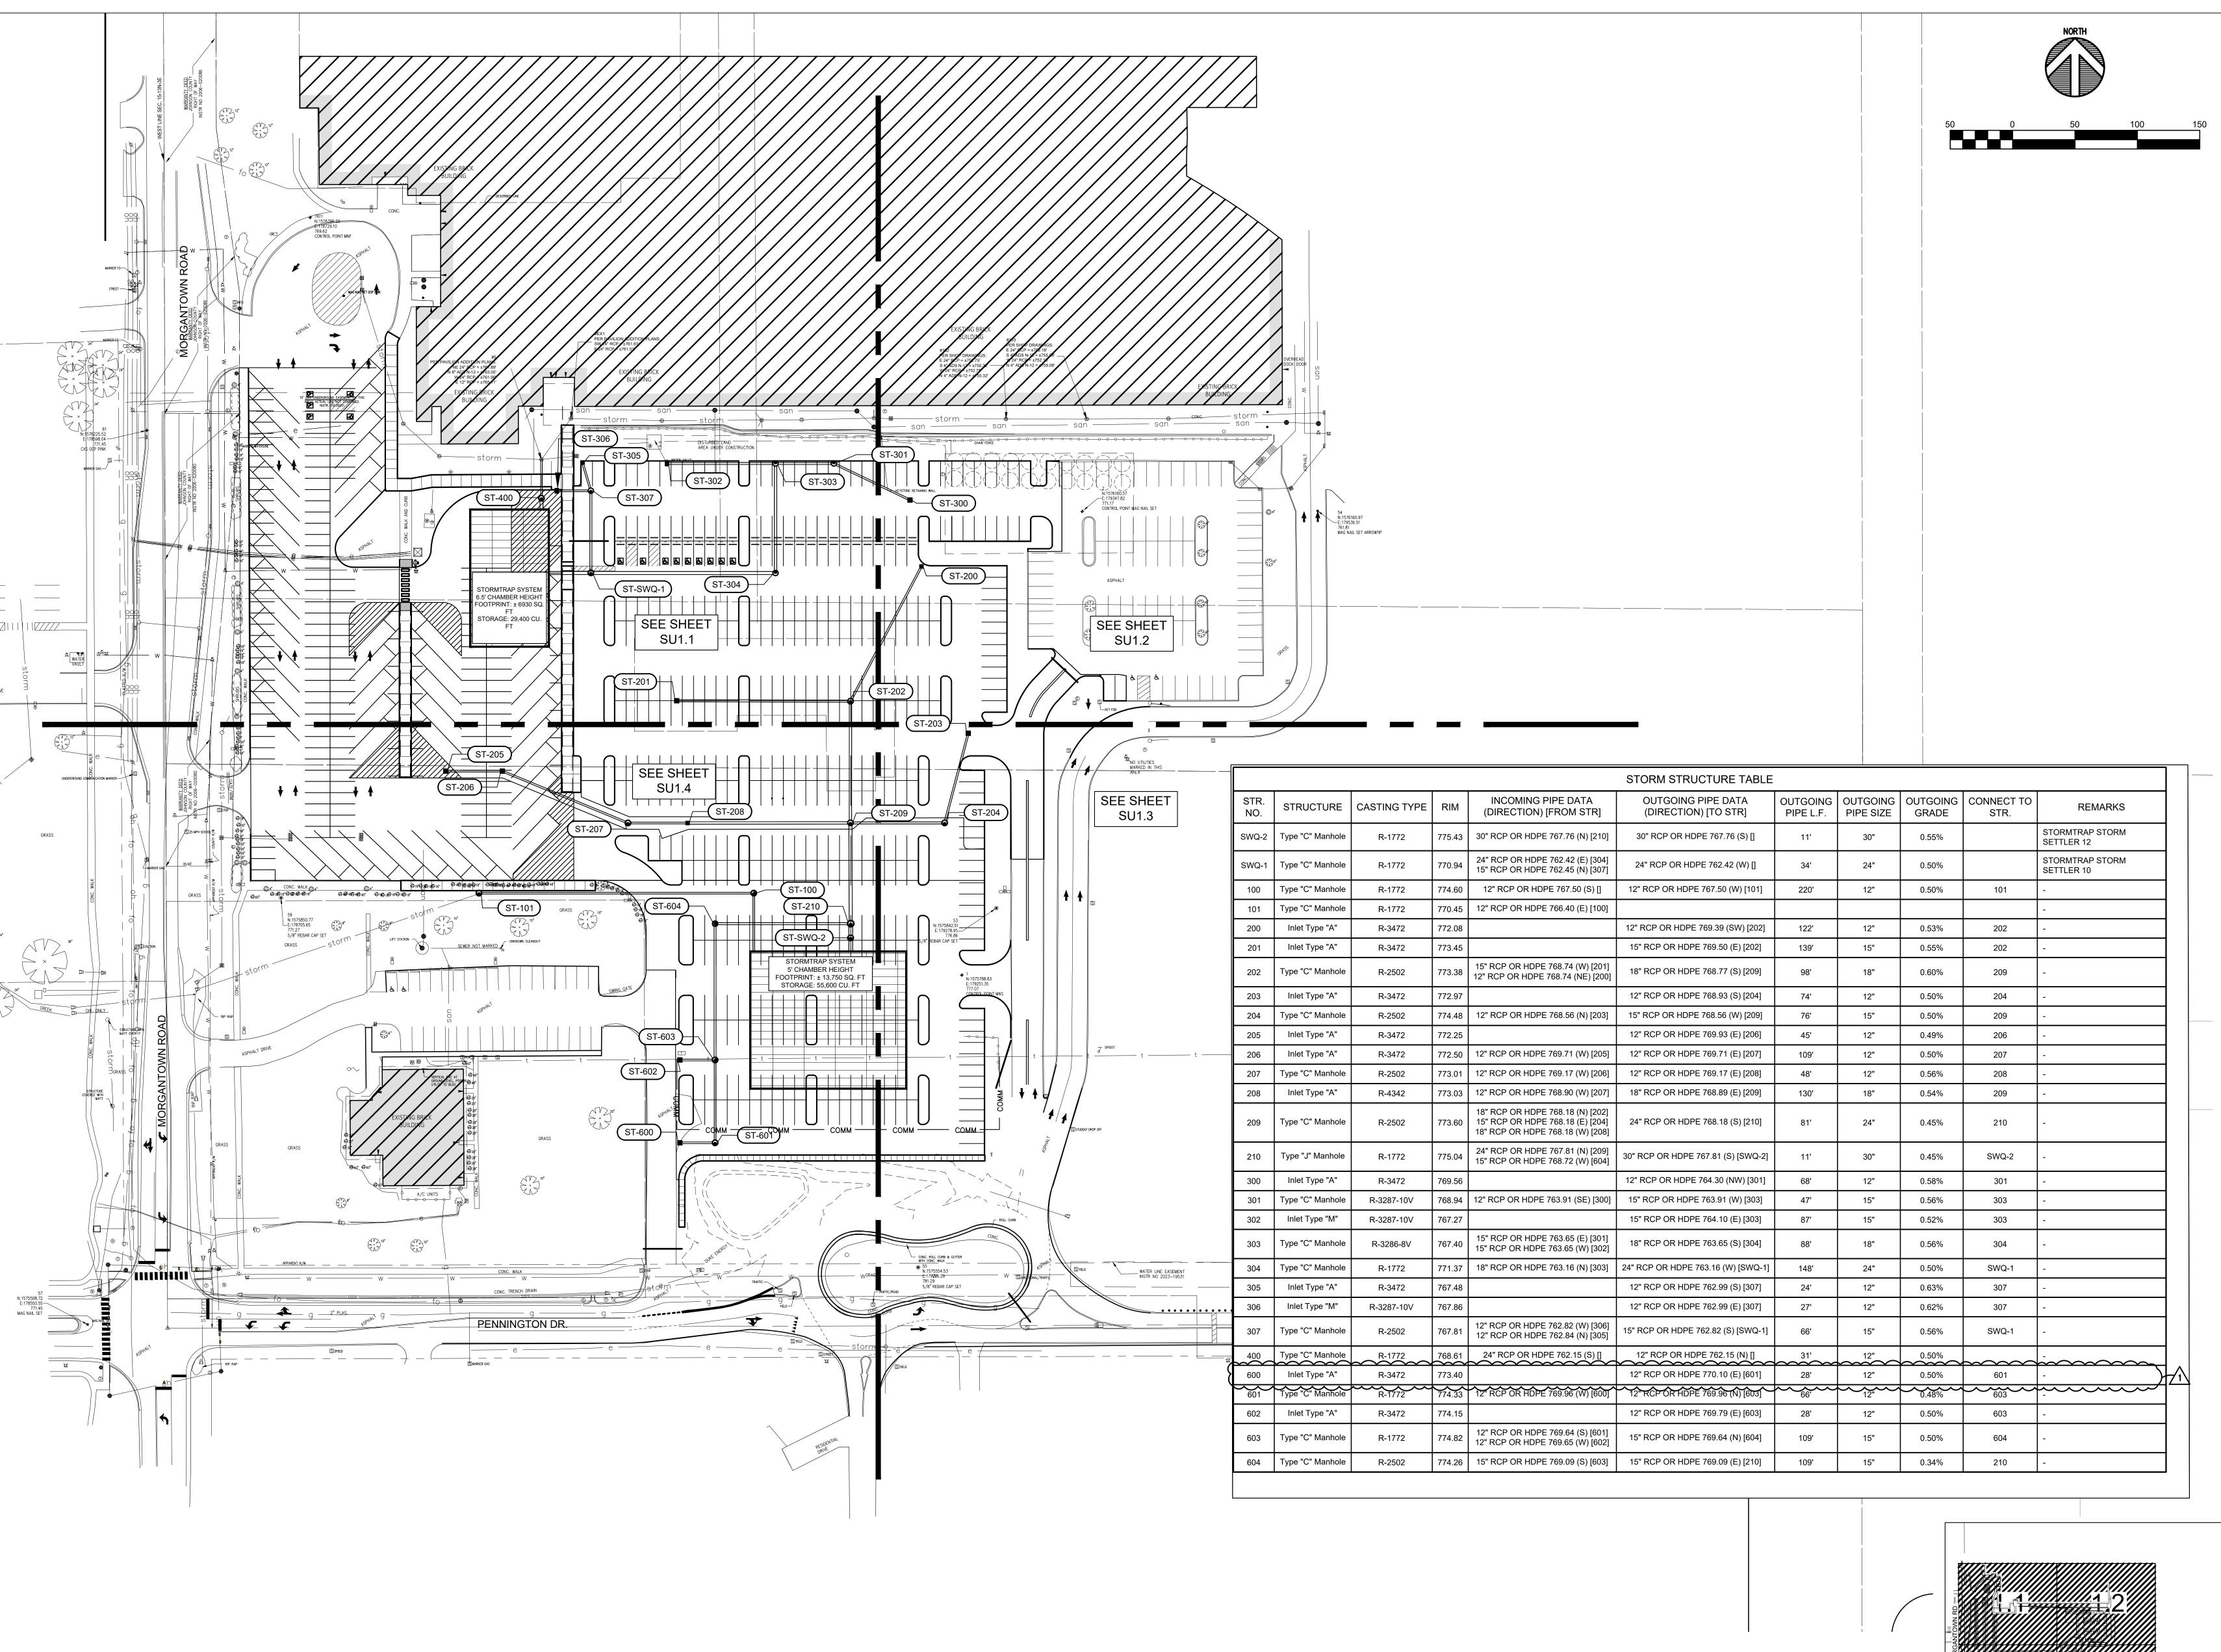
PROJECT NUMBER: 224140.00

PROJECT ISSUE DATE: 06-06-2025

REV.		
NO.	DESCRIPTION	DATE
1	ADDENDUM 1	06/18/2025

GRADING PLAN 4 OF 4

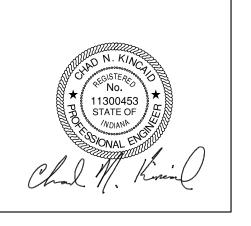G2.4



KEY MAP

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CENTER GROVE HIGH SCHOOL **PARKING LOT EXPANSION**

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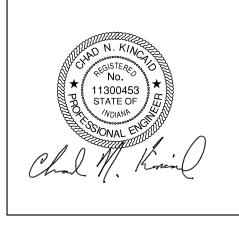
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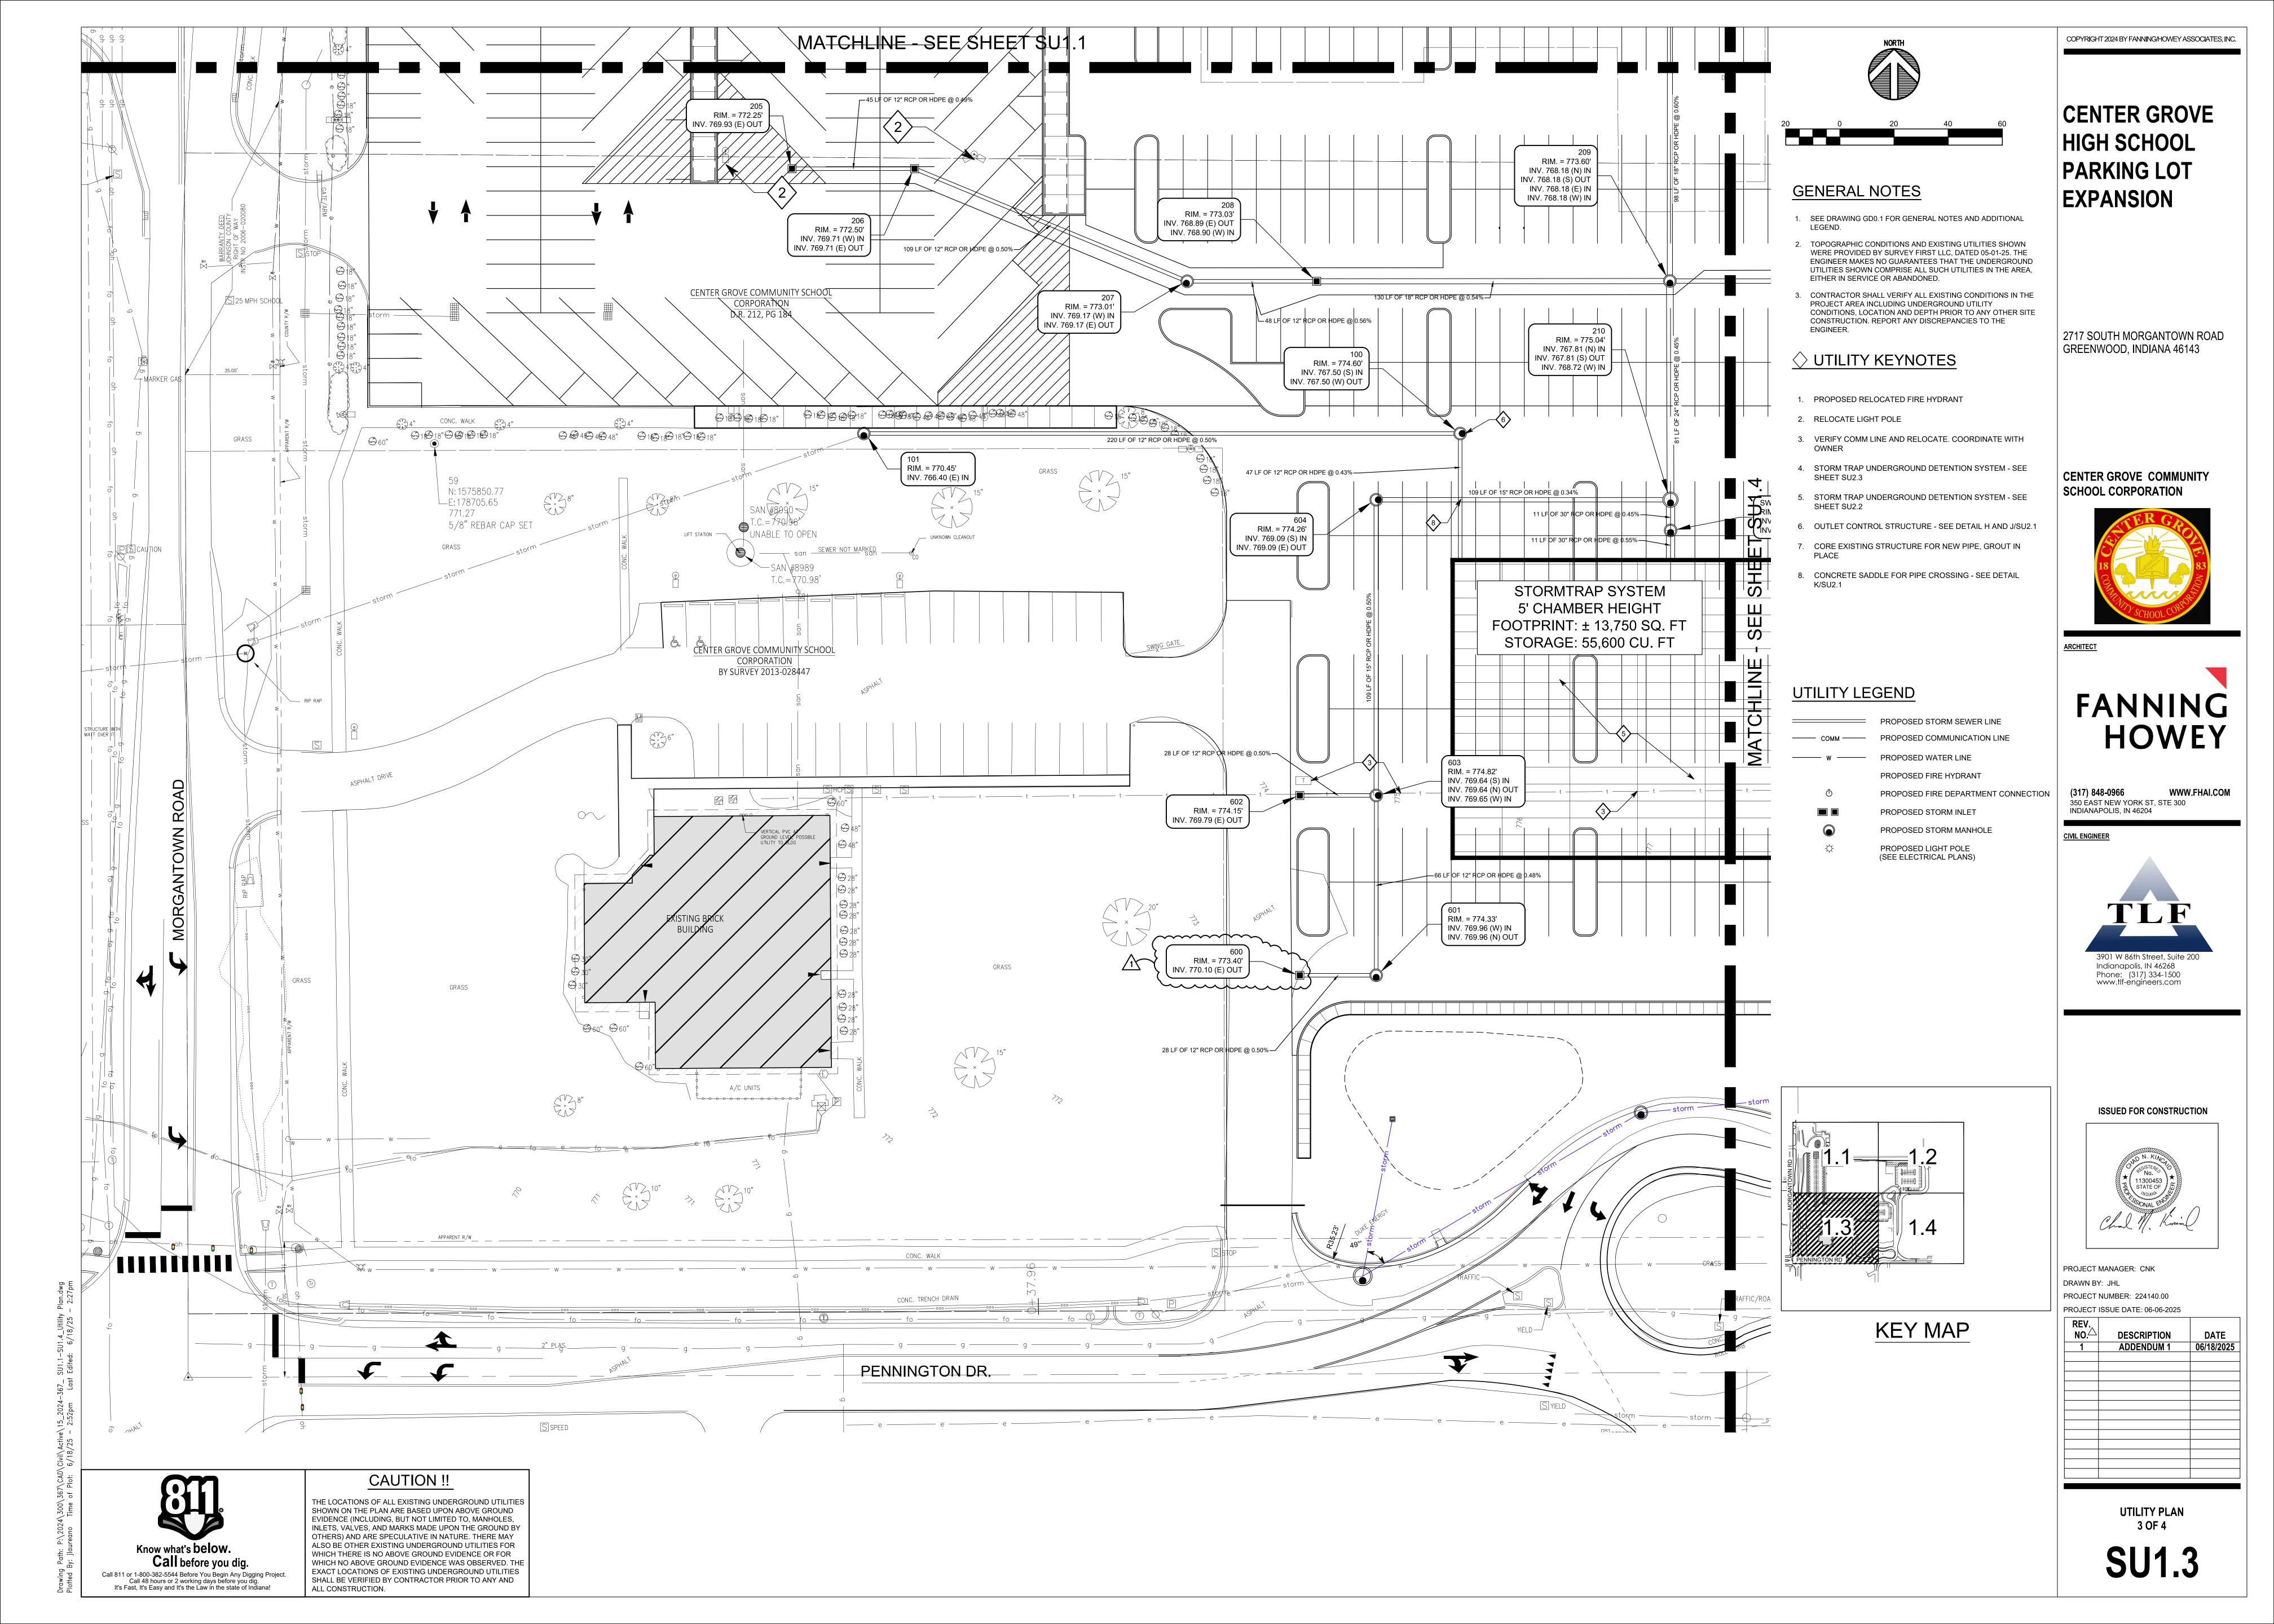
ISSUED FOR CONSTRUCTION




PROJECT MANAGER: CNK DRAWN BY: JHL PROJECT NUMBER: 224140.00 PROJECT ISSUE DATE: 06-06-2025


PROJECT 1350E DATE. 00-00-2025		
REV. NO.	DESCRIPTION	DATE
1	ADDENDUM 1	06/18/202
-	ADDENDOWN	00/10/202

OVERALL UTILITY PLAN




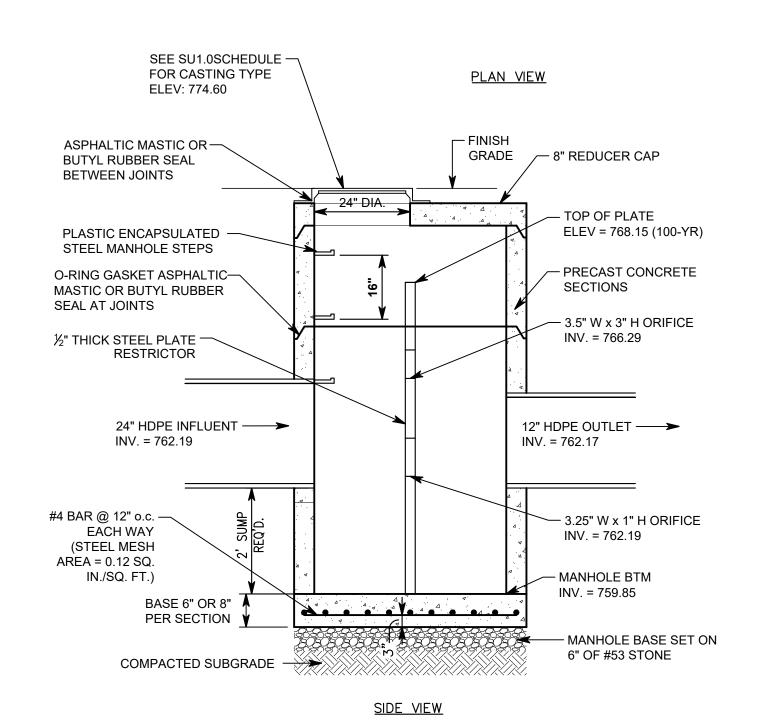


STR. 400 **OUTLET CONTROL STRUCTURE - DETAIL J** NOT TO SCALE

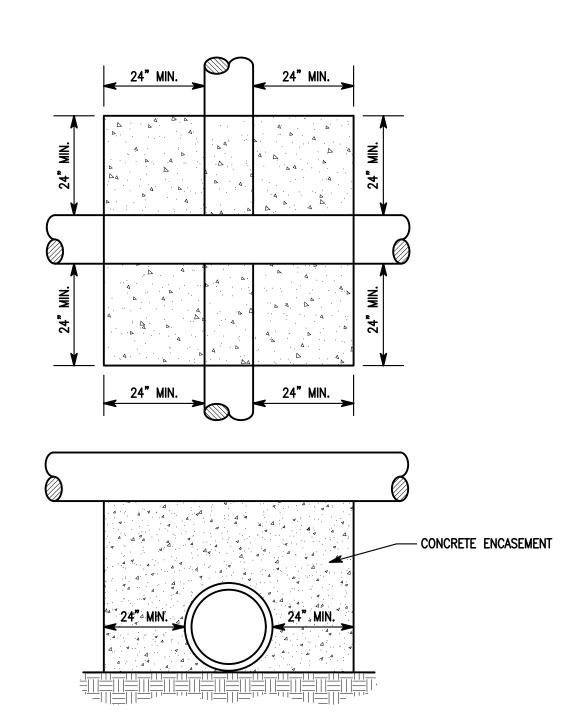


CONCRETE SADDLE - DETAIL K

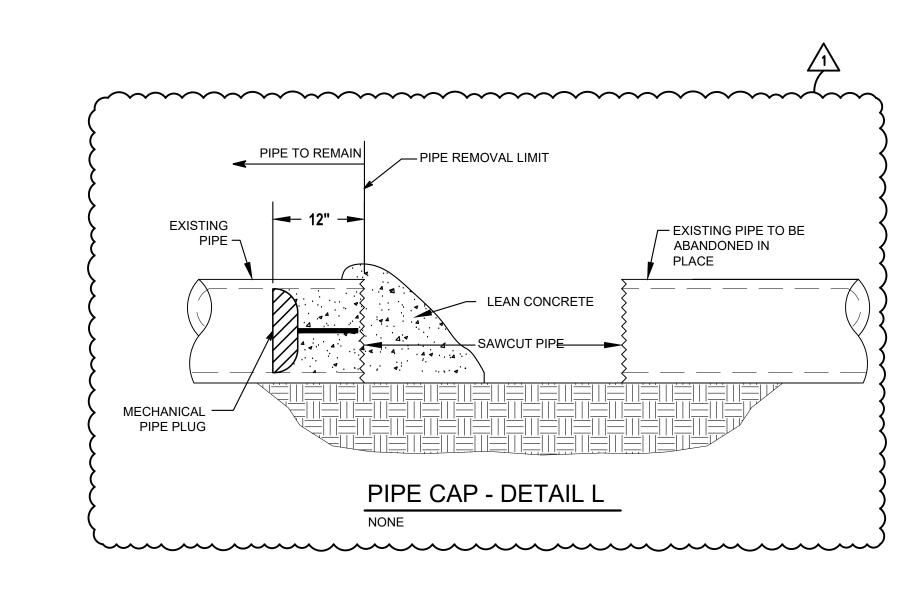


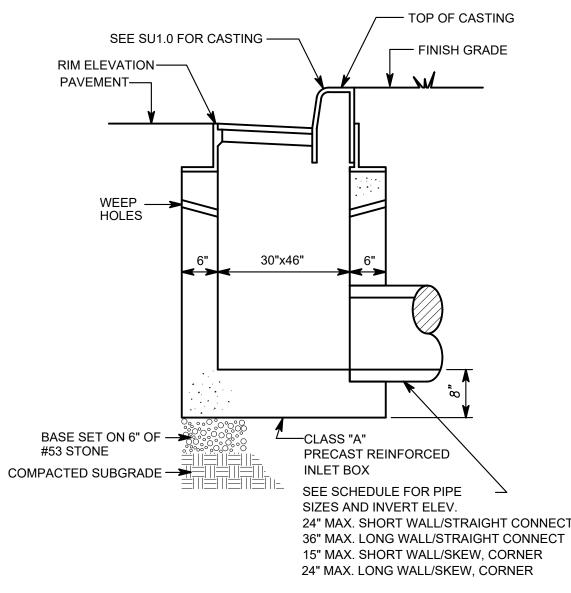


CURB INLET TYPE "B" - DETAIL F SCALE: NTS

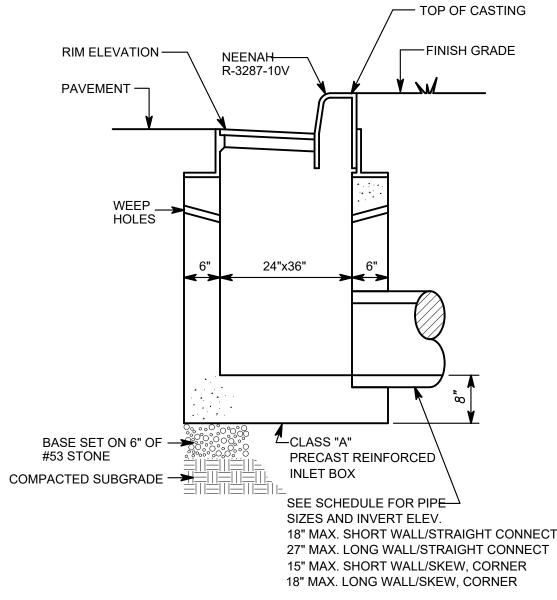


CURB INLET TYPE "J" OR "K" - DETAIL G

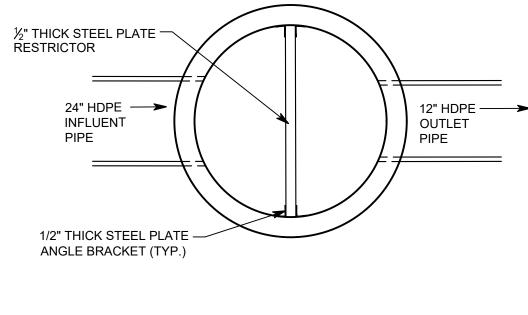

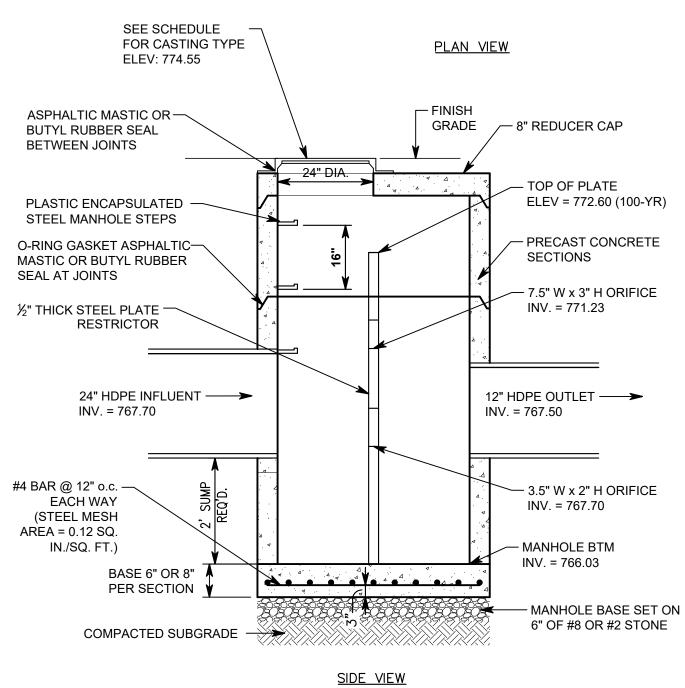

STR. 100 OUTLET CONTROL STRUCTURE - DETAIL H

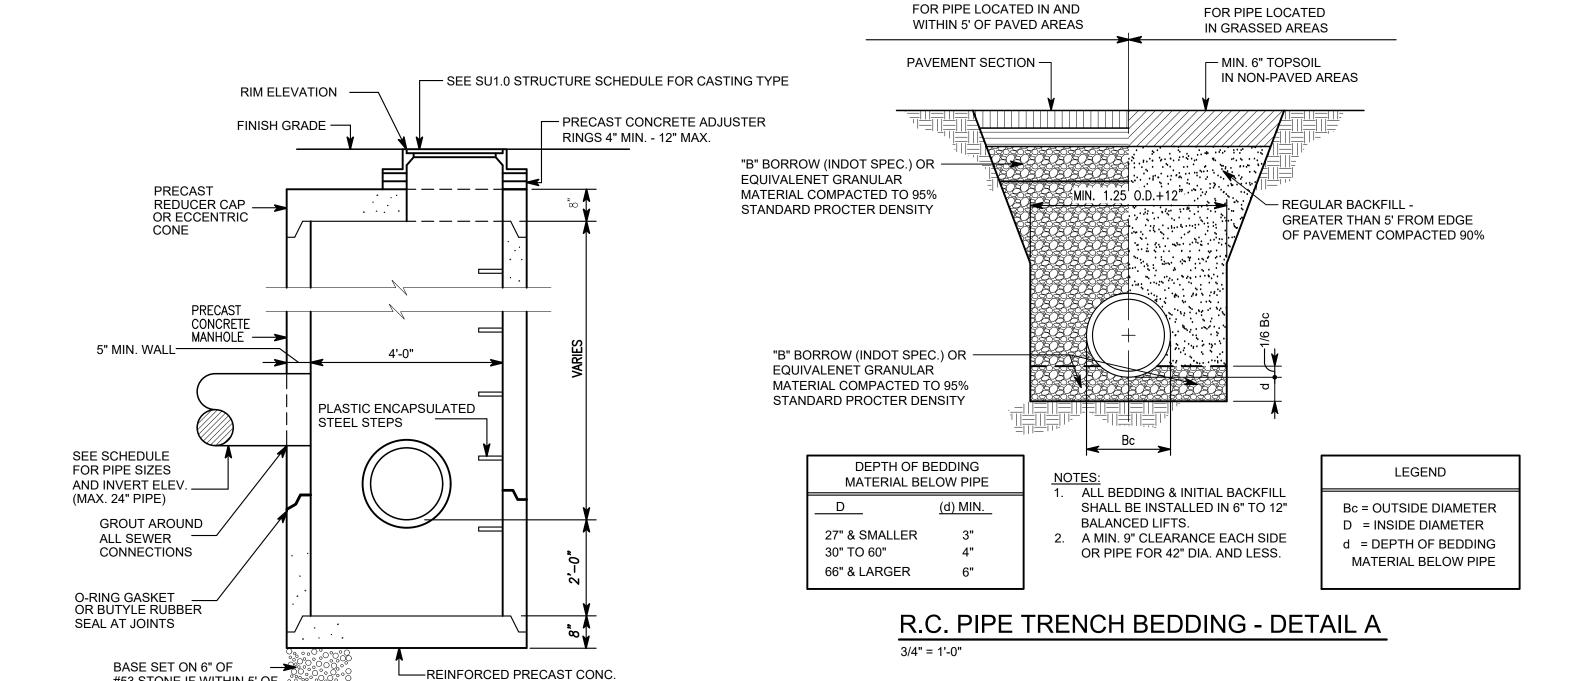

SEE SU1.0 STRUCTURE

ASPHALTIC MASTIC OR — BUTYL RUBBER SEAL

PLASTIC ENCAPSULATED — STEEL MANHOLE STEPS

O-RING GASKET ASPHALTIC —

#4 BAR @ 12" o.c. —

(STEEL MESH AREA =

SEE DETAIL

SEE SU1.0 SCHEDULE FOR CASTING TYPES

AND DIMENSIONS

0.12 SQ. IN./SQ. FT.)

EACH WAY

BASE 6" OR 8"

PER SECTION ¥

MASTIC OR BUTYL RUBBER

SEAL AT JOINTS

BETWEEN JOINTS

SCHEDULE FOR CASTING TYPE

AND ELEVATION. STAMP WITH

"DUMP NO WASTE- DRAINS TO

WATERWAY" ON ALL CASTINGS

FINISH

GRADE

- PRECAST CONCRETE

(4 MAX.) SEE DETAIL

48" DIA.

ADJUSTING RING AS NEEDED

- ECCENTRIC CONE OR

BY SITE CONDITIONS

PRECAST CONCRETE

— PREFORMED HOLE TO

MAX. OF PIPE O.D. + 6"

W/ NON SHRINK

CEMENT GROUT

BENCHWALLS AT MIN.

1/2" PER FOOT SLOPE

OF PAVED AREAS

DIA. "F" | DIA. "G" | THICKNESS

OF #53 STONE IF WITHIN 5'

MANHOLE BASE SET ON 6"
OF #53 STONE IF WITHIN 5'

- SEE SU1.0 STRUCTURE

- STANDARD PRECAST

MANHOLE CAP OR CONE

SCHEDULE FOR CASTING TYPE

AND ELEVATION. STAMP WITH

"DUMP NO WASTE- DRAINS TO

WATERWAY" ON ALL CASTINGS

NOTES:
MANHOLE TO BE PRECAST CONCRETE

MANHOLE CONFORMS TO ASTM C478

JOINTS CONFORM TO ASTM C443

STORM MANHOLE 4' TYPE 'C' - DETAIL B

SECTIONS

REDUCER CAP AS REQUIRED

CURB BASIN - DETAIL D


BASE, MANHOLE CONFORMS

TO ASTM C 443

TO ASTM C 478. JOINTS CONFORM


#53 STONE IF WITHIN 5' OF OF PAVED AREA

COMPACTED SUBGRADE

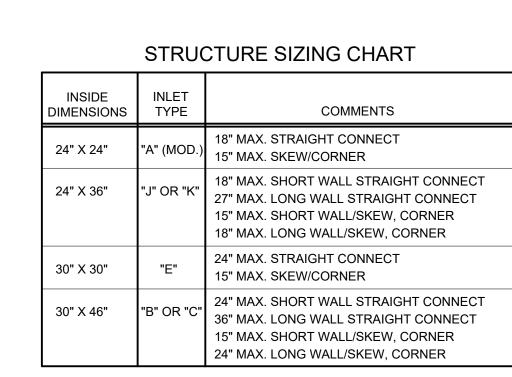


INSIDE DIMENSION

* SEE SCHEDULE

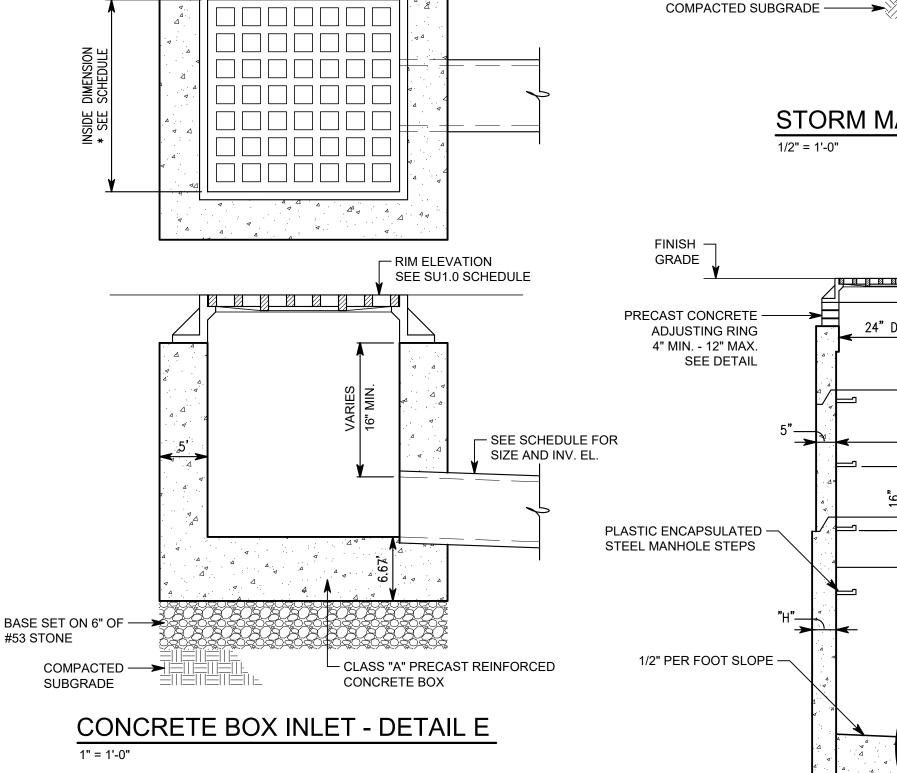



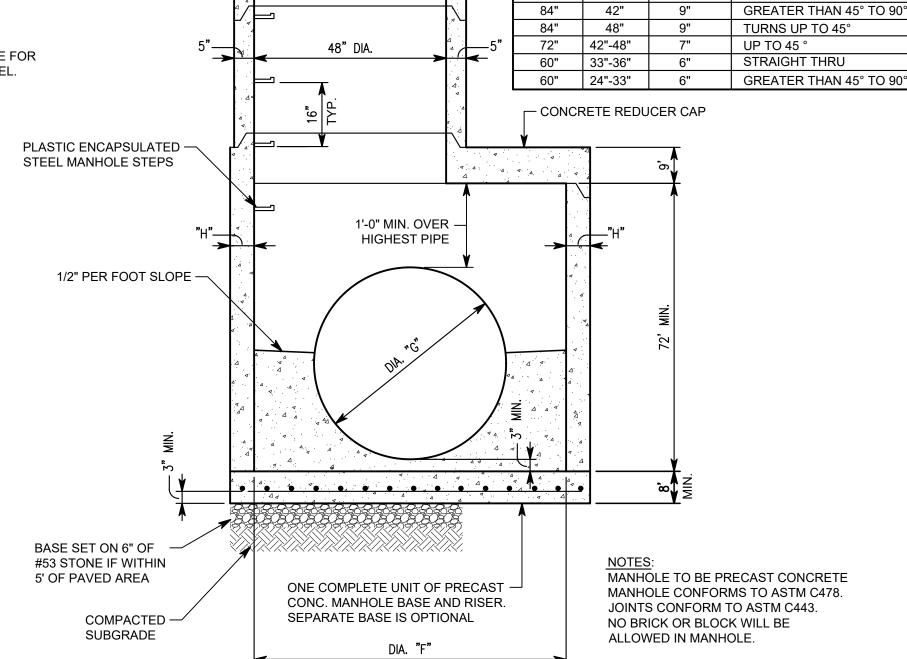


STORM MANHOLE TYPE 'J' - DETAIL C 1/2" = 1'-0"

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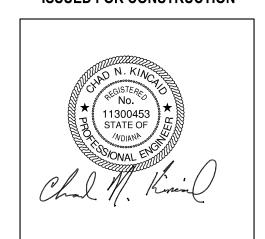
PIPE TURNS



Indianapolis, IN 46268

Phone: (317) 334-1500 www.tlf-engineers.com

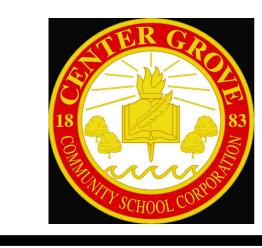ISSUED FOR CONSTRUCTION





PROJECT MANAGER: CNK DRAWN BY: JHL PROJECT NUMBER: 224140.00 PROJECT ISSUE DATE: 06-06-2025

KEV.		
NO.	DESCRIPTION	DATE
1	ADDENDUM 1	06/18/2025

STORM DETAILS



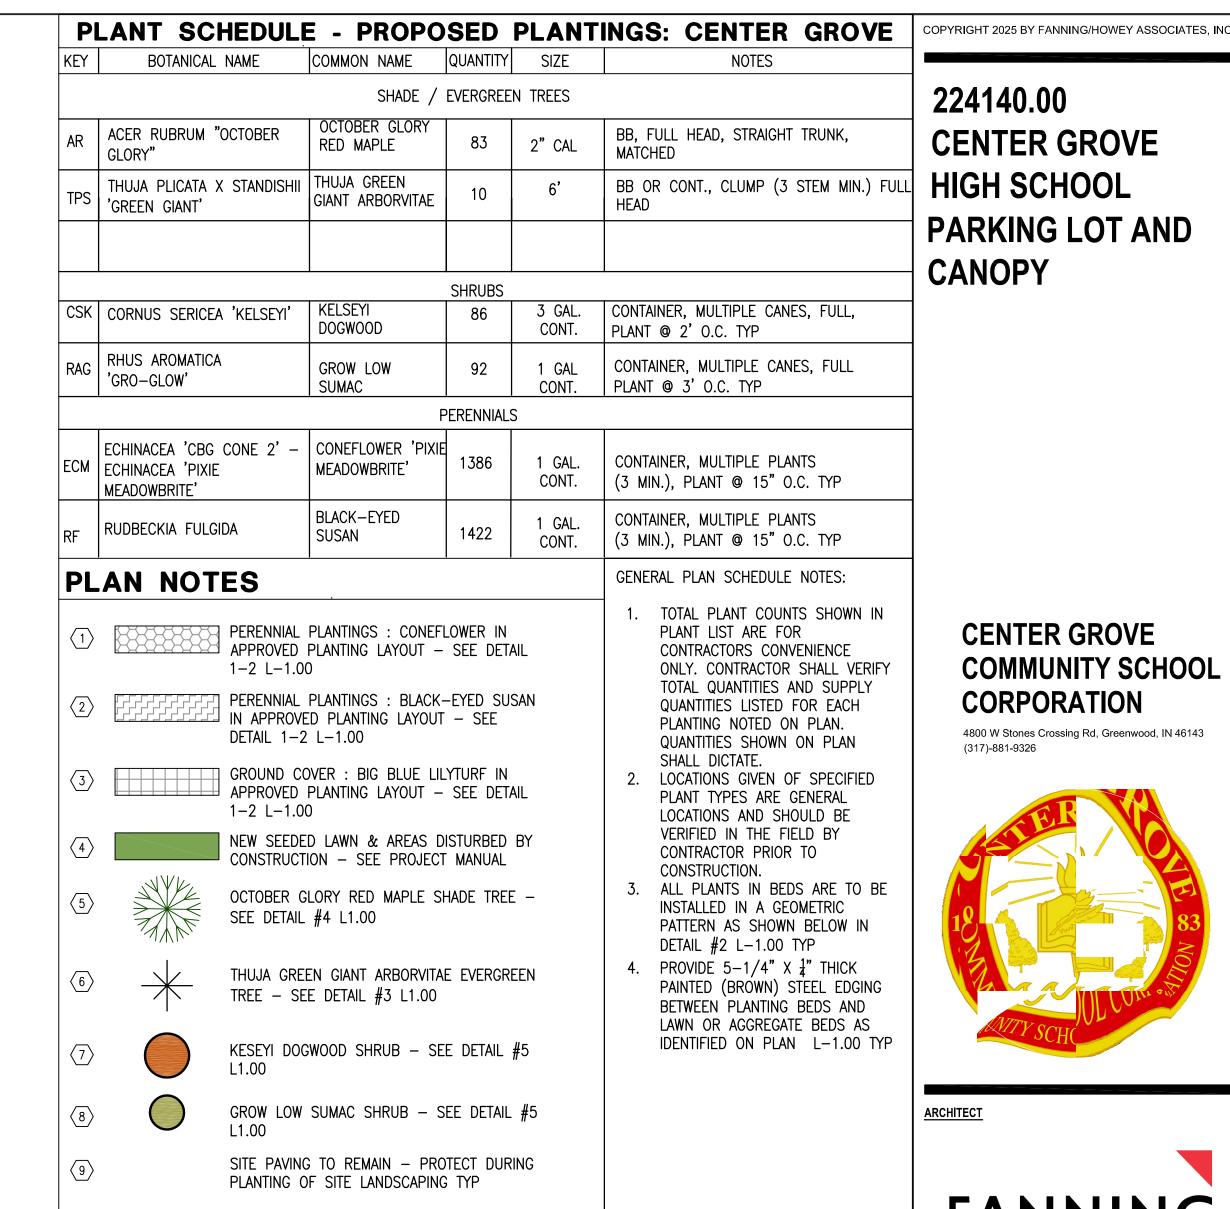


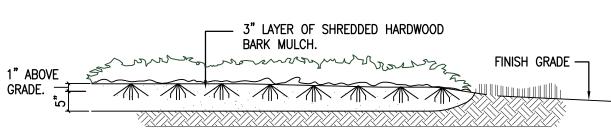


ALL PROPOSED NED AND RENOVATED PLANTING BEDS: EX SOIL BASE PROFILE TO REMAIN TILL EX. SOIL TYP - MIX/TILL IN 2" COMPOSE MATERIAL, 3"PEAT MOSS, AND 3" TOP DRESSING OF MULCH — PLANTING BED FINISH GRADE ELEVATION TO BE 1" BELOW ADJACENT

PROVIDE 5-1/4" X 4" THICK PAINTED (BROWN) STEEL EDGING BETWEEN PLANTING BEDS AND LAWN OR AGGREGATE BEDS AS IDENTIFIED ON PLAN - INSTALL PER MANUF. WRITTEN

GROUND COVER OR FLOWER BED DETAIL

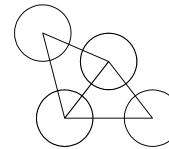

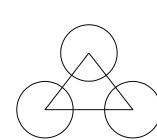


START OF CONSTRUCTION, ALL ASPHALT PAVING NOT NOTED FOR WORK IS TO

REMAIN - PROTECT DURING

CONSTRUCTION TYP.

Call before you dig.

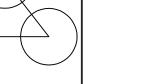

KEY PLAN

317-848-0966

100% CONSTRUCTION DOCUMENTS

CENTER GROVE

CORPORATION

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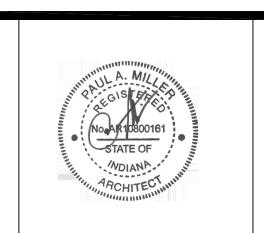
COMMUNITY SCHOOL

4800 W Stones Crossing Rd, Greenwood, IN 46143

FANNING

HOWEY

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PROJECT MANAGER: KS DRAWN BY: EB/LH PROJECT NUMBER: 224140.00

PROJECT CONSTRUCTION ISSUE DATE: 06-06-2025 DESCRIPTION

ADDENDUM #1 06/18/25

SITE LANDSCAPING **PLAN**

PLAN NOTES:

S1) EXISTING LIGHT POLE AT THIS LOCATION IS TO REMAIN IN PLACE.

S2 EXISTING LIGHT POLE AND BASE AT THIS LOCATION IS TO BE DISCONNECTED AND REMOVED.

PROVIDE A NEW LIGHT POLE ON A PRECAST CONCRETE BASE AT THIS LOCATION. POLE IS TO BE A 25'-0" TALL SQUARE POLE, PAINTED BLACK. PRECAST BASE AND POLE ARE PROVIDED BY THE ELECTRICAL CONTRACTOR AND THE LIGHT FIXTURE HEAD(S) ARE PROVIDED BY ENERGY HARNESS. PRECAST BASE IS TO MATCH THE EXISTING BASES.

RUN TWO 2" CONDUITS FROM EXISTING PANELBOARDS APHM AND APLM (ONE FROM EACH PANELBOARD), ABOVE THE CEILING THEN DOWN THE WALL CAVITY TO BELOW GRADE, THEN OUT TO THE POWER PULL BOX.

RUN A 2" CONDUIT FROM ABOVE THE CEILING TO THE WALL, THEN DOWN THE WALL CAVITY TO BELOW THE GRADE THEN OUT TO THE DATA PULLBOX.

S6 WIRE NEW GATE TO SPARE 20A, 1-POLE CIRCUIT IN EXISTING PANELBOARD "APLM" RUN THROUGH THE NEW POWER PULLBOX.

S7 WIRE NEW LIGHTING TO A SPARE 20, 1-POLE CIRCUIT IN EXISTING PANELBOARD "APHM". RUN THROUGH THE NEW POWER PULL BOX.

S8) WIRE EXISTING LIGHTING TO A SPARE 20A, 1-POLE CIRCUIT IN EXISTING PANELBOARD "APHM". RUN THROUGH THE NEW POWER PULL BOX.

EXISTING LIGHT POLE AT THIS LOCATION IS TO BE RELOCATED TO THE SOUTH TO MISS THE NEW SIDE WALK. PROVIDE A NEW CONCRETE BASE FOR LIGHT POLE AT LOCATION SHOWN.

PROVIDE A 2" PVC CONDUIT RUNNING TO LIGHT POLE FOR FUTURE CAMERA CABLING.

S11 PROVIDE A 2"PVC CONDUIT RUNNING TO LIGHT POLE WITH A 120V POWER FOR FUTURE CAMERA POWER.

RUNS FROM THE NEW DATA PULLBOX, BACK TO THE AP DATA ROOM IN THE EXISTING BUILDING.


RUN AN INDIVIDUAL OM4 MULTI-MODE 6 PAIR FIBER FROM NEW DATA PULLBOX TO LIGHT POLE LOCATION.

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224140.00
CENTER GROVE
HIGH SCHOOL
PARKING LOT
IMPROVEMENTS

CENTER GROVE
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CORPORATION

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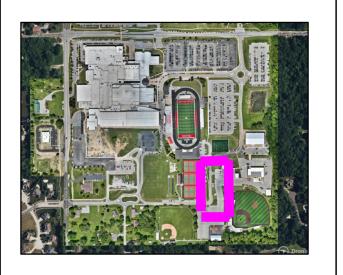


ARCHITECT

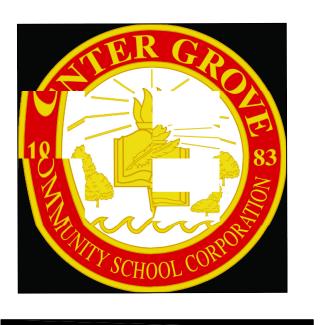


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KEY PLAN

<u>(EY PLAN</u>



100% CONSTRUCTION DOCUMENTS

PROJECT MANAGER: KS

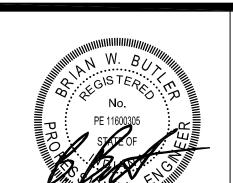DRAWN BY: RR

PROJECT NUMBER: 224140.00

REV. NO.	DESCRIPTION	DATE
1	ADDENDUM #1	06-18-2025

PROJECT CONSTRUCTION ISSUE DATE: 06-06-2025

ELECTRICAL SITE PLAN

E1.01

Know what's below.
Call before you dig.
Call 811 or 1-800-382-5544 Before You Begin Any Digging Proje
Call 48 hours or 2 working days before you dig.
It's Fast, it's Easy and it's the Lawin the state of indianal.

CAUTION!!

THE LOCATIONS OF ALL EXISTING UNDERGROUND UTILITIES SHOWN ON THE PLAN ARE BASED UPON ABOVE GROUND EVIDENCE (INCLUDING, BUT NOT LIMITED TO, MANHOLES, INLETS, VALVES, AND MARKS MADE UPON THE GROUND BY OTHERS) AND ARE SPECULATIVE IN NATURE. THERE MAY ALSO BE OTHER EXISTING UNDERGROUND UTILITIES FOR WHICH THERE IS NO ABOVE GROUND EVIDENCE OR FOR WHICH NO ABOVE GROUND EVIDENCE WAS OBSERVED. THE EXACT LOCATIONS OF EXISTING UNDERGROUND UTILITIES SHALL BE VERIFIED BY CONTRACTOR PRIOR TO ANY AND ALL CONSTRUCTION.

LOCATIONS GIVEN ARE APPROXIMATE AND ARE TO BE SITE VERIFIED PRIOR TO THE START OF CONSTRUCTION. ALL ASPHALT PAVING NOT NOTED FOR WORK IS TO REMAIN UNDERGROUND UTILITIES FOR ARE GROUND EVIDENCE OR FOR PROTECT DURING CONSTRUCTION TYP.

1" = 40'-0"