

Floyd County Annex Renovation

for

Floyd County, Indiana

Addendum No. 02

OWNER's TECHNICAL REP



Envoy, Inc.

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Fishers, Indiana 46308
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ARCHITECT / ENGINEER

LMH Architecture + MAR Architects
319 Bank Street
New Albany, Indiana 47150
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July, 08, 2025

Project: Floyd County Annex Renovation

Date: July 08, 2025

By: Envoy, Inc.

ADDENDUM

Number: 01

This addendum is based in accordance with the provisions of "The General Conditions of the Contract for Construction," Article 1, "Contract Documents" and becomes a part of the Contract Documents as provided therein. Bids will be received at the Floyd County in the Commissioner's Office located at 2524 Corydon Pike, Suite 104, New Albany, IN 47150 until **6:00 p.m.** (local time) on **Tuesday July 15, 2025.**

Included with this Addendum are the following Notes and Clarifications:

- 1. Updated drawings set with information on finishes, fire-rated doors, ceiling heights, bulkheads, and existing MEP fixtures. Please read all clouded notes and comments on the architectural and MEP drawings.**



FLOYD COUNTY ANNEX RENOVATION 2ND & 3RD FLOORS

120 W SPRING ST
NEW ALBANY, INDIANA



BID SET

FLOYD COUNTY
ANNEX
RENOVATION 2ND
& 3RD FLOORS 120
W. SPRING

NEW ALBANY INDIANA

COVER

REVISIONS

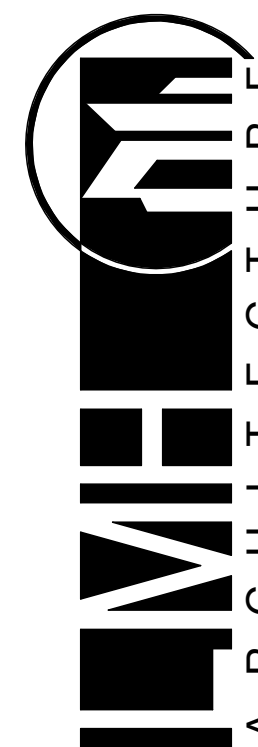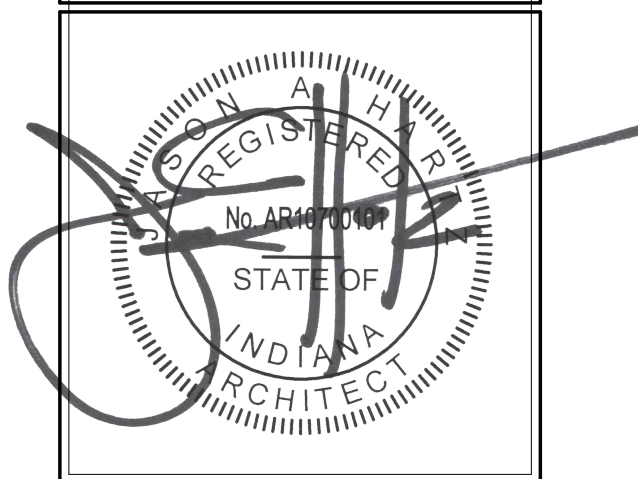

LMH ARCHITECTURE + MAP ARCHITECTS
12808 TOWNPARK WAY, SUITE 200
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502.581.0570
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PROJECT NUMBER

FCI2501

DATE

JUNE 12, 2025

SHEET NUMBER

COVER

	APPLICABLE CODES	BUILDING CLASSIFICATION	SHEET INDEX																																																																																																																																																
	<p>BUILDING CODE: 2014 INDIANA BUILDING CODE (2012 IBC WITH AMENDMENTS)</p> <p>LIFE SAFETY CODE: 2012 NFPA 101 – LIFE SAFETY CODE</p> <p>ACCESSIBILITY CODE: 2009 ANSI A117.1 WITH AMENDMENTS</p> <p>FIRE CODE: 2014 INDIANA FIRE CODE (2012 INTERNATIONAL FIRE CODE)</p> <p>PLUMBING CODE: 2012 INDIANA PLUMBING CODE (2006 INTERNATIONAL PLUMBING CODE WITH AMENDMENTS)</p> <p>MECHANICAL CODE: 2014 INDIANA MECHANICAL CODE (2012 INTERNATIONAL MECHANICAL CODE)</p> <p>ELECTRICAL CODE: 2009 INDIANA ELECTRIC CODE (2008 NFPA 70 – NATIONAL ELECTRIC CODE)</p> <p>ENERGY CODE: 2010 INDIANA ENERGY CONSERVATION CODE (2007 ASHRAE 90.1)</p> <p>FUEL AND GAS CODE: 2014 INDIANA FUEL GAS CODE (2012 NATIONAL FUEL GAS CODE)</p>	<p>OCCUPANCY: CLASSIFICATION (I.B.C): NFPA 101</p> <p>FULLY SPRINKLED: PER NFPA 13</p> <p>TYPE OF CONSTRUCTION: INTERNATIONAL BUILDING CODE: NFPA 101 LIFE SAFETY CODE:</p> <p>PROJECT SQUARE FOOTAGE</p> <p>SECOND FLOOR THIRD FLOOR FOURTH FLOOR</p> <p>TOTAL</p>	<p>GENERAL COVER X1</p> <p>ARCHITECTURAL</p> <p>A1.1 A2.1 A3.1 A3.2 A5.1 A11.1 A14.1 A15.1</p> <p>HVAC</p> <p>H-0.01 H-1.01 H-2.01 H-4.01 H-5.01</p> <p>ELECTRICAL</p> <p>EO.01 E2.21 E-1.01 E-1.11 E-1.21 E-2.01 E-2.11 E-4.01</p> <p>FIRE PROTECTION</p> <p>FP-0.01 FP-1.01 FP-2.01</p>																																																																																																																																																
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FLOYD COUNTY
ANNEX
RENOVATION 2ND
& 3RD FLOORS 120
W. SPRING

NEW ALBANYINDIANA

CODE CRITERIA -
LEGENDS AND
ABBREVIATIONS

REVISIONS

LMH ARCHITECTURE
ARCHITECTURE + MAF ARCHITECTS

12808 TOWNEPARK WAY, SUITE 200
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502.581.0570
WWW.LMHARCHITECTURE.COM

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NEW ALBANY, IN 47150
812.945.2324

PROJECT NUMBER


FCI2501

DATE

JUNE 12, 2025


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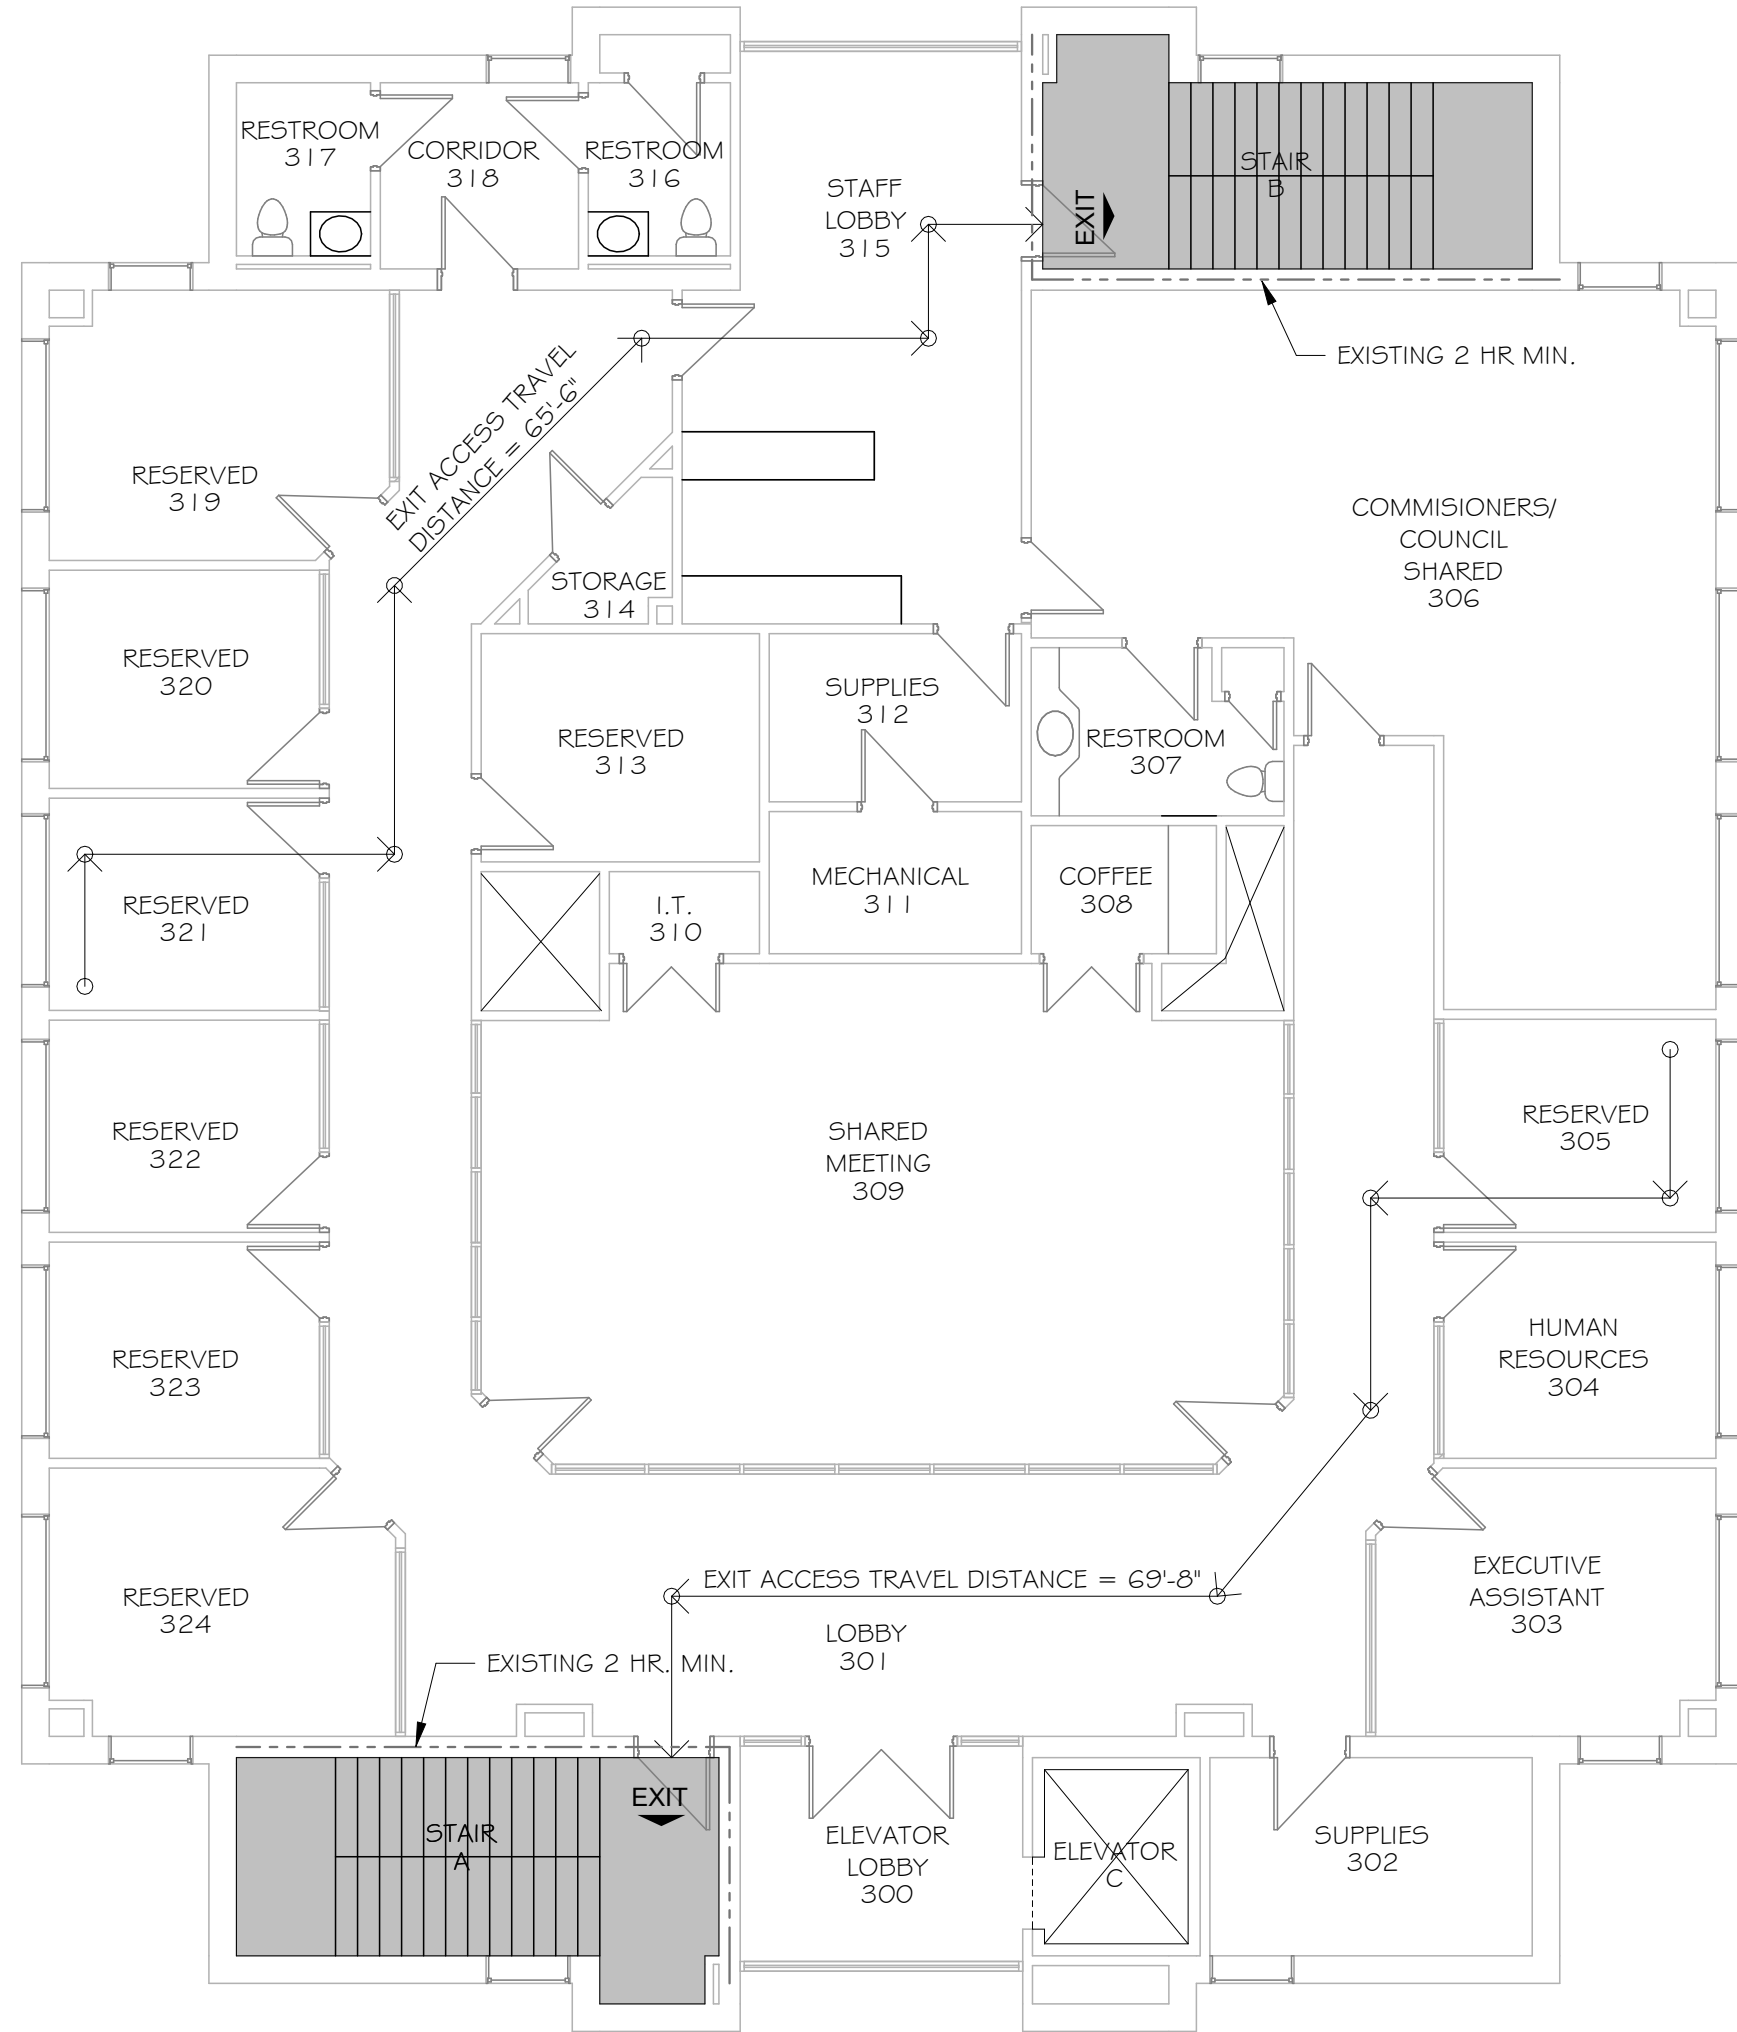
LIFE SAFETY PLAN - FIRST FLOOR

SCALE: 1/8" = 1'-0"

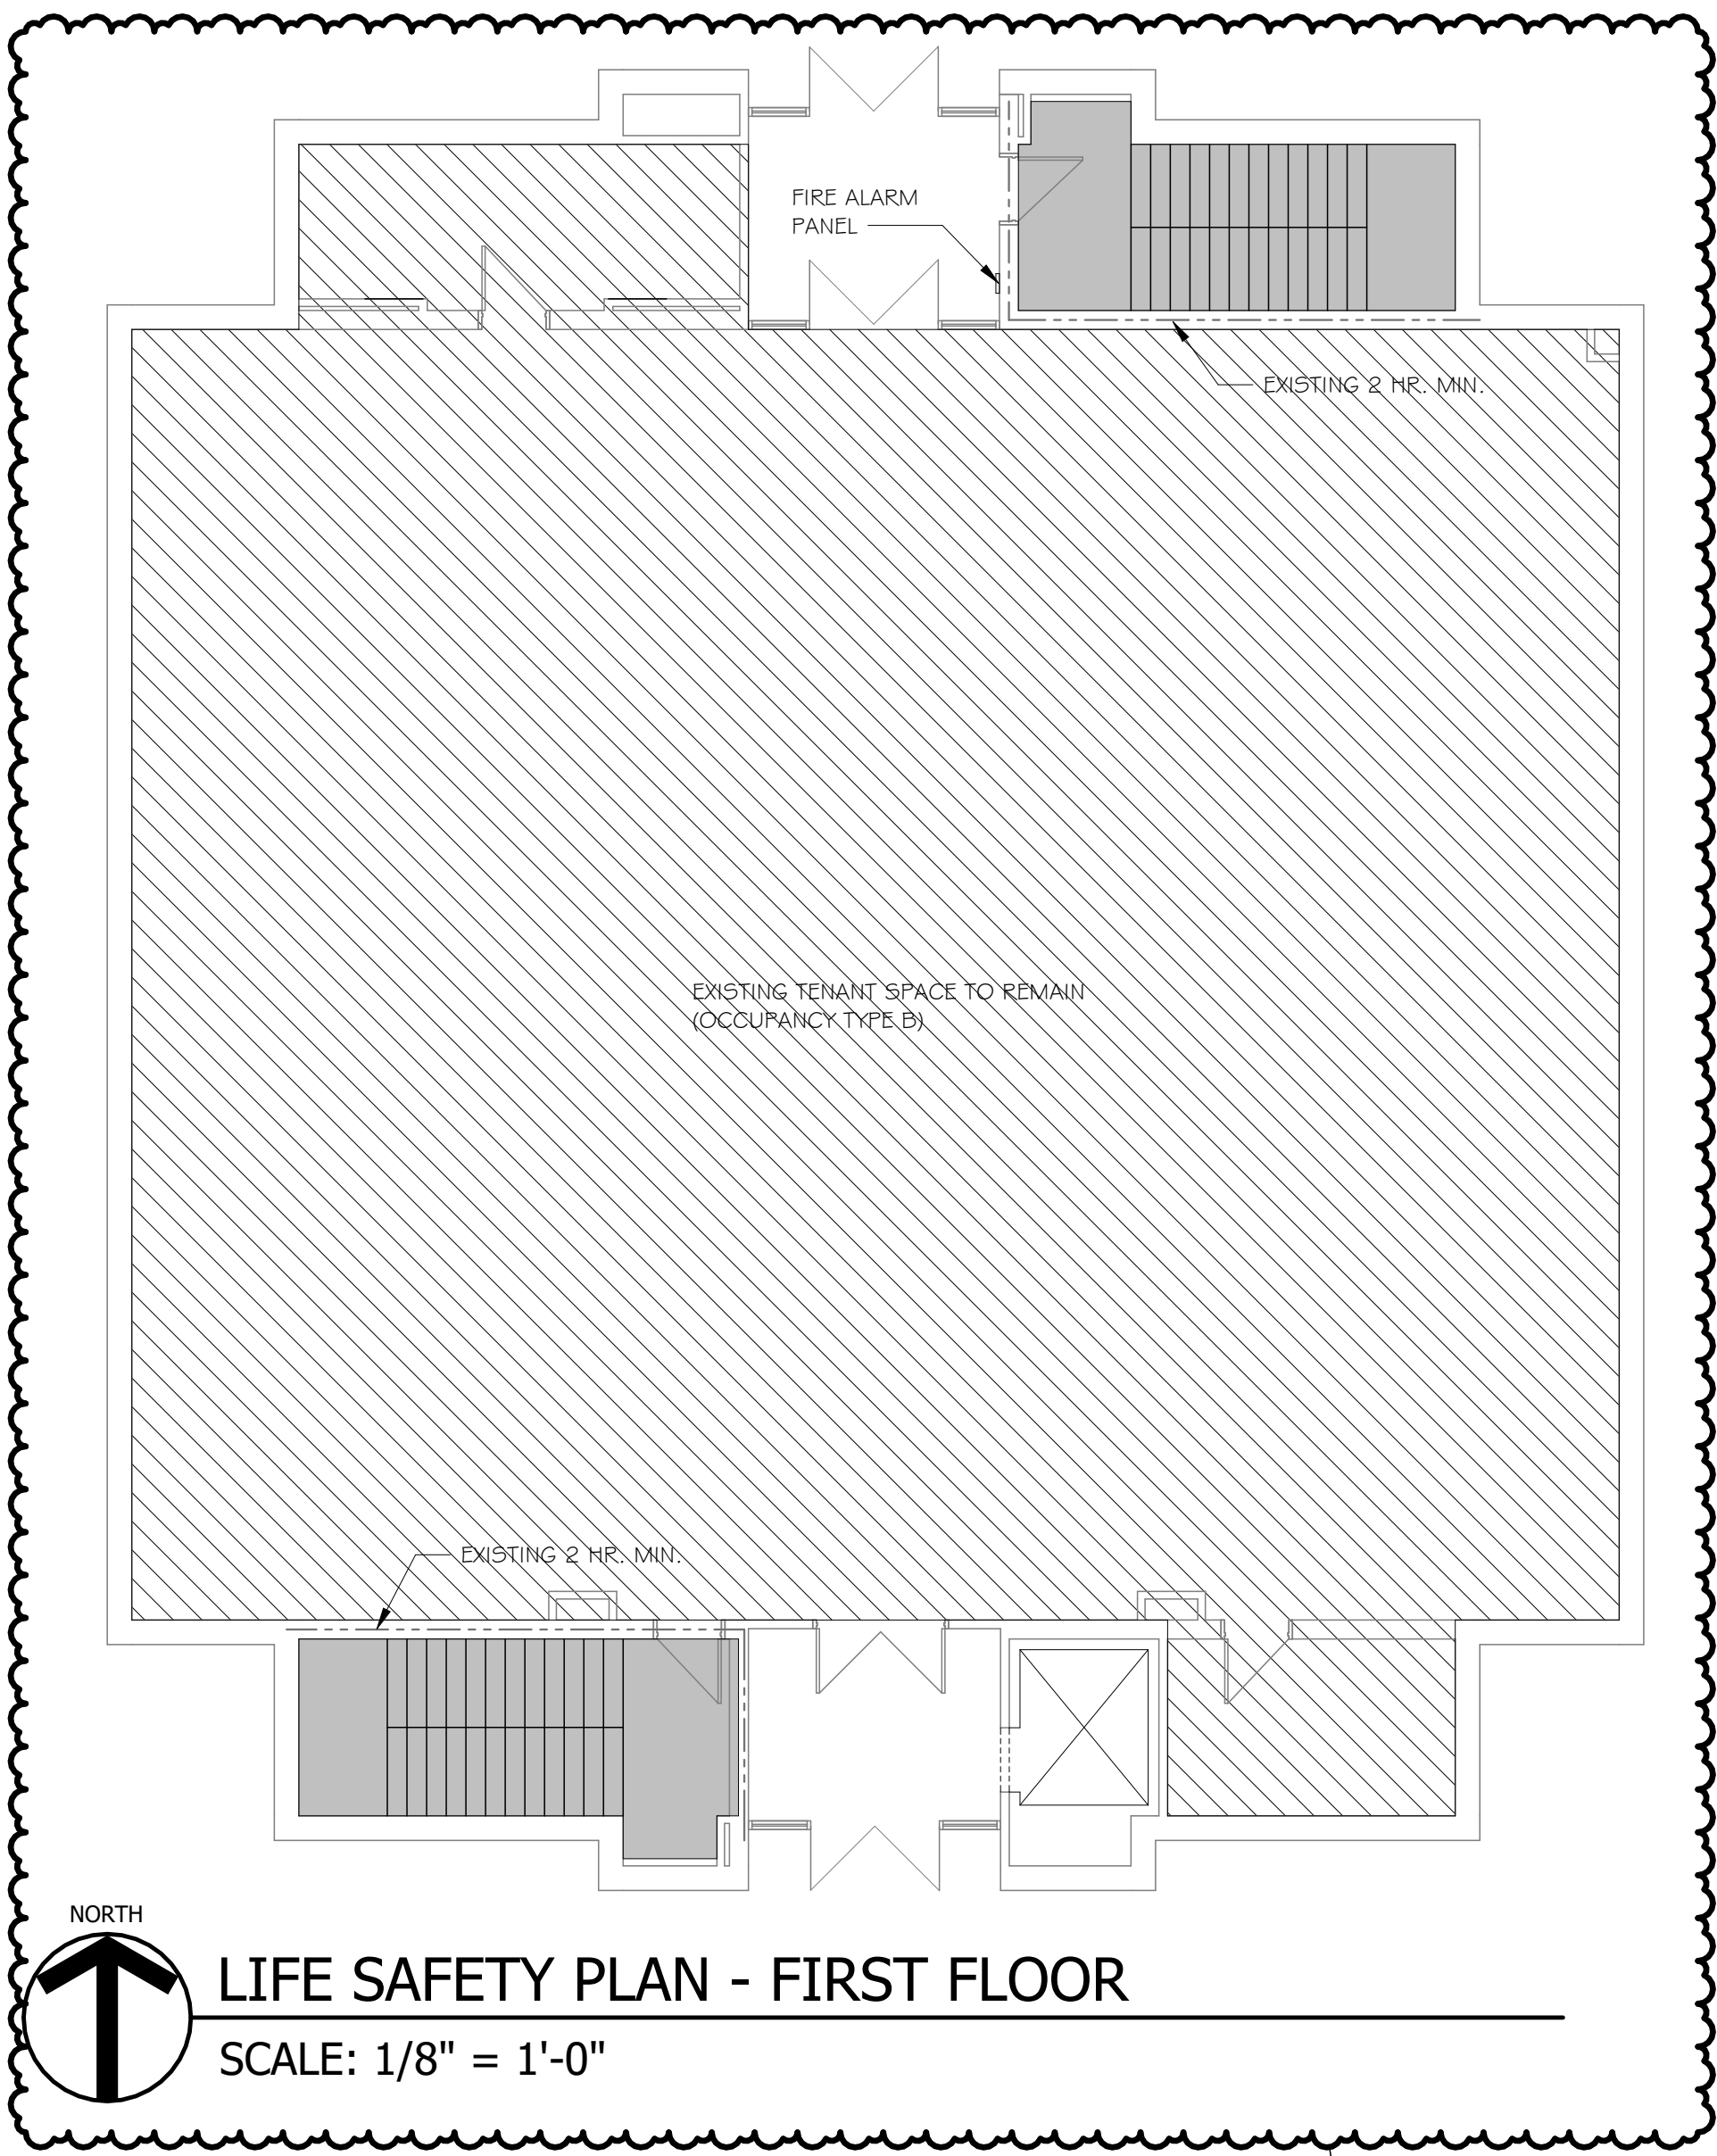

LIFE SAFETY PLAN - SECOND FLOOR

SCALE: 1/8" = 1'-0"

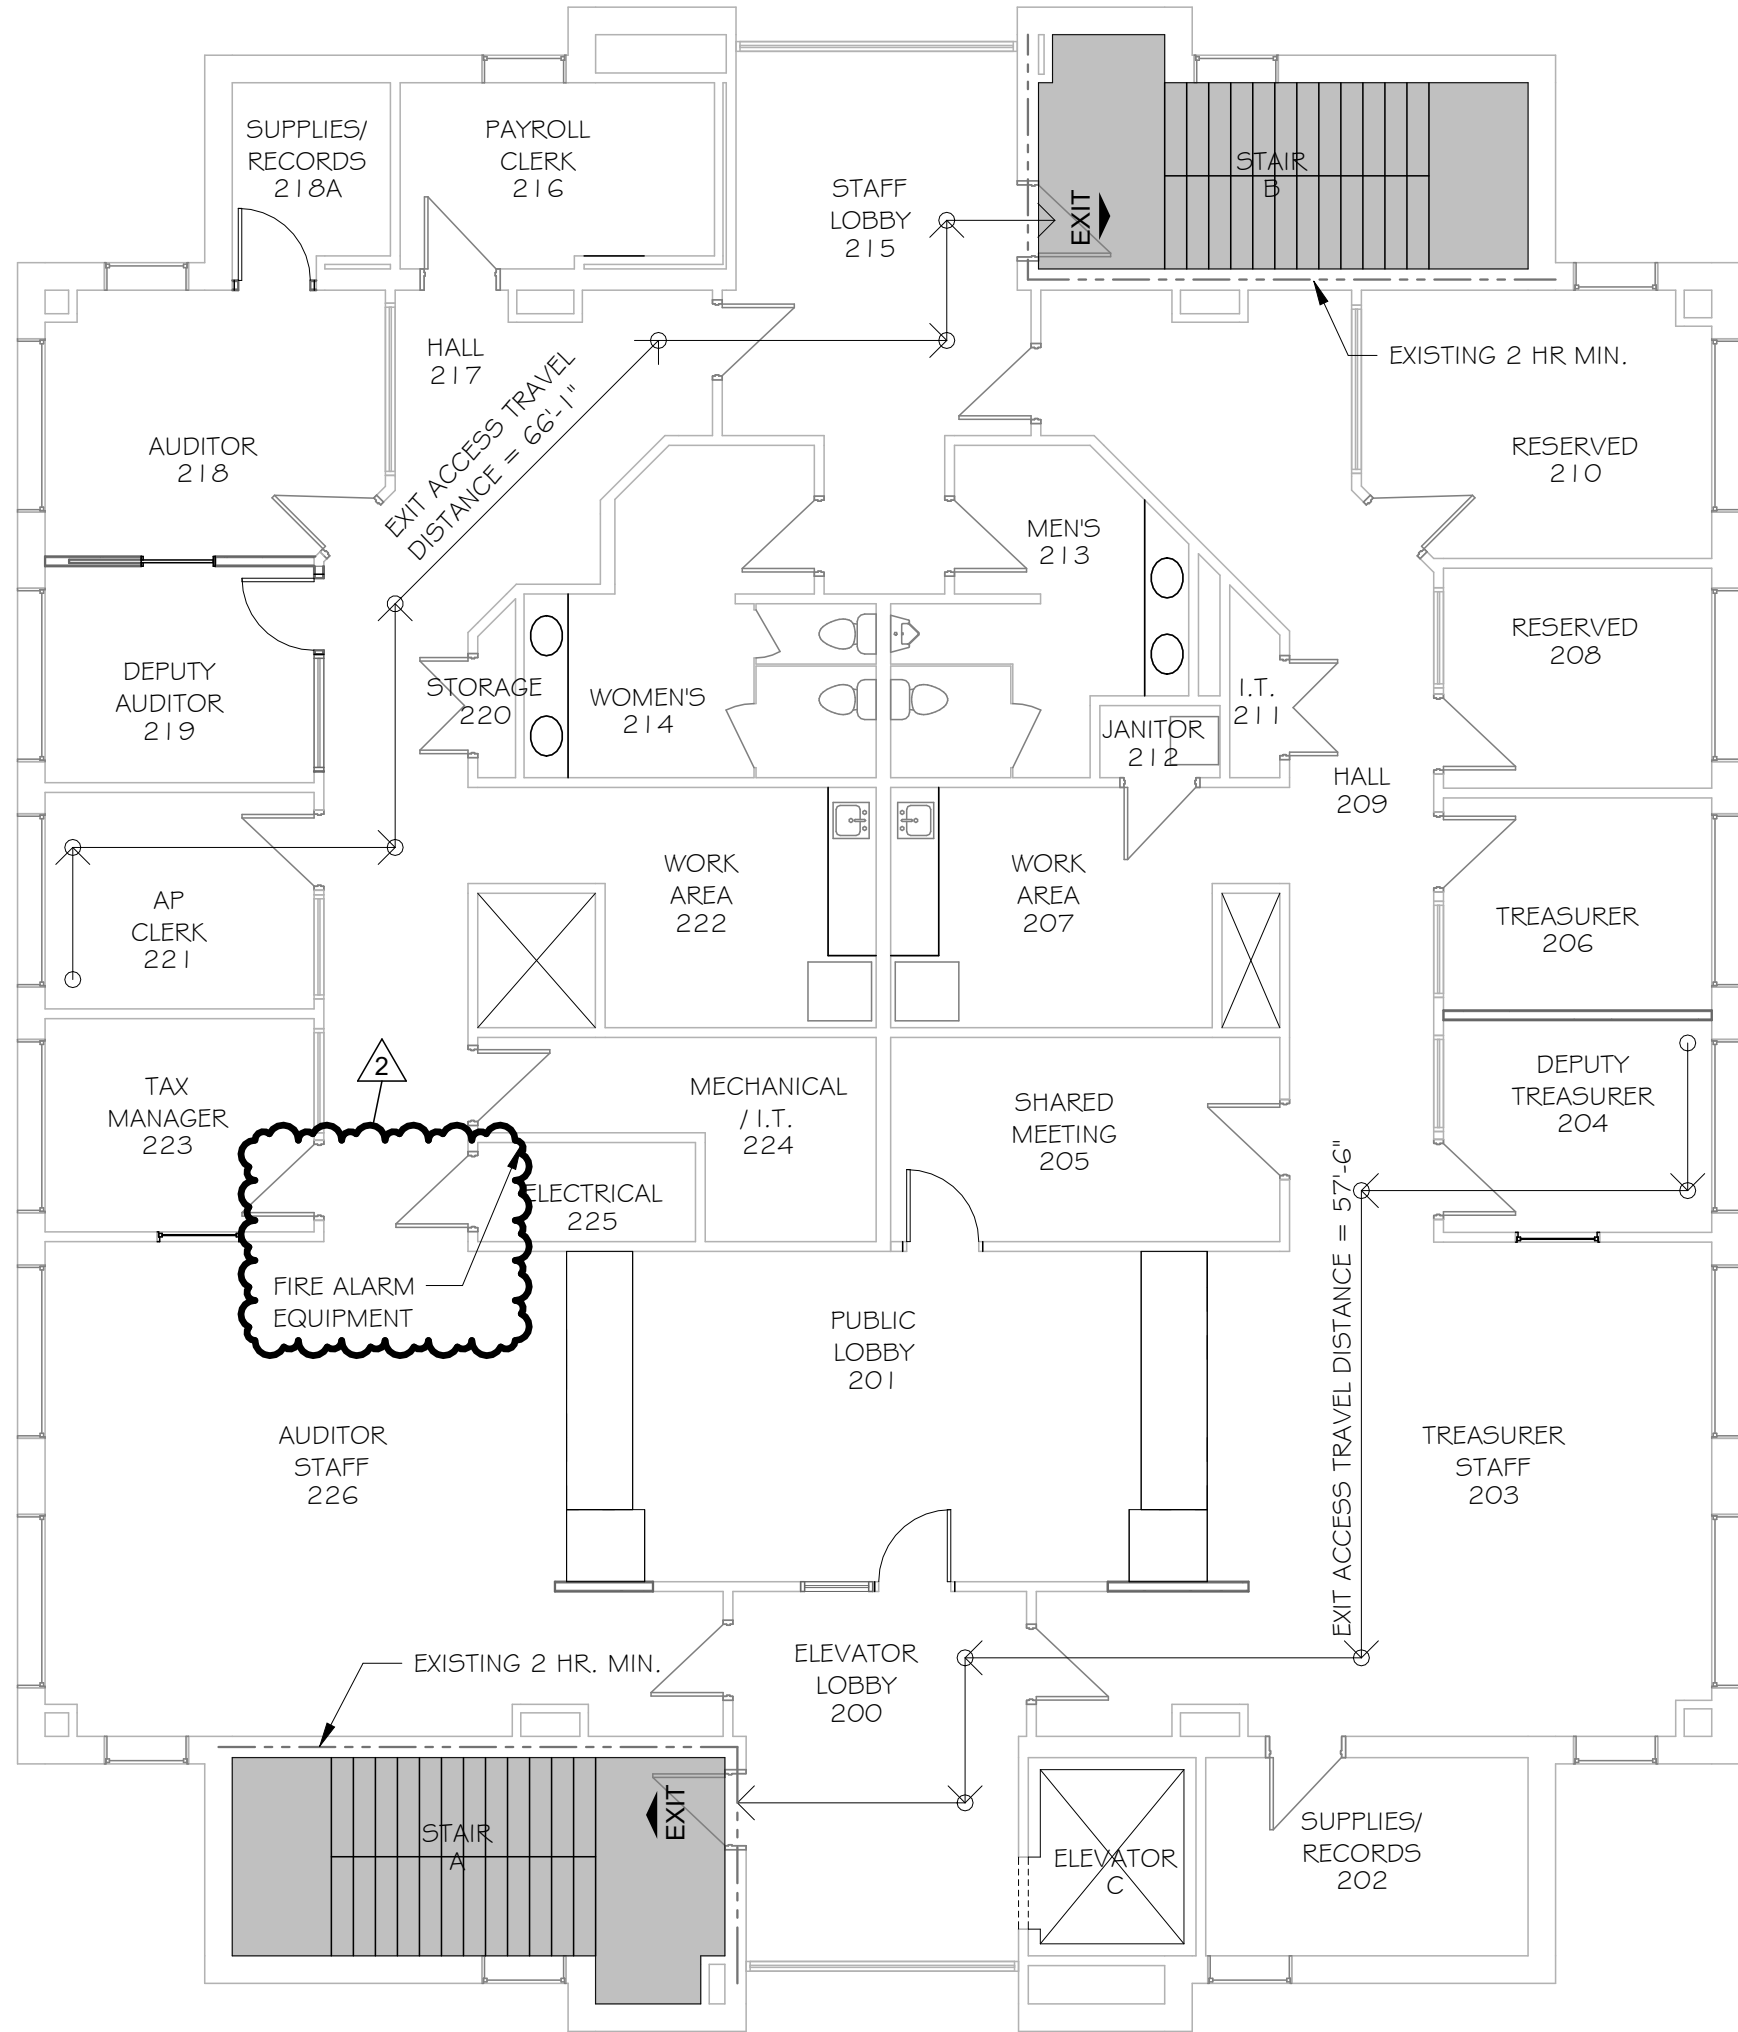

LIFE SAFETY PLAN - THIRD FLOOR

SCALE: 1/8" = 1'-0"

LIFE SAFETY LEGEND

2 HOUR FIRE RATED BARRIER

NEW
EXISTING

EXIT ACCESS STAIR

NEW/EXISTING

WALLS SHALL FORM A BARRIER TO LIMIT THE TRANSFER OF SMOKE

RATED STAIR DOORS - CONSTRUCTED TO RESIST THE PASSAGE OF SMOKE. DOORS HARDWARE SHALL BE POSITIVE LATCHING WITH THE EXCEPTION OF TOILET ROOMS, BATHROOMS, SHOWER ROOMS, SINK CLOSETS, AND SIMILAR AUXILIARY SPACES THAT DO NOT CONTAIN FLAMMABLE OR COMBUSTIBLE MATERIALS.

34 CLEAR EGRESS WIDTH

TABLE OF EXIT CAPACITY


COMPARTMENT	AREA	OCCUPANCY CLASSIFICATION	SQUARE FEET PER OCCUPANT	NUMBER OF OCCUPANTS	INCHES PER OCCUPANT	INCHES REQUIRED OTHER EGRESS	INCHES PROVIDED
SECOND FLOOR	4,690 SF	GROUP B	1.00	47	0.2	10"	72"
THIRD FLOOR	4,690 SF	GROUP B	1.00	47	0.2	10"	72"
TOTAL	9,380 SF		1.00	94	0.2	20"	72"

FLOYD COUNTY
ANNEX
RENOVATION 2ND
& 3RD FLOORS 120
W. SPRING

NEW ALBANY INDIANA

LIFE SAFETY PLAN

REVISIONS
2 ADDENDUM #2 07.07.25

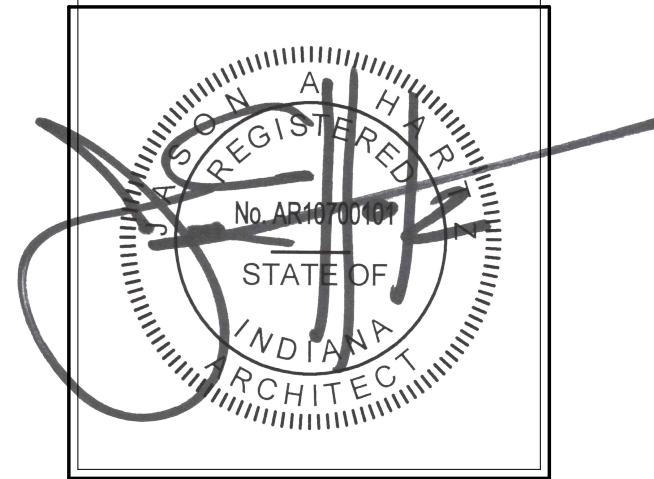

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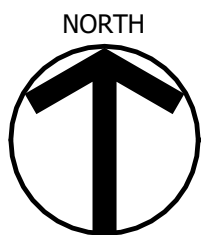
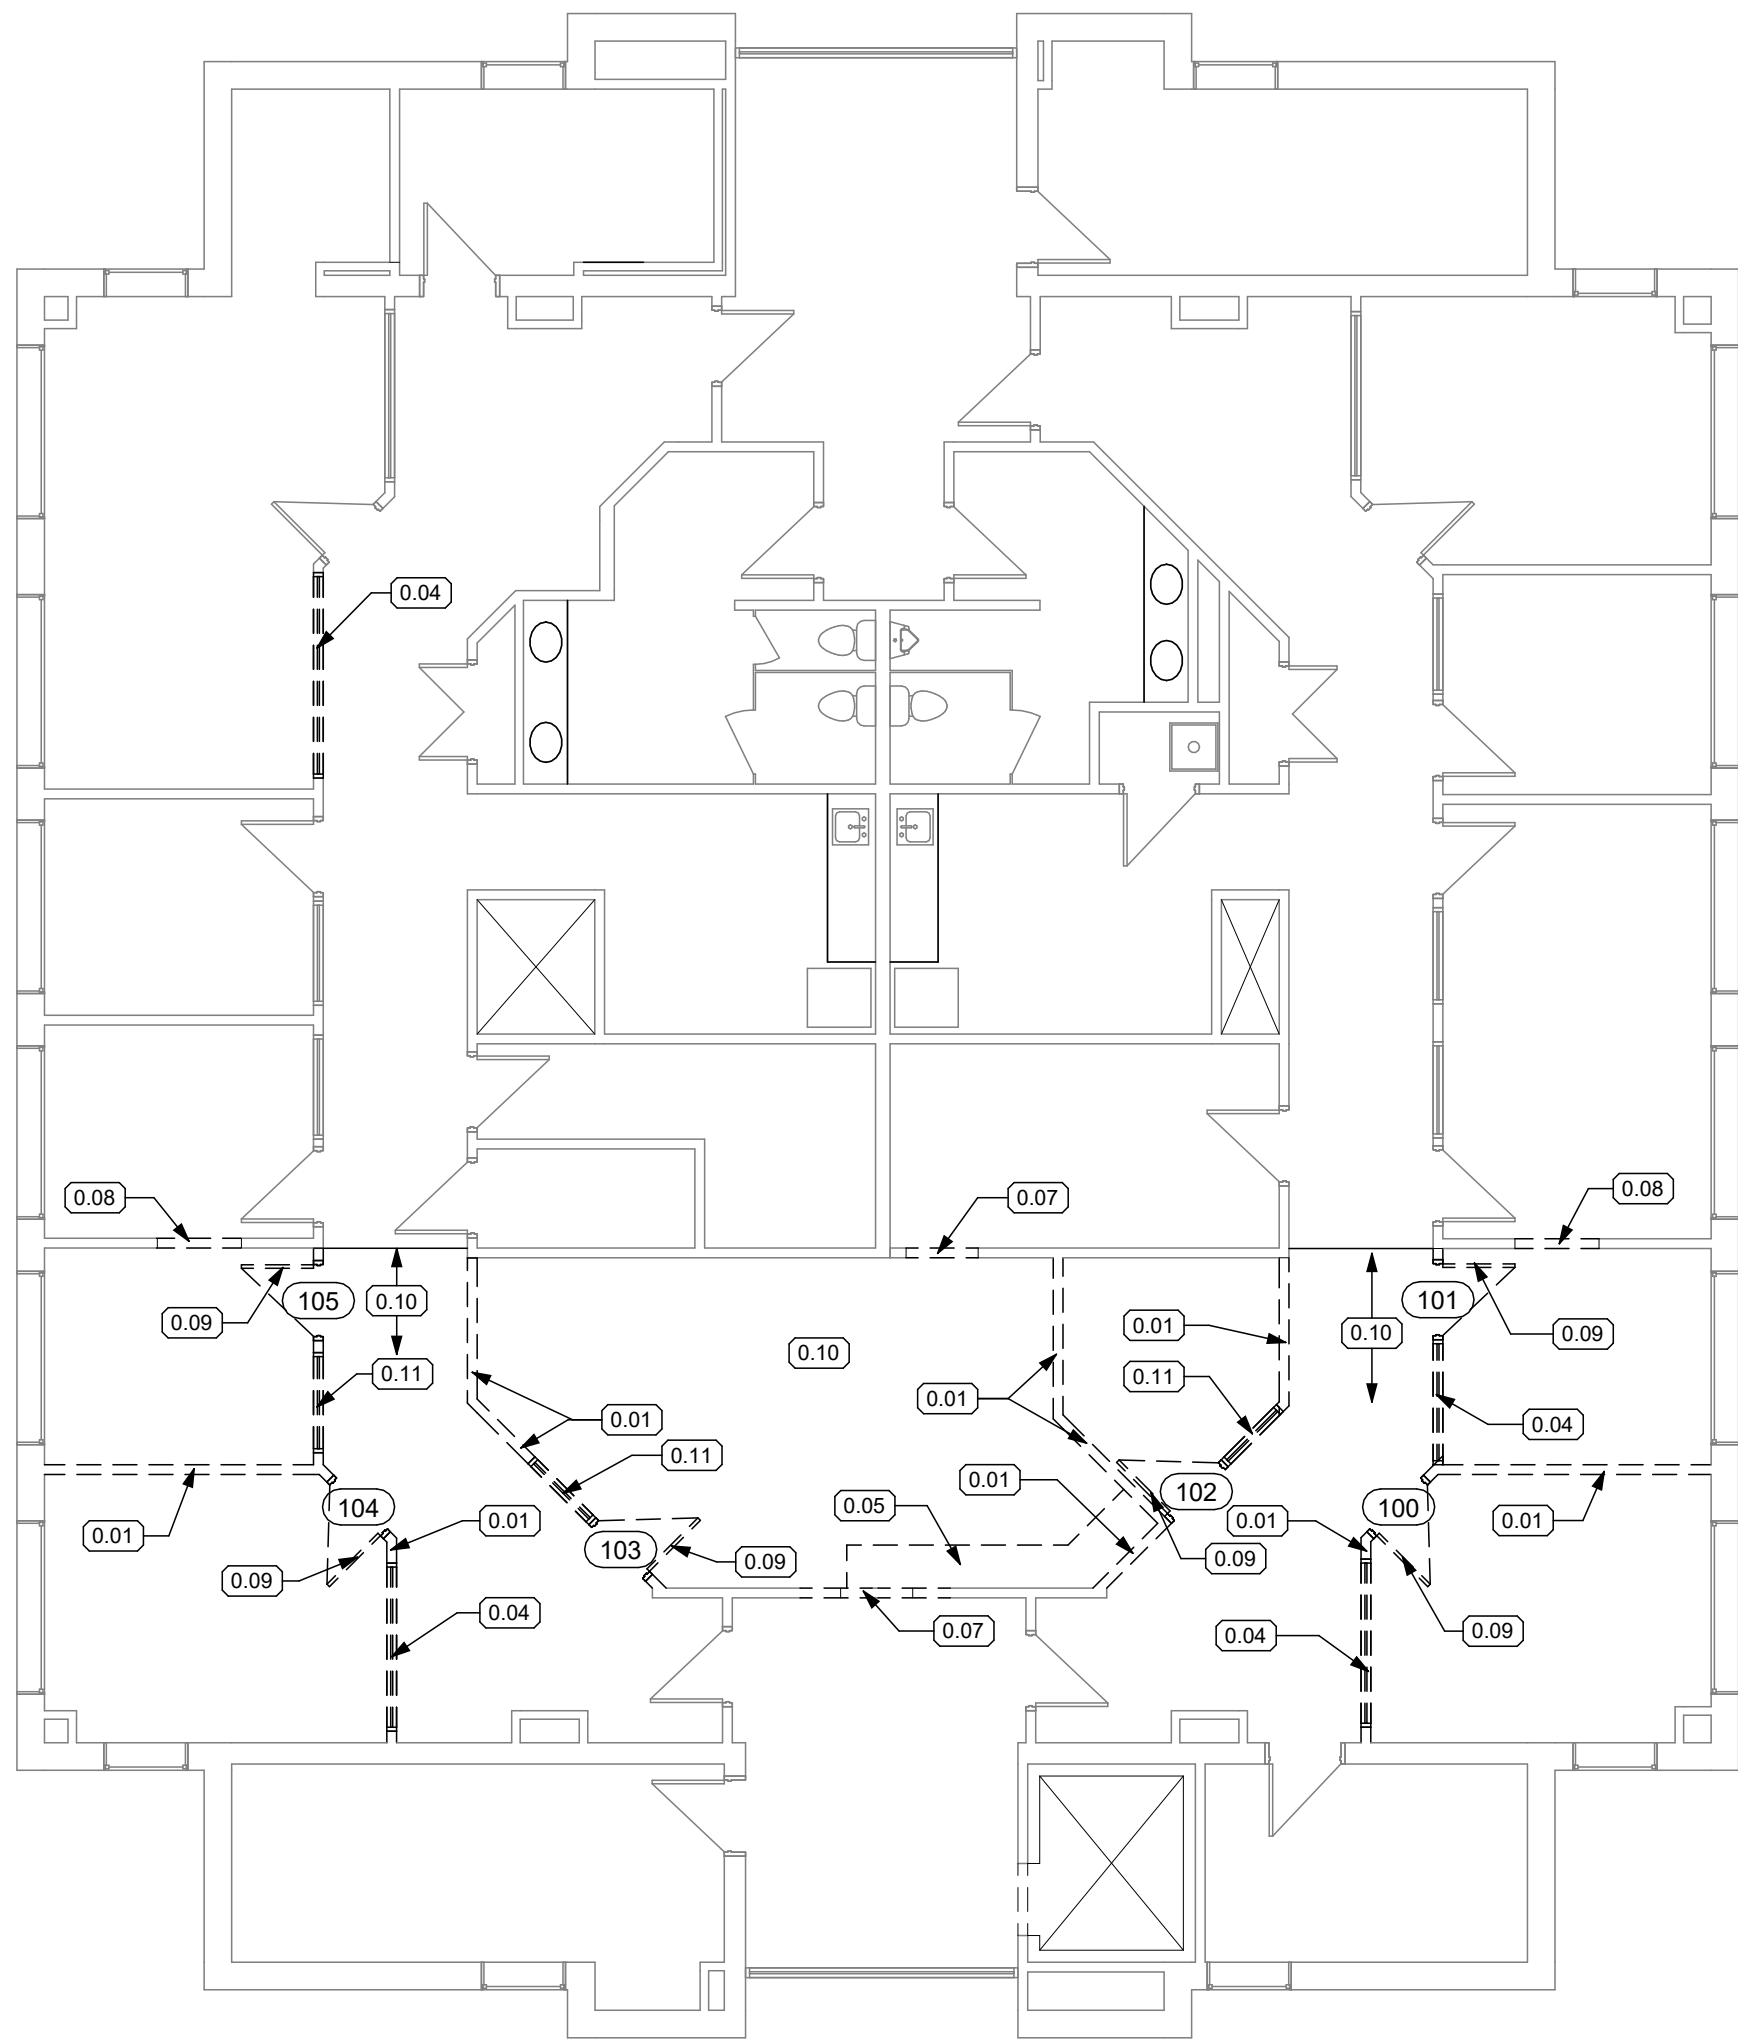
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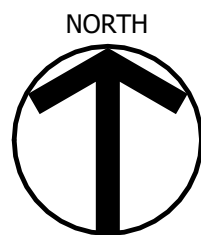
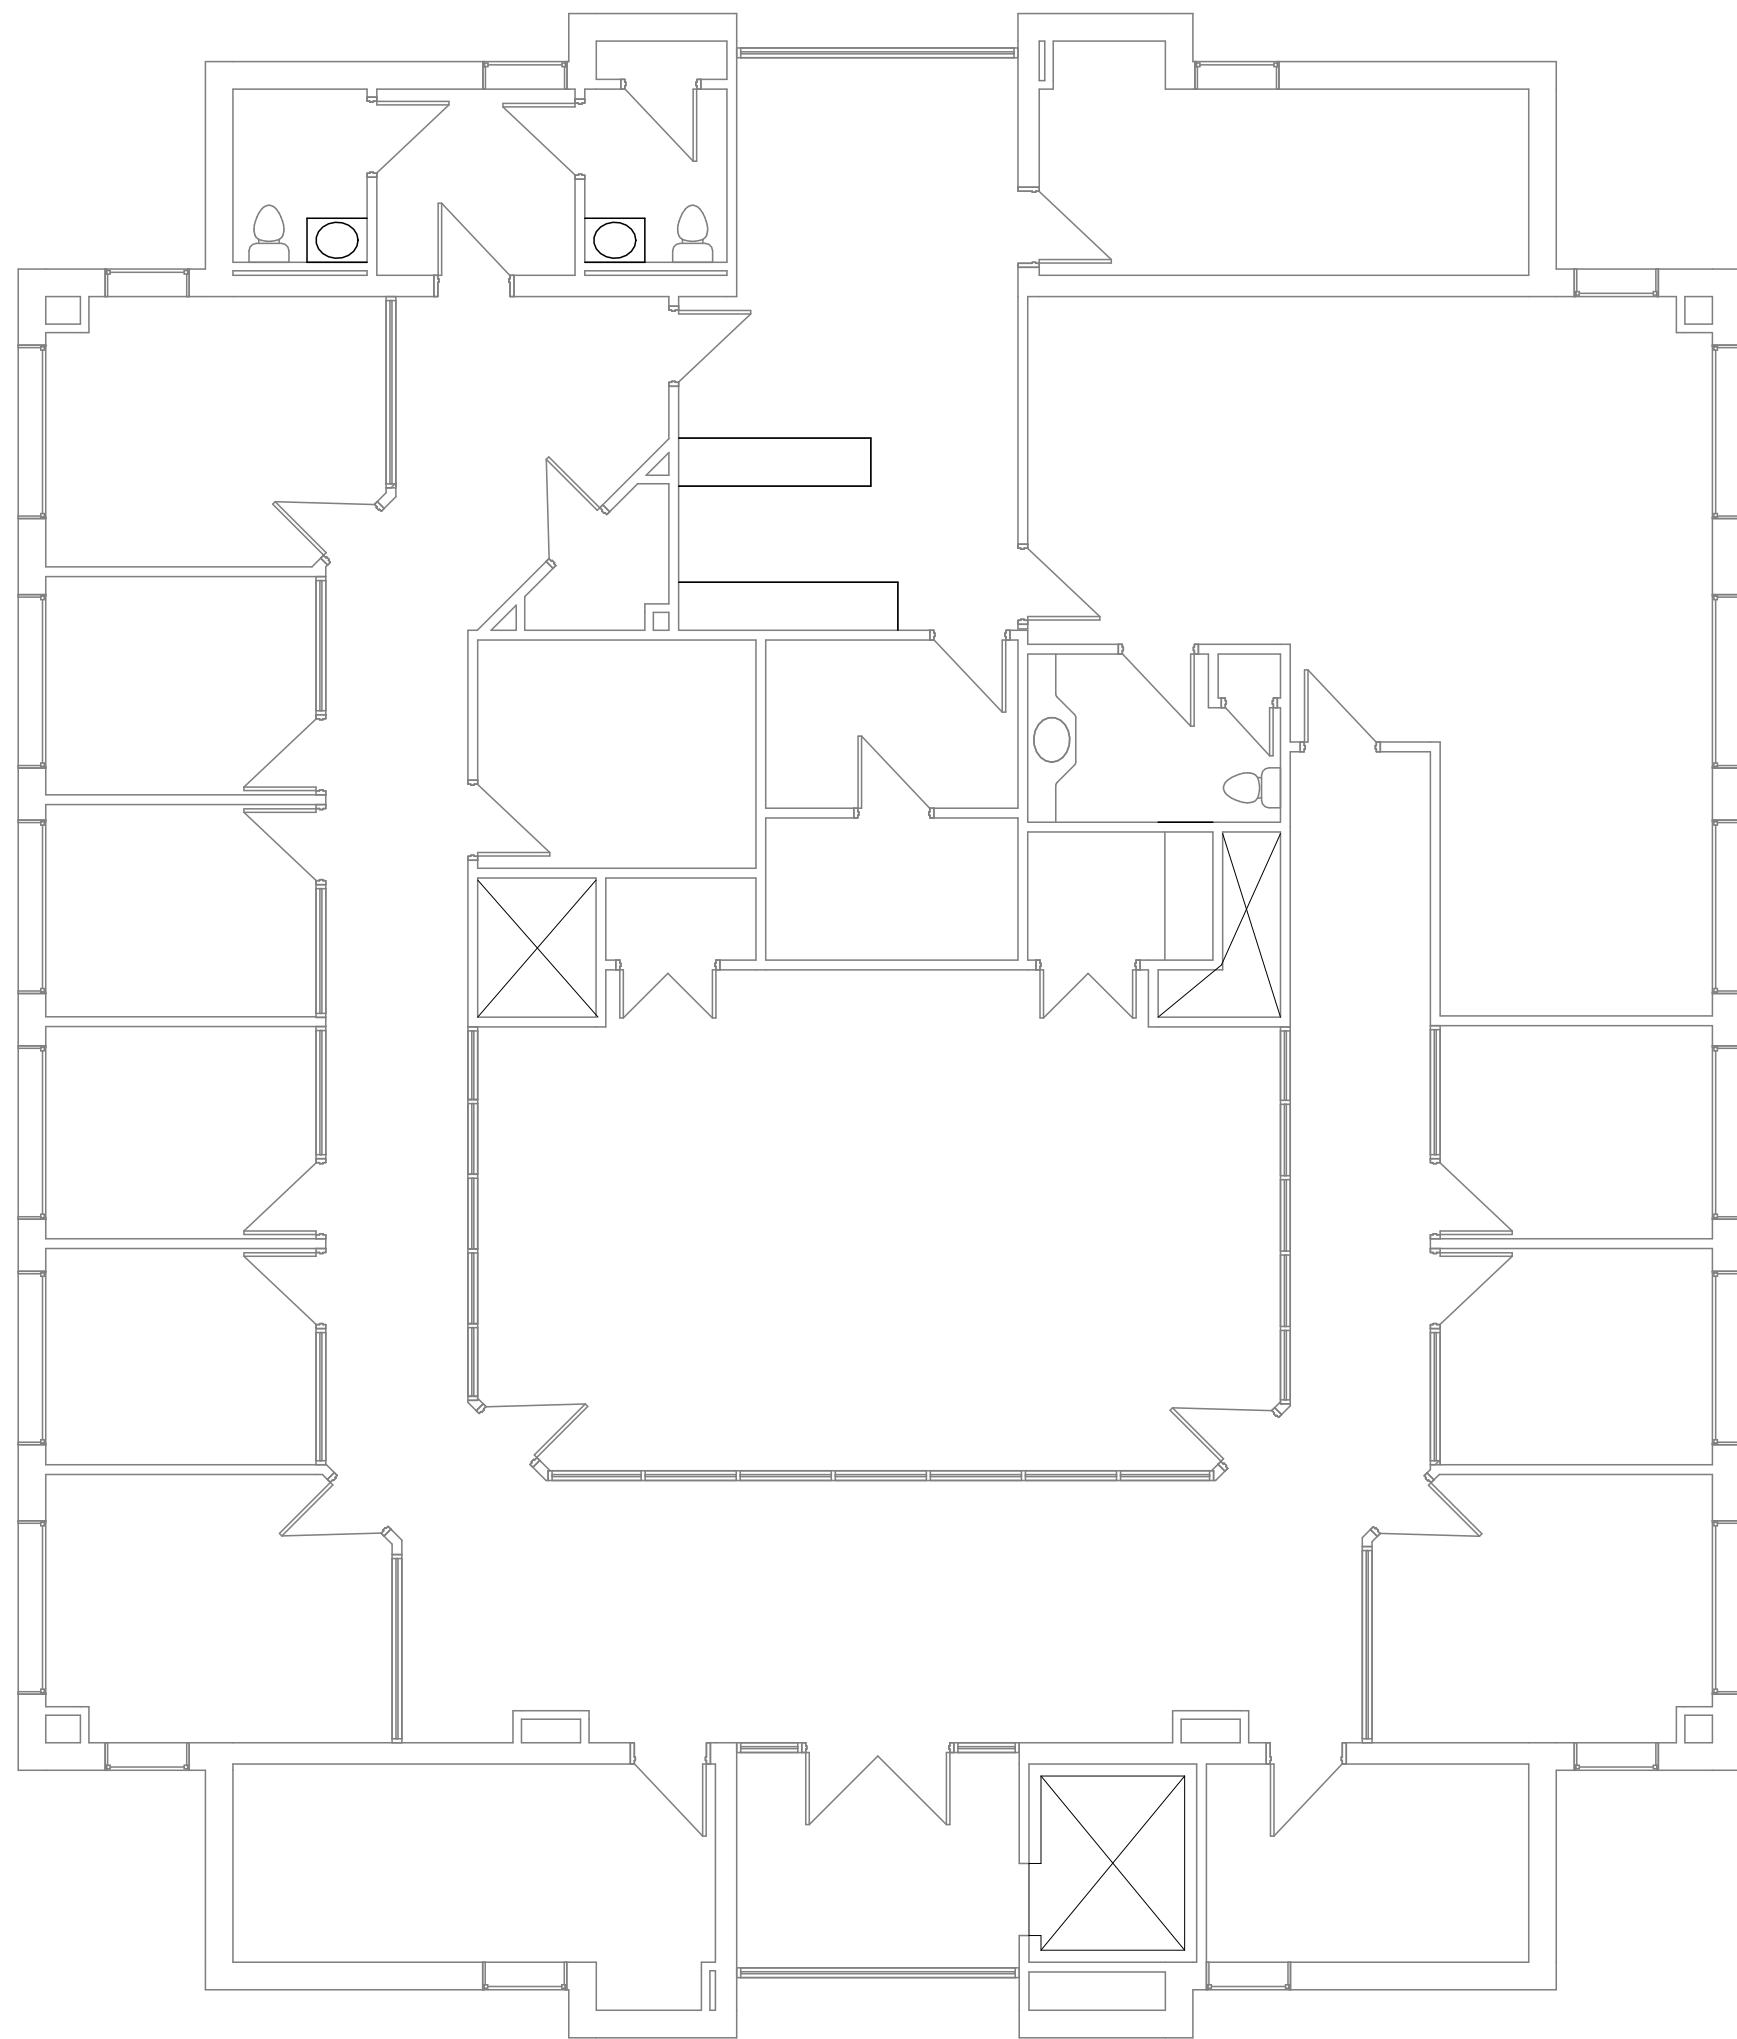
SHEET NUMBER

A1.1



DEMOLITION PLAN - SECOND FLOOR

SCALE: 1/8" = 1'-0"



DEMOLITION PLAN - THIRD FLOOR

SCALE: 1/8" = 1'-0"

DEMOLITION LEGEND

- EXISTING WALL TO REMAIN
- EXISTING WALL TO BE DEMOLISHED
- EXISTING WALL CONSTRUCTION TO REMAIN
EXISTING DOOR AND FRAME TO REMAIN
- EXISTING WALL CONSTRUCTION TO REMAIN
EXISTING DOOR AND FRAME TO BE REMOVED
- EXISTING WALL CONSTRUCTION TO BE DEMOLISHED
EXISTING DOOR AND FRAME TO BE REMOVED

GENERAL DEMOLITION NOTES

- SCHEDULE DEMOLITION WORK WITH THE OWNER OR OWNER'S REP TO MINIMIZE THE DISRUPTION OF SERVICES AND PROVIDE FOR THE UNINTERRUPTED FUNCTIONING OF THE FACILITY.
- CUT AND PATCH AS REQUIRED FOR INSTALLATION OF WORK ITEMS. REFER TO MECHANICAL, PLUMBING, FIRE PROTECTION, AND ELECTRICAL DOCUMENTS FOR ADDITIONAL CUTTING REQUIREMENTS.
- PROVIDE TEMPORARY SUPPORT WHERE DEMOLITION AFFECTS STRUCTURE. PRIOR TO COMMENCING DEMOLITION WORK, NOTIFY ARCHITECT OF FIELD CONDITIONS PRESENTING HAZARD CONDITION FOR BUILDING OR OCCUPANTS.
- REMOVE EXISTING FINISHES AS NECESSARY IN AREAS RECEIVING NEW FINISHES. PROTECT SURROUNDING AREA FINISHES.
- LEGALLY DISPOSE ITEMS REJECTED BY THE OWNER.
- COORDINATE UTILITY SHUT DOWNS AND DISCONNECTS WITH OWNER.
- SALVAGE REQUIRED QUANTITY OF STAINED WOOD TRIM, FLOOR BASE, DOORS, BORROWED LIGHT GLASS AND FRAMES TO REUSE.

DEMOLITION KEYNOTES

- 0.01 REMOVE EXISTING WALL
- 0.02 REMOVE EXISTING DOOR AND TRIM
- 0.03 REMOVE EXISTING DOOR AND TRANSOM
- 0.04 REMOVE EXISTING BORROWED LITE GLASS
- 0.05 REMOVE EXISTING CASEWORK
- 0.06 REMOVE EXISTING PLUMBING FIXTURES
- 0.07 CREATE OPENING IN EXISTING WALL FOR NEW DOOR INSTALLATION
- 0.08 CREATE OPENING IN EXISTING WALL FOR NEW BORROWED LITE INSTALLATION
- 0.09 SALVAGE EXISTING DOOR AND TRIM FOR REUSE
- 0.10 SALVAGE EXISTING CARPET TILE FOR REUSE
- 0.11 SALVAGE EXISTING BORROWED LITE GLASS AND TRIM FOR REUSE

FLOYD COUNTY
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DEMOLITION PLANS -
2ND & 3RD FLOORS

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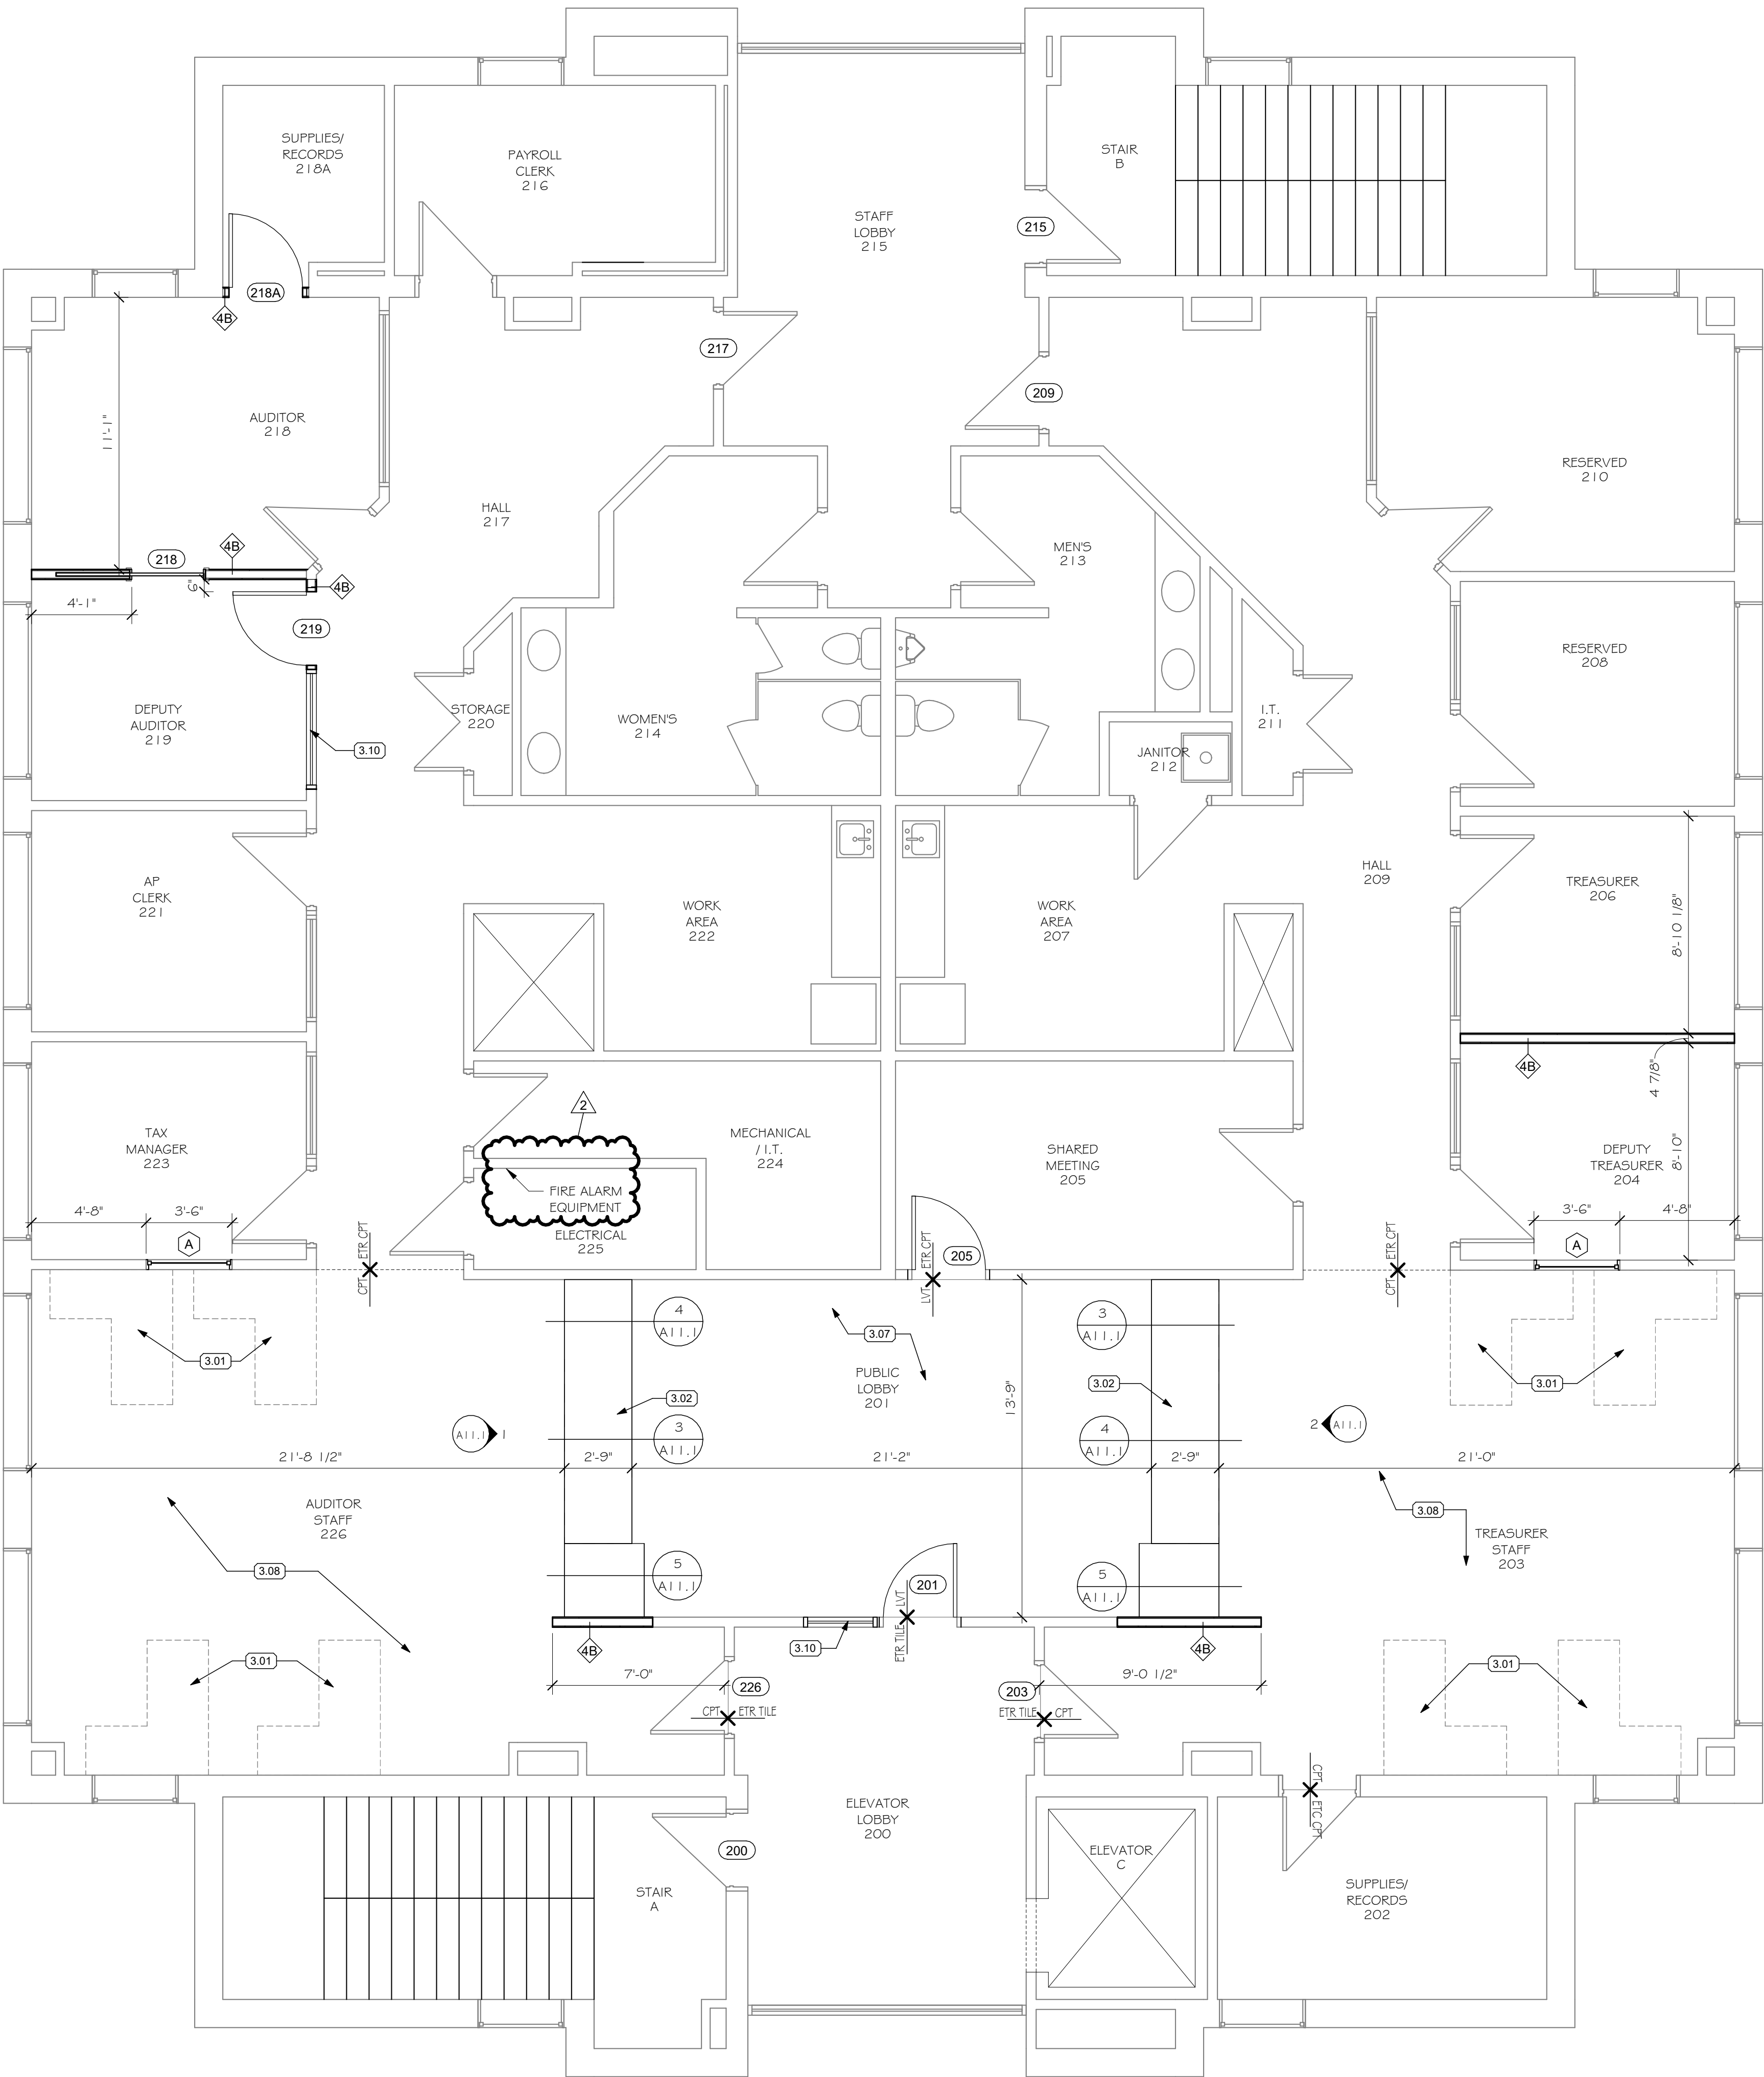
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SHEET NUMBER

A2.1




1 FLOOR PLAN - SECOND FLOOR
1/4" = 1'-0"

GENERAL PLAN NOTES

- A. DIMENSIONS ARE FROM FACE OF FINISHED SURFACE TO FACE OF FINISHED SURFACE.
- B. DIMENSIONS NOTED AS "CLEAR" ARE FROM FINISHED FACE TO FINISHED FACE.
- C. INTERIOR PARTITIONS SHALL BE 3-5/8" 20 GAGE METAL STUDS @ 16" O.C. UNLESS NOTED OTHERWISE.
- D. INTERIOR PARTITIONS TYPES ARE INDICATED ON SHEET A3.1.
- E. PATCH AND REPAINT TO MATCH EXISTING WALL CORNER TO CORNER IN ROOMS WHERE WORK IS BEING COMPLETED.
- F. IN ROOMS WITH NO WORK BEING COMPLETED EXISTING FINISHES TO REMAIN. PROTECT DURING CONSTRUCTION TO ADJACENT AREAS.
- G. WHERE EXISTING WALL WAS REMOVED PATCH DRYWALL TO MATCH ADJACENT FINISH. PAINT ENTIRE WALL FROM INSIDE CORNER TO INSIDE CORNER.
- H. PATCH AS REQUIRED AND PAINT ALL WALLS ON SECOND FLOOR.

FLOOR PLAN KEY NOTES

- 3.01 FURNITURE (NOT IN CONTRACT)
- 3.02 BUILT IN F-LAM CASEWORK
- 3.03 OFFICE EQUIPMENT (NOT IN CONTRACT)
- 3.04 NEW SINK
- 3.05 REFRIGERATOR (NOT IN CONTRACT)
- 3.06 KNAPE & VOST EXTRA HEAVY DUTY STANDARDS AND BRACKETS ADJUSTABLE SHELVING SYSTEM.
- 3.07 NEW LVT FLOORING AT ENTIRE EXTENT OF ROOM
- 3.08 NEW CARPET TILE FLOORING AT ENTIRE EXTENT OF ROOM
- 3.10 REINSTALL SALVAGED BORROWED LITE WINDOW, FIELD VERIFY SIZE
- 3.11 RELOCATED OFFICE FILE AND STORAGE CABINET (NOT IN CONTRACT)
- 3.12 PUBLIC COMPUTER STATION WORK COUNTER
- 3.14 ALIGN FACE OF COUNTER WITH INDICATED ADJACENT ARCHITECTURAL ELEMENT

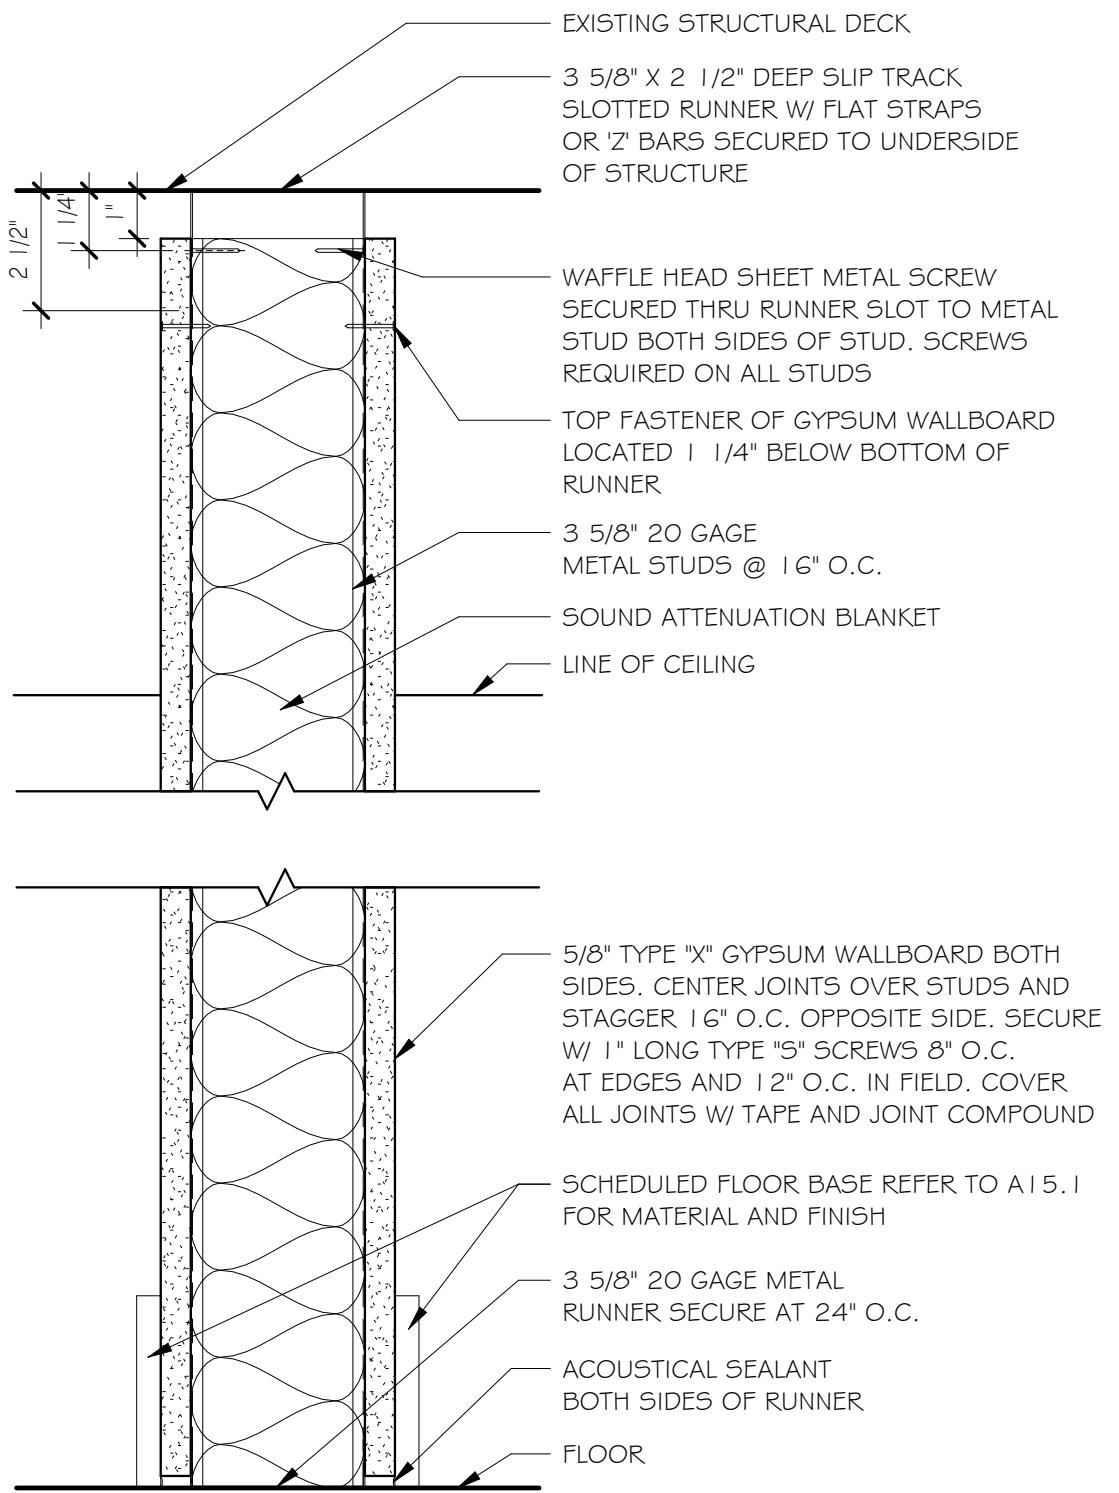

4B - WALL TYPE

SCALE: 3" = 1'-0"

FLOYD COUNTY
ANNEX
RENOVATION 2ND
& 3RD FLOORS 120
W. SPRING

NEW ALBANYINDIANA

FLOOR PLAN - SECOND
FLOOR

REVISIONS
2ADDENDUM #207.07.25

ARCHITECTURE


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LOUISVILLE, KY 40243
502.581.0570
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319 BANK STREET
NEW ALBANY, IN 47150
812.945.2324

PROJECT NUMBER
FCI2501

DATE
JUNE 12, 2025

SHEET NUMBER
A3.1

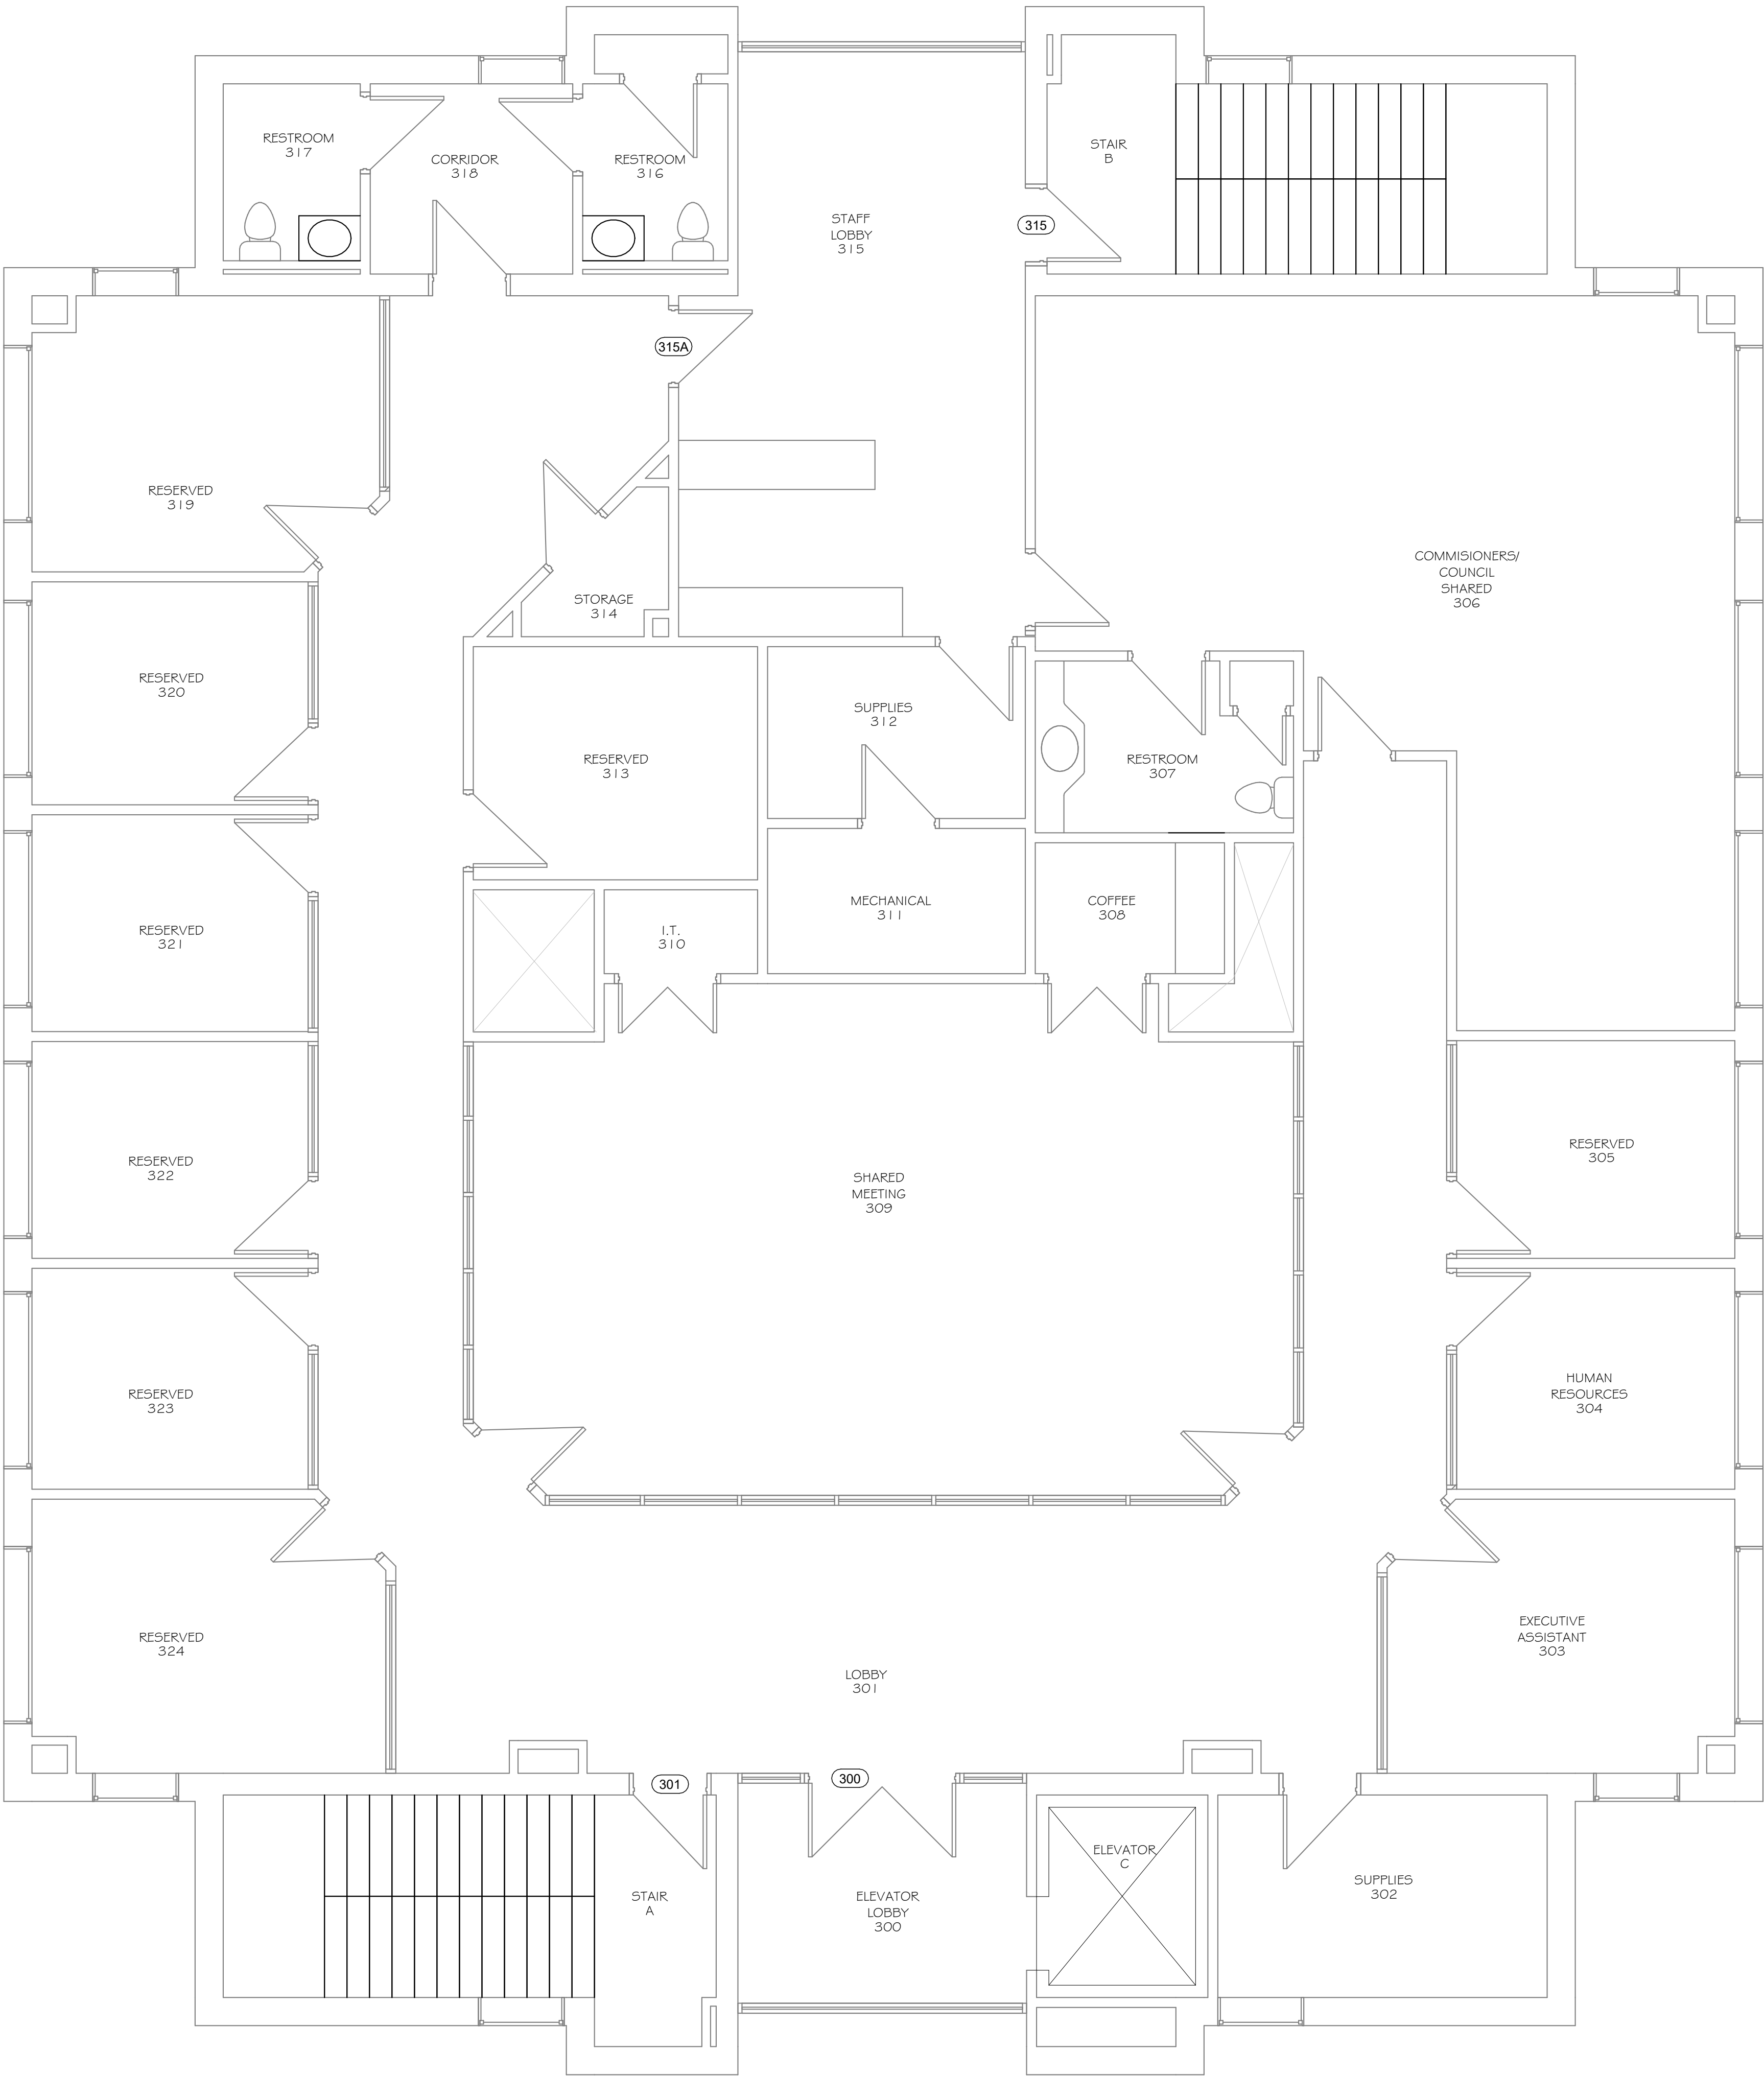

1 FLOOR PLAN - THIRD FLOOR
SCALE: 1/4" = 1'-0"

GENERAL PLAN NOTES


- A. DIMENSIONS ARE FROM FACE OF FINISHED SURFACE TO FACE OF FINISHED SURFACE.
- B. DIMENSIONS NOTED AS "CLEAR" ARE FROM FINISHED FACE TO FINISHED FACE.
- C. INTERIOR PARTITIONS SHALL BE 3-5/8" 20 GAGE METAL STUDS @ 16" O.C. UNLESS NOTED OTHERWISE.
- D. INTERIOR PARTITIONS TYPES ARE INDICATED ON SHEET A3.1.
- E. PATCH AND REPAINT TO MATCH EXISTING WALL CORNER TO CORNER IN ROOMS WHERE WORK IS BEING COMPLETED.
- F. IN ROOMS WITH NO WORK BEING COMPLETED EXISTING FINISHES TO REMAIN. PROTECT DURING CONSTRUCTION TO ADJACENT AREAS..
- G. WHERE EXISTING WALL WAS REMOVED PATCH DRYWALL TO MATCH ADJACENT FINISH. PAINT ENTIRE WALL FROM INSIDE CORNER TO INSIDE CORNER.
- H. PATCH AS REQUIRED AND PAINT ALL WALLS ON SECOND FLOOR.

FLOYD COUNTY
ANNEX
RENOVATION 2ND
& 3RD FLOORS 120
W. SPRING

NEW ALBANYINDIANA

FLOOR PLAN - THIRD
FLOOR

REVISIONS

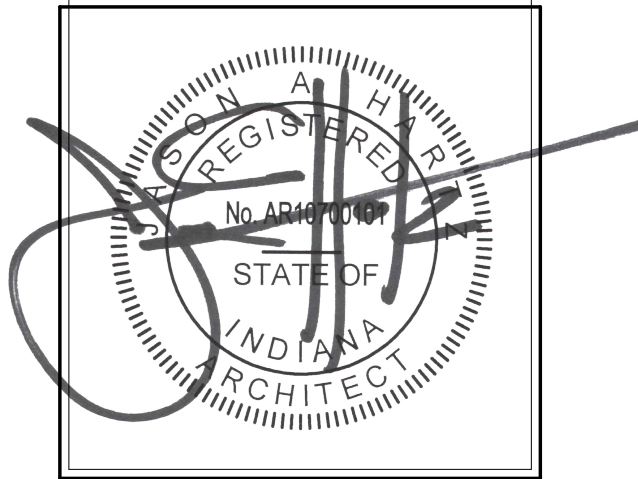

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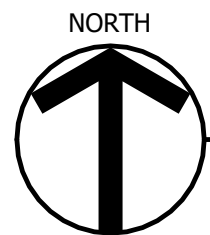
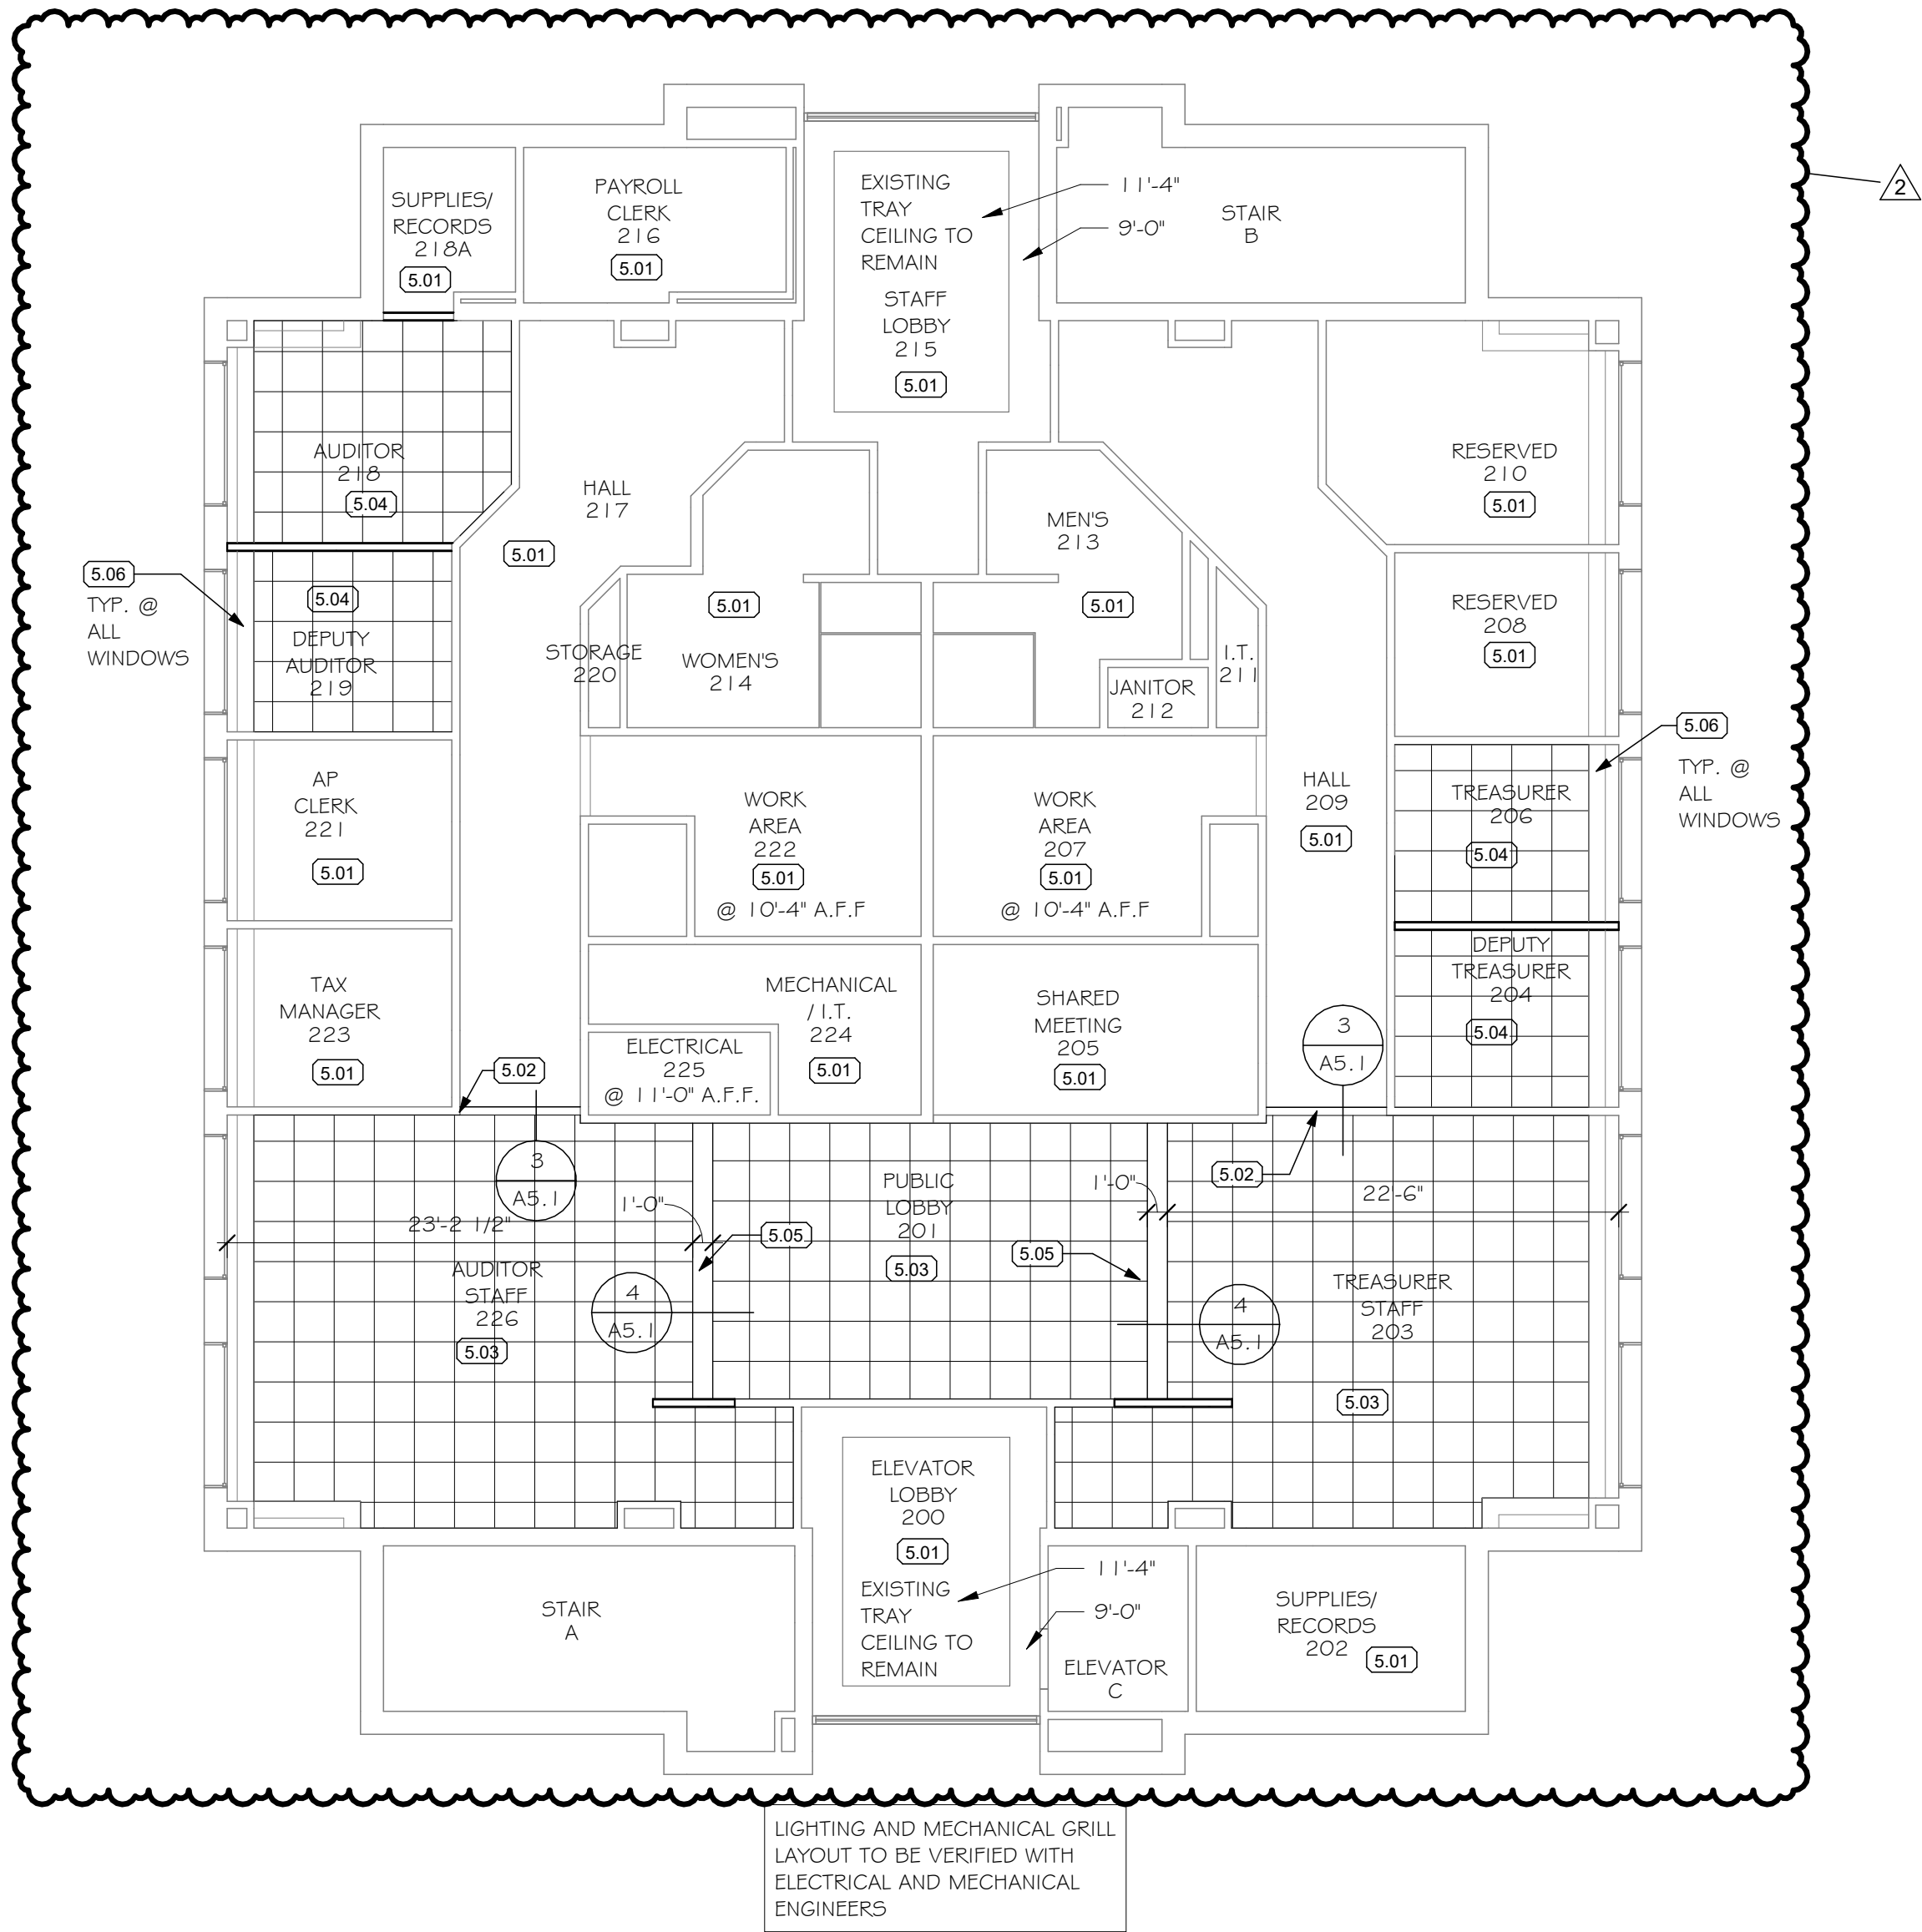
FCI2501

DATE

JUNE 12, 2025



SHEET NUMBER

A3.2



REFLECTED CEILING PLAN - 2ND FLOOR

SCALE: 1/8" = 1'-0"

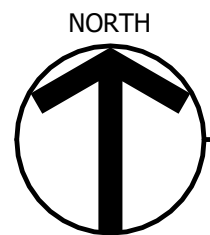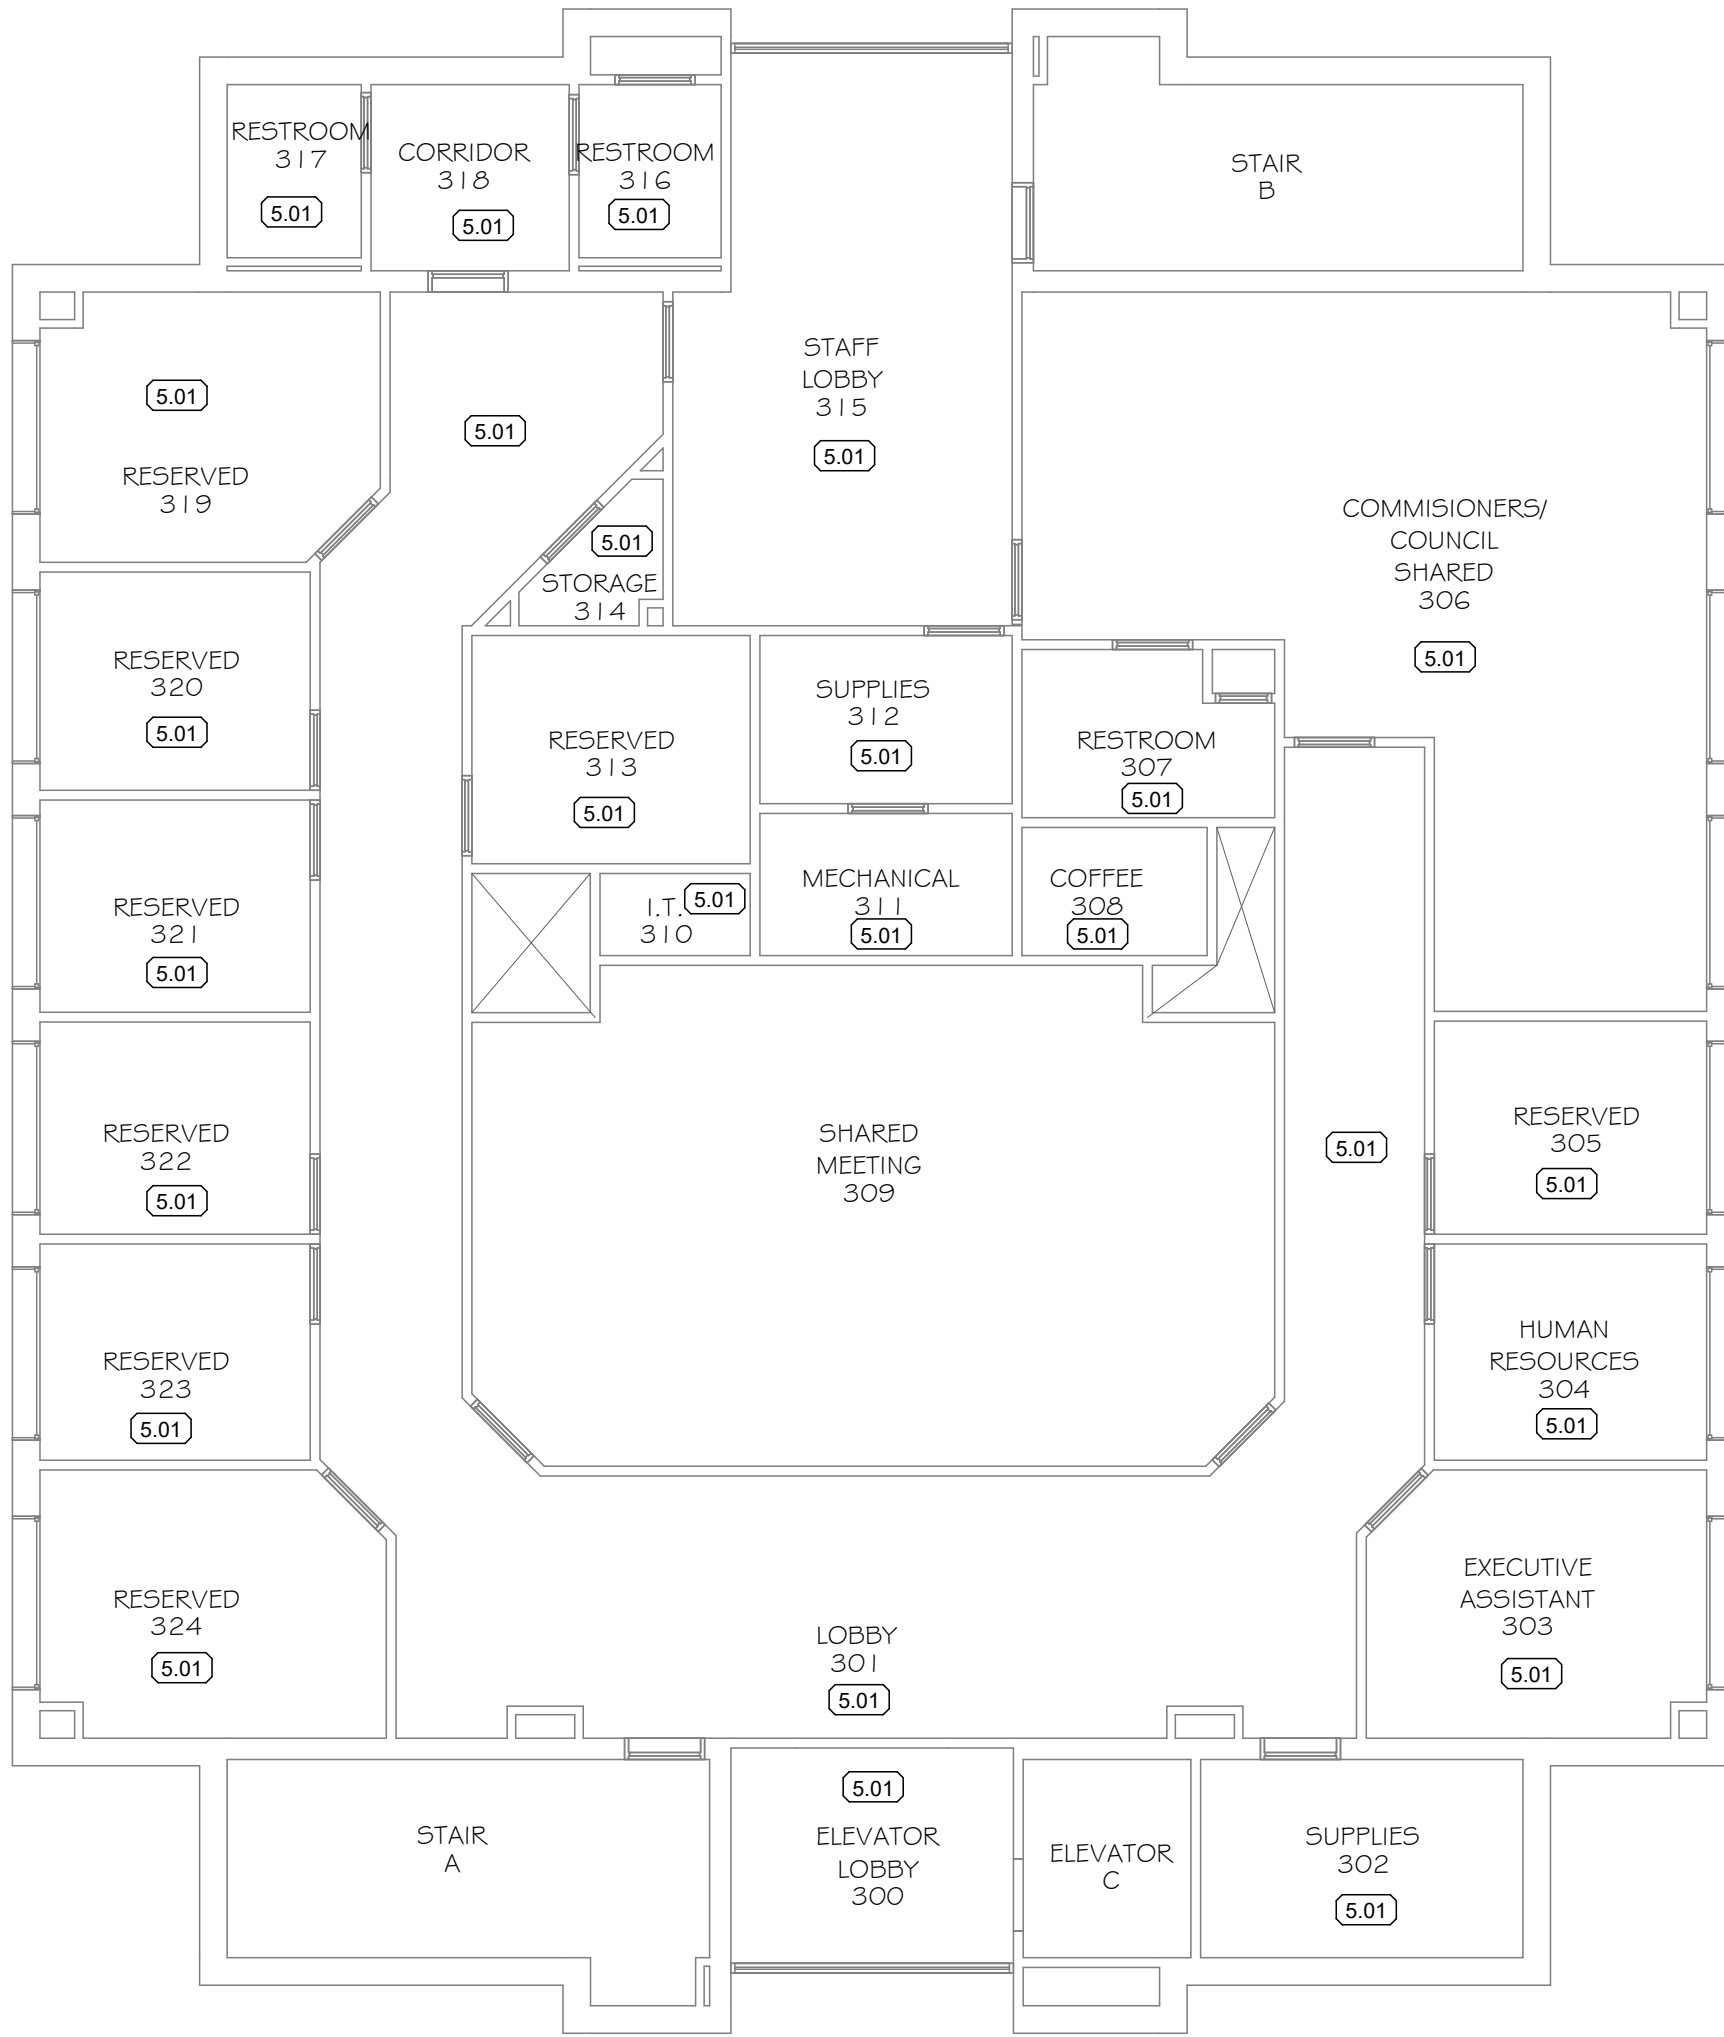

REFLECTED CEILING PLAN - 3RD FLOOR

SCALE: 1/8" = 1'-0"

WALL RATING LEGEND

-----	SMOKE PARTITION
- - - - -	SMOKE COMPARTMENT BARRIER WALL (1 HOUR RATED CONSTRUCTION WITH 20 MINUTE OPENING PROTECTION)
-----	1 HOUR FIRE RATED PARTITION
- - - - -	2 HOUR FIRE RATED PARTITION
+/+ /+ /+	1 HOUR FIRE RATED SMOKE COMPARTMENT BARRIER WALL
+/+ /+ /+	2 HOUR RATED SMOKE COMPARTMENT BARRIER WALL

GENERAL REFLECTED CEILING NOTES


- A. MATCH NEW CEILING GRID AND TILE TO THE EXISTING STYLE AND COLOR OF ADJACENT CEILING.
B. NEW CEILING TO BE SAME AS EXISTING CEILING HEIGHT AS ADJACENT CEILING. CEILING HEIGHT IS 9'-0" UNLESS OTHERWISE NOTED.
C. WHERE POSSIBLE MODIFY EXISTING GRID LAYOUT TO ACCOMMODATE NEW PLAN LAYOUT. REUSE EXISTING TILES IN GOOD CONDITION.

REFLECTED CEILING PLAN LEGEND

	2X2 ACOUSTICAL CEILING GRID AND PANELS
	2X4 ACOUSTICAL CEILING GRID AND PANELS
	GYPSUM WALLBOARD CEILING
	2'X4' RECESSED FLUORESCENT FIXTURE- COORDINATE WITH ELECTRICAL DRAWINGS
	2'X2' RECESSED FLUORESCENT FIXTURE- COORDINATE WITH ELECTRICAL DRAWINGS
	RECESSED DOWNLIGHT FIXTURE- COORDINATE WITH ELECTRICAL DRAWINGS
	SMOKE DETECTOR COORDINATE WITH ELECTRICAL DRAWINGS
	HEAT DETECTOR COORDINATE WITH ELECTRICAL DRAWINGS
	CEILING MOUNTED EXIT SIGN COORDINATE WITH ELECTRICAL DRAWINGS
	RETURN AIR DIFFUSER OR REGISTER COORDINATE WITH MECHANICAL DRAWINGS
	SUPPLY AIR DIFFUSER OR REGISTER COORDINATE WITH MECHANICAL DRAWINGS
	EXHAUST FAN COORDINATE WITH MECHANICAL DRAWINGS
	PENDANT LIGHT FIXTURE COORDINATE WITH ELECTRICAL DRAWINGS
	LOCKABLE ACCESS PANEL


REFLECTED CEILING KEYNOTES

- 5.01 EXISTING CEILING TO REMAIN.
5.02 NEW GYPSUM BOARD BULKHEAD @ 8'-1 1/4" A.F.F., FACES OF BULKHEAD TO MATCH ADJACENT WALL FINISH. BOTTOM OF BULKHEAD TO BE CEILING WHITE PAINT. SEE DETAIL 3/A5.1
5.03 NEW LAY IN ACOUSTICAL 2X2 CEILING. MATCH HEIGHT OF ADJACENT EXISTING ACOUSTICAL LAY-IN CEILING (9'-0" UNLESS OTHERWISE NOTED)
5.04 MODIFY EXISTING ACOUSTICAL CEILING AS REQUIRED.
5.05 NEW GYPSUM BOARD BULKHEAD @ 8'-6" A.F.F., FACES OF BULKHEAD TO MATCH ADJACENT WALL FINISH. BOTTOM OF BULKHEAD TO BE CEILING WHITE PAINT. SEE DETAIL 4/A5.1
5.06 EXISTING GYPSUM BOARD BULKHEAD AND CURTAIN POCKET TO REMAIN.

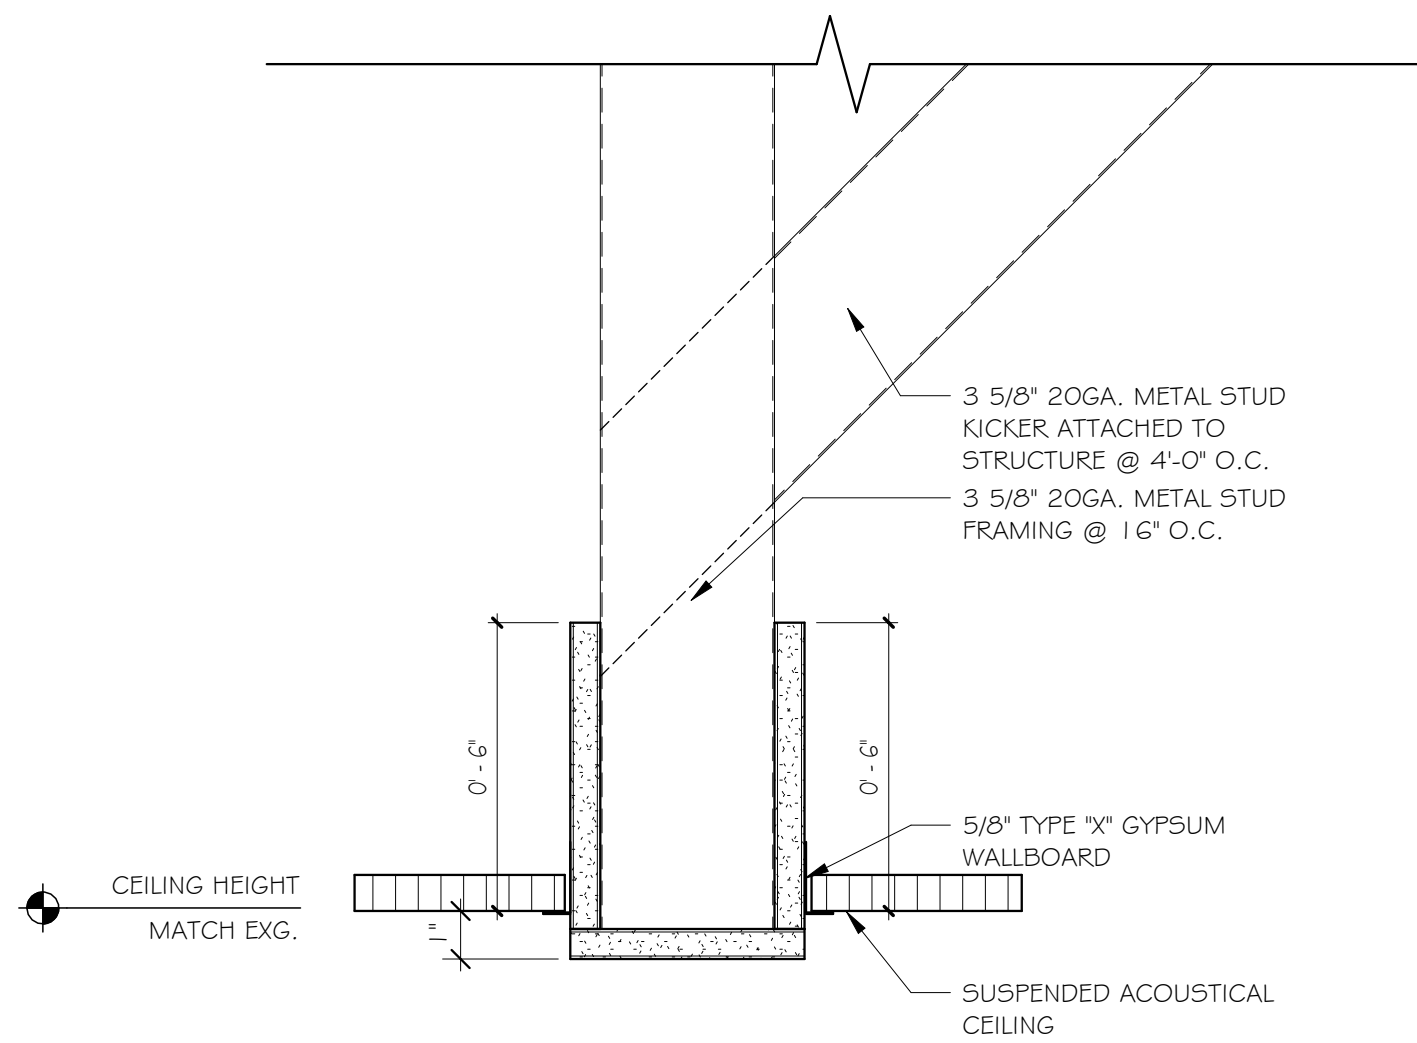

3 BULKHEAD DETAIL

SCALE: 3" = 1'-0"

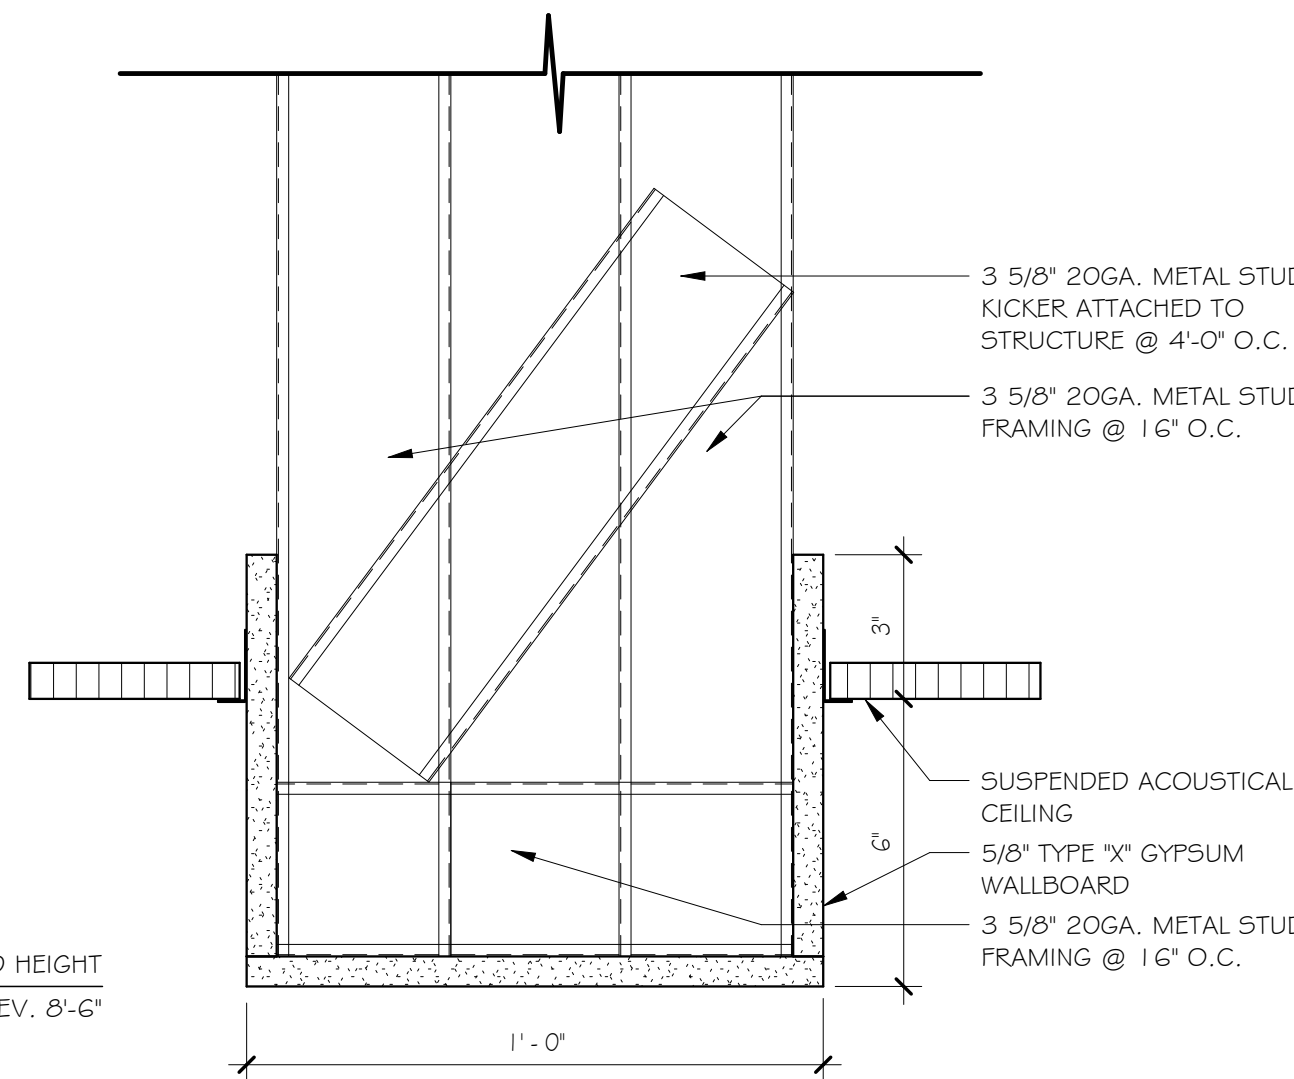

4 BULKHEAD DETAIL

3" = 1'-0"


FLOYD COUNTY ANNEX RENOVATION 2ND & 3RD FLOORS 120 W. SPRING

NEW ALBANY INDIANA

REFLECTED CEILING PLAN - 2ND & 3RD FLOORS

REVISIONS

2 ADDENDUM #2 07.07.25

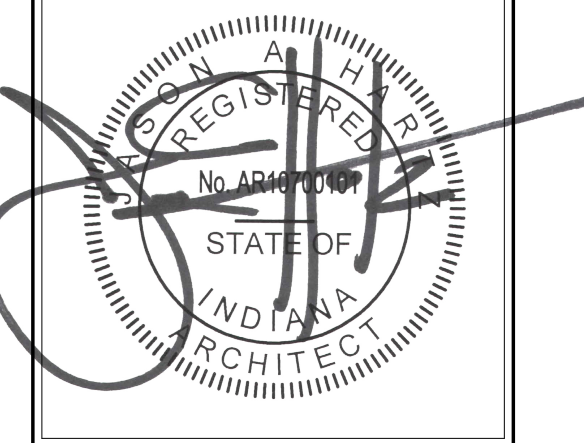

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PROJECT NUMBER


FCI2501

DATE


JUNE 12, 2025

SHEET NUMBER


A5.1

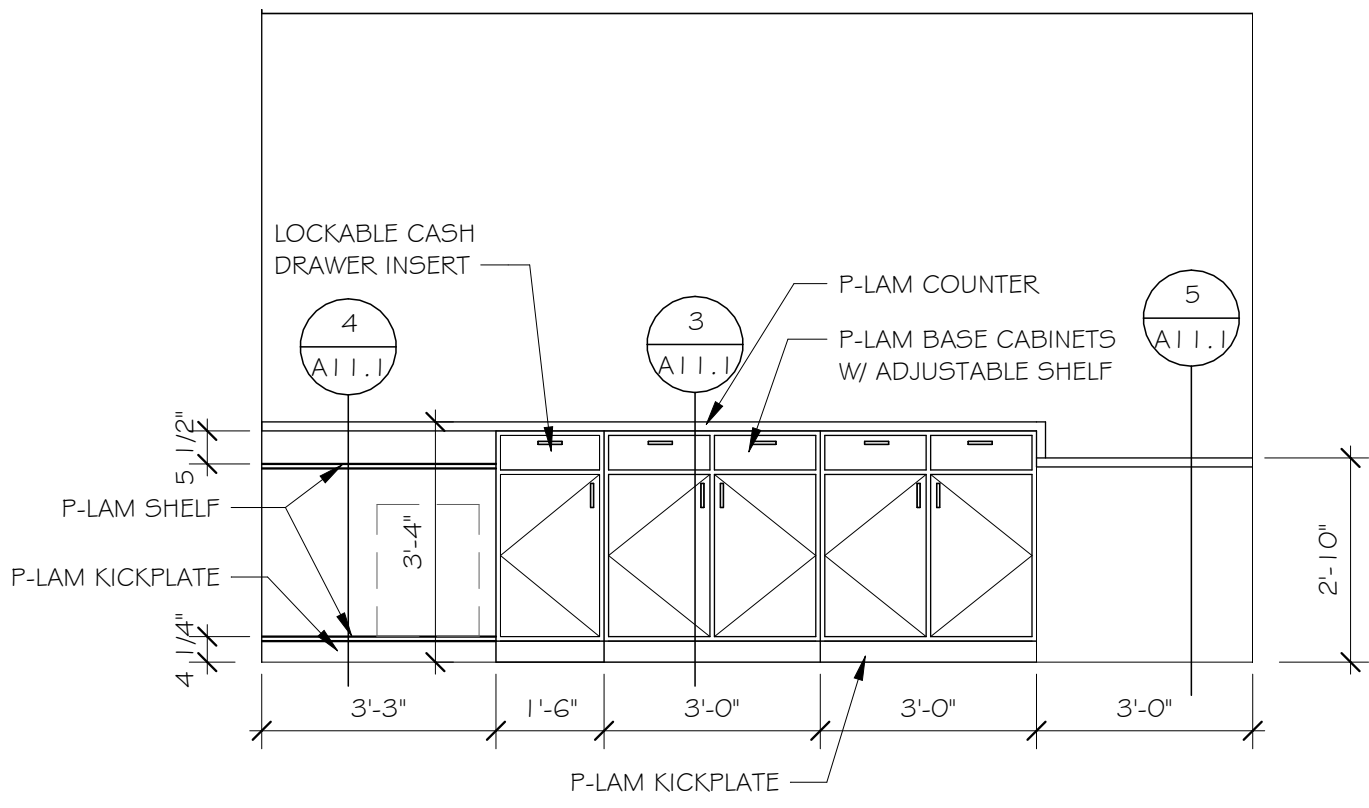


1 AUDITOR TRANSACTION COUNTER
3/8" = 1'-0"

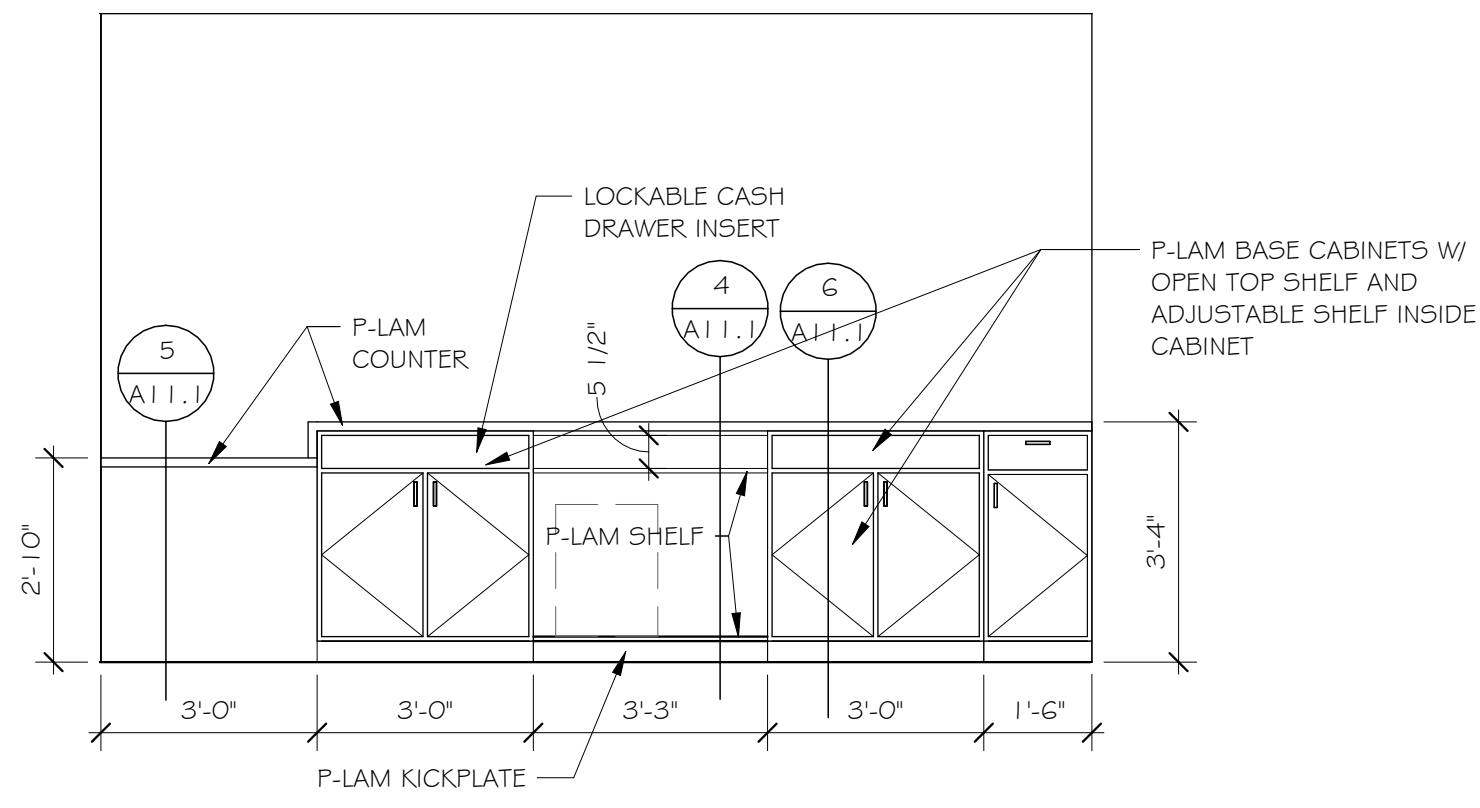


2 TREASURER TRANSACTION COUNTER
3/8" = 1'-0"

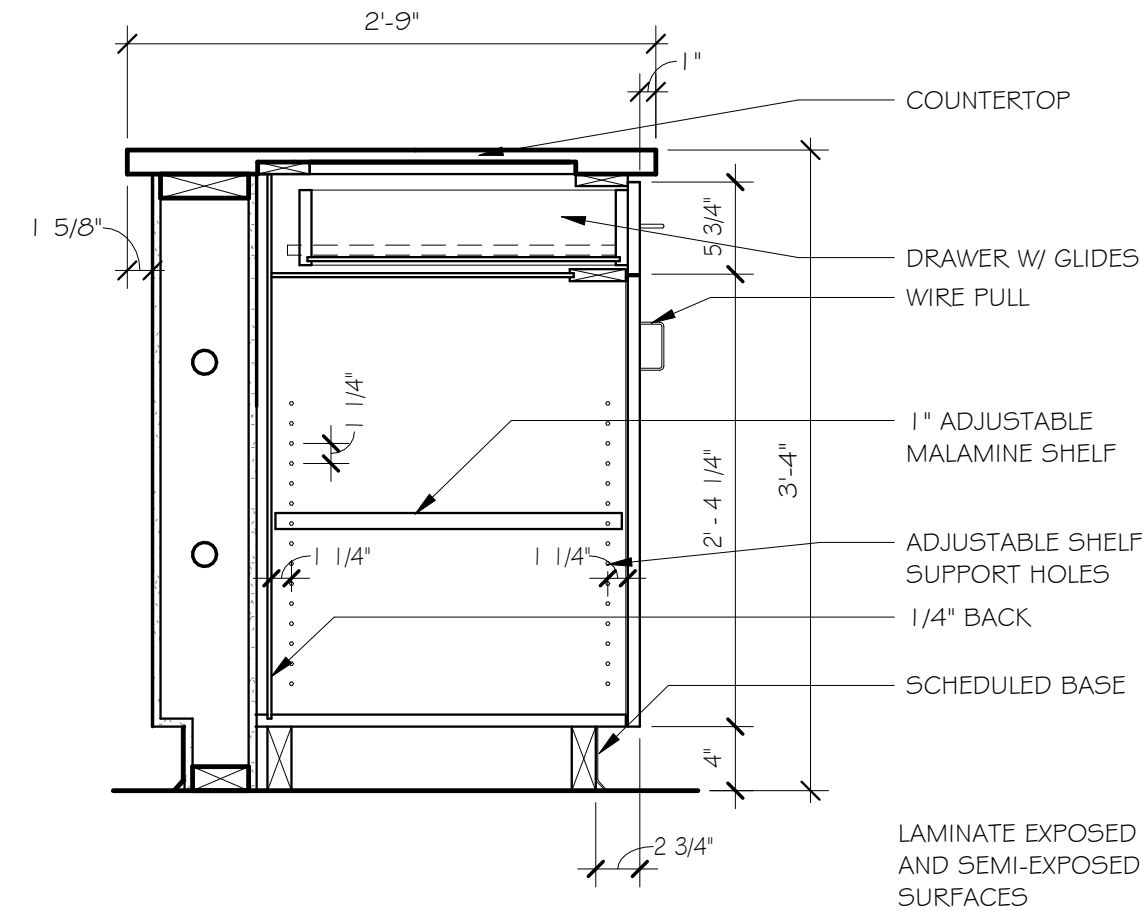


3 BASE SECTION
1" = 1'-0"

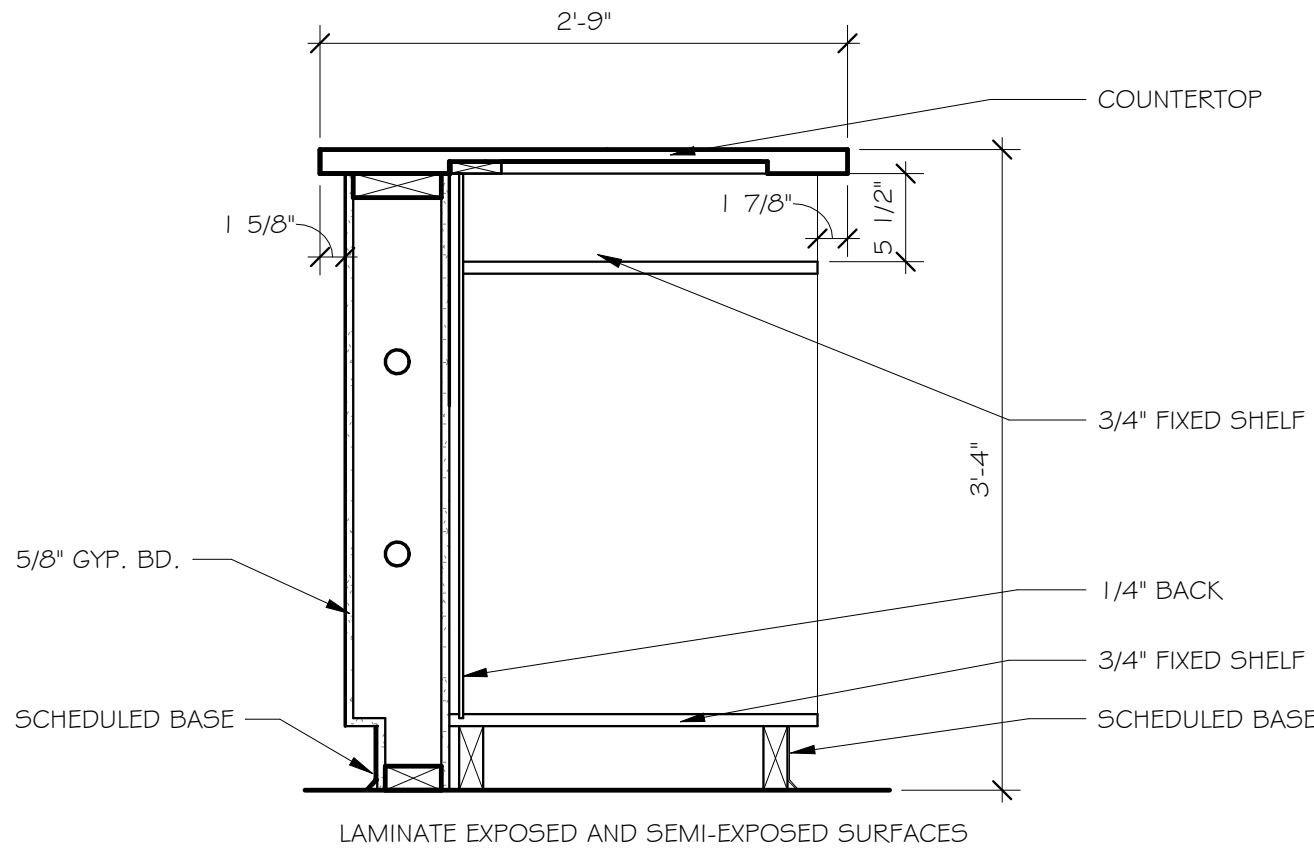

4 BASE SECTION OPEN SHELVES
1" = 1'-0"

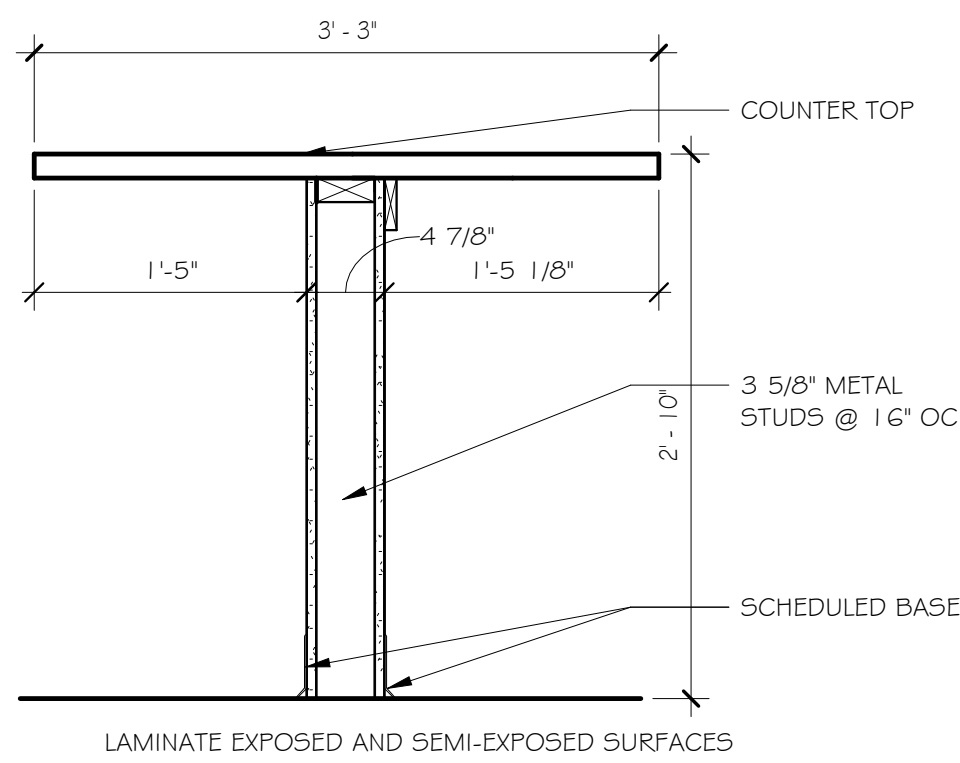

5 KNEE SPACE BOTH SIDES
1" = 1'-0"

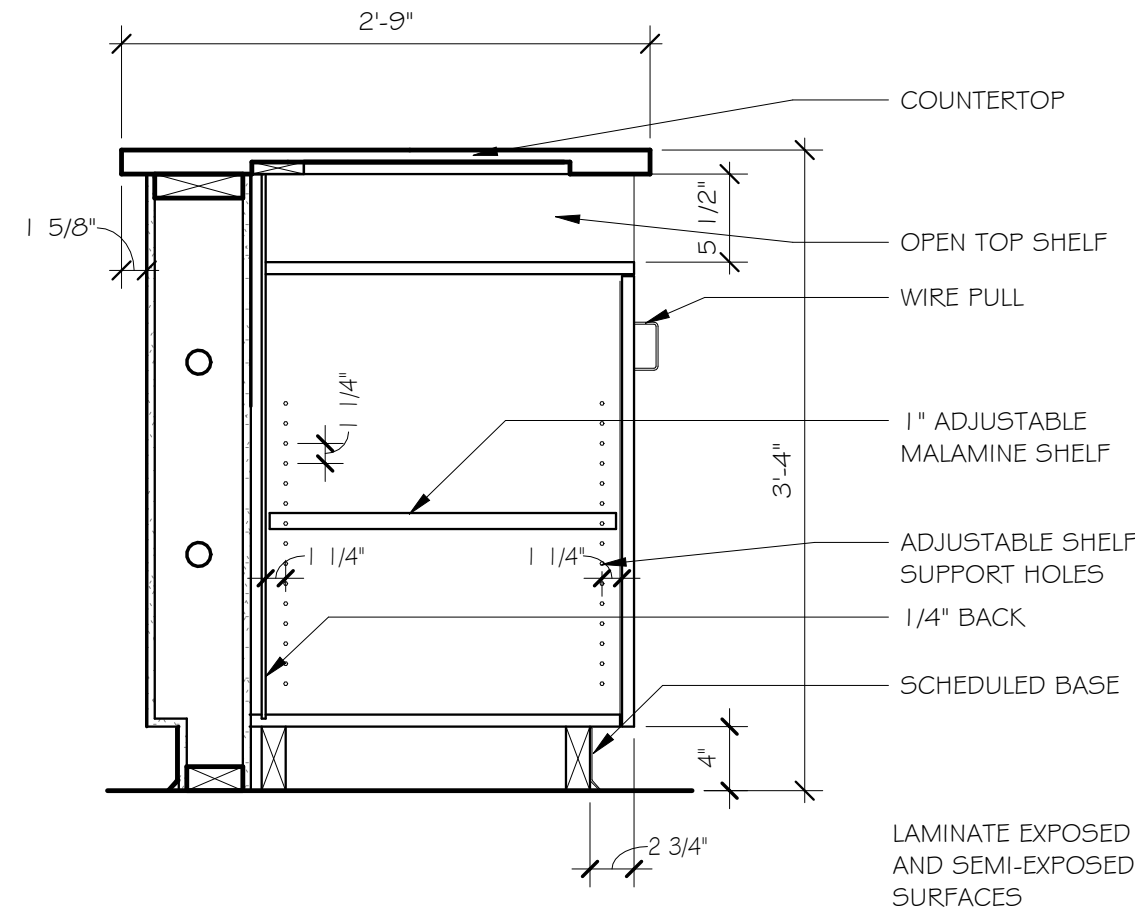

6 BASE SECTION WITH OPEN TOP SHELF
1" = 1'-0"

GENERAL INTERIOR ELEVATION NOTES



- A. PROVIDE FINISHED END PANELS ON EXPOSED ENDS OF CABINETS AND ON SUPPORT LEGS.
- B. PROVIDE FILLER PANELS FOR PROPER DOOR OPERATION AND DRAWER OPERATION AND AS REQUIRED FOR FINISHED CASEWORK.
- C. PROVIDE SEALANT AT COUNTERTOP AND WALL INTERSECTIONS, AT BACKSPLASH AND WALL INTERSECTIONS, AND AT PLUMBING FIXTURES.
- D. PROVIDE 1 1/2" RADIUS ON EXPOSED COUNTERTOP CORNERS.
- E. CASEWORK SECTIONS ARE INDICATED ON SHEET A12.1.
- F. MOUNT OUTLETS 10" ABOVE COUNTER TO TOP OF BOX UNLESS NOTED OTHERWISE.
- G. LAMINATE ALL EXPOSED AND SEMI-EXPOSED SURFACES OF CASEWORK AND COUNTERTOPS.
- H. SEE FINISH SCHEDULE ON A15.1 FOR SPECIFIC FINISHES.
- I. ALL CASEWORK TO FOLLOW AWI STANDARDS.

FLOYD COUNTY
ANNEX
RENOVATION 2ND
& 3RD FLOORS 120
W. SPRING

NEW ALBANY INDIANA


INTERIOR ELEVATIONS

REVISIONS

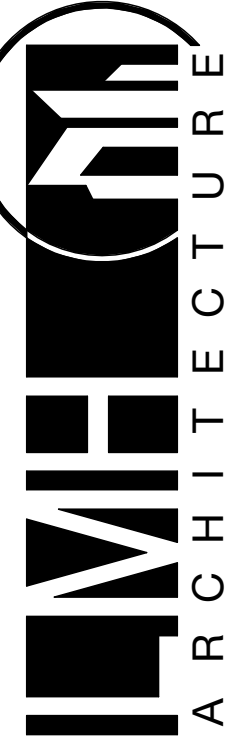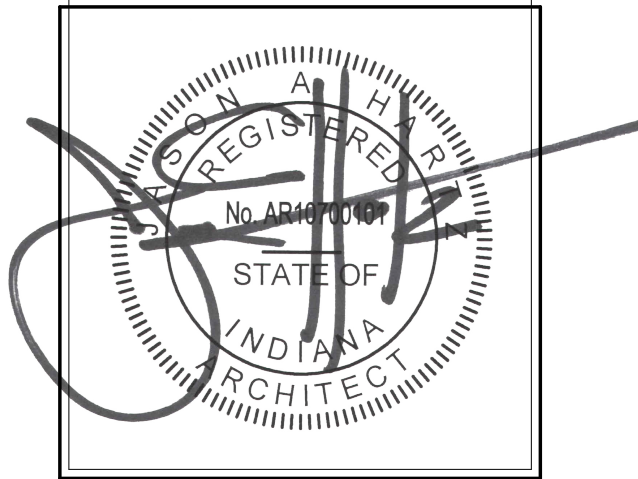

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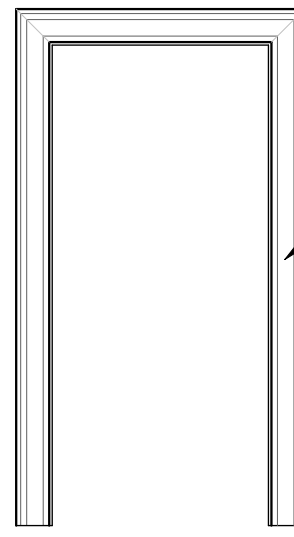
PROJECT NUMBER	FCI2501
DATE	JUNE 12, 2025
SHEET NUMBER	A11.1

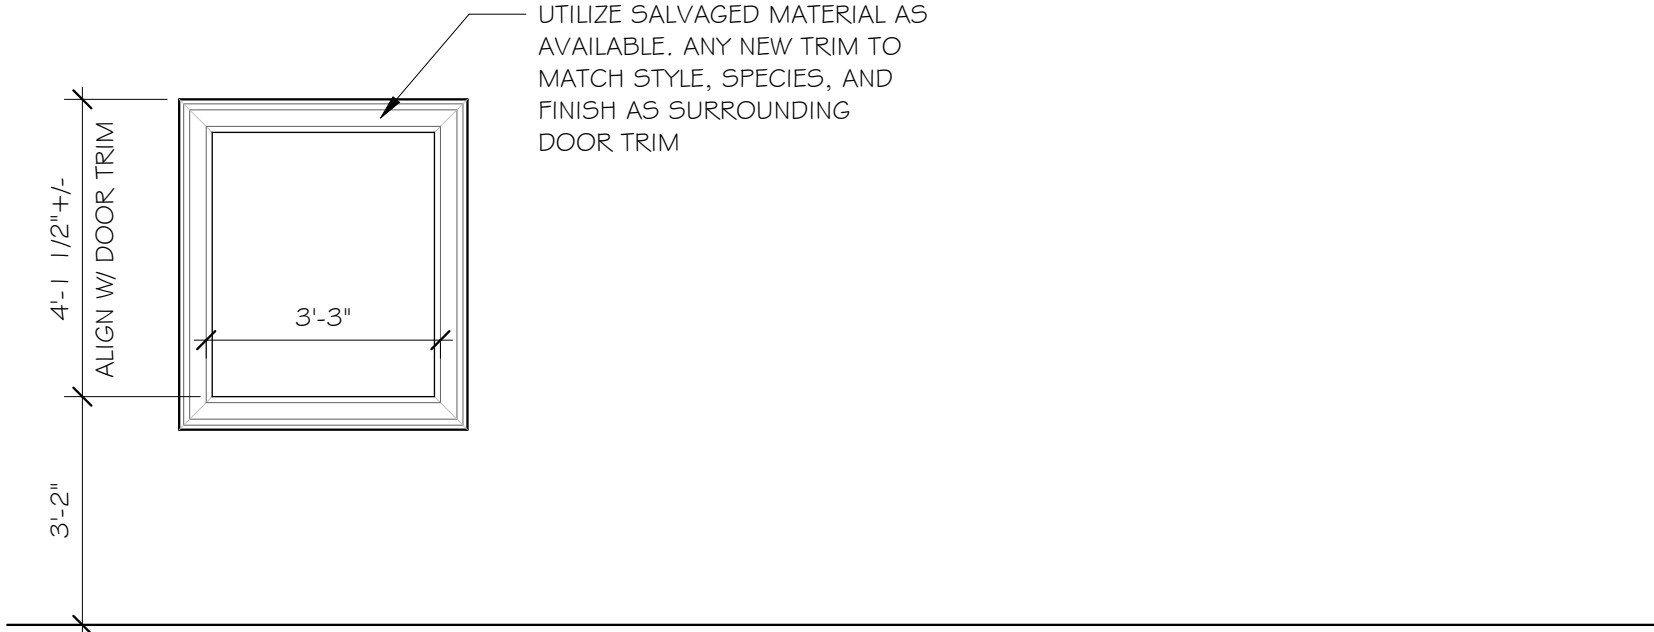

A

WINDOW TYPE LEGEND


SCALE: 3/8" = 1'-0"



1

DOOR FRAME ELEVATIONS

SCALE: 3/8" = 1'-0"

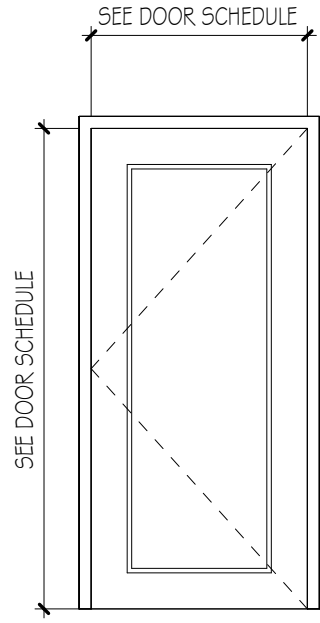

A

DOOR TYPES

SCALE: 3/8" = 1'-0"

DOOR SCHEDULE														
DOOR NUMBER	ROOM NAME	ROOM NUMBER	PAIR	Width		Height		DOOR				FRAME		
								MATERIAL	FINISH	THICKNESS	TYPE	MATERIAL	FINISH	ELEVATION
200	STAIR	A		3' - 0"	7' - 0"	-	-	O' - 1 3/4"	-	-	-	-	-	1
201	ELEVATOR LOBBY	200		3' - 0"	7' - 0"	-	-	O' - 1 3/4"	A	WOOD	S4V	1	2	103
203	ELEVATOR LOBBY	200		3' - 0"	7' - 0"	-	-	O' - 1 3/4"	-	-	-	-	-	2
205	SHARED MEETING	205		3' - 0"	7' - 0"	-	-	O' - 1 3/4"	SCW	S4V	O' - 1 3/4"	A	WOOD	S4V
209	STAFF LOBBY	215		3' - 0"	7' - 0"	-	-	O' - 1 3/4"	-	-	-	-	-	2
215	STAIR	B		3' - 0"	7' - 0"	-	-	O' - 1 3/4"	-	-	-	-	-	1
217	HALL	217		3' - 0"	7' - 0"	-	-	O' - 1 3/4"	-	-	-	-	-	2
218	AUDITOR	218		3' - 0"	7' - 0"	-	-	O' - 1 3/8"	HCW	PAINT	O' - 1 3/8"	A	WOOD	S4V
218A	SUPPLIES/ RECORDS	218A		3' - 0"	7' - 0"	-	-	O' - 1 3/4"	SCW		O' - 1 3/4"	A	WOOD	S4V
219	DEPUTY AUDITOR	219		3' - 0"	7' - 0"	-	-	O' - 1 3/4"	SCW		O' - 1 3/4"	A	WOOD	S4V
226	ELEVATOR LOBBY	200		3' - 0"	7' - 0"	-	-	O' - 1 3/4"	-	-	-	-	-	2
300	ELEVATOR LOBBY	300	YES	6' - 0"	7' - 0"	-	-	O' - 1 3/4"	-	-	-	-	-	5
301	STAIR	A		3' - 0"	7' - 0"	-	-	O' - 1 3/4"	-	-	-	-	-	1
315	STAIR	B		3' - 0"	7' - 0"	-	-	O' - 1 3/4"	-	-	-	-	-	1
315A	STAFF LOBBY	315		3' - 0"	7' - 0"	-	-	O' - 1 3/4"	-	-	-	-	-	2


SEE DEMOLITION PLANS FOR SALVAGED DOOR NUMBER REFERENCE

CONTRACTOR TO HAVE ALL EXISTING UNLABELED DOORS AND FRAMES IN 2-HOUR MINIMUM RATED STAIR WALL VERIFIED AND PROVIDE NEW 90 MINUTE LABELS ON ALL THAT DO NOT HAVE TAG / LABEL VISIBLE.

- DOOR HARDWARE**
 - CONTRACTOR SHALL FIELD VERIFY ALL EXISTING HARDWARE PREPS AND MATCH EXISTING PRIOR TO ORDERING.
 - ALL HARDWARE SHALL BE SUPPLIED TO CONFORM TO APPLICABLE STATE, LOCAL AND NATIONAL CODES IN ACCORDANCE WITH THE AHJ.
 - FURNISH ALL BRACKETS REQUIRED FOR PROPER INSTALLATION.
 - FURNISH DOOR CLOSERS ON ALL FIRE AND SMOKE-RATED OPENINGS AS REQUIRED BY THE AHJ AND CODES.
 - FURNISH SMOKE AND FIRE SEALS ON ALL FIRE AND SMOKE-RATED OPENINGS AS REQUIRED BY THE A.H.J. AND CODES.
 - ALL HARDWARE SHALL BE GRADE 1 WITH BHMA 652 FINISH.
 - VERIFY ALL EXISTING HARDWARE IS IN WORKING ORDER. REPAIR ITEMS THAT ARE NON-COMPLIANT.CONTRACTOR SHALL CONFIRM ALL FUNCTIONS WITH OWNER PRIOR TO ORDERING HARDWARE. DOOR HARDWARE SHALL BE PROVIDED AS A COMPLETE FUNCTIONING OPENING WITH THE INTENDED FUNCTION OF THE OWNER.
 - ACCESS CONTROL CONTRACTOR RESPONSIBLE FOR SYSTEM REQUIREMENTS TO MEET APPLICABLE EGRESS CODE SECTIONS INCLUDING 1008.1.9.11 STAIRWAY DOORS.
- SET #1**
1EA LOCK
1EA LEVER
NEW HARDWARE BY ACCESS CONTROL CONTRACTOR
- SET #2**
3EA HINGES
1EA LOCK
1EA LEVER
NEW HARDWARE BY ACCESS CONTROL CONTRACTOR
- SET #3**
3EA HINGES - REUSE EXISTING
1EA LOCK
1EA WALL STOP
1EA LEVER
- SET #4**
3EA HINGES - BALL BEARING
1EA LOCK
1EA WALL STOP
1EA LEVER
- SET #5**
3EA HINGES - REUSE EXISTING
1EA LOCK
1 EA LEVER - REUSE EXISTING
- SET #6**
1EA COMMERCIAL GRADE TRACK
2EA BALL BEARING DOOR HANGERS
1EA DOOR BUMPER
1EA DOOR GUIDE
1EA POCKET DOOR LOCK

DOOR SCHEDULE AND
DETAILS

REVISIONS		
2	ADDENDUM #2	07.07.25

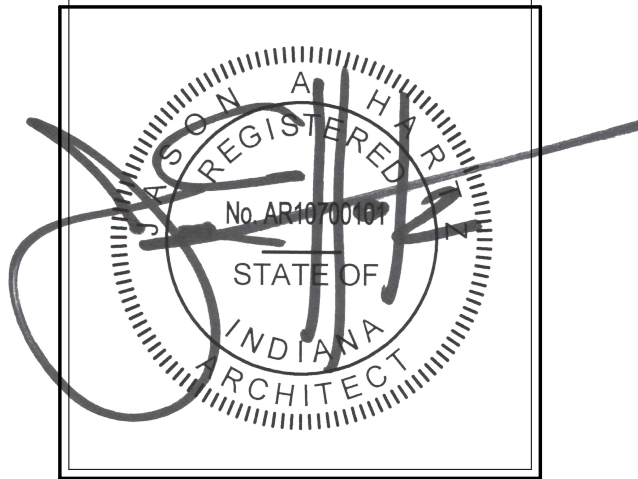

INTERIOR FINISH LEGEND - TABLE							
FINISH CODE	DESCRIPTION	MANUFACTURER	PRODUCT	NUMBER	COLOR	FINISH/SIZE	NOTES
BASE							
RB-1	RUBBER BASE	JOHNSONITE	DURACOVE TRADITIONAL WALL BASE	--	MATCH TO EXISTING	4'	2ND FLOOR EAST
RB-2	RUBBER BASE	JOHNSONITE	DURACOVE TRADITIONAL WALL BASE	DC40	BLACK	4'	2ND FLOOR WEST
WDB-1	WOOD BASE	--	--	--	S&V-1	MATCH EXISTING PROFILE, SPECIES, AND CUT	
CASEWORK							
PL-1	PLASTIC LAMINATE	WILSONART	STANDARD LAMINATE	--	--	FINE VELVET	VERTICAL SURFACES
PL-2	PLASTIC LAMINATE	WILSONART	STANDARD LAMINATE	--	--	FINE VELVET	HORIZONTAL SURFACES
S&V	STAIN AND VARNISH	--	--	--	MATCH TO EXISTING	MATCH TO EXISTING	
CEILING							
ACT-1	ACOUSTICAL CEILING TILE	USG	RADAR	--	WHITE	MATCH TO EXISTING	CONTRACTOR TO VERIFY MATCH TO EXISTIN 2ND & 4TH FLOOR
ACT-2	ACOUSTICAL CEILING TILE	CERTAINTeed	CASHMERE STYLE EDGE	CMTS-1 24	MATCH TO EXISTING	TIER NARROW REVEAL 24"X24"	3RD FLOOR
PT-5	PAINT	SHERWIN WILLIAMS	PROMAR 200 ZERO VOC	--	CEILING WHITE	EG-SHEL	UNDERSIDE OF BULKHEAD
FLOORING							
CPT-1	CARPET	PATCRAFT	FUTURA	10380	MATCH TO EXISTING	24" X 24"	2ND FLOOR
CPT-2	CARPET	INTERFACE	GREAT LENGTHS II		ENTROBEAN II	11X11M	3RD FLOOR (DISCONTINUED)
CPT-5	CARPET	PATCRAFT	EXPERIENCE	10291	MATCH TO EXISTING	24" X 24"	STAIRWELL
LVT-1	LUXURY VINYL TILE PLANKS	TEKNOFLOR	RARE PLANK HPD	89003RP	AMERICAN WALNUT (MATCH EXISTING DOOR STAIN)	7.09" X 47.24", 3MM THICKNESS, 20 MIL WEAR LAYER	20 YR. WARRANTY (MIN) INSTALLATION METHOD: RANDOM STAGGER
LVT-2	LUXURY VINYL TILE PLANKS	TBD				3MM THICKNESS, 20 MIL WEAR LAYER	20 YR. WARRANTY (MIN) INSTALLATION METHOD: RANDOM STAGGER
TILE							
T-1	TILE - FLOOR	--	--	--	--	--	EXISTING TO REMAIN
WALL							
PT-1	PAINT	SHERWIN WILLIAMS	PROMAR 200 ZERO VOC	--	MATCH TO EXISTING	EG-SHEL	PAINT ENTIRE EXTENT OF WALLS TO EACH ADJACENT INSIDE CORNER
PT-2	PAINT	SHERWIN WILLIAMS	PROMAR 200 ZERO VOC	--	MATCH TO EXISTING	EG-SHEL	PAINT ENTIRE EXTENT OF WALLS TO EACH ADJACENT INSIDE CORNER





ALL MATERIAL SUBSTITUTIONS SUBJECT TO SPECIFICATION SECTION 016005

GENERAL FINISH SCHEDULE NOTES

- A. PATCH AND REPAINT TO MATCH EXISTING WALL CORNER TO CORNER IN ROOMS WHERE WORK IS BEING COMPLETED BUT EXISTING FINISHES TO REMAIN.
- B. IN ROOMS WITH NO WORK BEING COMPLETED EXISTING FINISHES TO REMAIN. PROTECT DURING CONSTRUCTION TO ADJACENT AREAS.
- C. ALL ELECTRICAL DEVICES AND COVERS TO MATCH EXISTING.
- D. USE MANUFACTURER'S RECOMMENDED INSTALLATION METHODS AND MATERIALS FOR ALL FINISHES

FLOORING TRANSITIONS

NOTE: MATCH COLOR OF FLOORING TRANSITION STRIP TO COLOR OF NEW FLOORING MATERIAL

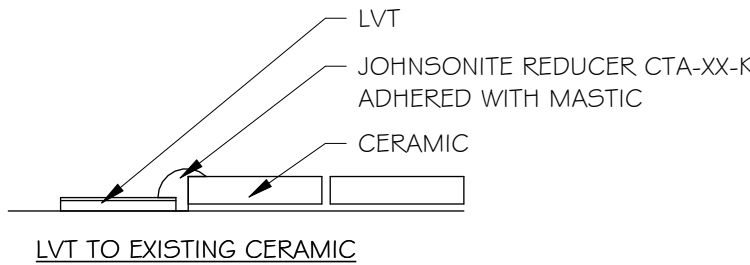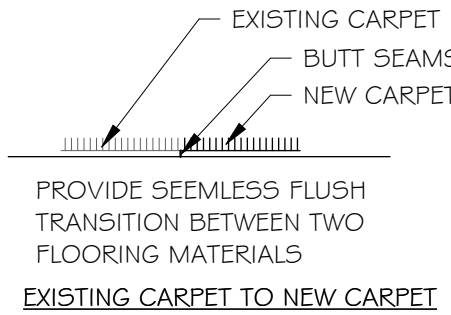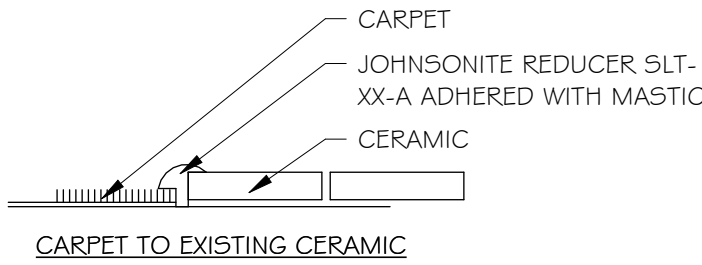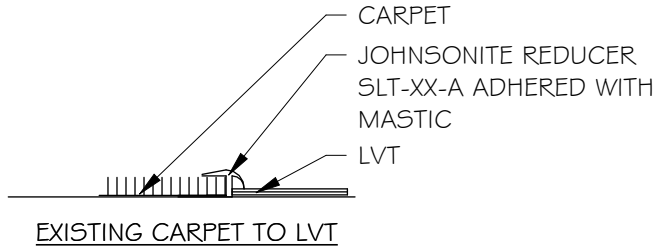

Room Schedule								
NO	ROOM NAME	FLOOR FINISH	BASE TYPE	BASE FINISH	WALL MATERIAL	WALL FINISH	CEILING TYPE	COMMENTS
A	STAIR	ETR	ETR	ETR	ETR	ETR	ETR	
B	STAIR	ETR	ETR	ETR	ETR	ETR	ETR	
C	ELEVATOR	ETR	ETR	ETR	ETR	ETR	ETR	
2ND FLOOR								
200	ELEVATOR LOBBY	ETR	ETR	ETR	ETR	PAINT	ETR	
201	PUBLIC LOBBY	LVT-1	WOOD	S&V	DRYWALL	PAINT	ACT / DW	
202	SUPPLIES/ RECORDS	ETR	ETR	ETR	ETR	PAINT	ETR	
203	TREASURER STAFF	CPT-1	WOOD	S&V	DRYWALL	PAINT	ACT	
204	DEPUTY TREASURER	CPT-1	WOOD	S&V	DRYWALL	PAINT	ACT	PROTECT EXISTING FINISHES DURING CONSTRUCTION AND PATCH AS REQUIRED
205	SHARED MEETING	ETR	ETR	ETR	ETR	PAINT	ETR	PROTECT EXISTING FINISHES DURING CONSTRUCTION AND PATCH AS REQUIRED
206	TREASURER	CPT-1	WOOD	S&V	DRYWALL	PAINT	ACT	PROTECT EXISTING FINISHES DURING CONSTRUCTION AND PATCH AS REQUIRED
207	WORK AREA	ETR	ETR	ETR	ETR	PAINT	ETR	
208	RESERVED	ETR	ETR	ETR	ETR	PAINT	ETR	
209	HALL	ETR	ETR	ETR	ETR	PAINT	ETR	PROTECT EXISTING FINISHES DURING CONSTRUCTION AND PATCH AS REQUIRED
210	RESERVED	ETR	ETR	ETR	ETR	PAINT	ETR	
211	I.T.	ETR	ETR	ETR	ETR	PAINT	ETR	
212	JANITOR	ETR	ETR	ETR	ETR	PAINT	ETR	
213	MEN'S	ETR	ETR	ETR	ETR	ETR	ETR	
214	WOMEN'S	ETR	ETR	ETR	ETR	ETR	ETR	
215	STAFF LOBBY	ETR	ETR	ETR	ETR	PAINT	ETR	
216	PAYROLL CLERK	ETR	ETR	ETR	ETR	PAINT	ETR	
217	HALL	ETR	ETR	ETR	ETR	PAINT	ETR	PROTECT EXISTING FINISHES DURING CONSTRUCTION AND PATCH AS REQUIRED
218	AUDITOR	CPT-1	WOOD	S&V	DRYWALL	PAINT	ACT	PROTECT EXISTING FINISHES DURING CONSTRUCTION AND PATCH AS REQUIRED
218A	SUPPLIES/ RECORDS	ETR	ETR	ETR	ETR	PAINT	ETR	
219	DEPUTY AUDITOR	CPT-1	WOOD	S&V	DRYWALL	PAINT	ACT	PROTECT EXISTING FINISHES DURING CONSTRUCTION AND PATCH AS REQUIRED
220	STORAGE	ETR	ETR	ETR	ETR	PAINT	ETR	
221	AP CLERK	ETR	ETR	ETR	ETR	PAINT	ETR	
222	WORK AREA	ETR	ETR	ETR	ETR	PAINT	ETR	
223	TAX MANAGER	ETR	ETR	ETR	ETR	PAINT	ETR	PROTECT EXISTING FINISHES DURING CONSTRUCTION AND PATCH AS REQUIRED
224	MECHANICAL / I.T.	ETR	ETR	ETR	ETR	PAINT	ETR	
225	ELECTRICAL	ETR	ETR	ETR	ETR	PAINT	ETR	
226	AUDITOR STAFF	CPT-1	WOOD	S&V	DRYWALL	PAINT	ACT	
3RD FLOOR								
300	ELEVATOR LOBBY	ETR	ETR	ETR	ETR	ETR	ETR	
301	LOBBY	ETR	ETR	ETR	ETR	ETR	ETR	
302	SUPPLIES	ETR	ETR	ETR	ETR	ETR	ETR	
303	EXECUTIVE ASSISTANT	ETR	ETR	ETR	ETR	ETR	ETR	
304	HUMAN RESOURCES	ETR	ETR	ETR	ETR	ETR	ETR	
305	RESERVED	ETR	ETR	ETR	ETR	ETR	ETR	
306	COMMISSIONERS/ COUNCIL SHARED	ETR	ETR	ETR	ETR	ETR	ETR	
307	RESTROOM	ETR	ETR	ETR	ETR	ETR	ETR	
308	COFFEE	ETR	ETR	ETR	ETR	ETR	ETR	
309	SHARED MEETING	ETR	ETR	ETR	ETR	ETR	ETR	
310	I.T.	ETR	ETR	ETR	ETR	ETR	ETR	
311	MECHANICAL	ETR	ETR	ETR	ETR	ETR	ETR	
312	SUPPLIES	ETR	ETR	ETR	ETR	ETR	ETR	
313	RESERVED	ETR	ETR	ETR	ETR	ETR	ETR	
314	STORAGE	ETR	ETR	ETR	ETR	ETR	ETR	
315	STAFF LOBBY	ETR	ETR	ETR	ETR	ETR	ETR	
316	RESTROOM	ETR	ETR	ETR	ETR	ETR	ETR	
317	RESTROOM	ETR	ETR	ETR	ETR	ETR	ETR	
318	CORRIDOR	ETR	ETR	ETR	ETR	ETR	ETR	
319	RESERVED	ETR	ETR	ETR	ETR	ETR	ETR	
320	RESERVED	ETR	ETR	ETR	ETR	ETR	ETR	
321	RESERVED	ETR	ETR	ETR	ETR	ETR	ETR	
322	RESERVED	ETR	ETR	ETR	ETR	ETR	ETR	
323	RESERVED	ETR	ETR	ETR	ETR	ETR	ETR	
324	RESERVED	ETR	ETR	ETR	ETR	ETR	ETR	

FLOYD COUNTY
ANNEX
RENOVATION 2ND
& 3RD FLOORS 120
W. SPRING

NEW ALBANYINDIANA

ROOM FINISH
SCHEDULE

REVISIONS

2ADDENDUM #207.07.25

Professional Seal of a Registered Professional Architect, State of Indiana, No. 00000000

LVMH
ARCHITECTURE

LVMH ARCHITECTURE + MAF ARCHITECTS
12808 TOWNES PARK WAY, SUITE 200
LOUISVILLE, KY 40243
502.581.0570
WWW.LVMHARCHITECTURE.COM

PROJECT NUMBER

FCI2501












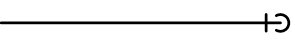
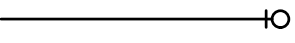



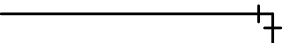
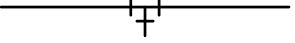
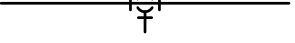
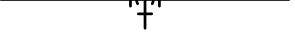
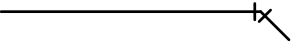
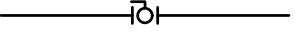
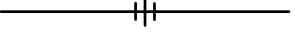
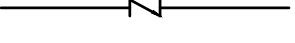

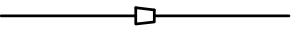
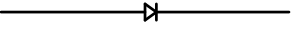
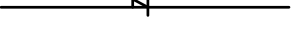

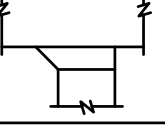
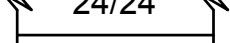

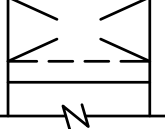

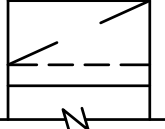
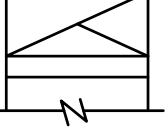
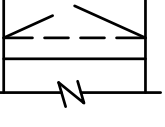




DATE

JUNE 12, 2025

SHEET NUMBER

A15.1

P:\E07825001-ENVOY -- FLOYD COUNTY JUDICIAL CENTER DESIGN\CAD\MECHANICAL\H-0.01.DWG ALLISON R. WILKINS SAVE TIME 5/16/2025 4:42:06 PM PLOT DATE 7/7/2025 11:49 AM

HEATING LEGEND			
SYMBOL	DESCRIPTION	SYMBOL	DESCRIPTION
	TO BE REMOVED		HOT WATER SUPPLY
	NEW CONNECTION TO EXISTING		HOT WATER RETURN
	EXISTING EQUIPMENT		CHILLED WATER SUPPLY
	NEW EQUIPMENT		CHILLED WATER RETURN
ABBREVIATIONS			
AC	AIR COMPRESSOR		HOT WATER PERIMETER SUPPLY
BTUH	BRITISH THERMAL UNITS PER HOUR		HOT WATER PERIMETER RETURN
CA	COMPRESSED AIR		CONDENSATE PUMP DISCHARGE
CFM	CUBIC FEET PER MINUTE		ELBOW DOWN OR AWAY
CHWS	CHILLED WATER SUPPLY		ELBOW UP OR TOWARD
CHWR	CHILLED WATER RETURN		TEE DOWN OR AWAY
DDC	DIRECT DIGITAL CONTROLS		TEE UP OR TOWARD
DP	DIFFERENTIAL PRESSURE		RISE OR DROP
FCU	FAN COIL UNIT		90° ELBOW
F.L.P	FAIL LAST POSITION		PIPE TEE
HWR	HOT WATER RETURN		PIPE TAKEOFF (FROM BOTTOM OF MAIN)
HWS	HOT WATER SUPPLY		PIPE TAKEOFF (FROM TOP OF MAIN)
LPS	LOW PRESSURE STEAM		45° ELBOW
MBH	THOUSAND BTUH		BALL VALVE
MIN	MINIMUM		BUTTERFLY VALVE
SA	SUPPLY AIR		CHECK VALVE
STM	STEAM		SOLENOID
TEMP	TEMPERATURE		REDUCER
VFD	VARIABLE FREQUENCY DRIVE		CONCENTRIC REDUCER
			ECCENTRIC REDUCER
			AIR HANDLING UNIT
			BRANCH DUCT TAP
			RECTANGULAR DUCT (FIRST FIGURE IS SIDE SHOWN) ALL DUCT DIMENSIONS ARE INSIDE CLEAR DIMENSIONS
			SUPPLY DUCT UP OR TOWARD
			SUPPLY DUCT DOWN OR AWAY
			RETURN DUCT UP OR TOWARD
			RETURN DUCT DOWN OR AWAY
			EXHAUST DUCT UP OR TOWARD
			EXHAUST DUCT DOWN OR AWAY
			LAY-IN SUPPLY DIFFUSER WITH CFM
			LAY-IN RETURN GRILLE WITH CFM
			LAY-IN EXHAUST GRILLE WITH CFM
			DUCT-MOUNTED SUPPLY DIFFUSER WITH CFM

- SITE/PROJECT SPECIFIC REQUIREMENTS
1.

EXISTING FINISHES - CONTRACTOR SHALL PROTECT ALL EXISTING FINISHED SURFACES (FLOORS, WALLS, CEILINGS, STEPS, RAILINGS, FURNISHINGS, ETC.) FROM DAMAGE DURING THE PROJECT. CONTRACT SHALL PAY ALL COSTS INCURRED TO REPAIR OR REPLACE COMPONENTS DAMAGED AS A RESULT OF WORK DONE FOR THE PROJECT.
2.

TEMPORARY REMOVAL OF COMPONENTS - CONTRACTOR MAY TEMPORARILY REMOVE EXISTING DOORS, RAILINGS, FURNISHINGS, ETC. WHILE LOADING AND UNLOADING EQUIPMENT. CONTRACTOR SHALL STORE AND PROTECT ANY ITEMS FROM DAMAGE. CONTRACTOR SHALL PROMPTLY REINSTALL OR REPLACE ANY REMOVED COMPONENTS ONCE ADDITIONAL CLEARANCE IS NOT NEEDED.
3.

CONTRACTOR SHALL TEMPORARILY REMOVE EXISTING CEILING-MOUNTED EQUIPMENT AS NEEDED TO PERFORM WORK. REMOVED ITEMS SHALL BE SAVED AND REINSTALLED PRIOR TO COMPLETION OF PROJECT.

- GENERAL HVAC DEMOLITION NOTES
1.

VERIFY EXACT SIZE AND LOCATION OF EXISTING UTILITIES PRIOR TO START OF DEMOLITION
2.

UNLESS OTHERWISE NOTED, REMOVAL OF PIPING AND/OR EQUIPMENT SHALL INCLUDE ALL INSULATION, VALVES, HANGERS, SUPPORTS, EQUIPMENT PADS, FLASHING, ROOF CURBS, CONTROLS, AND ASSOCIATED VALVES, FITTINGS AND ACCESSORIES.
3.

UNLESS OTHERWISE NOTED, REMOVAL OF PIPING SHALL BE BACK TO THE MAIN OR LAST ACTIVE SERVICE. REMAINING PIPE SHALL BE CAPPED.
4.

ALL OPENINGS OR HOLES LEFT IN EXISTING WALLS, FLOORS, AND CEILINGS TO REMAIN, INCLUDES CHASES, SHALL BE PATCHED TO MATCH EXISTING CONDITIONS BY THE CONTRACTOR WHOSE WORK HAS CREATED THE OPENING OR HOLE.
5.

EXISTING CONDITIONS WERE OBTAINED THROUGH FIELD OBSERVATION AND AVAILABLE DRAWINGS.
6.

DISCONNECT ALL HEATING PIPING CONNECTIONS AND DUCTWORK CONNECTIONS TO EQUIPMENT BEING REMOVED.
7.

REMOVAL OF CONTROLS SHALL INCLUDE ALL WIRING BACK TO SOURCE INCLUDING ANY SUPPORTS, BOXES, CONDUITS AND ACCESSORIES.
8.

REMOVAL OF PNEUMATIC CONTROLS SHALL INCLUDE ALL PNEUMATIC TUBING AND ACCESSORIES. REMOVE PIPING AND CAP AT LAST ACTIVE SOURCE.
9.

DISCONNECT ALL DUCTWORK CONNECTIONS TO EQUIPMENT BEING REMOVED.

- GENERAL HVAC NOTES
1.

DUCTWORK AND PIPING IS SHOWN IN SCHEMATIC FORM ONLY, OFFSETS AND CHANGES IN ELEVATIONS ARE NOT NECESSARILY SHOWN. ROUTE DUCTWORK IN AN ORDERLY MANNER AS REQUIRED FOR CLEARANCE WITH STRUCTURAL CONDITIONS. COORDINATE LOCATION OF DUCTWORK WITH OTHER TRADES PRIOR TO INSTALLATION.
2.

COORDINATE LOCATIONS AND SIZES OF CONNECTIONS TO EQUIPMENT WITH ALL TRADES.
3.

CONTRACTOR SHALL BE RESPONSIBLE FOR PROVIDING ADEQUATE SUPPORTING SYSTEMS AND DEVICES FOR ALL DUCTWORK, PIPING, HVAC EQUIPMENT, AND ACCESSORIES.
4.

PROVIDE AND INSTALL SLEEVES FOR ALL DUCTWORK AND PIPING PASSING THROUGH WALLS AND FLOORS.
5.

PROVIDE RIGID METAL DUCT, WITH NO EXCEPTION, WHERE FIRE AND/OR SMOKE RATED WALLS, CEILINGS, AND FLOORS ARE PENETRATED.
6.

LOCATE AND INSTALL ALL HVAC EQUIPMENT TO PROVIDE MANUFACTURER'S MINIMUM SERVICE CLEARANCES.
7.

CONNECTIONS TO EQUIPMENT SHALL BE PROVIDED WITH ISOLATION VALVES AND UNIONS TO FACILITATE EQUIPMENT REMOVAL.
8.

PIPING IS SHOWN IN SCHEMATIC FOR ONLY, CHANGES IN ELEVATION ARE NOT NECESSARILY SHOWN. ROUTE PIPING IN AN ORDERLY MANNER AS REQUIRED FOR CLEARANCE WITH STRUCTURAL CONDITIONS. COORDINATE LOCATION OF PIPING WITH OTHER TRADES PRIOR TO INSTALLATION. WHERE POSSIBLE, RACK PIPING HORIZONTALLY OR VERTICALLY.
9.

SEE HEATING DETAILS FOR EXACT PIPING CONNECTIONS TO EQUIPMENT, INCLUDING VALVES, TRAPS, AND SYSTEM ACCESSORIES.
10.

BALANCING VALVES SHALL BE, AT MINIMUM, ONE PIPE SIZE SMALLER THAN THE PIPING IN WHICH THEY ARE INSTALLED. CONTRACTOR SHALL VERIFY THAT VALVE CAN BE ADJUSTED TO MEET FLOW REQUIREMENTS WITHOUT THE PRODUCTION OF UNACCEPTABLE NOISE.
11.

THE LOCATIONS AND SIZES OF EXISTING DUCTWORK, PIPING, AND EQUIPMENT HAS BEEN TAKEN FROM "AS-BUILT" DRAWINGS AND INFORMATION PROVIDED BY THE OWNER. CONTRACTOR SHALL FIELD VERIFY ALL EXISTING CONDITIONS PRIOR TO START OF WORK.
12.

ALL CONNECTIONS TO, OR SHUTDOWNS OF, EXISTING SYSTEMS SHALL BE COORDINATED WITH THE OWNER TO PROVIDE MINIMUM INTERFERENCE WITH THEIR OPERATION AND DOWNTIME OF THE SYSTEM.
13.

SEAL ALL PENETRATIONS OF FIRE AND SMOKE RATED WALLS, CEILINGS, AND FLOORS IN ACCORDANCE WITH THE PROJECT MANUAL. CORRIDOR WALLS THAT ARE BUILT TO DECK SHALL BE TREATED AS FIRE RATED WALLS.



DESIGN FIRM REGISTRATION NO. 184-000450

125 W. CHURCH STREET
CHAMPAIGN, IL 61820
PHONE : 217.373.8900 www.clarkdietz.com

PROJECT TITLE

E07825001 ENVOY - FLOYD
COUNTY ANNEX
RENOVATION

DESIGNED BY: ARW

DRAWN BY: ARW

CHECKED BY: NTP

DATE CHECKED: 05/16/25

07/03/25

ADDENDUM #1

DRAWING TITLE


MECHANICAL GENERAL
NOTES LEGEND AND
ABBREVIATIONS

PROJECT No.

E07825001


DRAWING No.

H-0.01

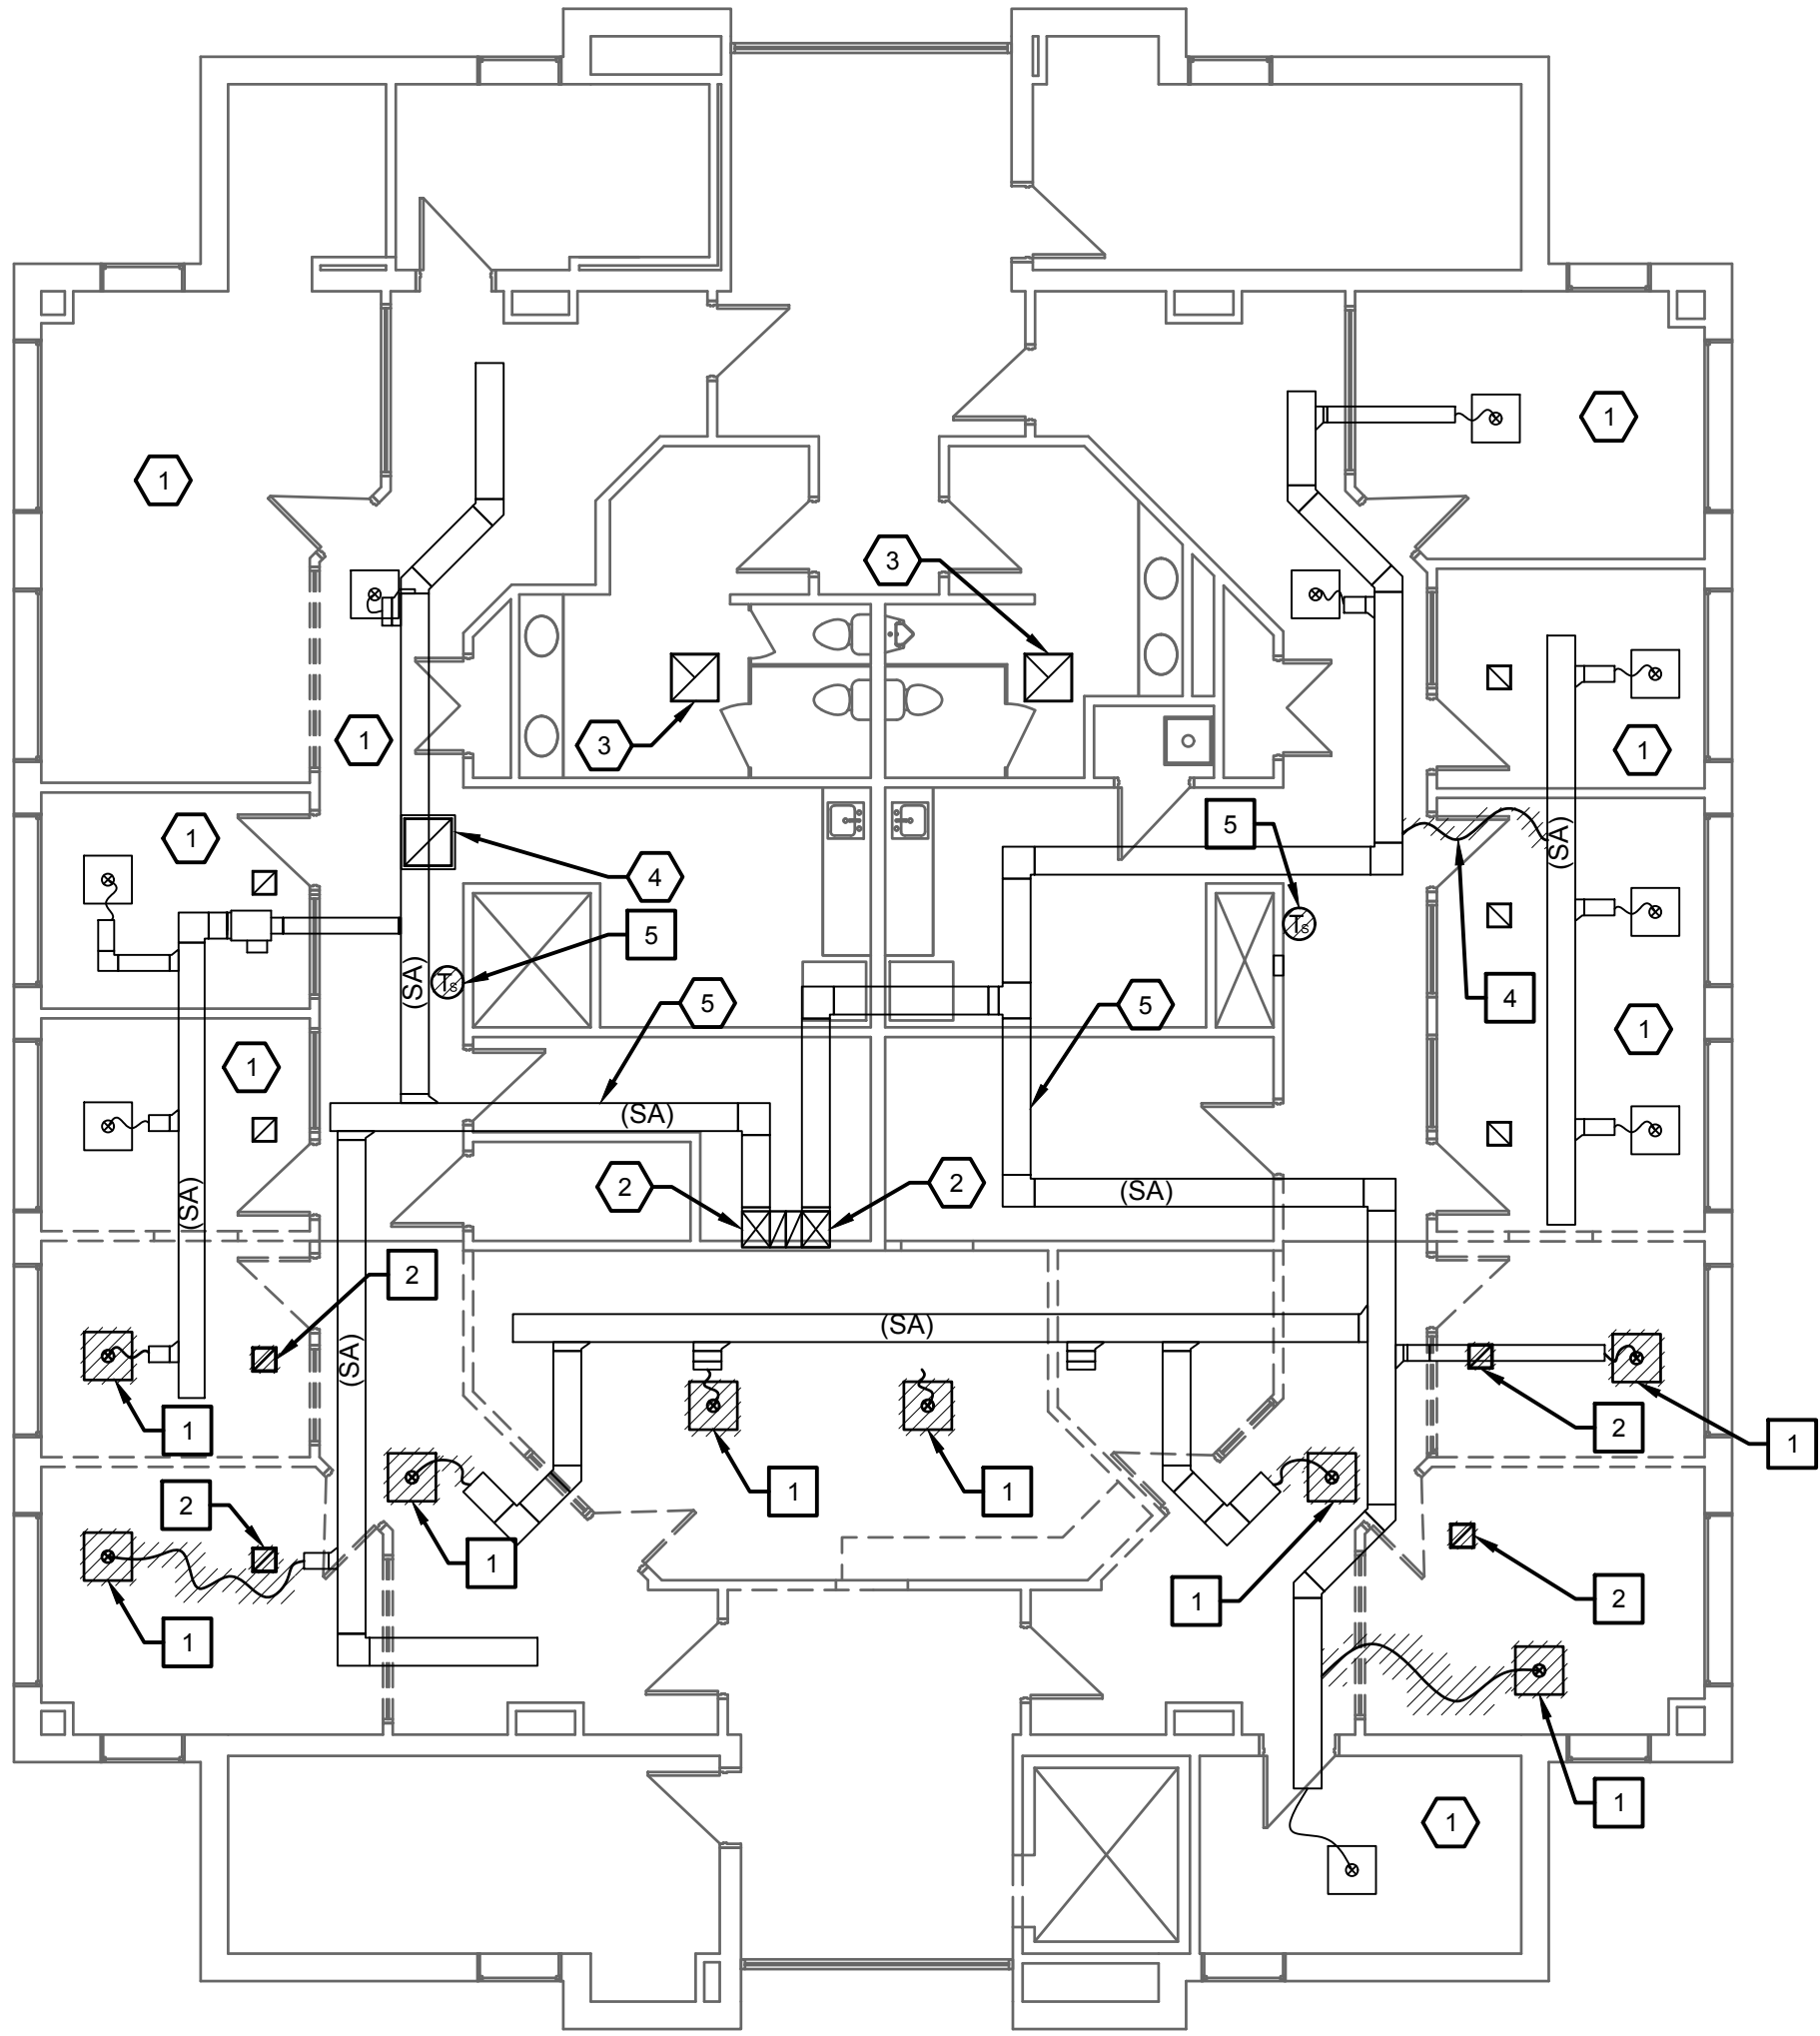

1 SECOND FLOOR MECHANICAL DEMO PLAN

0 2' 4' 8' 16'

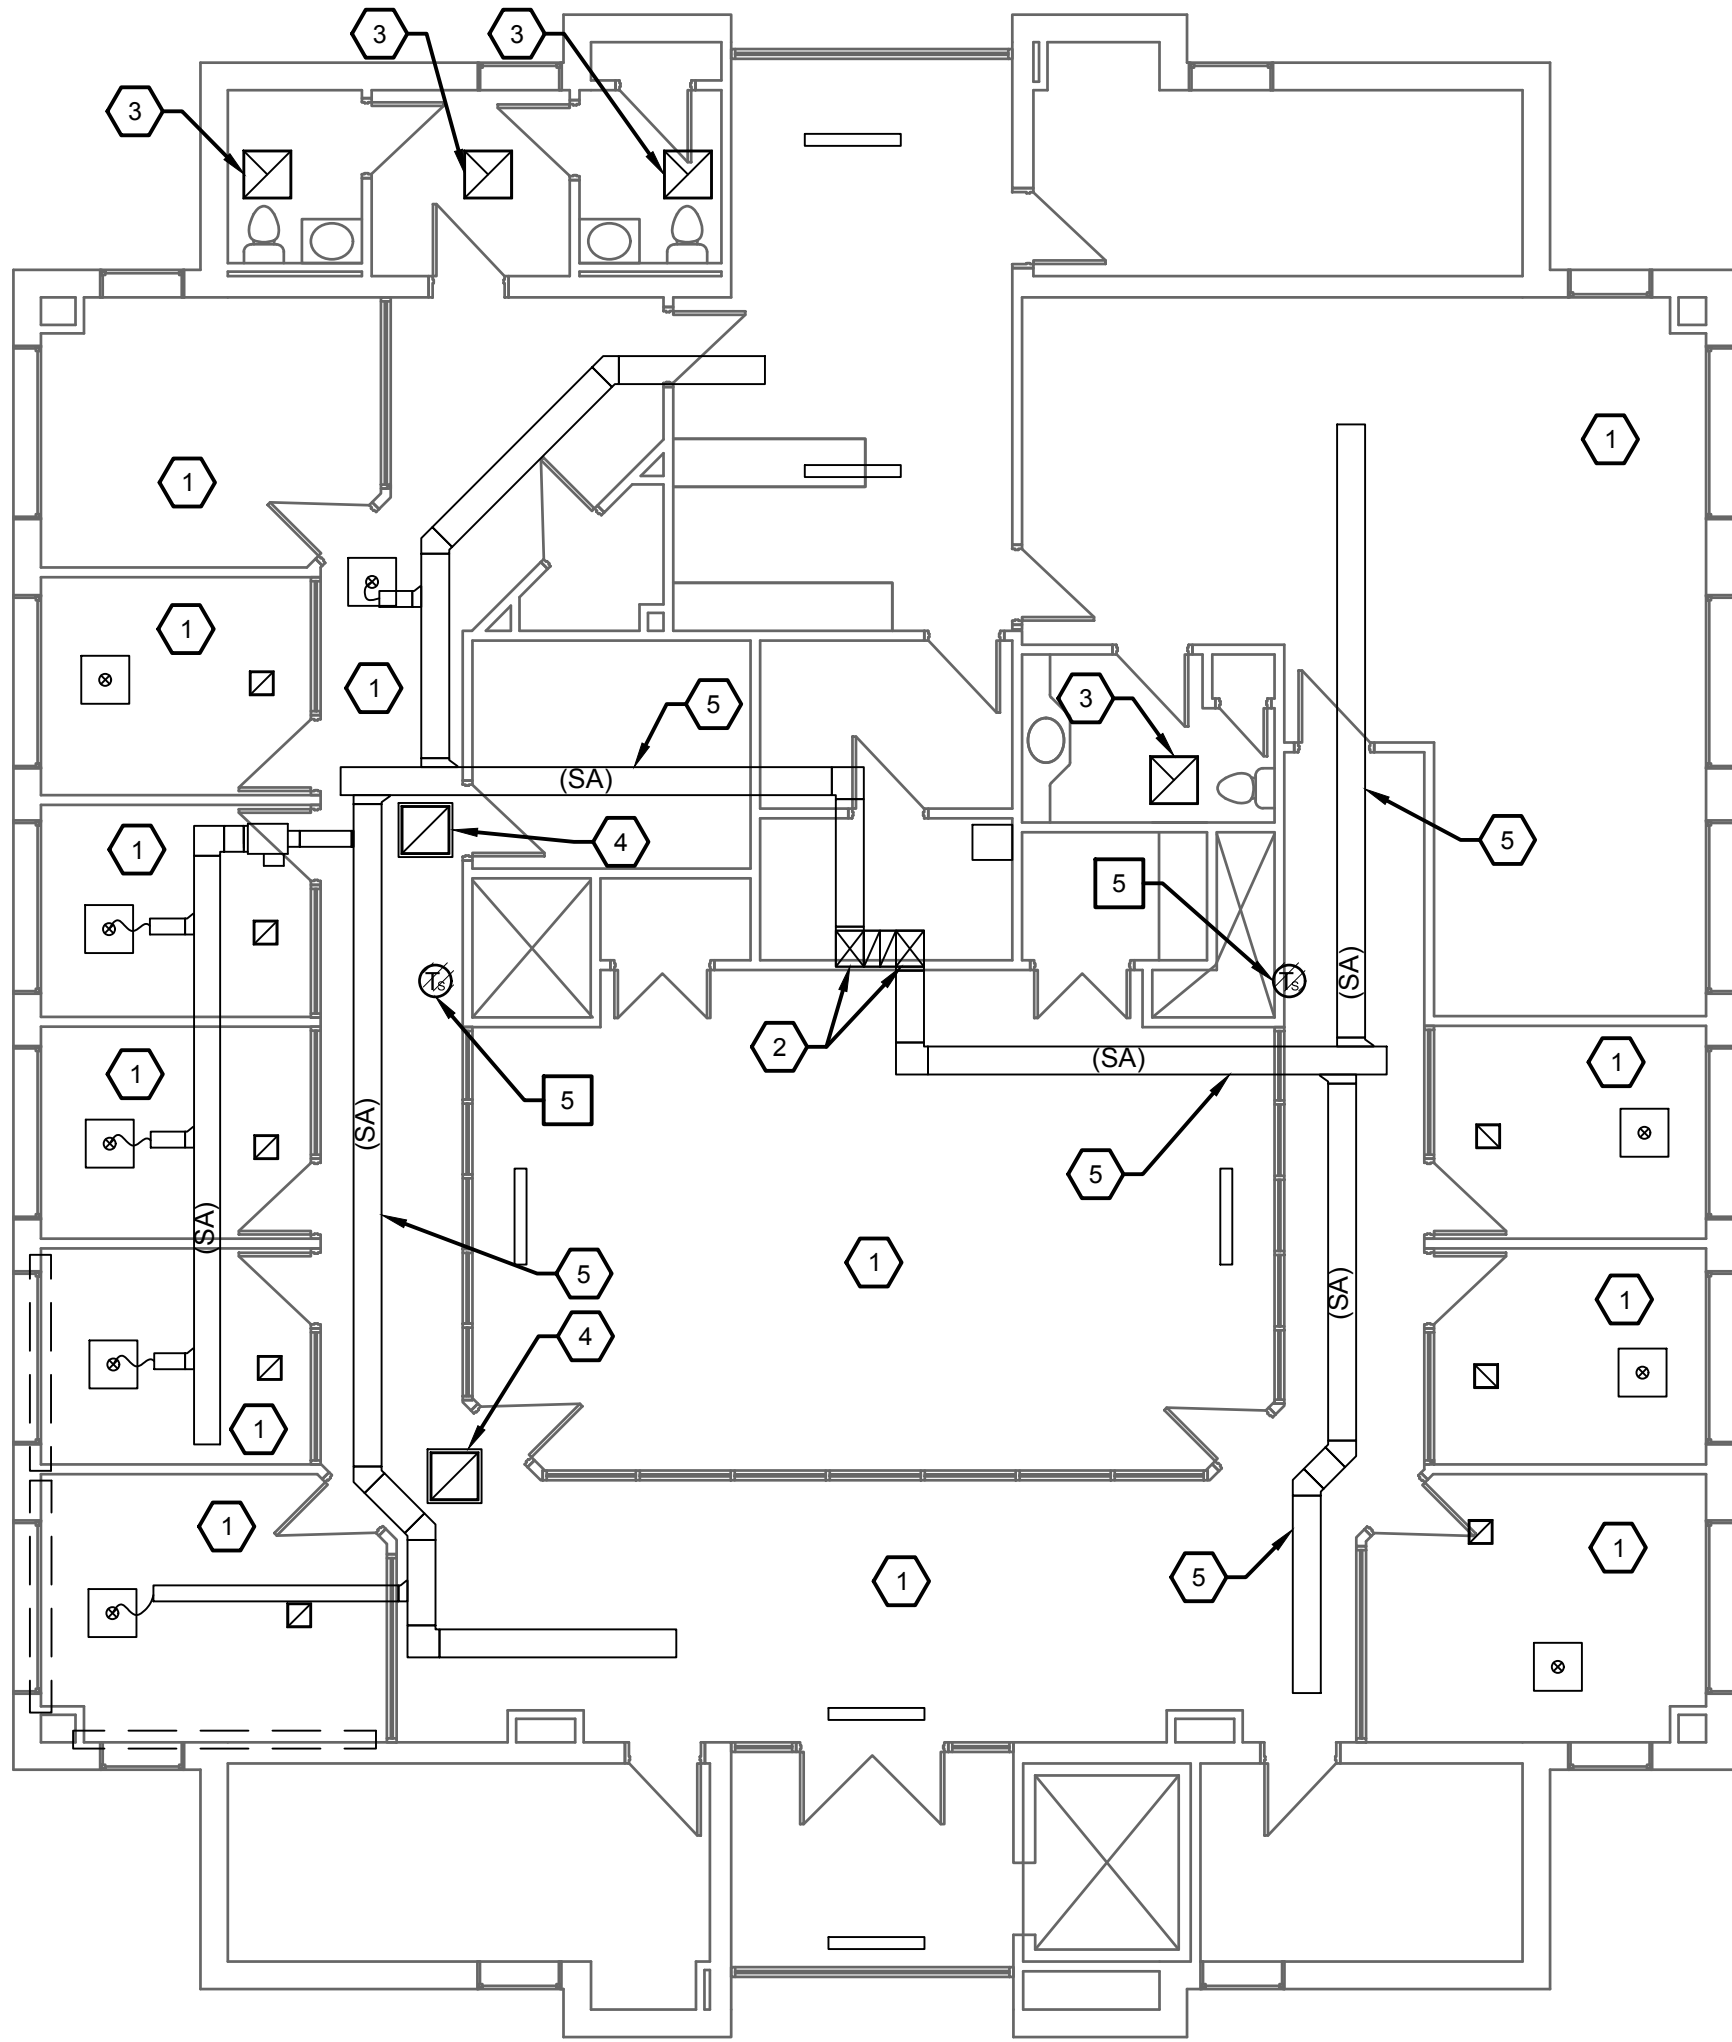

2 THIRD FLOOR MECHANICAL DEMO PLAN

0 2' 4' 8' 16'

NOTES (THIS SHEET)

1. SEE SHEET H-001 FOR SYMBOLS AND ABBREVIATIONS.

DEMOLITION KEYNOTES

1. REMOVE EXISTING SUPPLY DIFFUSER AND FLEX DUCTWORK.
2. REMOVE EXISTING RETURN GRILLE.
3. REMOVE EXISTING EXHAUST GRILLE. CAP EXISTING EXHAUST DUCTWORK.
4. REMOVE EXISTING FLEX DUCTWORK.
5. REMOVE EXISTING THERMOSTAT. THERMOSTAT TO BE RELOCATED. SEE H-2.01.

KEYNOTES (THIS SHEET)

1. EXISTING SUPPLY DIFFUSERS AND RETURN GRILLES TO REMAIN.
2. EXISTING 5 TON HEAT PUMP TO REMAIN.
3. EXISTING EXHAUST GRILLE TO REMAIN.
4. EXISTING RETURN GRILLE TO REMAIN.
5. EXISTING SUPPLY DUCTWORK ABOVE CEILING TO REMAIN.



1. SEE SHEET H-001 FOR SYMBOLS AND ABBREVIATIONS.
2. SECOND AND THIRD FLOORS ARE PLENUM RETURN.

KEYNOTES (THIS SHEET)

1. EXISTING SUPPLY DIFFUSERS AND RETURN GRILLES TO REMAIN. CONTRACTOR TO FIELD VERIFY NUMBER OF GRILLES AND DIFFUSERS. PROVIDE NEW BALANCING DAMPER FOR ALL SUPPLY DIFFUSERS. BALANCE DIFFUSERS TO CFM LISTED PER ROOM.
2. NEW SUPPLY DIFFUSER. PROVIDE NEW BALANCING DAMPER. BALANCE ALL DIFFUSERS TO CFM LISTED PER ROOM. PROVIDE FLEX DUCTWORK CONNECTION. SEE SCHEDULE.
3. NEW RETURN GRILLE. SEE SCHEDULE.
4. NEW SUPPLY DIFFUSER. SEE SCHEDULE.
5. NEW SUPPLY DUCTWORK. MATCH EXISTING SUPPLY DUCTWORK SIZE. MAKE CONNECTION TO EXISTING SUPPLY DUCTWORK.
6. NEW SUPPLY DUCTWORK. MAKE CONNECTION TO EXISTING SUPPLY DUCTWORK.
7. NEW OUTDOOR AIR DUCTWORK. MAKE CONNECTION TO EXISTING RETURN DUCTWORK ABOVE CEILING ABOVE EXISTING HEAT PUMP UNIT.
8. EXISTING 5 TON HEAT PUMP TO REMAIN.
9. EXISTING EXHAUST GRILLE TO REMAIN.
10. PROVIDE NEW INLINE SUPPLY FAN ABOVE CEILING. MAKE CONNECTION TO EXISTING OA DUCTWORK. FAN SHALL RUN BASED ON EXISTING HEAT PUMP OPERATIONS. RUN FAN WHENEVER HEAT PUMPS ARE RUNNING. SEE SCHEDULE.
11. EXISTING RETURN GRILLE TO REMAIN.
12. EXISTING OUTDOOR AIR DUCTWORK IN EXISTING SHAFT.
13. EXISTING LINEAR SLOT DIFFUSER TO REMAIN. PROVIDE NEW BALANCING DAMPER. BALANCE ALL DIFFUSERS TO CFM LISTED PER ROOM.
14. RELOCATE EXISTING TSTAT TO NEW LOCATION. PROVIDE NEW WIRE BACK TO UNIT. MAKE FINAL CONNECTION. ROUTE NEW WIRING IN EXISTING WALL CAVITY AND UP ABOVE CEILING.



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PROJECT TITLE

E07825001 ENVOY - FLOYD
COUNTY ANNEX
RENNOVATION

DESIGNED BY:	ARW
DRAWN BY:	ARW
CHECKED BY:	NTP
DATE CHECKED:	05/16/25

07/03/25 ADDENDUM #1

DATE	REVISION
------	----------

DRAWING TITLE

SECOND & THIRD FLOOR MECHANICAL NEW PLAN

PROJECT No.
07825001

DRAWING No

H-2.01

GRILLES & DIFFUSER SCHEDULE											
TAG	TYPE	FACE SIZE	AIR PATTERN	THROW (FEET)	MOUNTING	MATERIAL	FINISH	MAX N.C. LEVEL	NOTES	DESIGN BASIS	
										MANUFACTURER	MODEL NUMBER
SD-1	SQUARE PLAQUE CEILING DIFFUSER	24x24	4-WAY	VARIES	LAY-IN	ALUMINUM	WHITE	30		PRICE	SPD
RG-1	3/4" LOUVER GRILLE 45 DEGREE	24X24	-	-	LAY-IN	ALUMINUM	WHITE	30		PRICE	600

FAN SCHEDULE													
TAG	SERVICE	AIR VOL. (CFM)	EXT. S.P. (IN. W.C.)	MTR.SPEED (RPM)	MOTOR HP	DRIVE	FAN TYPE	ELECTRIC DATA			REMARKS	DESIGN BASIS	
	LOCATION							V	PH	HZ		MANUFACTURER	MODEL NUMBER
SF-1	OA INTAKE 2ND FLOOR	550	0.5	1725	1/6	DIRECT	INLINE	120	1	60	XX	GREENHECK	SQ-95
SF-2	OA INTAKE 3RD FLOOR	550	0.5	1725	1/6	DIRECT	INLINE	120	1	60	XX	GREENHECK	SQ-95
NOTES:													
1. XX													



AIR INLET/OUTLET CONNECTION SCHEDULE				
SYMBOL	TAG	NECK SIZE	DUCT SIZE	REMARKS
A1	SD-1	6"	-	NOTES 1, 2
A2	SD-1	8"	-	NOTES 1, 2
B1	RG-1	-	-	NOTES 1, 2
NOTES				
1. UNLESS OTHERWISE NOTED, ALL BRANCH DUCTWORK TO AIR INLET/OUTLET SHALL EQUAL THE SCHEDULED NECK SIZE. PROVIDE TRANSITIONS AS REQUIRED.				
2. PROVIDE VOLUME DAMPER FOR EACH DIFFUSER.				

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PROJECT TITLE

E07825001 ENVOY - FLOYD COUNTY ANNEX RENNOVATION

DATE

REVISION

DRAWING TITLE


MECHANICAL SCHEDULES

PROJECT No.


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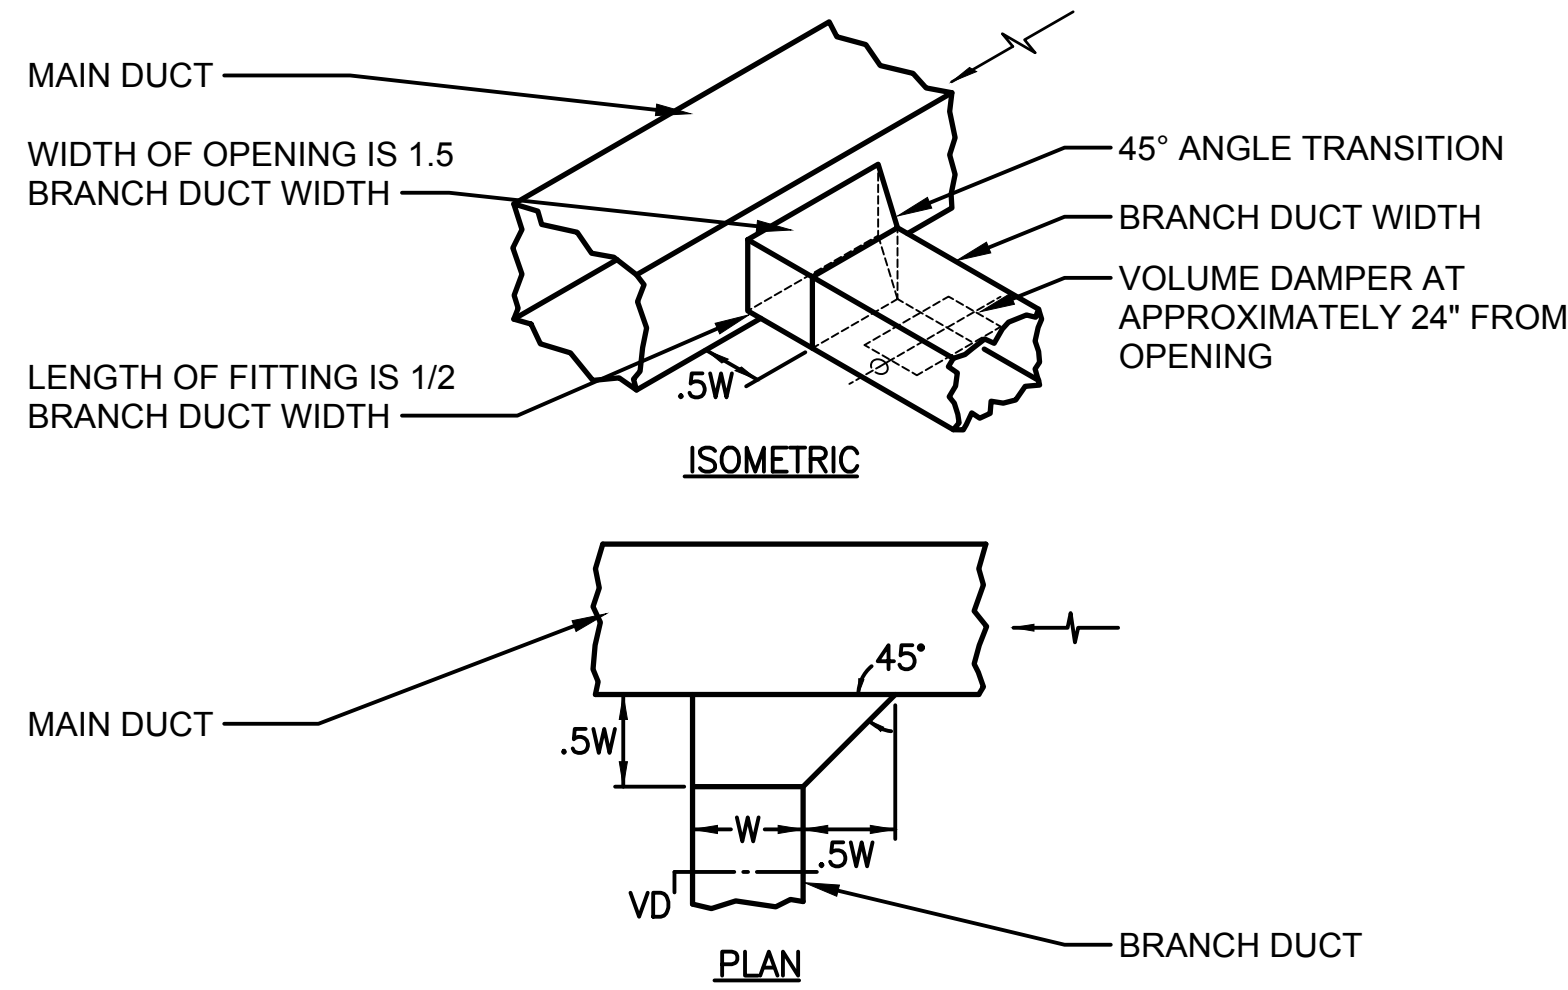
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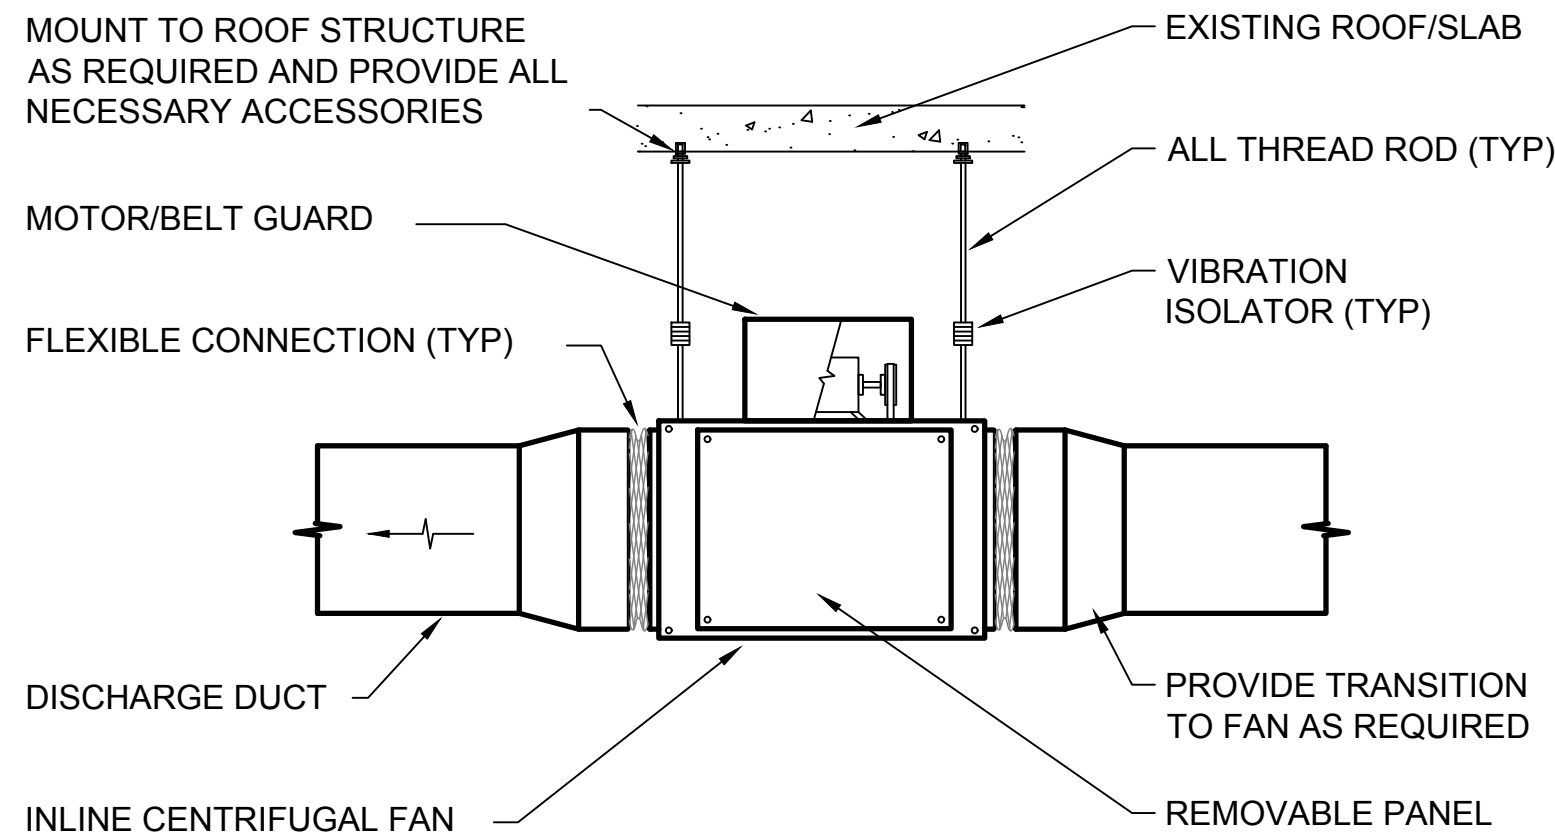
1 **DIFFUSER/GRILLE CONNECTION**
NO SCALE



2 **DUCT CONNECTIONS**
NO SCALE

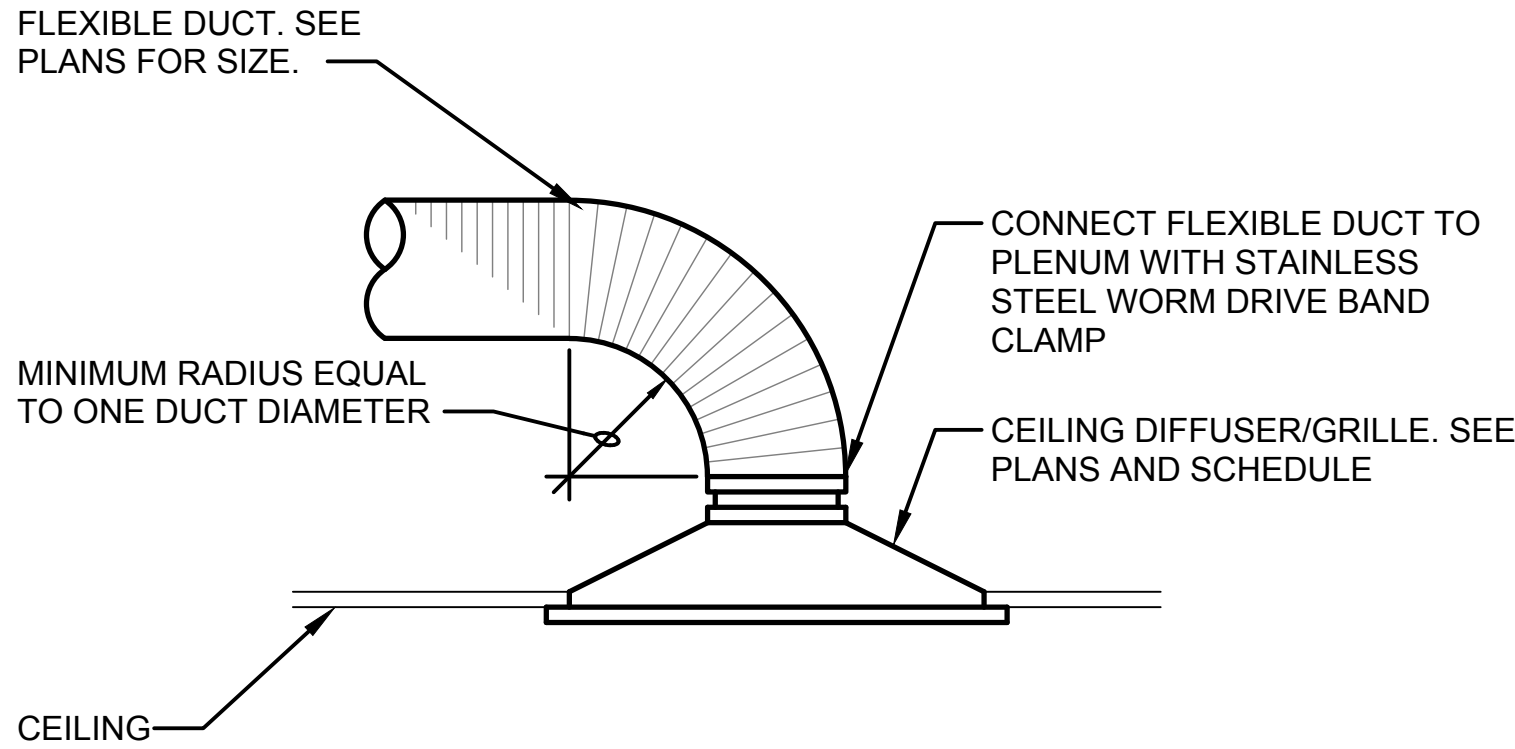

3 **BRANCH TAKEOFF FITTING W/VD**
NO SCALE

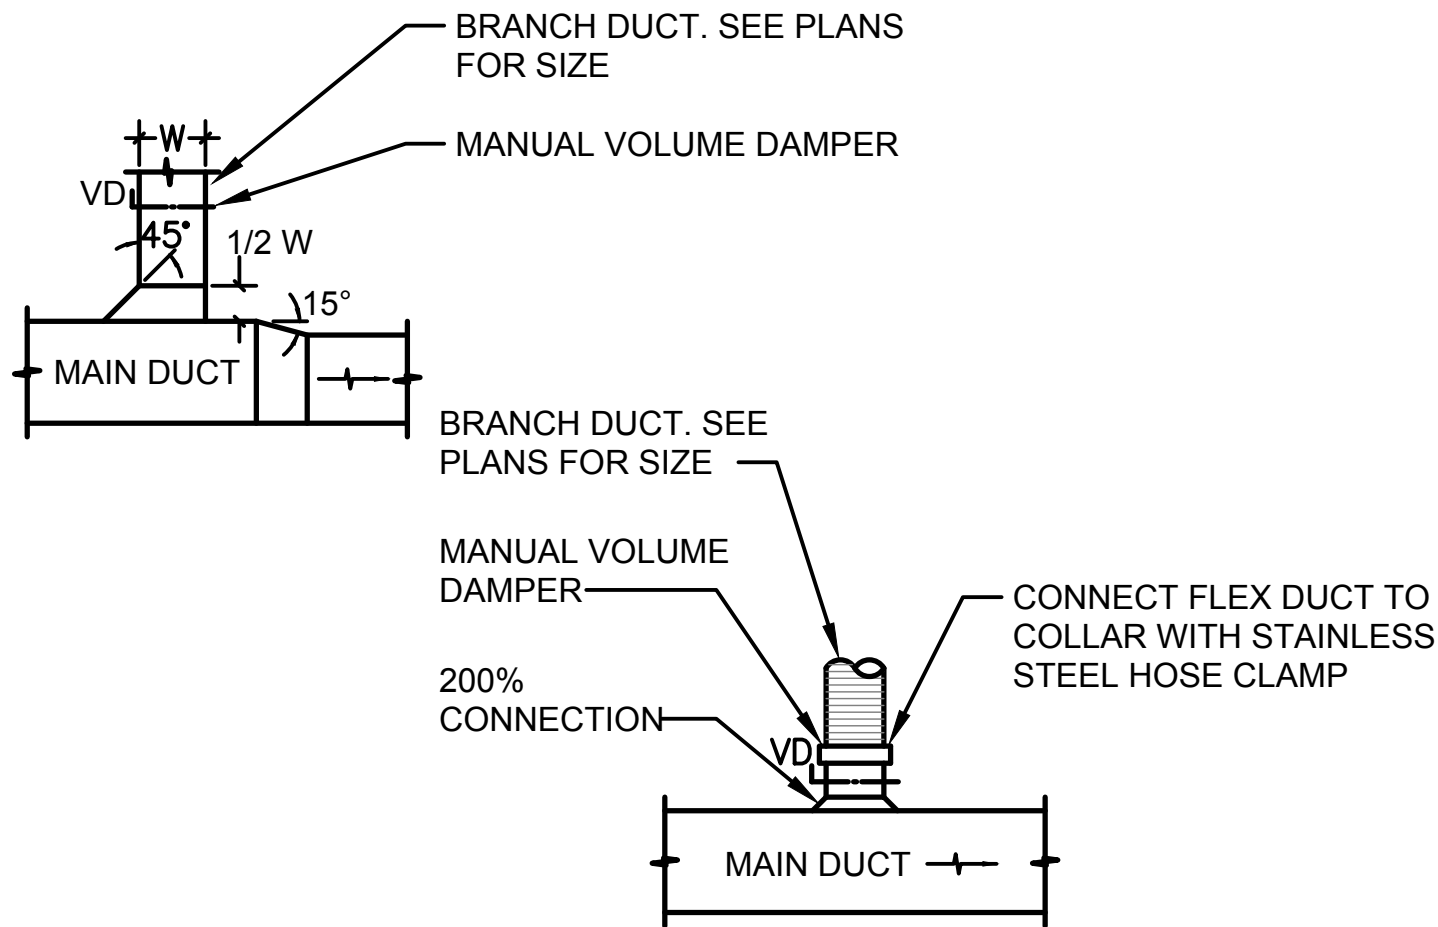

NOTE: SEE ARCHITECTURAL DRAWINGS FOR EXACT ROOF DETAILS

4 **INLINE CENTRIFUGAL FAN INSTALLATION**
NO SCALE

ELECTRICAL GENERAL NOTES

1.

ALL WORK SHALL CONFORM TO THE 2020 NATIONAL ELECTRICAL CODE AND ALL APPLICABLE CODES, THE MOST CURRENT EDITION OF THE NATIONAL ELECTRICAL SAFETY CODE, AND ALL APPLICABLE LOCAL ORDINANCES.
2.

CONTRACTOR SHALL FURNISH ALL MATERIALS FOR A COMPLETE AND WORKABLE SYSTEM. ALL MATERIALS FURNISHED BY THE CONTRACTOR ARE TO BE NEW.
3.

CONTRACTOR SHALL COORDINATE AND SCHEDULE ALL OUTAGES OF POWER, FIRE ALARM, DATA AND TELEPHONE SERVICES WITH THE USING AGENCY. CONTRACTOR SHALL PROVIDE MINIMUM OF 2 WEEKS ADVANCE NOTICE PRIOR TO ANY OUTAGE.
4.

THE USING AGENCY SHALL HAVE "FIRST RIGHT OF REFUSAL" FOR ALL REMOVED ELECTRICAL EQUIPMENT (PANELS, BREAKERS, ETC...).
5.

CONTRACTOR IS RESPONSIBLE FOR DISPOSAL OF ALL MATERIALS REMOVED AS PART OF THIS PROJECT THAT THE USING AGENCY DOES NOT WANT TURNED OVER TO THEM. DISPOSAL SHALL BE IN ACCORDANCE WITH ALL APPLICABLE REGULATIONS. ALL DISPOSAL SHALL BE AT THE CONTRACTOR'S EXPENSE.
6.

ALL PANELBOARDS SHALL BE KEYED WITH A FAB-7 KEY.
7.

CONTRACTOR SHALL REMOVE ALL UNUSED CONDUIT AND WIRE BACK TO SOURCE. CONCEALED CONDUIT BELOW SLAB, UNDERGROUND, OR IN WALLS MAY REMAIN IN PLACE. UNUSED CONDUITS LOCATED ABOVE SUSPENDED CEILINGS SHALL BE CONSIDERED EXPOSED AND SHALL BE REMOVED.
8.

ALL EQUIPMENT SHOWN ON THE DRAWINGS IS NEW UNLESS OTHERWISE NOTED AS EXISTING OR RELOCATED.
9.

ALL CONDUIT PENETRATIONS SHALL BE THE MINIMUM SIZE REQUIRED FOR THE CONDUIT. ALL NEW OR EXISTING OPENINGS BEING USED FOR CONDUIT PENETRATIONS IN EXISTING WALLS, FLOORS AND CEILINGS NOT BEING DEMOLISHED, INCLUDING CHASES, SHALL BE SEALED WITH FIRE CAULK AND PATCHED TO MATCH EXISTING CONDITIONS BY THE CONTRACTOR WHOSE WORK HAS CREATED THE OPENING. IF LARGE HOLES ARE CREATED OR USED, THEN THEY SHALL BE SEALED WITH MASONRY. ALL HOLES IN WALLS WHERE ELECTRICAL EQUIPMENT IS BEING REMOVED (I.E. BOXES, SURFACE RACEWAY, CONDUIT, ETC.) SHALL BE PATCHED AND PAINTED OR HOLES FILLED WITH GROUT TO MATCH EXISTING CONDITIONS BY ELECTRICAL CONTRACTOR. EXISTING UNUSED OPENINGS DO NOT NEED TO BE REPAIRED.
10.

ALL INTERIOR CONDUIT SHALL BE EMT TYPE (3/4" MINIMUM UNLESS NOTED OTHERWISE). ALL CONDUIT IN TUNNELS AND OUTSIDE SHALL BE RIGID GALVANIZED STEEL.
11.

CONTRACTOR SHALL PROVIDE BLANK STAINLESS STEEL COVER PLATES FOR ALL UNUSED WALLBOXES.
12.

ALL INTERIOR SURFACE RACEWAY AND EXPOSED INTERIOR CONDUIT SHALL BE EMT TYPE CONDUIT UNLESS NOTED OTHERWISE.
13.

CONTRACTOR SHALL INDICATE ALL CORRECT CIRCUIT NUMBERS FOR ALL NEW OR MODIFIED LOADS (I.E. LIGHTING CIRCUITS, ADDED RECEPTACLES, MOTOR LOADS, ETC.) ON THE RECORD DRAWINGS.
14.

CONTRACTOR SHALL INCLUDE ALL PREMIUM TIME REQUIRED TO PERFORM OUTAGES AS CONVENIENT FOR THE USING AGENCY. NO ADDITIONAL COMPENSATION WILL BE ALLOWED FOR OUTAGES PERFORMED AT NIGHT, ON WEEKENDS OR ON HOLIDAYS.
15.

CONTRACTOR SHALL INCLUDE ALL PREMIUM TIME REQUIRED TO PERFORM ANY NOISY, DISRUPTIVE OR HAZARDOUS WORK. THIS WORK SHALL BE PERFORMED AFTER NORMAL HOURS OR ON WEEKENDS.
16.

ALL BRANCH CIRCUIT WIRING SHALL BE 2#12, 1#12G UNLESS NOTED OTHERWISE. UTILIZE EXISTING CONDUIT WHERE POSSIBLE.
17.

ALL ELECTRICAL DEVICES (SWITCHES, RECEPTACLES, ETC...) SHALL BE BROWN IN COLOR. ALL COVERPLATES SHALL BE STAINLESS STEEL TYPE.
18.

THERE HAS BEEN LEAD PAINT ENCOUNTERED IN SOME LOCATIONS WITHIN THE BUILDINGS. IF LEAD PAINT IS ENCOUNTERED THE CONTRACTOR SHALL HANDLE APPROPRIATELY PER SPEC SECTION 02 83 00.
19.

APPLICATION FOR BUILDING CREDENTIAL WILL BE PROVIDED BY THE USING AGENCY AND WILL NEED TO BE FILLED OUT BY THE CONTRACTOR AND RETURNED FOR BADGING PRIOR TO ANY WORK BEING PERFORMED.
20.

THE CONTRACTOR IS RESPONSIBLE FOR FOLLOWING ALL USING AGENCY PROCEDURES IDENTIFIED IN THE USING AGENCY'S FIRE ALARM SYSTEM DEVICE IMPAIRMENT NOTICE PROCEDURES.
21.












ONSITE PARKING IS NOT AVAILABLE FOR THE CONTRACTOR'S VEHICLES.
22.

ALL NEW RECEPTACLE COVERPLATES SHALL BE STAINLESS STEEL. PROVIDE AN ENGRAVED PLATE WITH THE PANEL AND CIRCUIT # FEEDING THE RECEPTACLE MOUNTED TO THE COVERPLATE.
23.

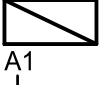ALL NEW RECEPTACLES THAT ARE BEING FED FROM AN EMERGENCY PANEL SHALL BE RED IN COLOR.
24.

WHERE THE CONTRACTOR ABANDONS CONCEALED CONDUIT IN PLACE, THE CONTRACTOR SHALL PROVIDE A TAG AT EACH END INDICATING "ABANDONED CONDUIT". CONTRACTOR SHALL PLUG ALL CONDUITS THAT THEY ABANDON IN PLACE.

ELECTRICAL SYMBOL LIST

	EXISTING PANELBOARD
	FIRE ALARM SMOKE DETECTOR, CEILING MOUNTED
	FIRE ALARM NOTIFICATION DEVICE
	EQUIPMENT TO BE REMOVED
	TYPICAL LIGHT FIXTURE DESIGNATION
	INDICATES FIXTURE TYPE
	LIGHT FIXTURE, RECESSED MOUNTED
	EXIT SIGN, CEILING MOUNTED
	LIGHT SWITCH, 1 POLE
	LIGHT SWITCH, 3-WAY
	CARD READER

ELECTRICAL ABBREVIATIONS

A	AMPERES	KV	KILO-VOLT
AC	ABOVE COUNTER	KVA	KILO-VOLT AMPERES
AFF	ABOVE FINISHED FLOOR	KW	KILOWATTS
ALUM	ALUMINUM	LBS	POUNDS
ASPH	ASPHALT	MC	MECHANICAL CONTRACTOR
AWG	AMERICAN WIRE GAUGE	MCC	MOTOR CONTROL CENTER
C	CONDUIT	MCP	MOTOR CIRCUIT PROTECTOR
CKT	CIRCUIT	MFR	MANUFACTURER
CLG	CEILING	MLO	MAIN LUG ONLY
CONC	CONCRETE	MMS	MANUAL MOTOR STARTER
CONT	CONTINUED	MSWB	MAIN SWITCHBOARD
CSDS	COMBINATION STARTER/DISC. SW.	NB	NEUTRAL BUS
D	DEPTH	NW	NEUTRAL WINDING
DDC	DIRECT DIGITAL CONTROL	OC	OVERCURRENT
DN	DOWN	OL'S	OVERLOAD RELAYS
E	ELECTRIC	P	POLE, PUMP
EA	EACH	PH	PHASE
EBJ	EQUIPMENT BONDING JUMPER	PLC	PROGRAMMABLE LOGIC CONTROLLER
EC	ELECTRICAL CONTRACTOR	PRI	PRIMARY
ENC	ENCLOSURE	RGS	RIGID GALVANIZED STEEL
EM	EMERGENCY	RPM	REVOLUTIONS PER MINUTE
ETM	ELAPSED TIME METER	SBJ	SYSTEM BONDING JUMPER
FDR	FEEDER	SEC	SECONDARY
FLA	FULL LOAD AMPERES	SS	STAINLESS STEEL
FLUOR	FLUORESCENT	T	TELEPHONE
FVNR	FULL VOLTAGE NON-REVERSING	TSP	TWISTED SHIELDED PAIR
FVZS	FULL VOLTAGE Z-SPEED	TYP	TYPICAL
G,GND	GROUND	UL	UNDERWRITER'S LABORATORY
GB	GROUND BUS	UPS	UNINTERRUPTIBLE POWER SUPPLY
GC	GENERAL CONTRACTOR	V	VOLTS
GFI	GROUND FAULT INTERRUPTER	VA	VOLT AMPERES
HP	HORSEPOWER	VFD	VARIABLE FREQUENCY DRIVE
HRG	HIGH RESISTANCE GROUND	W	WATTS
I/O	INPUT/OUTPUT	WP	WEATHER PROOF
IN	INCHES	XFMR	TRANSFORMER

PROJECT TITLE

E07825001 ENVOY - FLOYD
COUNTY ANNEX
RENOVATION

DRAWING TITLE

ELECTRICAL GENERAL NOTES
LEGEND AND ABBREVIATIONS

PROJECT No.

E07825001


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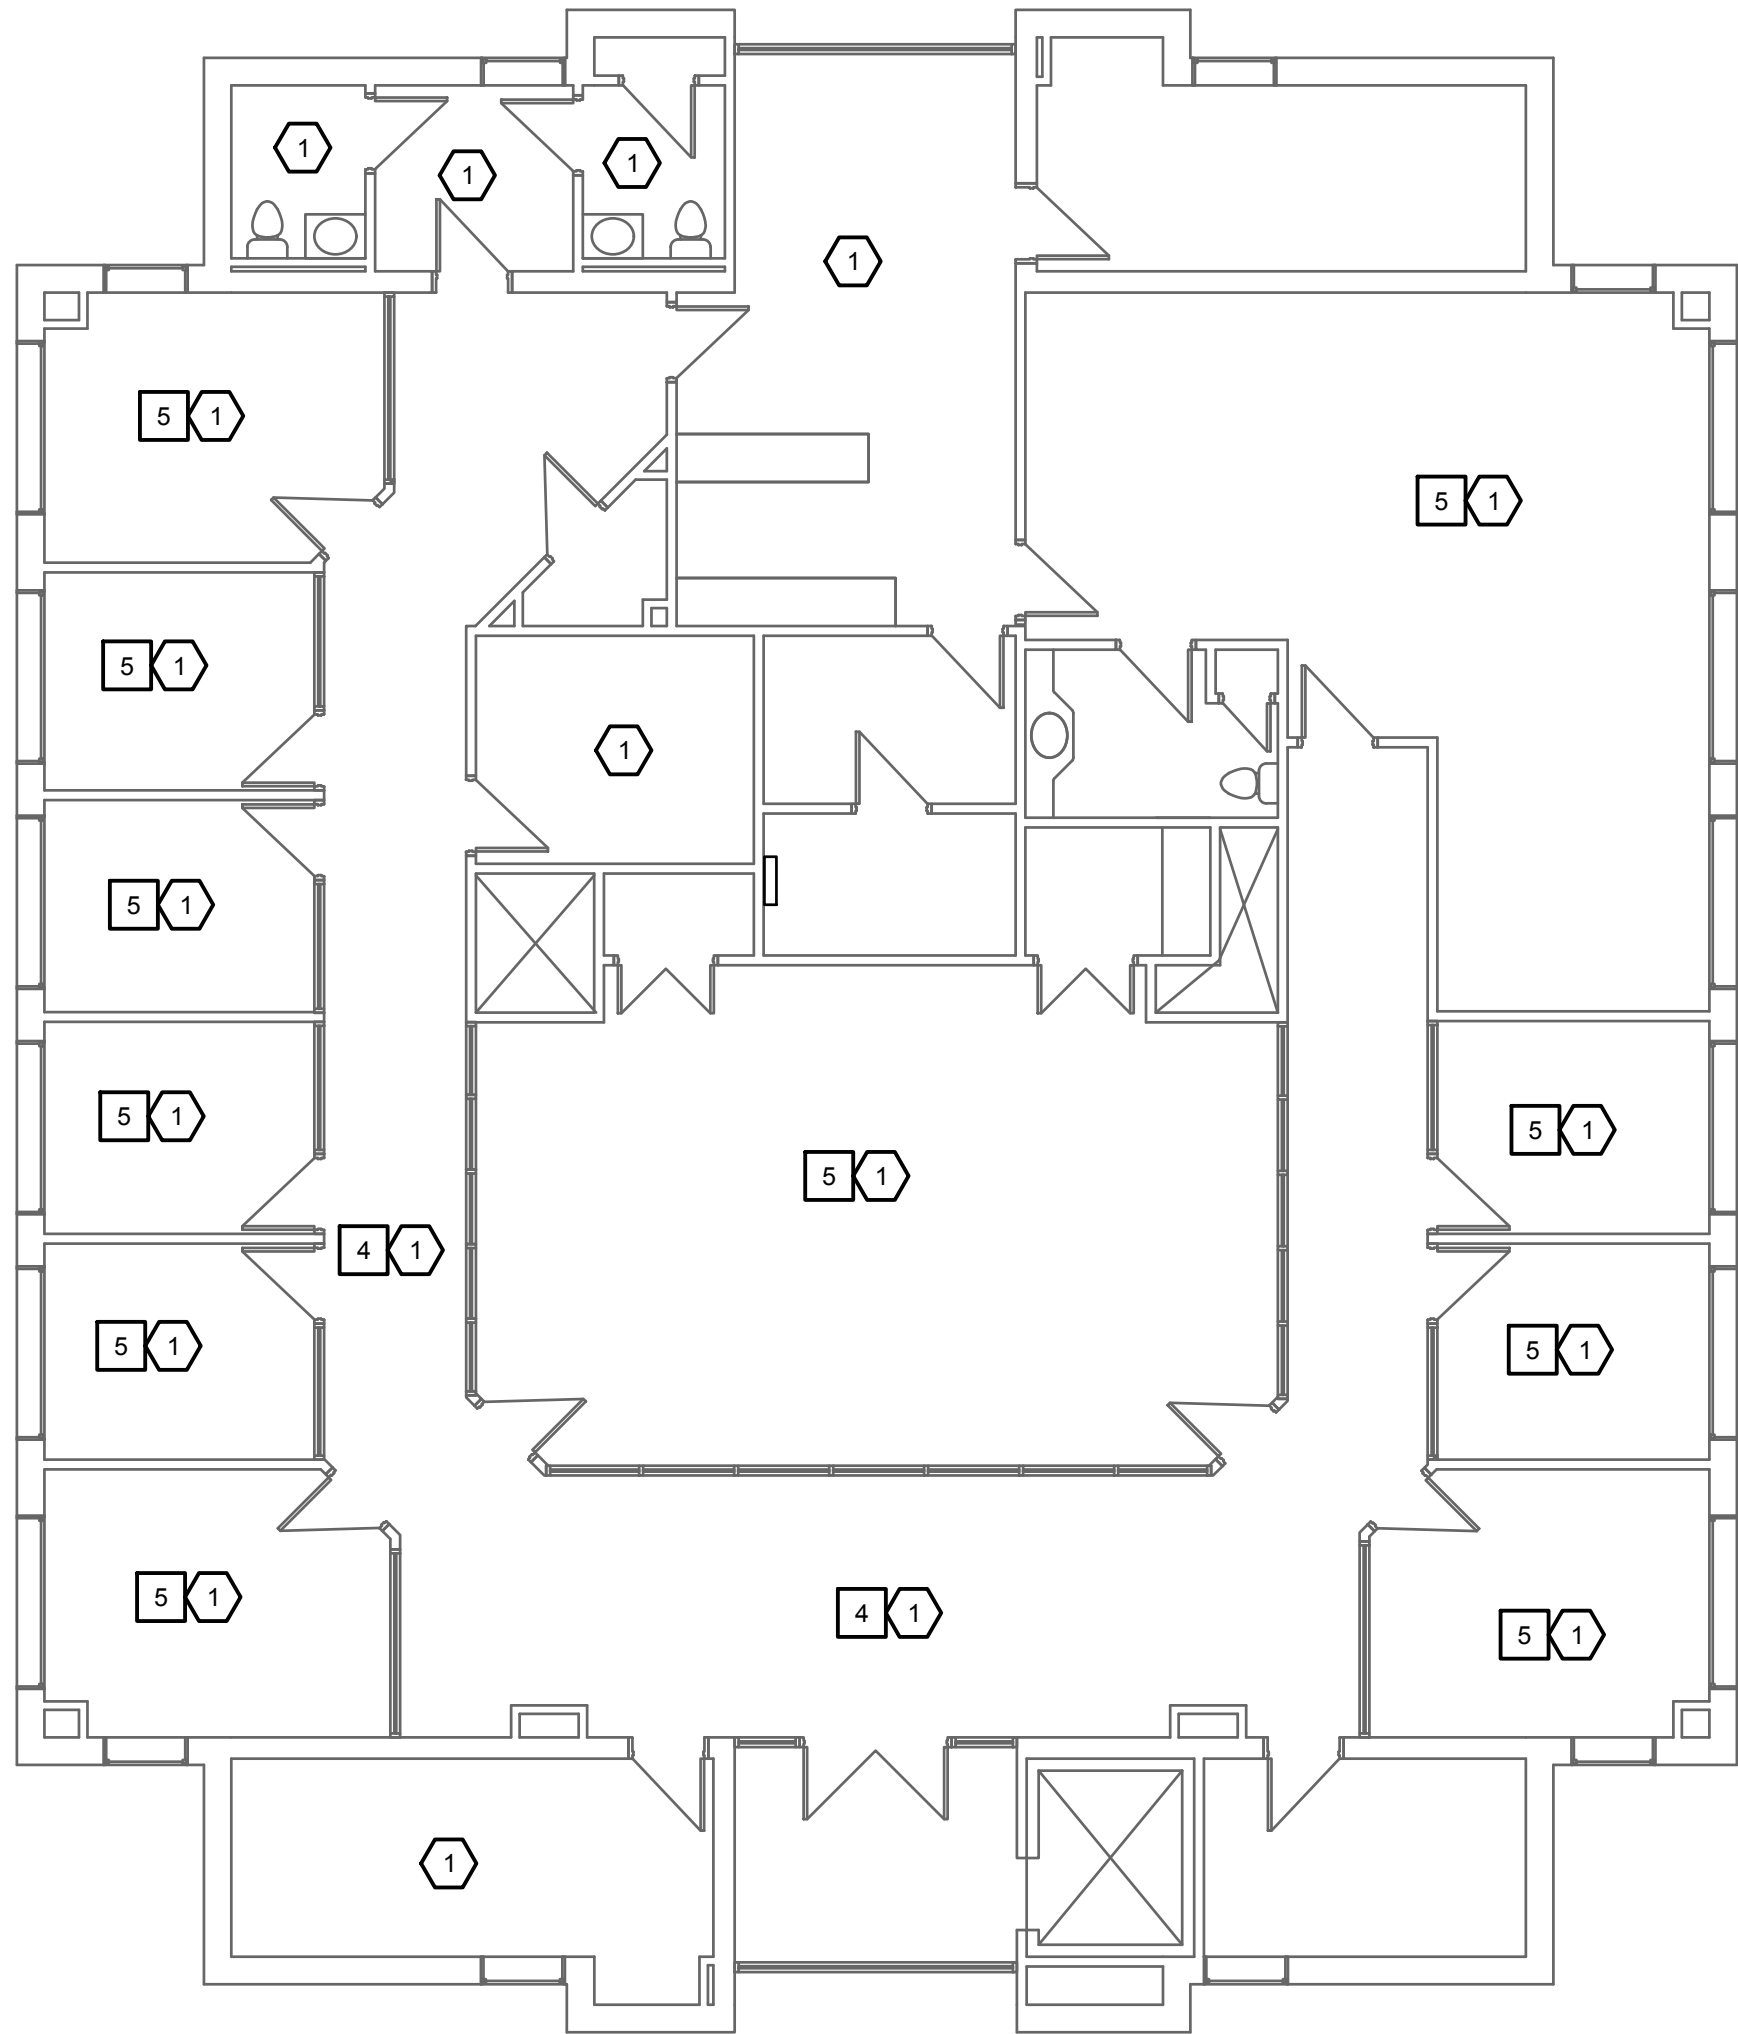
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1 SECOND FLOOR LIGHTING DEMO PLAN



2 THIRD FLOOR LIGHTING DEMO PLAN



NOTES (THIS SHEET)

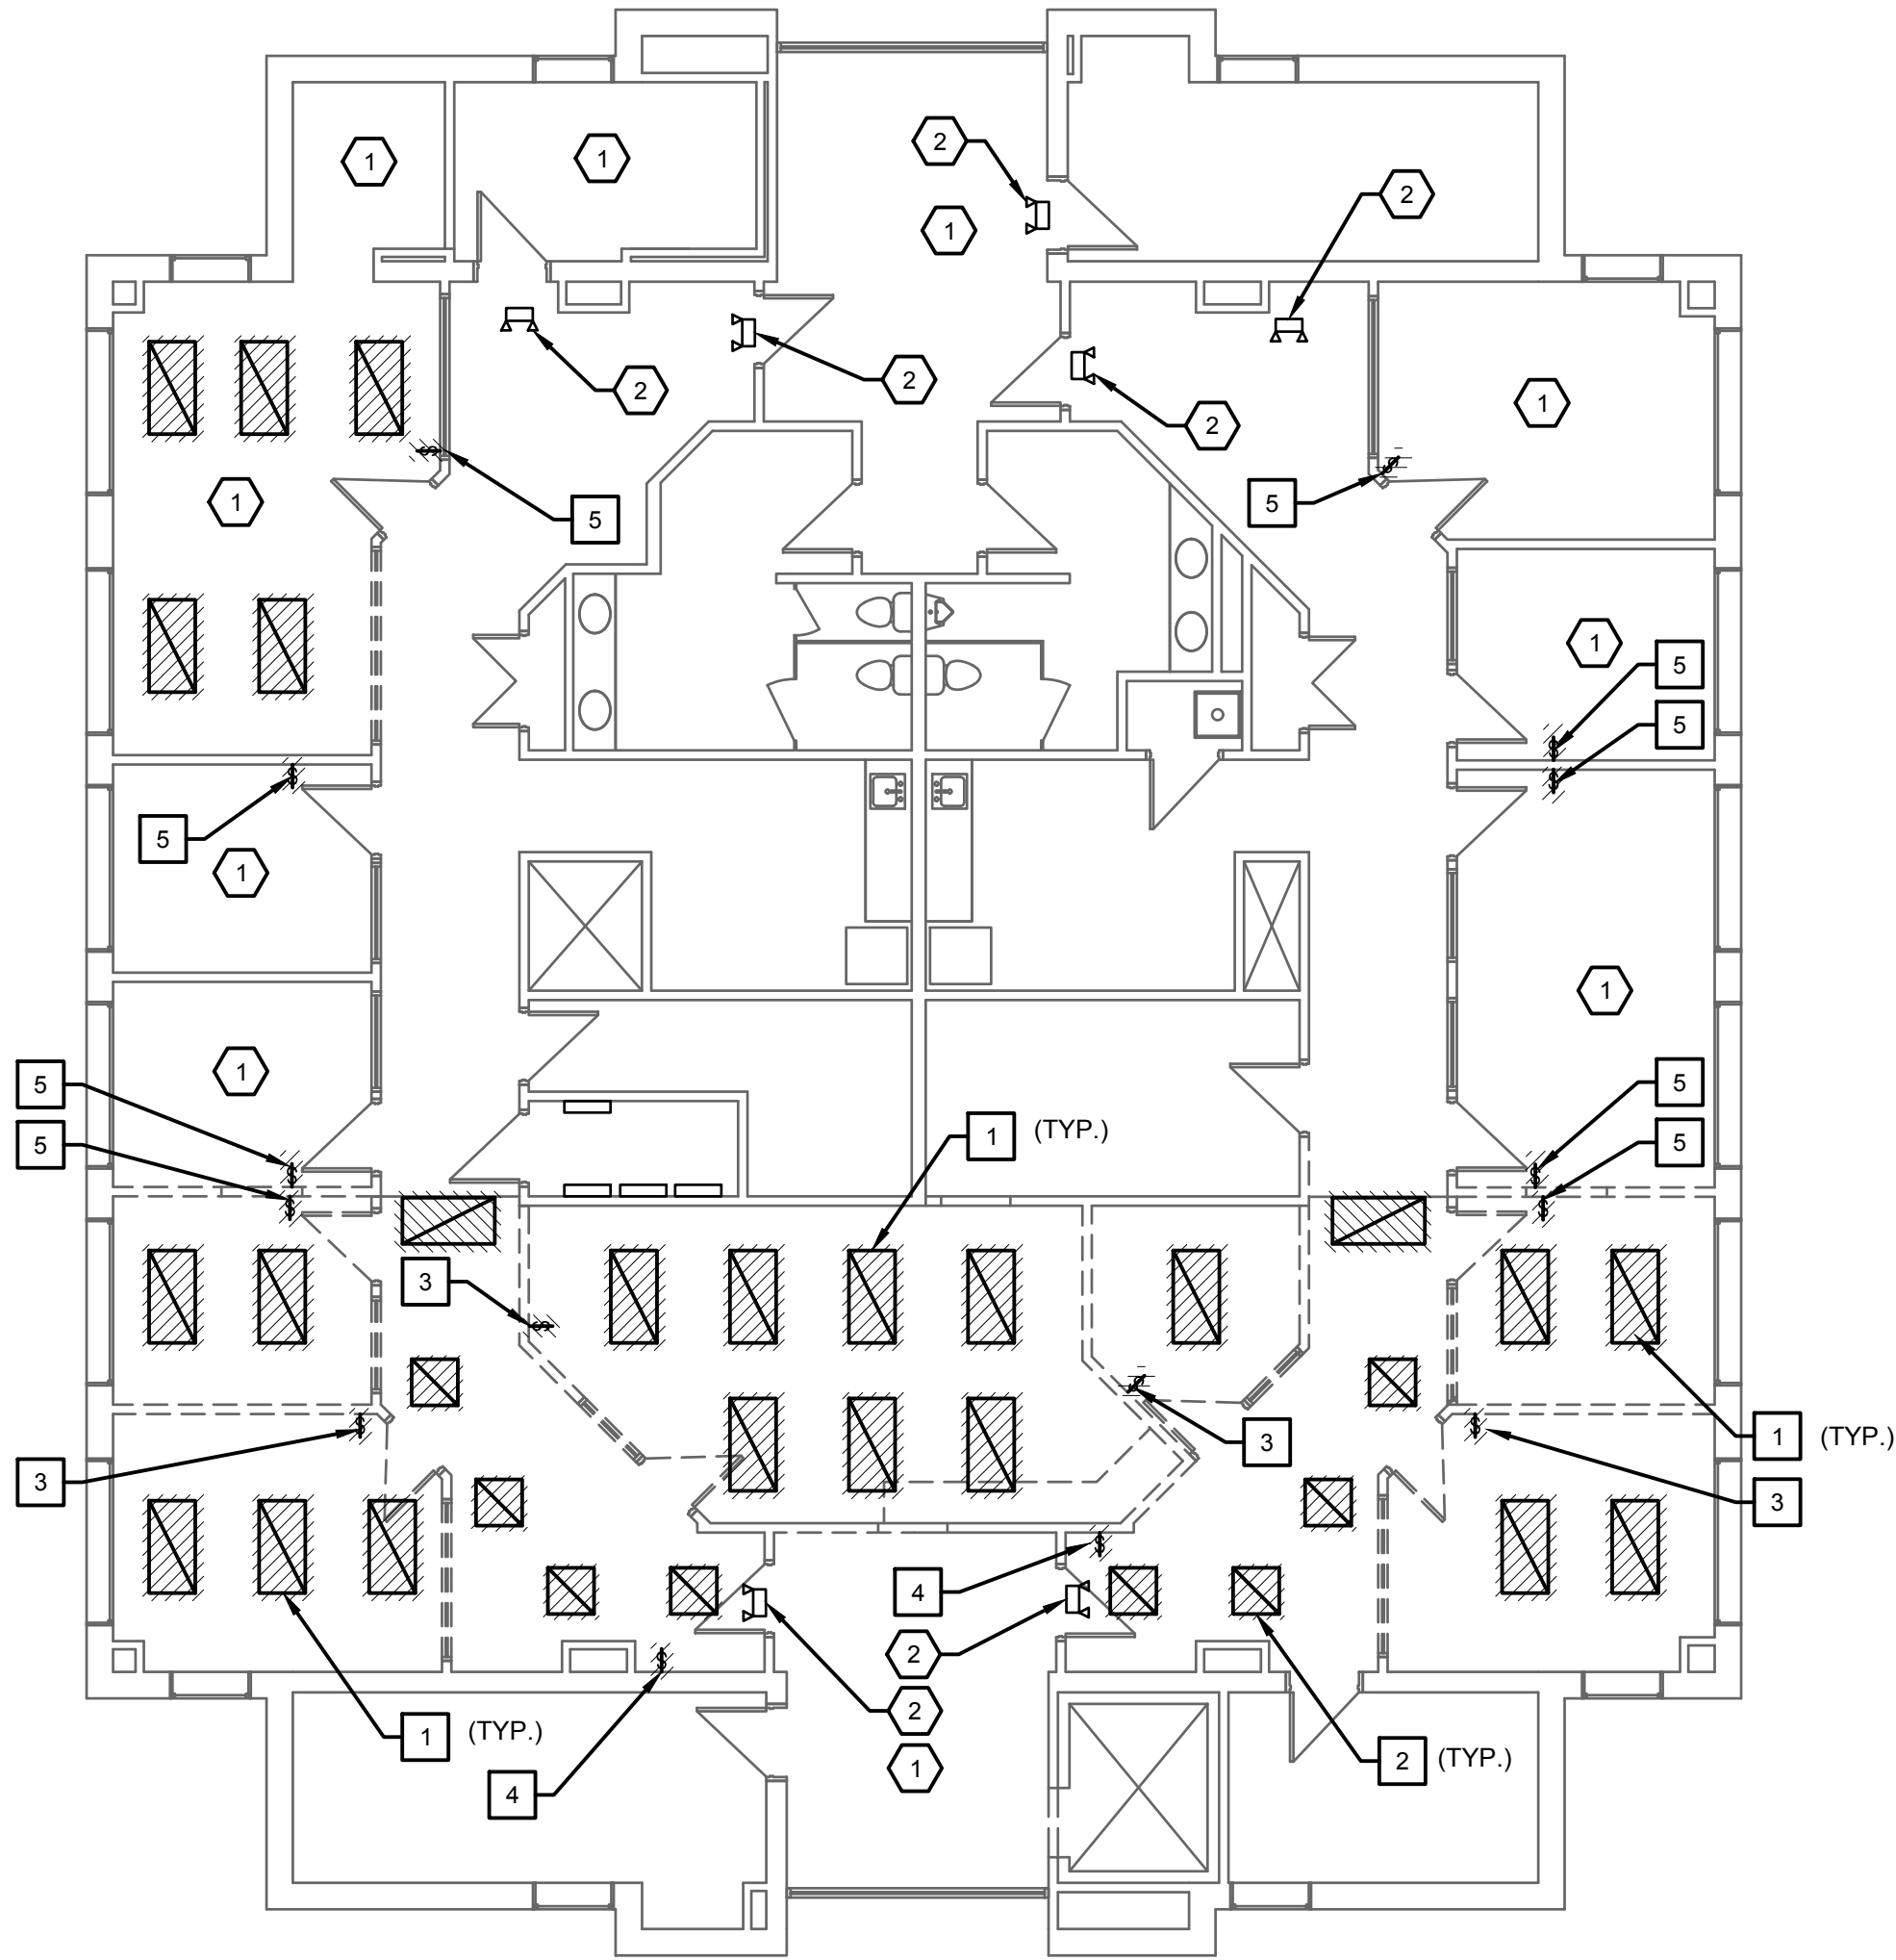
1. SEE SHEET E-0.01 FOR SYMBOLS AND ABBREVIATIONS.
2. ALL EXISTING ELECTRICAL DEVICES AND LIGHTS TO REMAIN UNLESS OTHERWISE NOTED. NOT ALL EXISTING ELECTRICAL DEVICES AND LIGHTS SHOWN.
3. ALL EXISTING CEILING MOUNTED DEVICES IN CEILINGS BEING REMOVED FOR CONSTRUCTION ARE TO BE REMOVED AND/OR PROTECTED DURING CONSTRUCTION, AND REINSTALLED AFTER CONSTRUCTION IS COMPLETED, UNLESS OTHERWISE NOTED.

DEMOLITION KEYNOTES

1. DISCONNECT AND REMOVE EXISTING 2'X4' FIXTURE. FIXTURE TO BE RELOCATED IN NEW CEILING GRID.
2. DISCONNECT AND REMOVE EXISTING 2'X2' FIXTURE.
3. DISCONNECT AND REMOVE EXISTING LIGHT SWITCH.
4. REMOVE EXISTING 3-WAY SWITCH. PROTECT EXISTING WIRING FOR USE WITH REPLACEMENT DIMMER SWITCHES. SEE SHEET E-2.01.
5. REMOVE EXISTING SINGLE POLE SWITCH. PROTECT EXISTING WIRING FOR USE WITH REPLACEMENT DIMMER SWITCH. SEE SHEET E-2.01.


KEYNOTES (THIS SHEET)

1. EXISTING LIGHTING AND CONTROLS IN THIS AREA TO REMAIN.
2. EXISTING LIGHTING IN THIS AREA TO REMAIN.
3. EXISTING COMBO EXIT EMERGENCY LIGHT TO REMAIN.

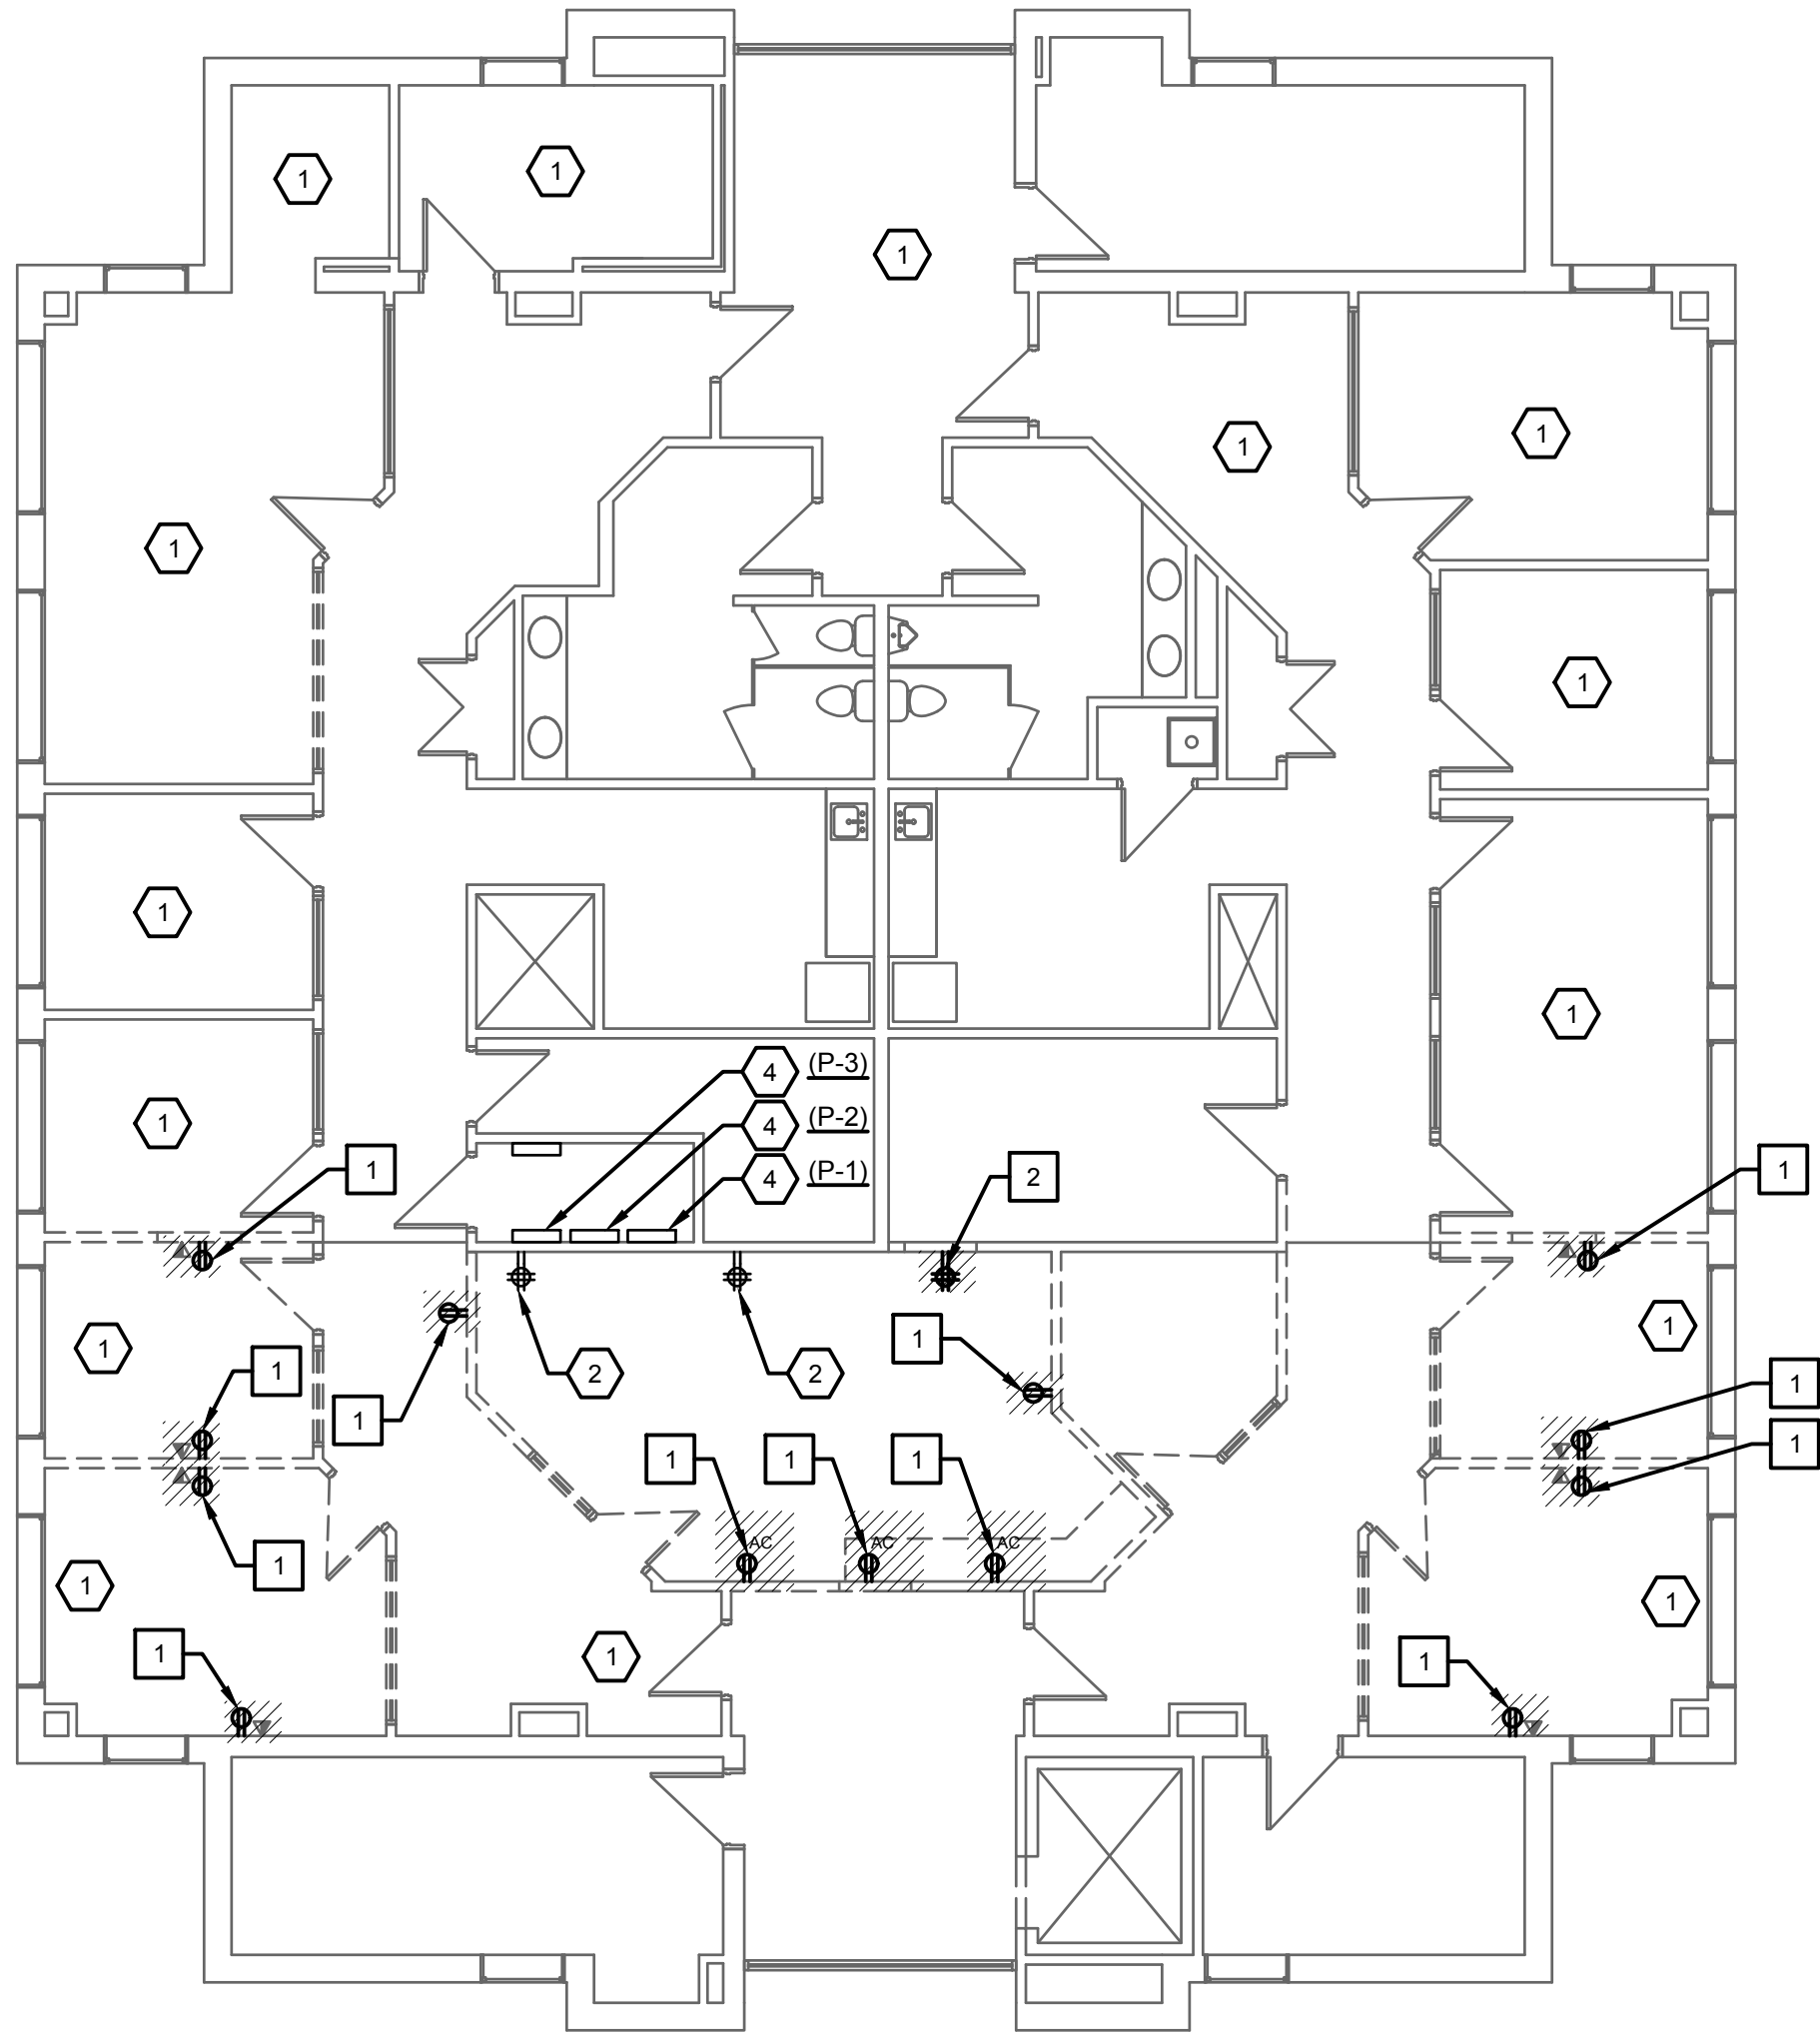

1 SECOND FLOOR POWER DEMO PLAN

0 2' 4' 8' 16'

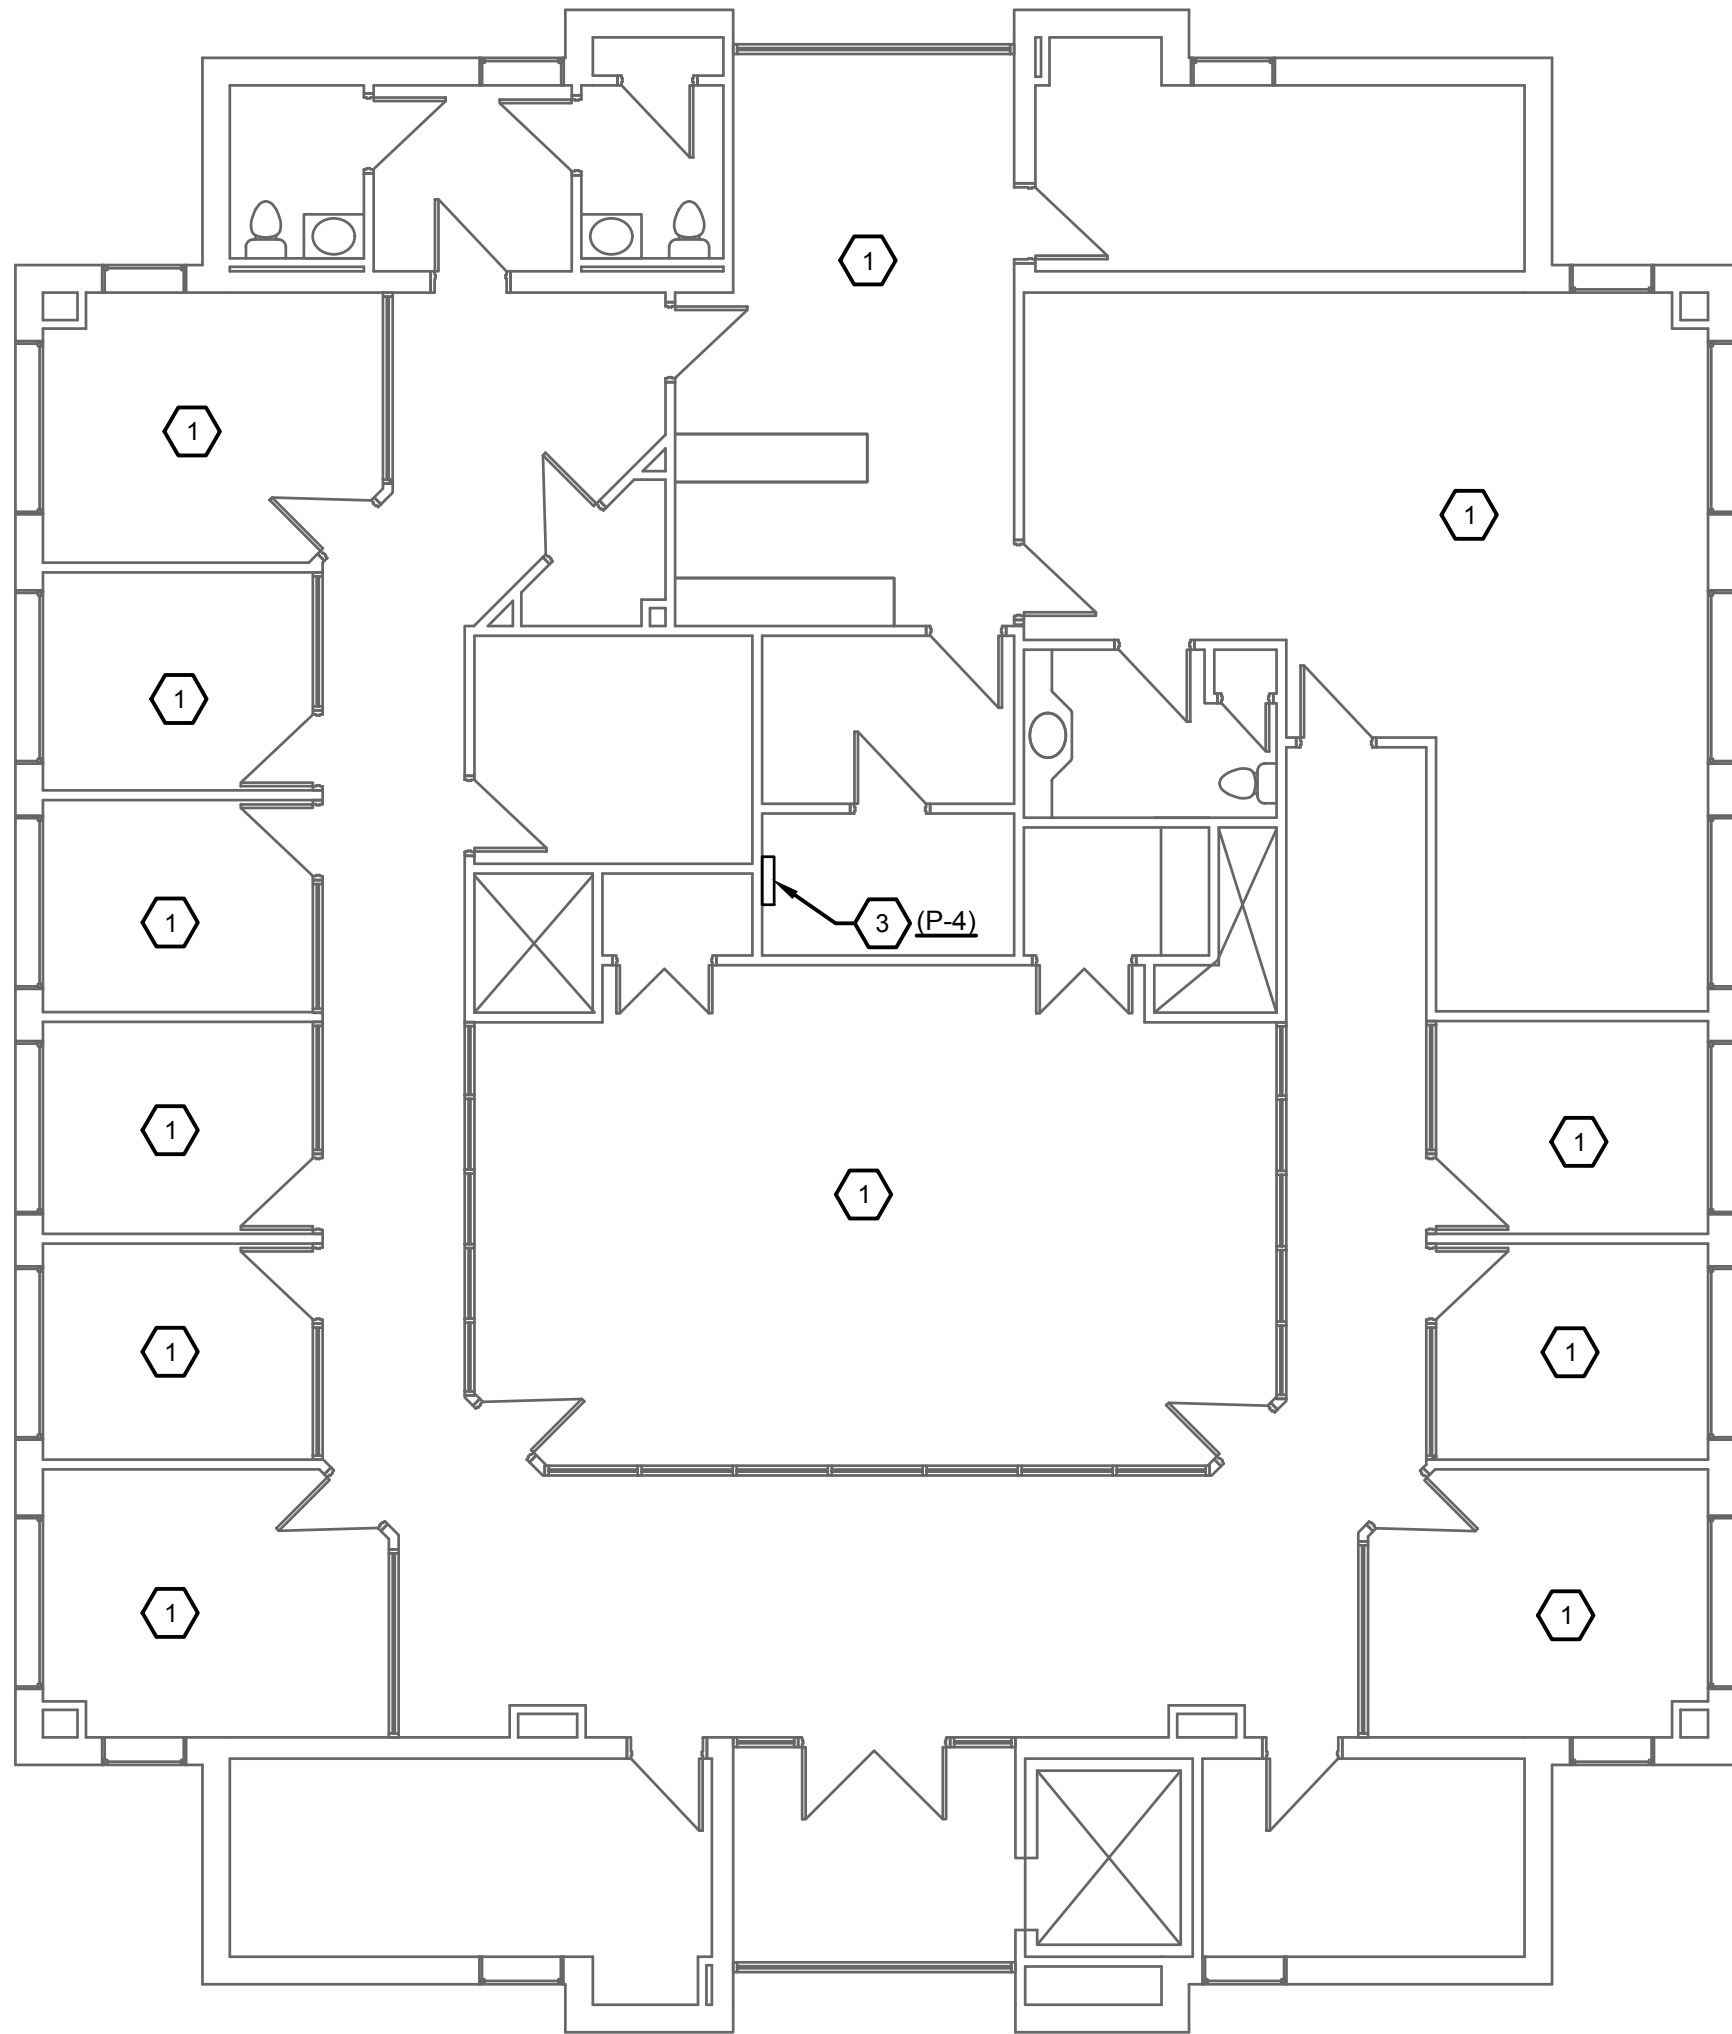

2 THIRD FLOOR POWER DEMO PLAN

0 2' 4' 8' 16'



NOTES (THIS SHEET)


1. SEE SHEET E-0.01 FOR SYMBOLS AND ABBREVIATIONS.
2. ALL EXISTING ELECTRICAL DEVICES AND LIGHTS TO REMAIN UNLESS OTHERWISE NOTED. NOT ALL EXISTING ELECTRICAL DEVICES AND LIGHTS SHOWN.
3. ALL EXISTING CEILING MOUNTED DEVICES IN CEILINGS BEING REMOVED FOR CONSTRUCTION ARE TO BE REMOVED AND/OR PROTECTED DURING CONSTRUCTION, AND REINSTALLED AFTER CONSTRUCTION IS COMPLETED, UNLESS OTHERWISE NOTED.

DEMOLITION KEYNOTES

1. DISCONNECT AND REMOVE EXISTING DUPLEX RECEPTACLE.
2. DISCONNECT AND REMOVE EXISTING QUADPLEX RECEPTACLE.


KEYNOTES (THIS SHEET)

1. EXISTING RECEPTACLES IN THIS AREA TO REMAIN.
2. EXISTING QUADPLEX RECEPTACLE TO REMAIN.
3. EXISTING POWER PANEL TO REMAIN.

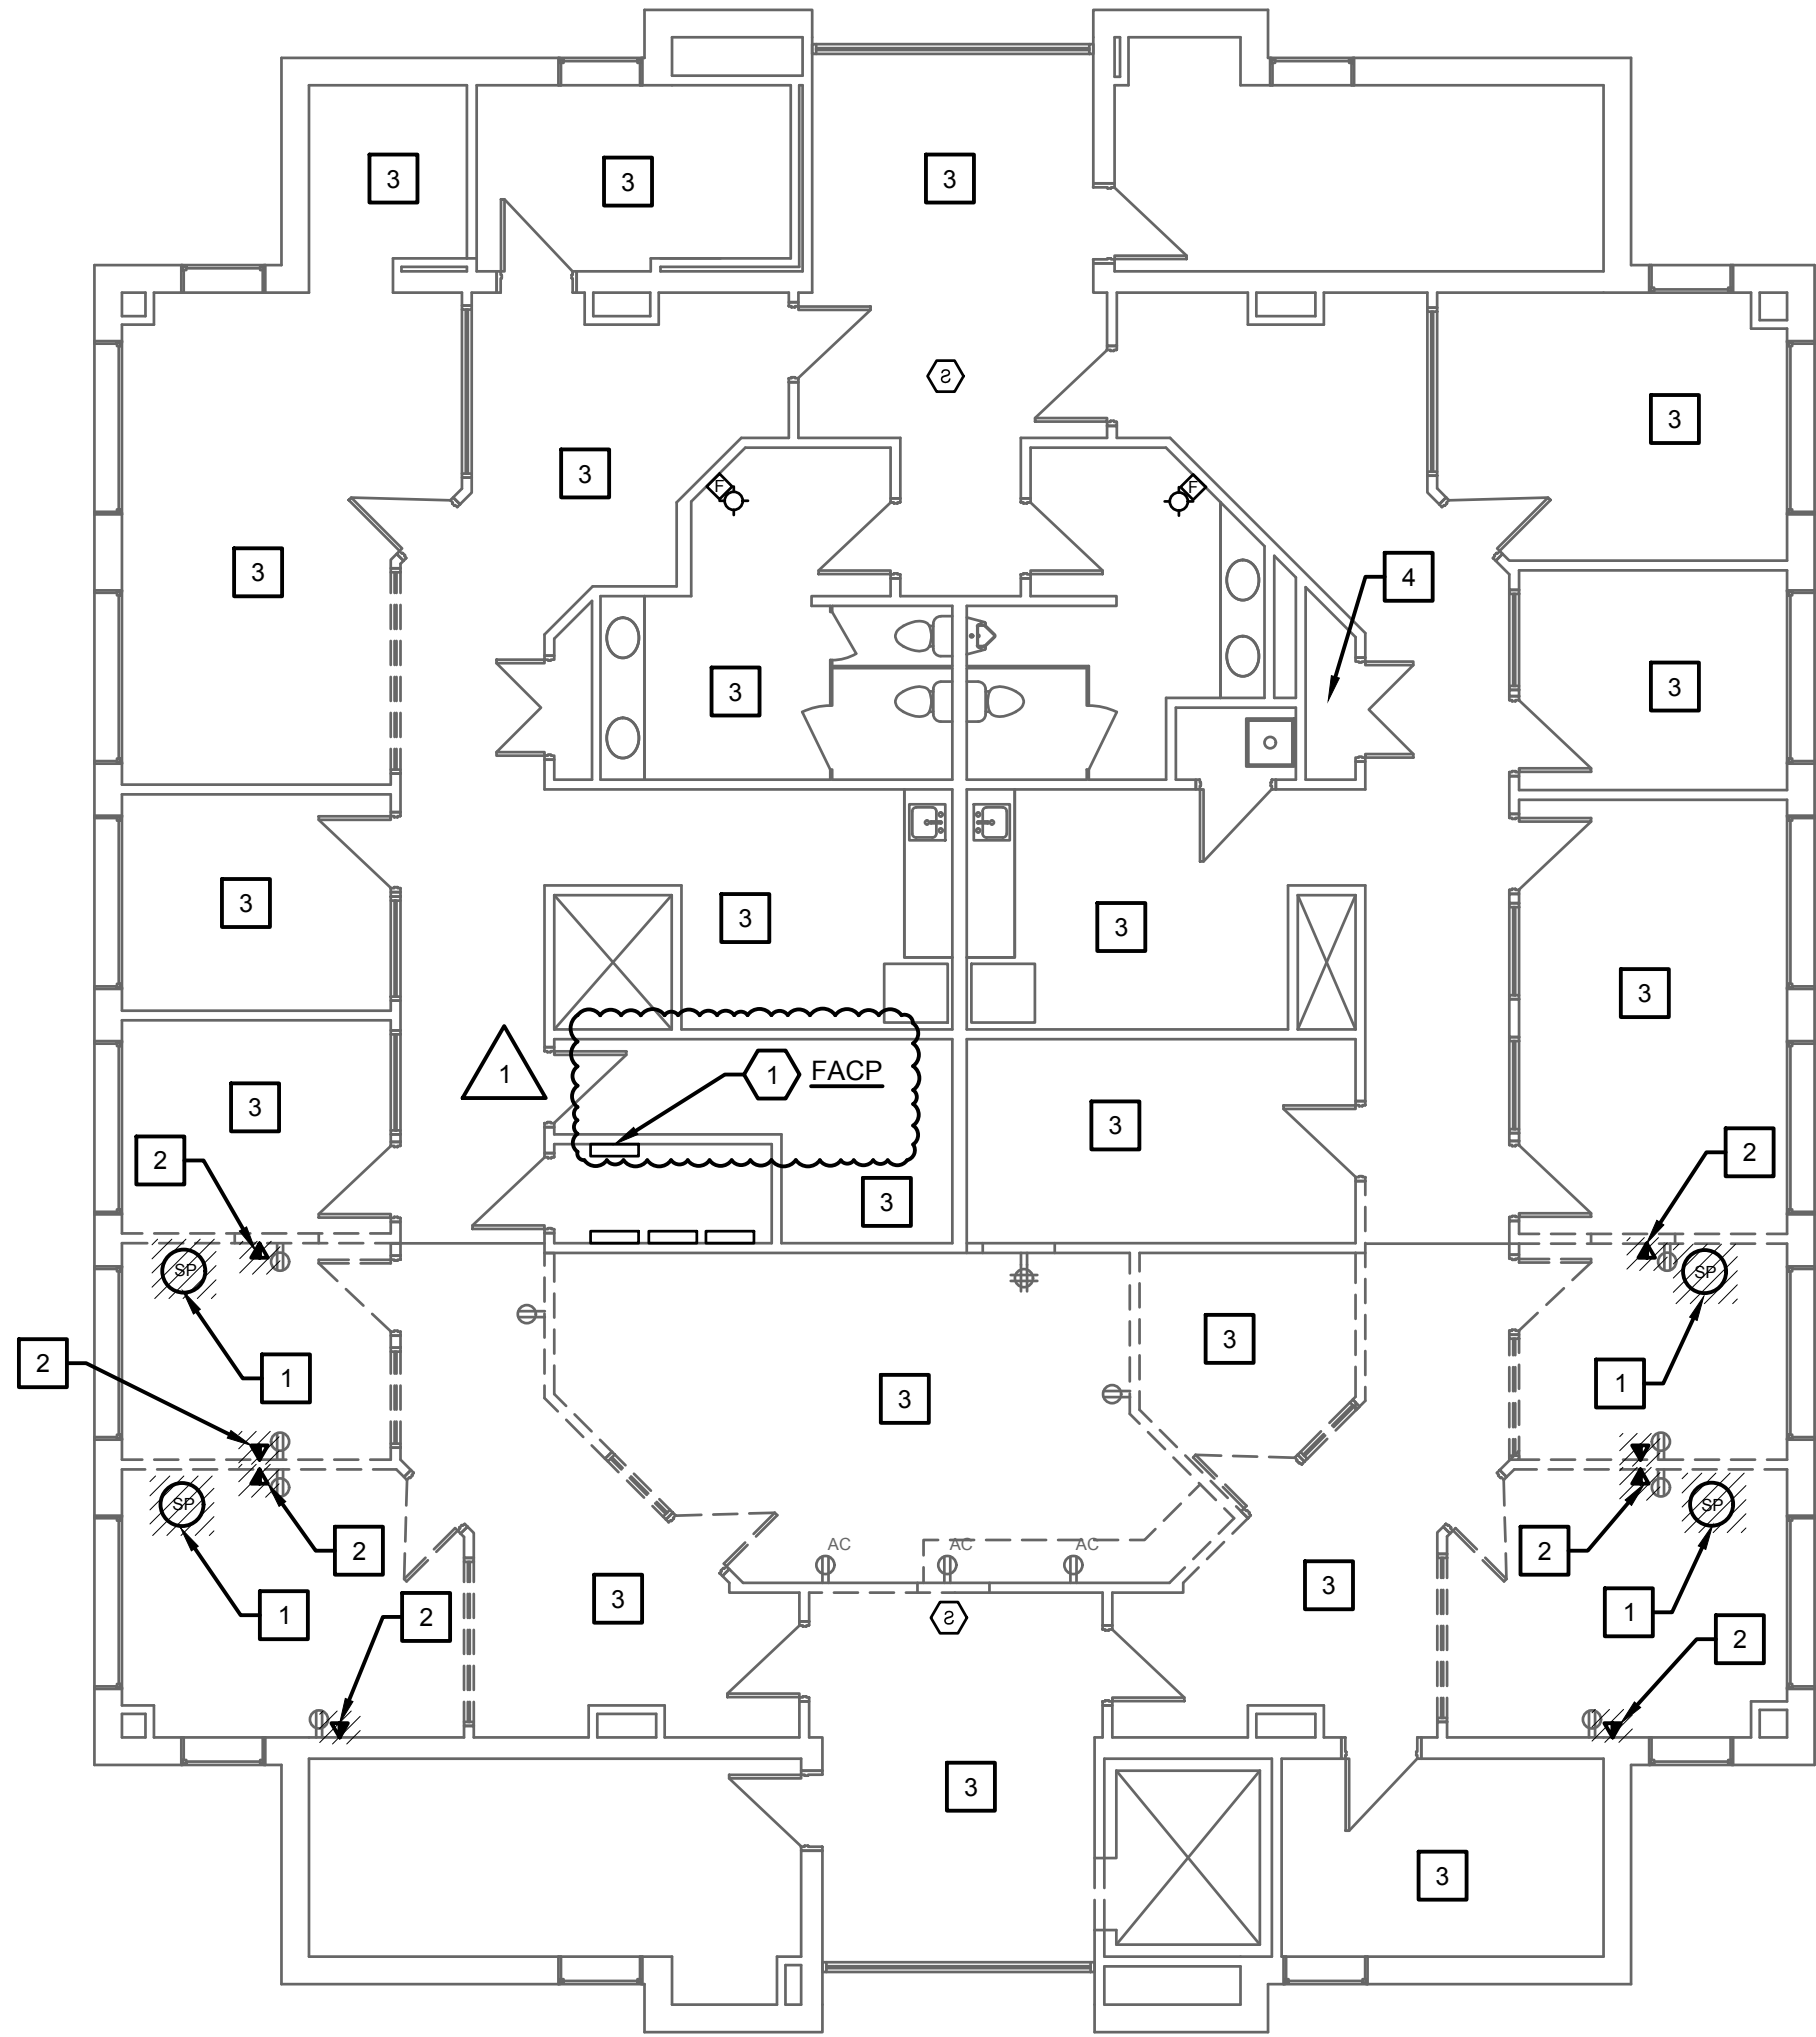

1 SECOND FLOOR SYSTEM DEMO PLAN

0 2' 4' 8' 16'

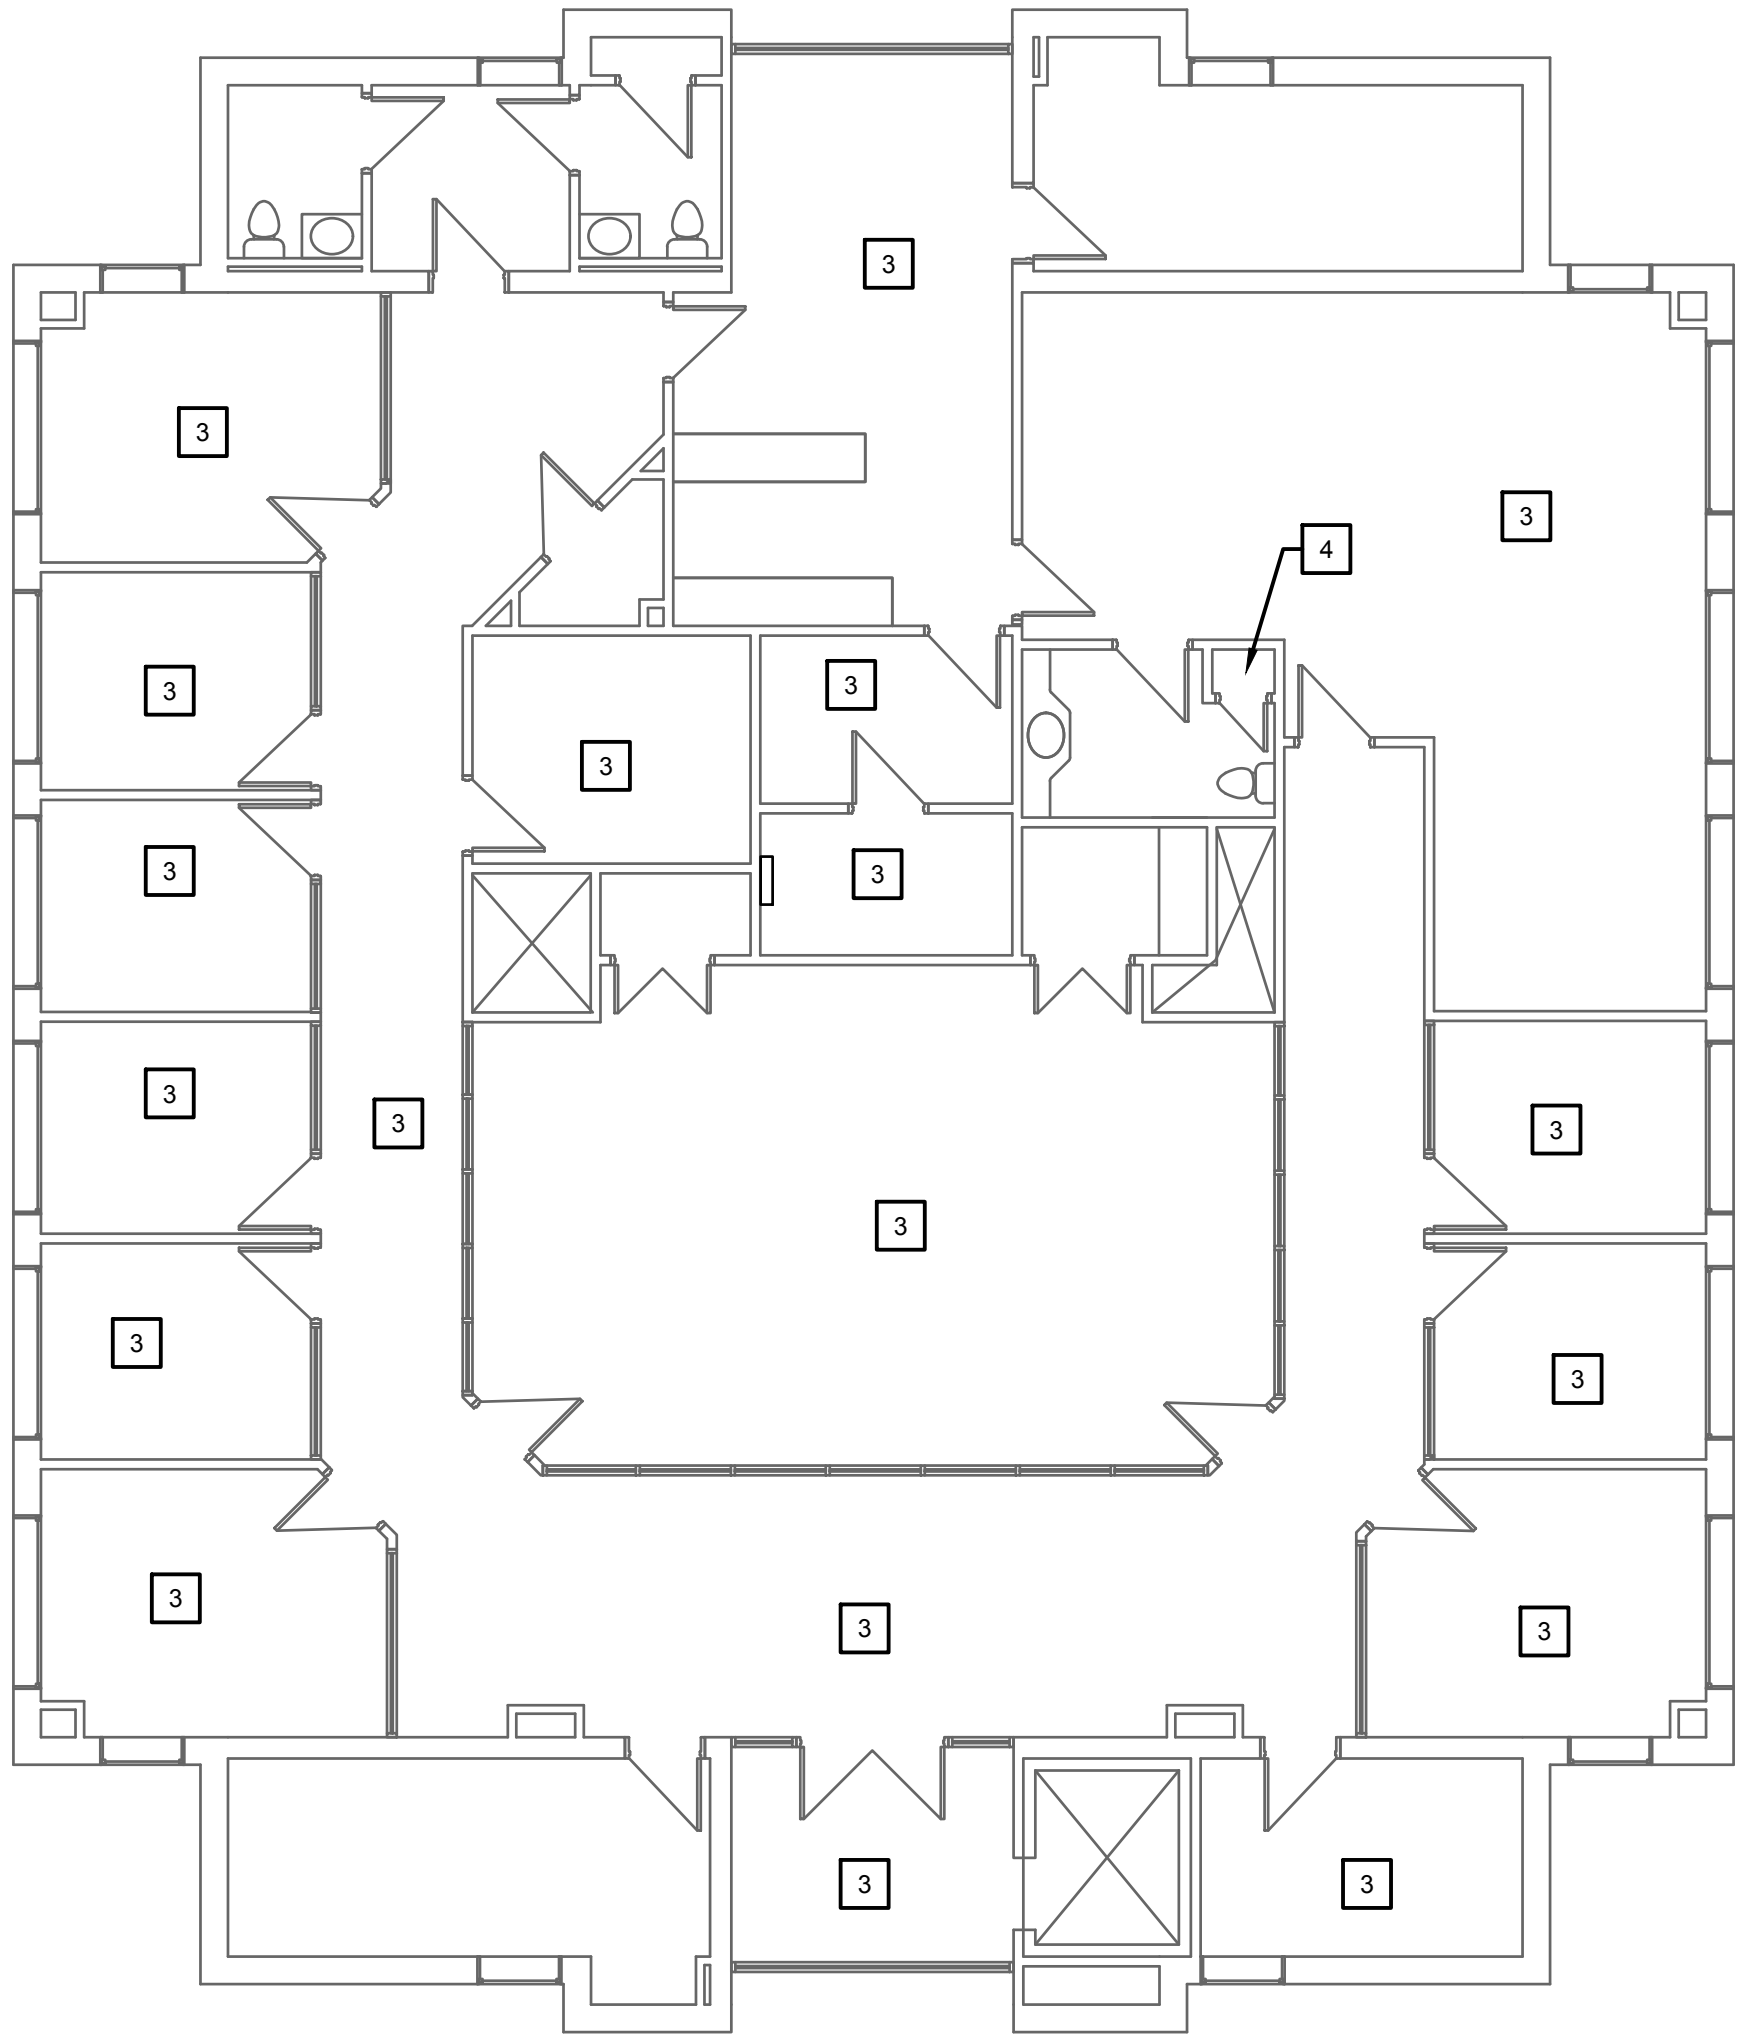

2 THIRD FLOOR SYSTEM DEMO PLAN

0 2' 4' 8' 16'



NOTES (THIS SHEET)

- 1. SEE SHEET E-0.01 FOR SYMBOLS AND ABBREVIATIONS.
- 2. ALL EXISTING ELECTRICAL DEVICES AND LIGHTS TO REMAIN UNLESS OTHERWISE NOTED. NOT ALL EXISTING ELECTRICAL DEVICES AND LIGHTS SHOWN.
- 3. ALL EXISTING CEILING MOUNTED DEVICES IN CEILINGS BEING REMOVED FOR CONSTRUCTION ARE TO BE REMOVED AND/OR PROTECTED DURING CONSTRUCTION, AND REINSTALLED AFTER CONSTRUCTION IS COMPLETED, UNLESS OTHERWISE NOTED.
- 4. CONTRACTOR SHALL REMOVE ALL EXISTING ACCESS CONTROL DEVICES, CABLING AND SUPPORTING HARDWARE BACK TO SOURCE.
- 5. CONTRACTOR SHALL REMOVE ALL EXISTING VIDEO SURVEILLANCE DEVICES AND CABLING BACK TO SOURCE.
- 6. ALL EXISTING COMMUNICATIONS CABLING WILL BE REPLACED. CONTRACTOR SHALL REMOVE ALL EXISTING DEVICES, WALL PLATE AND CABLING BACK TO SOURCE. EXISTING SUPPORTING HARDWARE SHALL BE PERMITTED TO BE REUSED IF IT IS GOOD CONDITIONS AND MEETS THE REQUIREMENTS OF THE SPECIFICATIONS.

DEMOLITION KEYNOTES

- 1. DISCONNECT AND REMOVE EXISTING ABANDONED CEILING MOUNTED SPEAKER.
- 2. DISCONNECT AND REMOVE EXISTING DATA DEVICE. REMOVE WIRING BACK TO PATCH PANEL IN EXISTING DATA CLOSET.
- 3. DISCONNECT AND REMOVE EXISTING DATA DEVICES IN THIS AREA. REMOVE WIRING BACK TO PATCH PANEL IN EXISTING DATA CLOSET.
- 4. EXISTING DATA CLOSET. REMOVE EXISTING PATCH PANELS. PROTECT EXISTING RACKS FOR REUSE.

KEYNOTES (THIS SHEET)

- 1. EXISTING FIRE ALARM CONTROL PANEL.

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PROJECT TITLE

E07825001 ENVOY - FLOYD
COUNTY ANNEX
RENOVATION

DESIGNED BY: ARW
DRAWN BY: ARW
CHECKED BY: NTP
DATE CHECKED: 05/16/25

07/03/25 ADDENDUM #1

DATE	REVISION

DRAWING TITLE

SECOND & THIRD FLOOR
SYSTEM DEMO PLAN

PROJECT No.

E07825001

DRAWING No.

E-1.21



1. SEE SHEET E-0.01 FOR SYMBOLS AND ABBREVIATIONS.
2. ALL EXISTING ELECTRICAL DEVICES AND LIGHTS TO REMAIN UNLESS OTHERWISE NOTED. NOT ALL EXISTING ELECTRICAL DEVICES AND LIGHTS SHOWN.
3. ALL EXISTING CEILING MOUNTED DEVICES IN CEILINGS BEING REMOVED FOR CONSTRUCTION ARE TO BE REMOVED AND/OR PROTECTED DURING CONSTRUCTION, AND REINSTALLED AFTER CONSTRUCTION IS COMPLETED, UNLESS OTHERWISE NOTED.
4. CONNECT NEW EXIT AND EMERGENCY LIGHTS TO AN UNSWITCHED LEG OF THE EXISTING LIGHTING CIRCUIT SERVING THE ADJACENT AREA.

1. EXISTING 2'X4' FIXTURE RELOCATED IN NEW CEILING GRID.
2. EXISTING 2'X4' FIXTURE TO REMAIN.
3. EXISTING 2'X2' FIXTURE TO REMAIN.
4. PROVIDE NEW 3-WAY 0-10V DIMMER TO REPLACE EXISTING 3-WAY SWITCHING. PROVIDE 0-10V DIMMING WIRING FROM NEW SWITCHES TO EACH LIGHT FIXTURE DRIVER AS REQUIRED TO PROVIDE DIMMING FUNCTION. DIMMER SWITCH SHALL BE LUTRON NO. DVSTV OR EQUAL.
5. PROVIDE NEW SINGLE POLE 0-10V DIMMER TO REPLACE EXISTING SINGLE POLE SWITCHING. PROVIDE 0-10V DIMMING WIRING FROM NEW SWITCHES TO EACH LIGHT FIXTURE DRIVER AS REQUIRED TO PROVIDE DIMMING FUNCTION. DIMMER SWITCH SHALL BE LUTRON NO. DVSTV OR EQUAL.
6. EXISTING COMBO EXIT EMERGENCY LIGHT TO REMAIN.
7. PROVIDE NEW CEILING MOUNTED COMBO EXIT EMERGENCY LIGHT. SEE SCHEDULE.
8. PROVIDE NEW WALL MOUNTED OCCUPANCY SENSOR.
9. EXISTING LIGHTING IN THIS AREA TO REMAIN.

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PROJECT	TITLE
E07825001	ENVOY - FLOYD COUNTY ANNEX RENNOVATION

DESIGNED BY: ARW
DRAWN BY: ARW
CHECKED BY: NTP
DATE CHECKED: 05/16/25

07/03/25 ADDENDUM #1

DATE	REVISION
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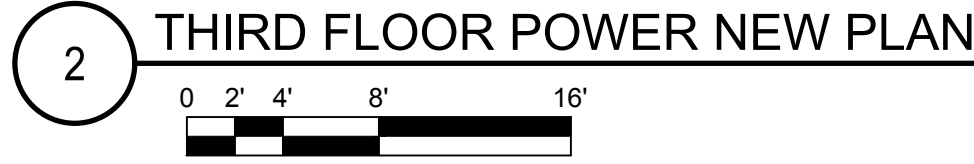
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SECOND & THIRD FLOOR
LIGHTING NEW PLAN

PROJECT No.
E07825001

DRAWING No.

E-2.01



1. SEE SHEET E-0.01 FOR SYMBOLS AND ABBREVIATIONS.
2. ALL EXISTING ELECTRICAL DEVICES AND LIGHTS TO REMAIN UNLESS OTHERWISE NOTED. NOT ALL EXISTING ELECTRICAL DEVICES AND LIGHTS SHOWN.
3. ALL EXISTING CEILING MOUNTED DEVICES IN CEILINGS BEING REMOVED FOR CONSTRUCTION ARE TO BE REMOVED AND/OR PROTECTED DURING CONSTRUCTION, AND REINSTALLED AFTER CONSTRUCTION IS COMPLETED, UNLESS OTHERWISE NOTED.
4. ALL NEW CIRCUITS SHALL BE CONNECTED TO NEW PANEL P-5 ON THE THIRD FLOOR UNLESS SPECIFICALLY NOTED OTHERWISE.

1. EXISTING RECEPTACLES IN THIS AREA TO REMAIN.
2. EXISTING DUPLEX RECEPTACLE TO REMAIN. REVISE/EXTEND EXISTING CIRCUIT IF REQUIRED DUE TO DEMOLITION OF ADJACENT RECEPTACLES.
3. EXISTING QUADPLEX RECEPTACLE TO REMAIN.
4. PROVIDE NEW PANEL P-5. SEE ONE-LINE DIAGRAM AND CIRCUIT DIRECTORY.
5. PROVIDE NEW QUADPLEX RECEPTACLE.
6. EXISTING POWER PANEL TO REMAIN.
7. EXISTING DATA CLOSET.
8. PROVIDE NEW DUPLEX RECEPTACLE.
9. SUPPLY FAN SF-1. MAKE FINAL CONNECTIONS. PROVIDE 2#12, 1#12G IN 3/4" CONDUIT TO PANEL P-5.
10. PROVIDE DUPLEX RECEPTACLE FOR COMPUTER AT CASEWORK. ROUTE FLEXIBLE CONDUIT INSIDE ADJACENT EXISTING WALL INTO CASEWORK. PROVIDE SURFACE RACEWAY ALONG THE INSIDE OF THE CASEWORK TO EACH RECEPTACLE. FIELD VERIFY RECEPTACLE LOCATIONS WITH OWNER.
11. PROVIDE DUPLEX RECEPTACLE FOR PRINTER INSIDE CASEWORK. UTILIZE SURFACE RACEWAY DESCRIBED IN KEYNOTE 10.
12. PROVIDE DUPLEX RECEPTACLE FOR NEW COPY MACHINE. PROVIDE SURFACE RACEWAY TO ABOVE ACCESSIBLE CEILING.
13. PROVIDE POWER CONNECTION TO MAGNETIC LOCK. COORDINATE INSTALLATION WITH FIRE ALARM RELAY INSTALLATION.
14. EXTEND EXISTING RECEPTACLE CIRCUIT TO NEW RECEPTACLES.

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PROJECT TITLE

E07825001 ENVOY - FLOYD
COUNTY ANNEX
RENNOVATION

DESIGNED BY: ARW
DRAWN BY: ARW
CHECKED BY: NTP
DATE CHECKED: 05/16/25

07/03/25 ADDENDUM #1

DATE	REVISION
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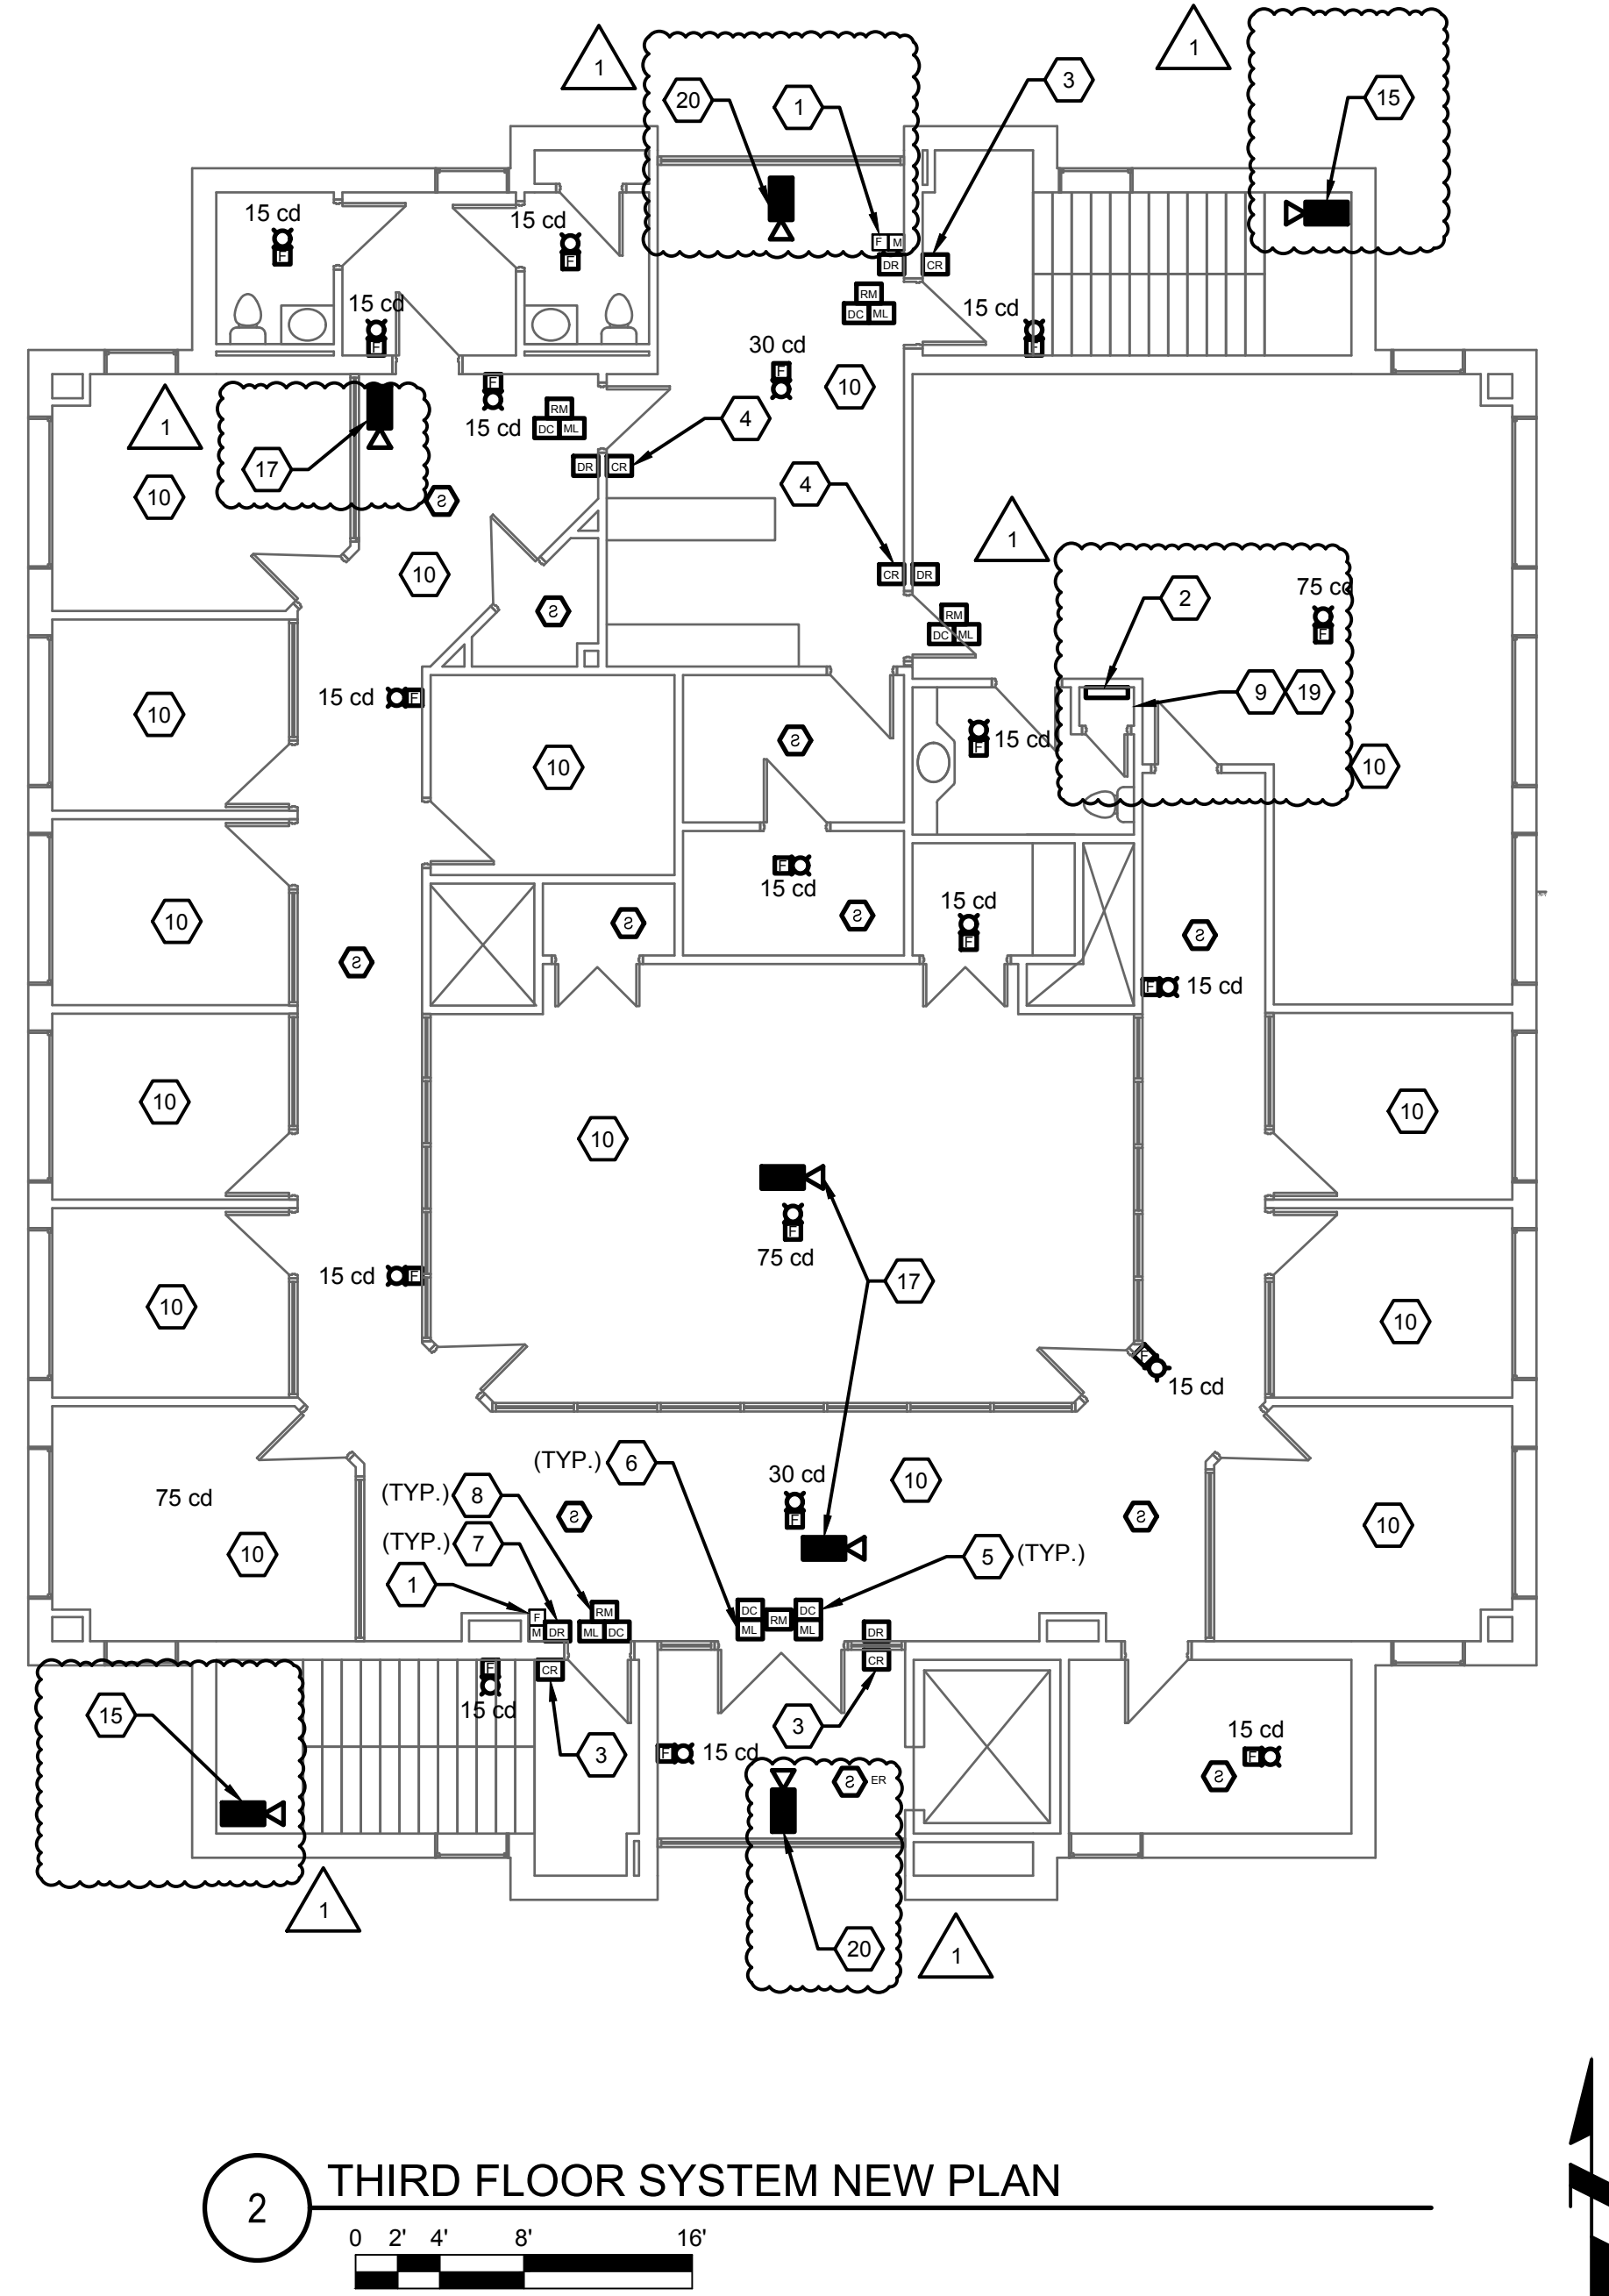
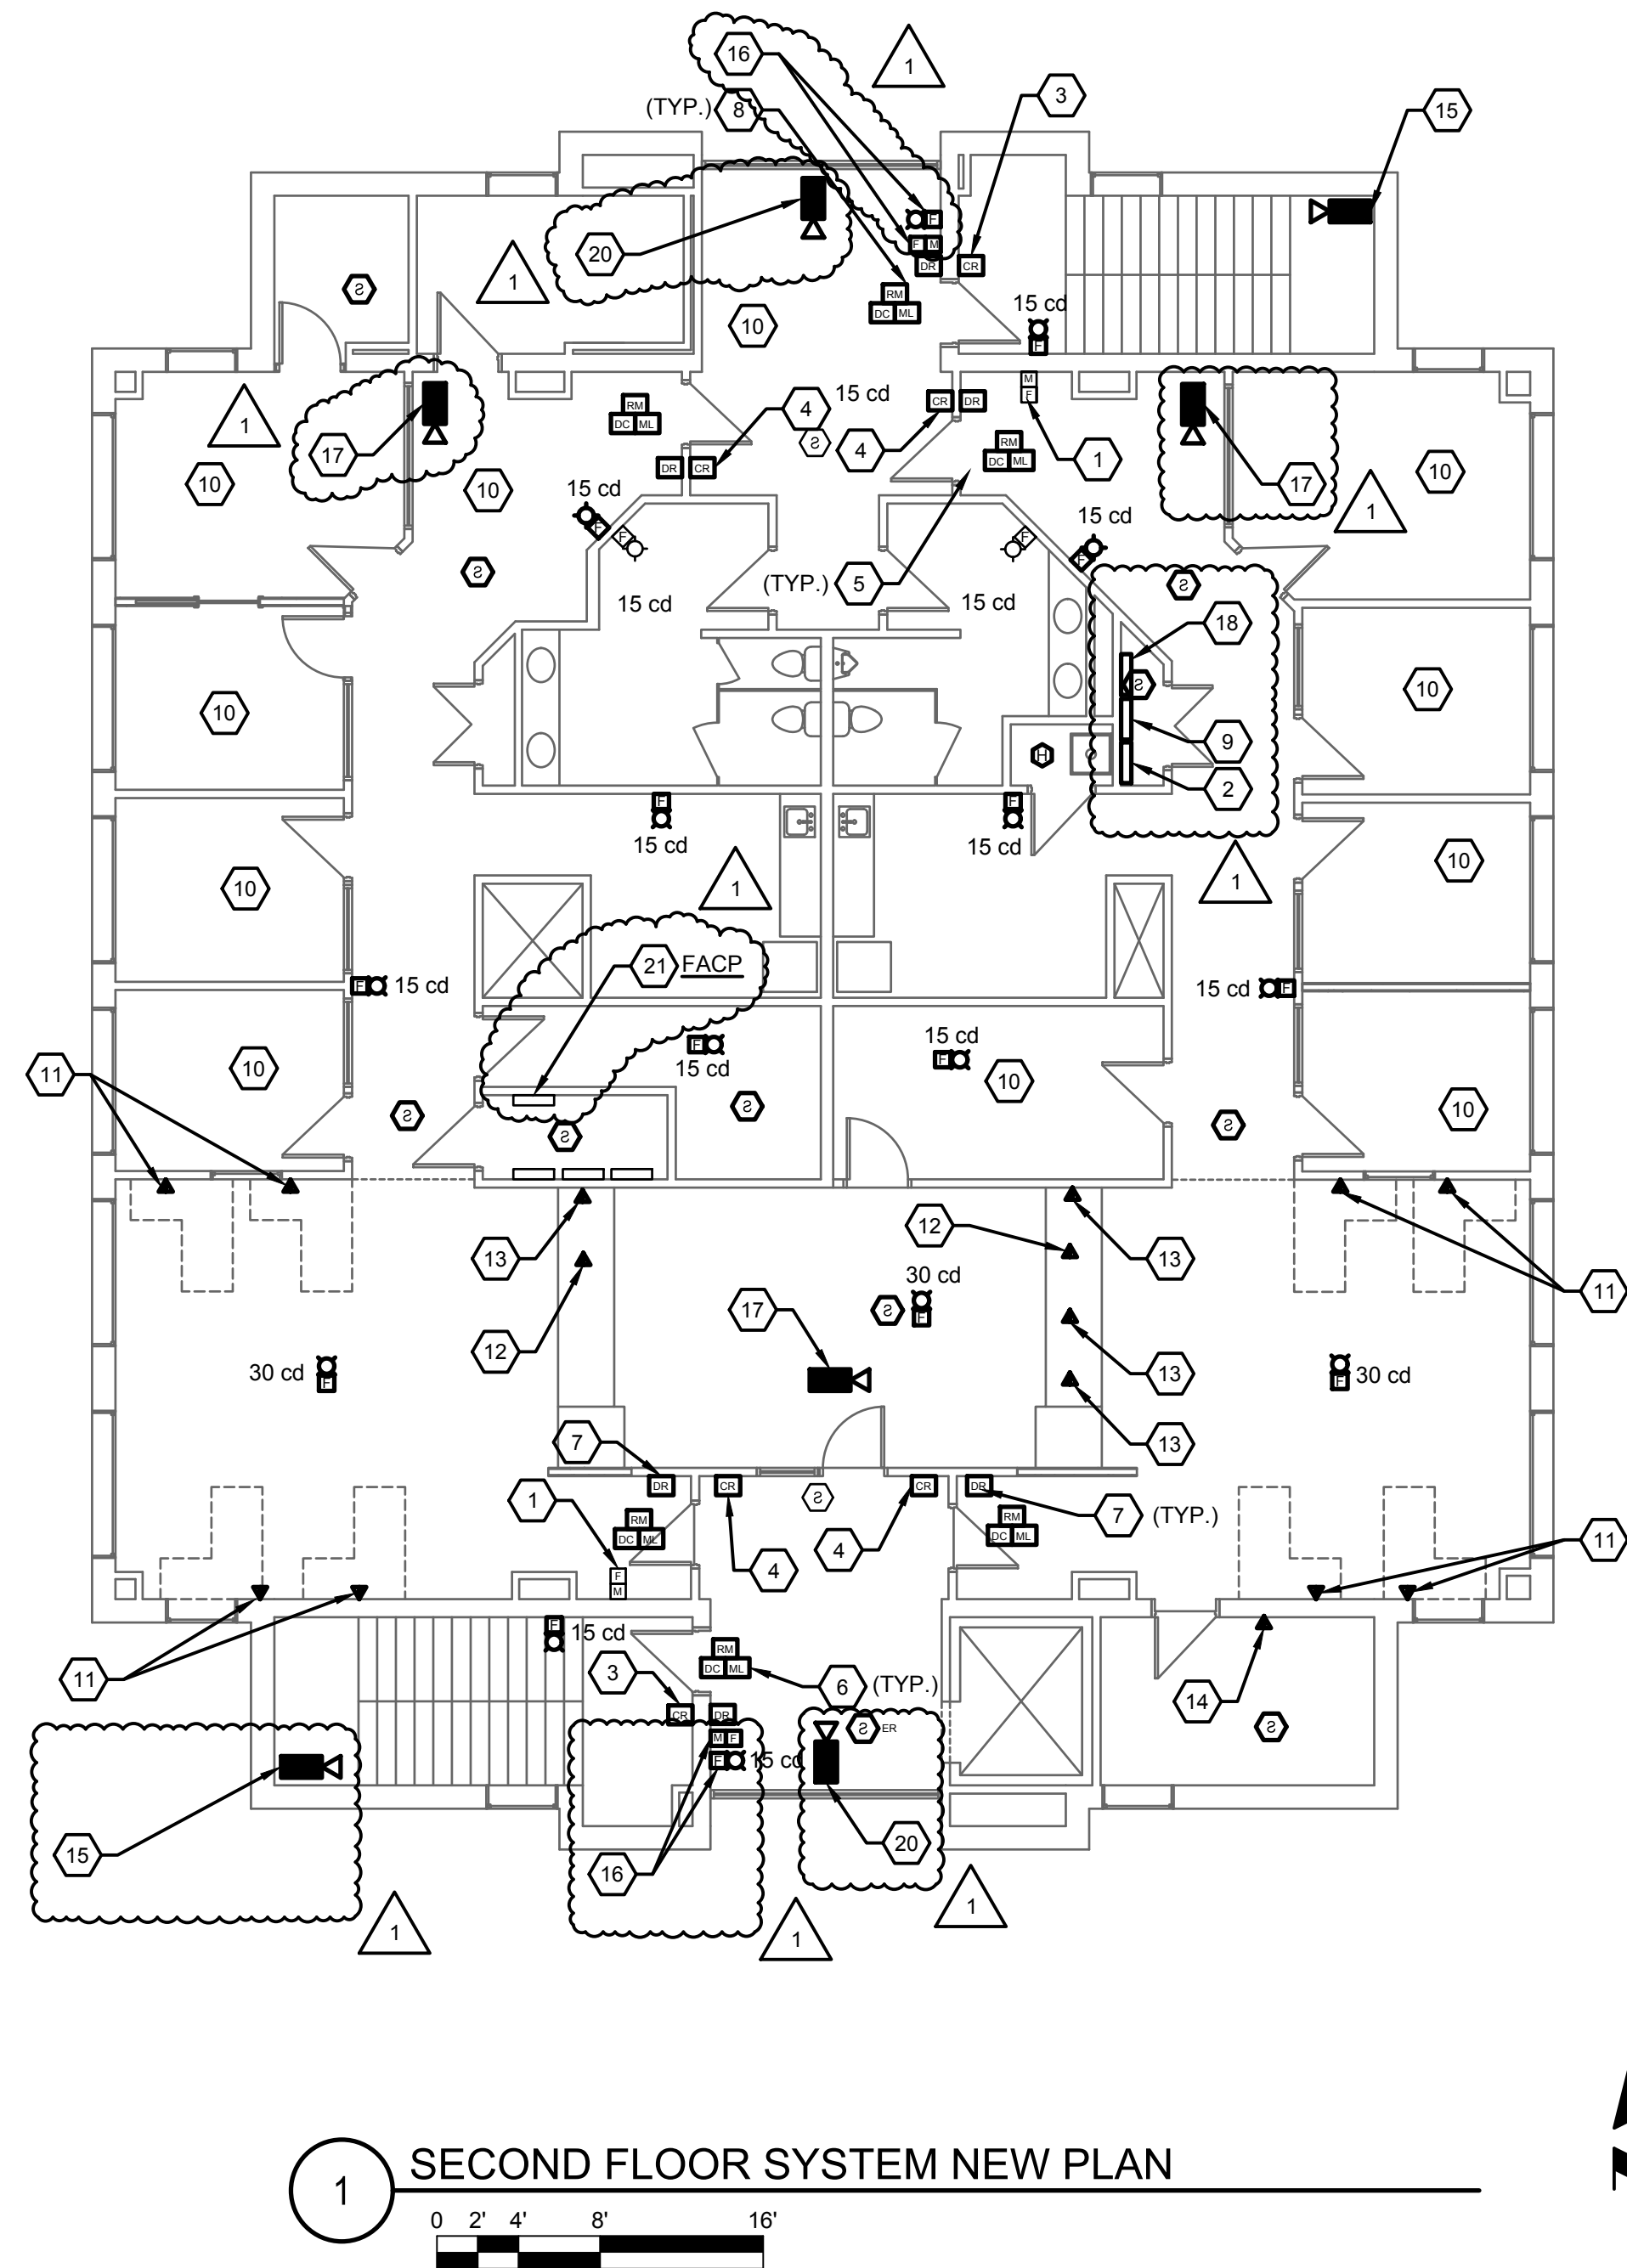
DRAWING TITLE

SECOND & THIRD FLOOR POWER NEW PLAN

PROJECT No.
07825001

DRAWING No.

E-2.11



- ### NOTES (THIS SHEET)


1. SEE SHEET E-0.01 FOR SYMBOLS AND ABBREVIATIONS.
2. ALL EXISTING ELECTRICAL DEVICES AND LIGHTS TO REMAIN UNLESS OTHERWISE NOTED. NOT ALL EXISTING ELECTRICAL DEVICES AND LIGHTS SHOWN.
3. ALL EXISTING CEILING MOUNTED DEVICES IN CEILINGS BEING REMOVED FOR CONSTRUCTION ARE TO BE REMOVED AND/OR PROTECTED DURING CONSTRUCTION, AND REINSTALLED AFTER CONSTRUCTION IS COMPLETED, UNLESS OTHERWISE NOTED.
4. CONTRACTOR SHALL PROVIDE NEW FIRE ALARM SYSTEM DEVICES AS SHOWN. THE INTENTION IS TO EXTEND THE EXISTING FIRE ALARM SYSTEM TO THE NEW DEVICES. SEE SPECIFICATION 28 31 00 FOR ADDITIONAL INFORMATION.
5. CONTRACTOR SHALL PROVIDE NEW CARD ACCESS SYSTEM INCLUDING DEVICES AS SHOWN. SEE SPECIFICATION 28 11 00 FOR ADDITIONAL INFORMATION.
6. CONTRACTOR SHALL PROVIDE NEW COMMUNICATIONS DEVICES, PLATES AND CABLING. SEE KEYNOTES AND THE DIVISION 27 SPECIFICATIONS FOR ADDITIONAL INFORMATION.
7. VIDEO SURVEILLANCE CAMERAS SHALL BE PROVIDED BY OTHERS. CONTRACTOR SHALL PROVIDE ROUGH IN AND CABLING. SEE KEYNOTES ON THIS SHEET FOR ADDITIONAL INFORMATION.

KEYNOTES (THIS SHEET)

1. EXISTING MANUAL PULL STATION TO REMAIN.
2. PROVIDE NEW CARD ACCESS CONTROL PANEL. PROVIDE CAT6 CABLE TO NEW PATCH PANEL AT EXISTING DATA CLOSET.
3. PROVIDE SURFACE MOUNTED CARD READER. PROVIDE SURFACE MOUNTED BOX. PROVIDE SURFACE MOUNTED CONDUIT TO THE INTERIOR OF THE SECURE SPACE. NO JUNCTION BOXES SHALL BE LOCATED IN THE STAIRWELL.
4. PROVIDE FLUSH MOUNTED CARD READER. PROVIDE RECESSED BOX AT EXISTING WALL. PROVIDE FLEXIBLE CONDUIT IN WALL TO A JUNCTION BOX AT THE INTERIOR OF THE SECURE SPACE.
5. PROVIDE SURFACE MOUNT DOOR CONTACT FOR DOOR POSITION MONITORING ON SECURE SIDE OF THE DOOR.
6. PROVIDE MAGNETIC LOCK ON SECURE SIDE OF DOOR.
7. PROVIDE DOOR RELEASE PUSH BUTTON.
8. PROVIDE FIRE ALARM RELAY MODULE TO INTERFACE MAGNETIC LOCK WITH THE FIRE ALARM SYSTEM.
9. EXISTING DATA CLOSET. PROVIDE NEW PATCH PANELS FOR TERMINATION OF NEW DATA CABLING.
10. PROVIDE (2) COMMUNICATIONS EQUIPMENT OUTLETS AND CABLING PER EXISTING DATA LOCATION IN THIS SPACE TO NEW PATCH PANEL AT THE EXISTING DATA CLOSET.
11. PROVIDE (2) COMMUNICATIONS EQUIPMENT OUTLETS AND CABLING TO NEW PATCH PANEL AT THE EXISTING DATA CLOSET.
12. PROVIDE (2) COMMUNICATIONS EQUIPMENT OUTLETS FOR A PRINTER LOCATED INSIDE THE CASEWORK TO NEW PATCH PANEL AT EXISTING DATA CLOSET. ROUTE CABLING DOWN THROUGH THE ADJACENT WALL AND INTO THE CASEWORK. NEATLY ROUTE CABLING THROUGH CASEWORK. PROVIDE SURFACE MOUNT "BISCUIT" BOX FOR DATA JACKS.
13. PROVIDE (2) COMMUNICATIONS EQUIPMENT OUTLETS FOR COMPUTER STATION AT THE CASEWORK TO NEW PATCH PANEL AT EXISTING DATA CLOSET. ROUTE CABLING DOWN THROUGH THE ADJACENT WALL AND INTO THE CASEWORK. NEATLY ROUTE CABLING THROUGH CASEWORK. PROVIDE SURFACE MOUNT "BISCUIT" BOX FOR DATA JACKS.
14. PROVIDE (2) COMMUNICATIONS EQUIPMENT OUTLETS FOR NEW COPY MACHINE TO NEW PATCH PANEL AT EXISTING DATA CLOSET. PROVIDE SURFACE MOUNTED RACEWAY TO ABOVE ACCESSIBLE CEILING.
15. CORNER MOUNTED CAMERA. PROVIDE SURFACE MOUNTED BOX WITH WIRE MOLD TO ACCESSIBLE CEILING INSIDE THE SECURE SPACE. PROVIDE (1) COMMUNICATIONS CABLE WITH AN RJ45 TERMINATION TO PATCH PANEL AT EXISTING DATA CLOSET. COORDINATE BOX REQUIREMENT WITH CAMERA SUPPLIER.
16. PROVIDE NEW FIRE ALARM DEVICES AT EXISTING BLOCK WALL. PROVIDE SURFACE RACEWAY ON WALL AND IN STAIRWELL AS REQUIRED TO GET ABOVE ACCESSIBLE CEILING INSIDE THE TENANT SPACE.
17. CEILING MOUNTED CAMERA. PROVIDE RECESSED BOX IN CEILING WITH CONDUIT TO ACCESSIBLE CEILING INSIDE THE SECURE SPACE. PROVIDE (1) COMMUNICATIONS CABLE WITH AN RJ45 TERMINATION TO PATCH PANEL AT EXISTING DATA CLOSET. COORDINATE BOX REQUIREMENT WITH CAMERA SUPPLIER.
18. PROVIDE 2" EMT RACEWAY FROM THE BASEMENT TO THE SECOND FLOOR FOR FIBER OPTIC/BACKBONE CABLE PROVIDED BY OTHERS. PROVIDE A 24"W X 24"L X 6"D HINGED COVER PULL BOX IN THE DATA CLOSET FOR FLOOR 1 AND FLOOR 2.
19. PROVIDE 2" EMT RACEWAY FROM THE SECOND FLOOR COMMUNICATIONS PULL BOX TO THE THIRD FLOOR FOR FIBER OPTIC/BACKBONE CABLE PROVIDED BY OTHERS. PROVIDE A 24"W X 24"L X 6"D HINGED COVER PULL BOX IN THE DATA CLOSET AT FLOOR 3.
20. CEILING MOUNTED CAMERA. PROVIDE RECESSED BOX IN TRAY CEILING AND RUN WIRE BACK TO ABOVE ACCESSIBLE CEILING. PROVIDE (1) COMMUNICATIONS CABLE WITH AN RJ45 TERMINATION TO PATCH PANEL AT EXISTING DATA CLOSET. COORDINATE BOX REQUIREMENT WITH CAMERA SUPPLIER.
21. EXISTING FIRE ALARM CONTROL PANEL.

LUMINAIRE SCHEDULE											
LUMINAIRE			LAMP			BALLASTS/DRIVER			MOUNT	DESCRIPTION	NOTES
TYPE	MANUFACTURER	CATALOG NUMBER	DESCRIPTION	NO.	WATTS	TYPE	NO.	VOLTAGE			
EM	LITHONIA	ECRG H0 SQ M6	LED	2	4	NA	NA	120	CEILING	COMBO EXT AND EMERGENCY	1
SCHEDULE NOTES: 1. SCHEDULE CONTAINS THE PREAPPROVED FIXTURES FOR THIS PROJECT. ANY SUBSTITUTIONS MUST BE APPROVED PRIOR TO THE BID DATE BY THE ENGINEER.											

PANEL:			P-5	OC DEVICE TYPE:	CB	ENCLOSURE:			SURFACE						BUS RATING (A):			100			
LOCATION:			3RD FLOOR	DEVICE FAMILY:	BOLT-ON	MOUNTING:									WITHSTAND (A):			10,000			
FED FROM:			P-4	MAIN BREAKER:	M.L.O.				L-L			L-N									
				WIRING:	4W+G	VOLTAGE:			208			120									
CCT	P	AMPS	LOAD DESCRIPTION	NOTES	LOAD (VA)	A _φ (VA)	B _φ (VA)	C _φ (VA)	LOAD (VA)	DESCRIPTION	NOTES	AMPS	P	CCT							
1	1	20	2ND FLOOR RECEPTACLES	-	360	1560			1200	3RD FLOOR MAG LOCKS	-	20	1	2							
3	1	20	2ND FLOOR RECEPTACLES	-	360		1560		1200	3RD FLOOR MAG LOCKS	-	20	1	4							
5	1	20	2ND FLOOR RECEPTACLES	-	360			1560	1200	3RD FLOOR MAG LOCKS	-	20	1	6							
7	1	20	2ND FLOOR RECEPTACLES	-	360	360			0	SPARE	-	20	1	8							
9	1	20	2ND FLOOR RECEPTACLES	-	360		360		0	SPARE	-	20	1	10							
11	1	20	2ND FLOOR COUNTER RECEPTS	-	720			720	0	SPARE	-	20	1	12							
13	1	20	2ND FLOOR PRINTER	-	960	960			0	SPARE	-	20	1	14							
15	1	20	2ND FLOOR PRINTER	-	960		960		0	SPARE	-	20	1	16							
17	1	20	2ND FLOOR COPIER	-	1200			1200	0	SPARE	-	20	1	18							
19	1	20	2ND FLOOR MAG LOCKS	-	1200	1200			0	SPARE	-	20	1	20							
21	1	20	2ND FLOOR MAG LOCKS	-	1200		1200		0	SPARE	-	20	1	22							
23	1	20	2ND FLOOR MAG LOCKS	-	1200			1200	0	SPARE	-	20	1	24							
25	1	20	2ND FLOOR SF-1	-	264	264			0	SPARE	-	20	1	26							
27	1	20	3RD FLOOR SF-2	-	264		264		0	SPARE	-	20	1	28							
29	1	20	SPARE	-	0			0	0	SPARE	-	20	1	30							
31	1	20	SPARE	-	0	0			0	SPARE	-	20	1	32							
33	1	20	SPARE	-	0		0		0	SPARE	-	20	1	34							
35	1	20	SPARE	-	0			0	0	SPARE	-	20	1	36							
37	1	20	SPARE	-	0	0			0	SPARE	-	20	1	38							
39	1	20	SPARE	-	0		0		0	SPARE	-	20	1	40							
41	1	20	SPARE	-	0			0	0	SPARE	-	20	1	42							
TOTAL VA PER PHASE:						4,344	4,344	4,680	TOTAL VA THIS PANEL:						13,368						
TOTAL AMPS PER PHASE:						36	36	39													

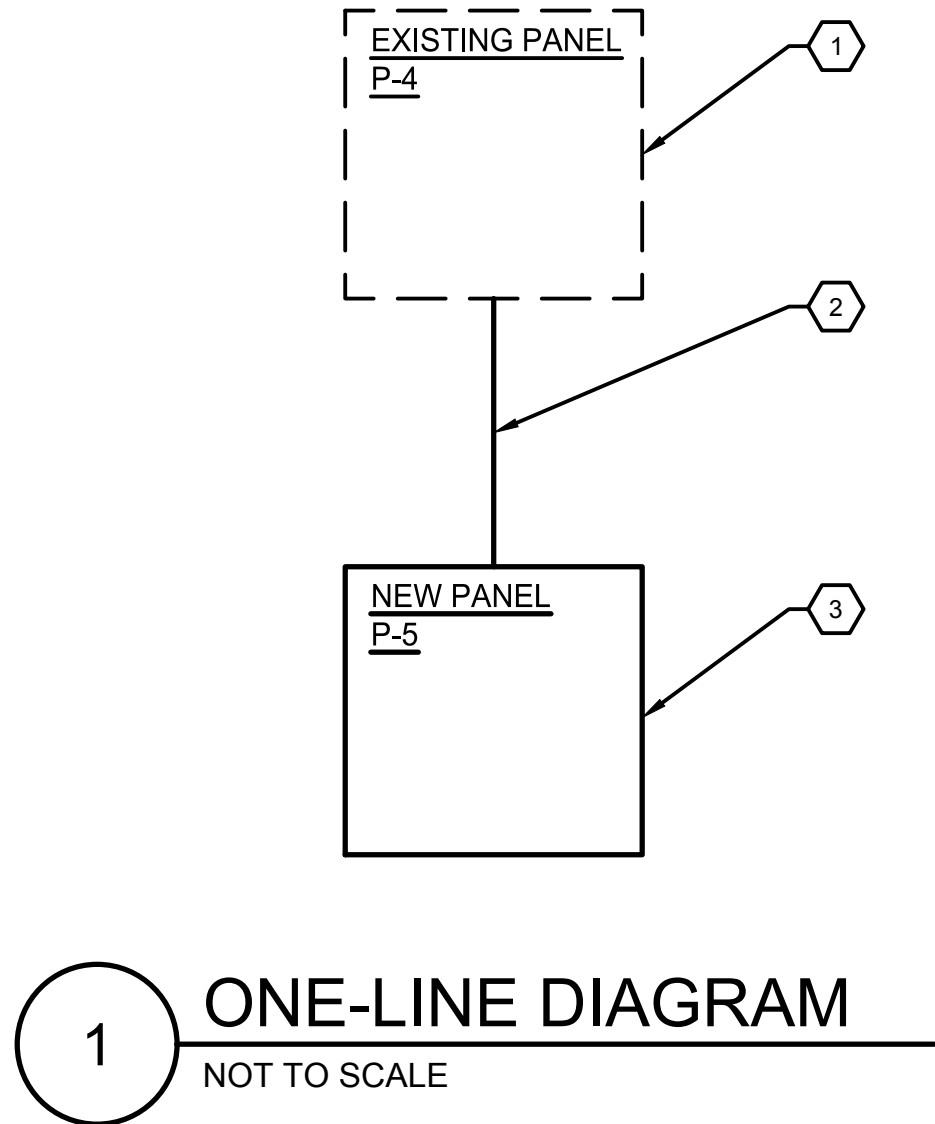

KEYNOTES (THIS SHEET)

1. PROVIDE NEW 100A/3P BREAKER AT EXISTING PANEL P-4. PANEL P-4 UTILIZES SQUARE D TYPE QO BREAKERS.
2. PROVIDE PANEL P-5. SEE CIRCUIT DIRECTORY.
3. PROVIDE (4) #2 AWG PHASE CONDUCTORS AND (1) #8 AWG EQUIPMENT GROUNDING CONDUCTOR IN 1-1/2" CONDUIT.

ClarkDietz

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PROJECT TITLE

E07825001 ENVOY - FLOYD
COUNTY ANNEX
RENOVATION

DRAWING TITLE

ELECTRICAL SCHEDULES &
ONE-LINE DIAGRAM

PROJECT No.

E07825001

DRAWING No.

E-4.01

FIRE PROTECTION GENERAL NOTES

1.

THE CONTRACTOR SHALL PROVIDE THE COMPLETE DESIGN AND DESIGN DRAWINGS FOR THE INSTALLATION OF THE FIRE SUPPRESSION SYSTEMS IN ACCORDANCE WITH NFPA STANDARDS. THESE DRAWINGS SHALL BE PREPARED AND SIGNED BY A PROFESSIONAL ENGINEER LICENSED IN THE STATE OF ILLINOIS.

A.

THE DESIGN OF THE FIRE SUPPRESSION SYSTEM SHALL BE IN ACCORDANCE WITH THE FOLLOWING CODES:

a.

IBC - 2021 EDITION

b.

NFPA 13 - 2022 EDITION

B.

EXCEPT WHERE NOTED ON THE DRAWINGS, ALL AREAS SHALL BE COMPLETELY PROTECTED BY AN APPROVED AUTOMATIC WET FIRE SUPPRESSION SYSTEM.

a.

THE SYSTEM SHALL BE DESIGNED TO ACCOMMODATE THE HAZARD LEVEL AS SHOWN ON THE DRAWINGS.

b.

NO MODIFICATION IS BEING MADE TO THE EXISTING FIRE DEPARTMENT CONNECTION.

C.

THE CONTRACTOR SHALL PROVIDE ALL DRAWINGS, CALCULATIONS, AND ADDITIONAL DOCUMENTATION TO ENGINEER.
2.

CONTRACTOR SHALL VERIFY LOCATION OF ALL EXISTING SPRINKELR HEADS AND PIPING, AND THAT ALL EXISTING PIPING IS ADEQUATELY SIZED FOR REVISED LAYOUT. CONTRACTOR SHALL INCLUDE COST ASSOCIATED WITH UP SIZING THE MAIN IN AREAS WHERE PIPING IS NOT ADEQUATELY SIZED.
3.

ALL NEW SPRINKLER PIPING SHALL BE ROUTED TO CONSERVE BUILDING SPACE. ALL PIPING TO BE EXPOSED SHALL BE CLEARLY DISPLAYED AND LABELED ON CONTRACTOR SUPPLIED DRAWINGS. WHERE EXPOSED, ALL PIPING SHALL BE ROUTED IN BETWEEN OR ADJACENT TO THE STRUCTURE.
4.

CONTRACTOR SHALL COORDINATE LOCATION AND ELEVATION OF NEW FIRE PROTECTION PIPING AND SYSTEM WITH EXISTING AND NEW RECESSED AND
- SURFACE MOUNTED LIGHTS, SMOKE DETECTORS, ALL EXISTING AND NEW CONDUITS, PIPING, DUCTWORK AND OTHER UTILITIES PRIOR TO INSTALLATION. WHERE CONDUITS, PIPING OR DUCTWORK REQUIRE RELOCATION TO INSTALL SPRINKLER PIPING, THE CONTRACTOR SHALL INCLUDE ALL COSTS ASSOCIATED WITH RELOCATING THE CONDUIT, PIPING OR DUCTWORK IN THEIR BID.

5.

ALL CUTTING AND PATCHING AS REQUIRED TO INSTALL THE FIRE SUPPRESSION SYSTEM SHALL BE BY THE CONTRACTOR.

6.

ALL EXPOSED FIRE PROTECTION PIPING SHALL BE PAINTED IN ACCORDANCE WITH THE SPECIFICATIONS. COLOR TO BE SELECTED BY THE ARCHITECT.

7.

NO SPRINKLER PIPING AND/OR SPRINKLER HEADS SHALL BE LOCATED DIRECTLY ABOVE ELECTRICAL EQUIPMENT.

8.

PIPING IS SHOWN IN SCHEMATIC FORM ONLY, CHANGES IN ELEVATION ARE NOT NECESSARILY SHOWN. ROUTE PIPING IN AN ORDERLY MANNER AS REQUIRED FOR CLEARANCE WITH STRUCTURAL CONDITIONS. COORDINATE LOCATION OF PIPING WITH OTHER TRADES PRIOR TO INSTALLATION. WHERE POSSIBLE, RACK PIPING HORIZONTALLY OR VERTICALLY.

9.

ALL CONNECTIONS TO, OR SHUTDOWNS OF, EXISTING SYSTEMS SHALL BE COORDINATED WITH THE OWNER TO PROVIDE MINIMUM INTERFERENCE WITH THEIR OPERATION AND DOWNTIME OF THE SYSTEM.

10.


CONTRACTOR SHALL BE RESPONSIBLE FOR PROVIDING ADEQUATE SUPPORTING SYSTEMS AND DEVICES FOR ALL PIPING, EQUIPMENT, AND ACCESSORIES PER NFPA REQUIREMENTS.

11.


CONTRACTOR IS REQUIRED TO INSTALL DRAIN VALVES IF PIPING ELEVATIONS ARE CHANGED DUE TO EXISTING UTILITIES. COORDINATE LOCATION OF DRAIN


- VALVE WITH OWNER AND USER. LABEL ALL DRAIN VALVES. SHOW ALL DRAIN VALVES ON AS-BUILT DRAWINGS. LOCATE ALL VALVES IN ACCESSIBLE LOCATION.
12.
- PROVIDE AND INSTALL SLEEVES FOR ALL PIPING PASSING THROUGH WALLS.
13.
- PROVIDE FIRE STOPPING OR FIRE CAULK AT ALL PENETRATIONS OF FIRE AND/OR SMOKE RATED WALLS, CEILINGS, AND FLOORS. SEE ARCHITECTURAL DRAWINGS FOR LOCATIONS OF FIRE AND/OR SMOKE RATED WALLS, CEILINGS, AND FLOORS.

FIRE PROTECTION LEGEND

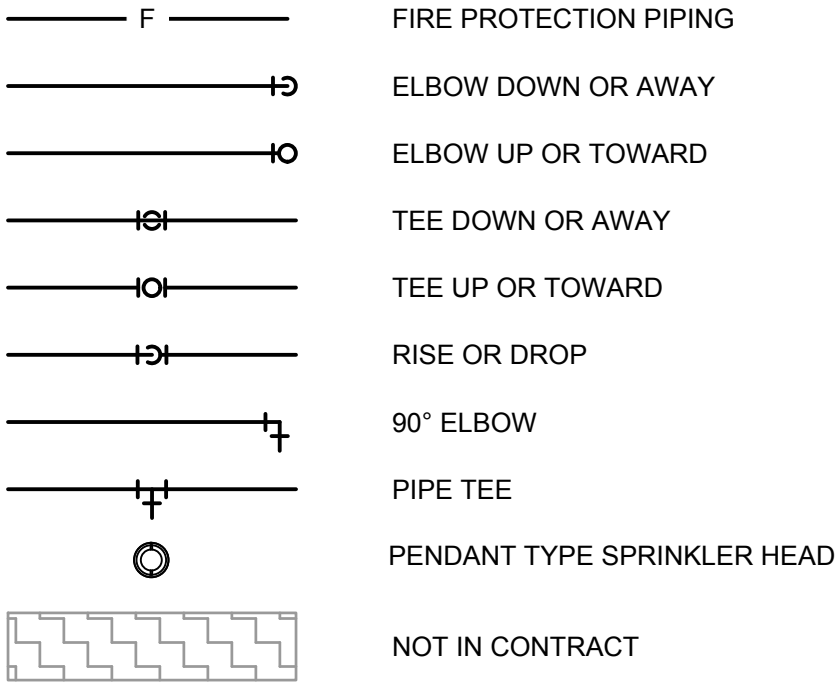


SPRINKLER HAZARD LEGEND

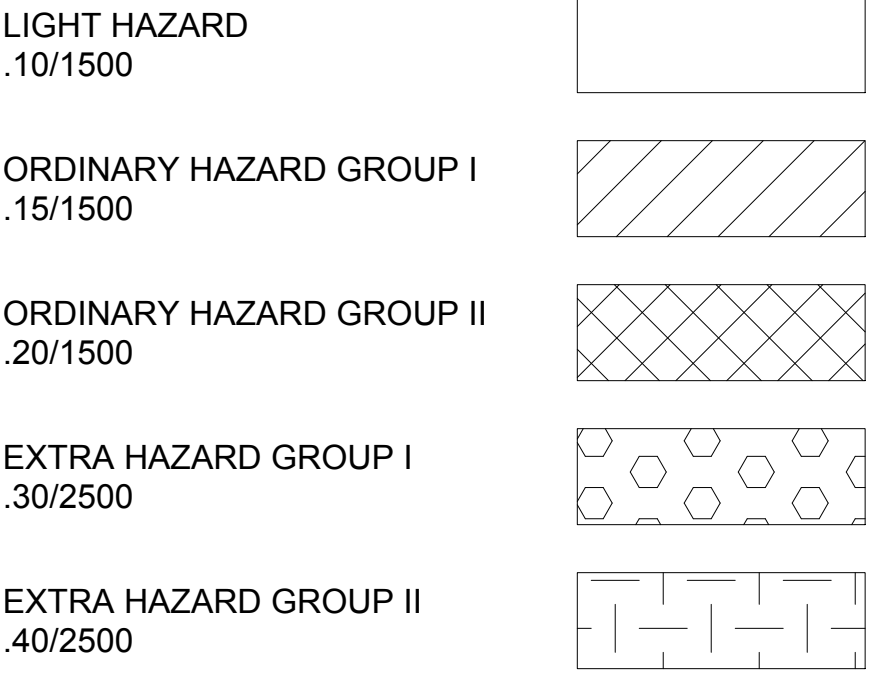

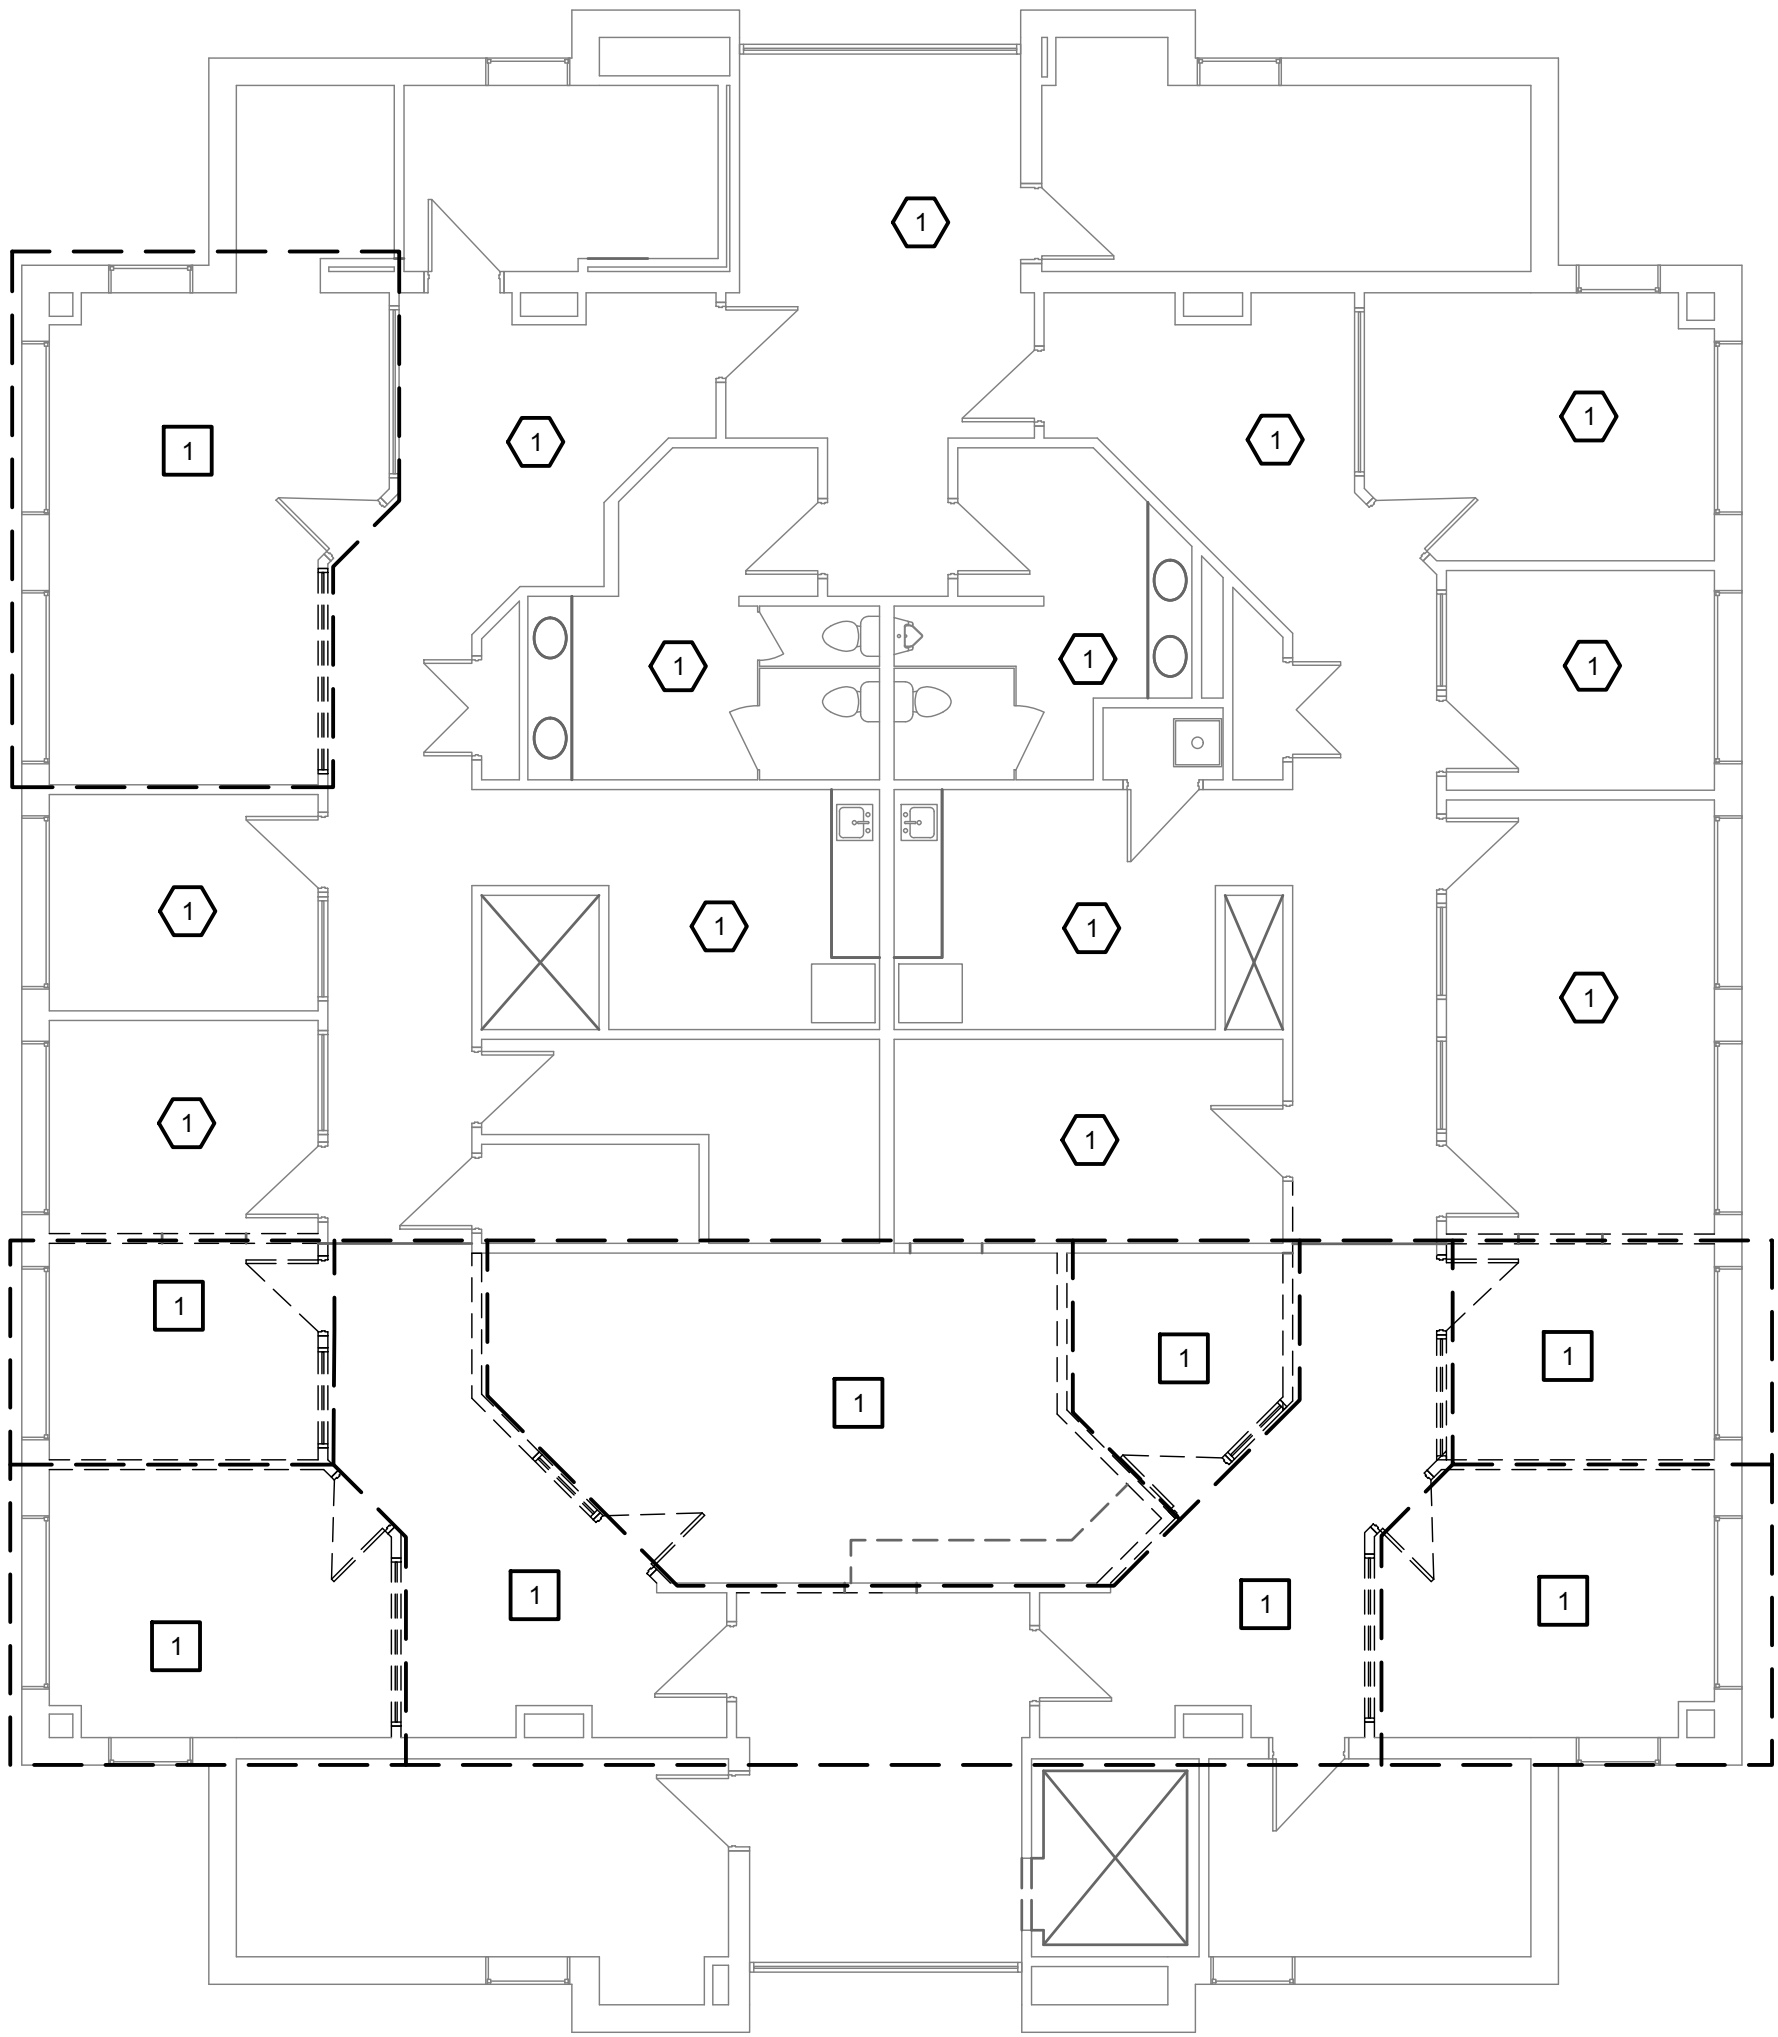

1 SECOND FLOOR FIRE PROTECTION DEMO PLAN

0 2' 4' 8' 16'

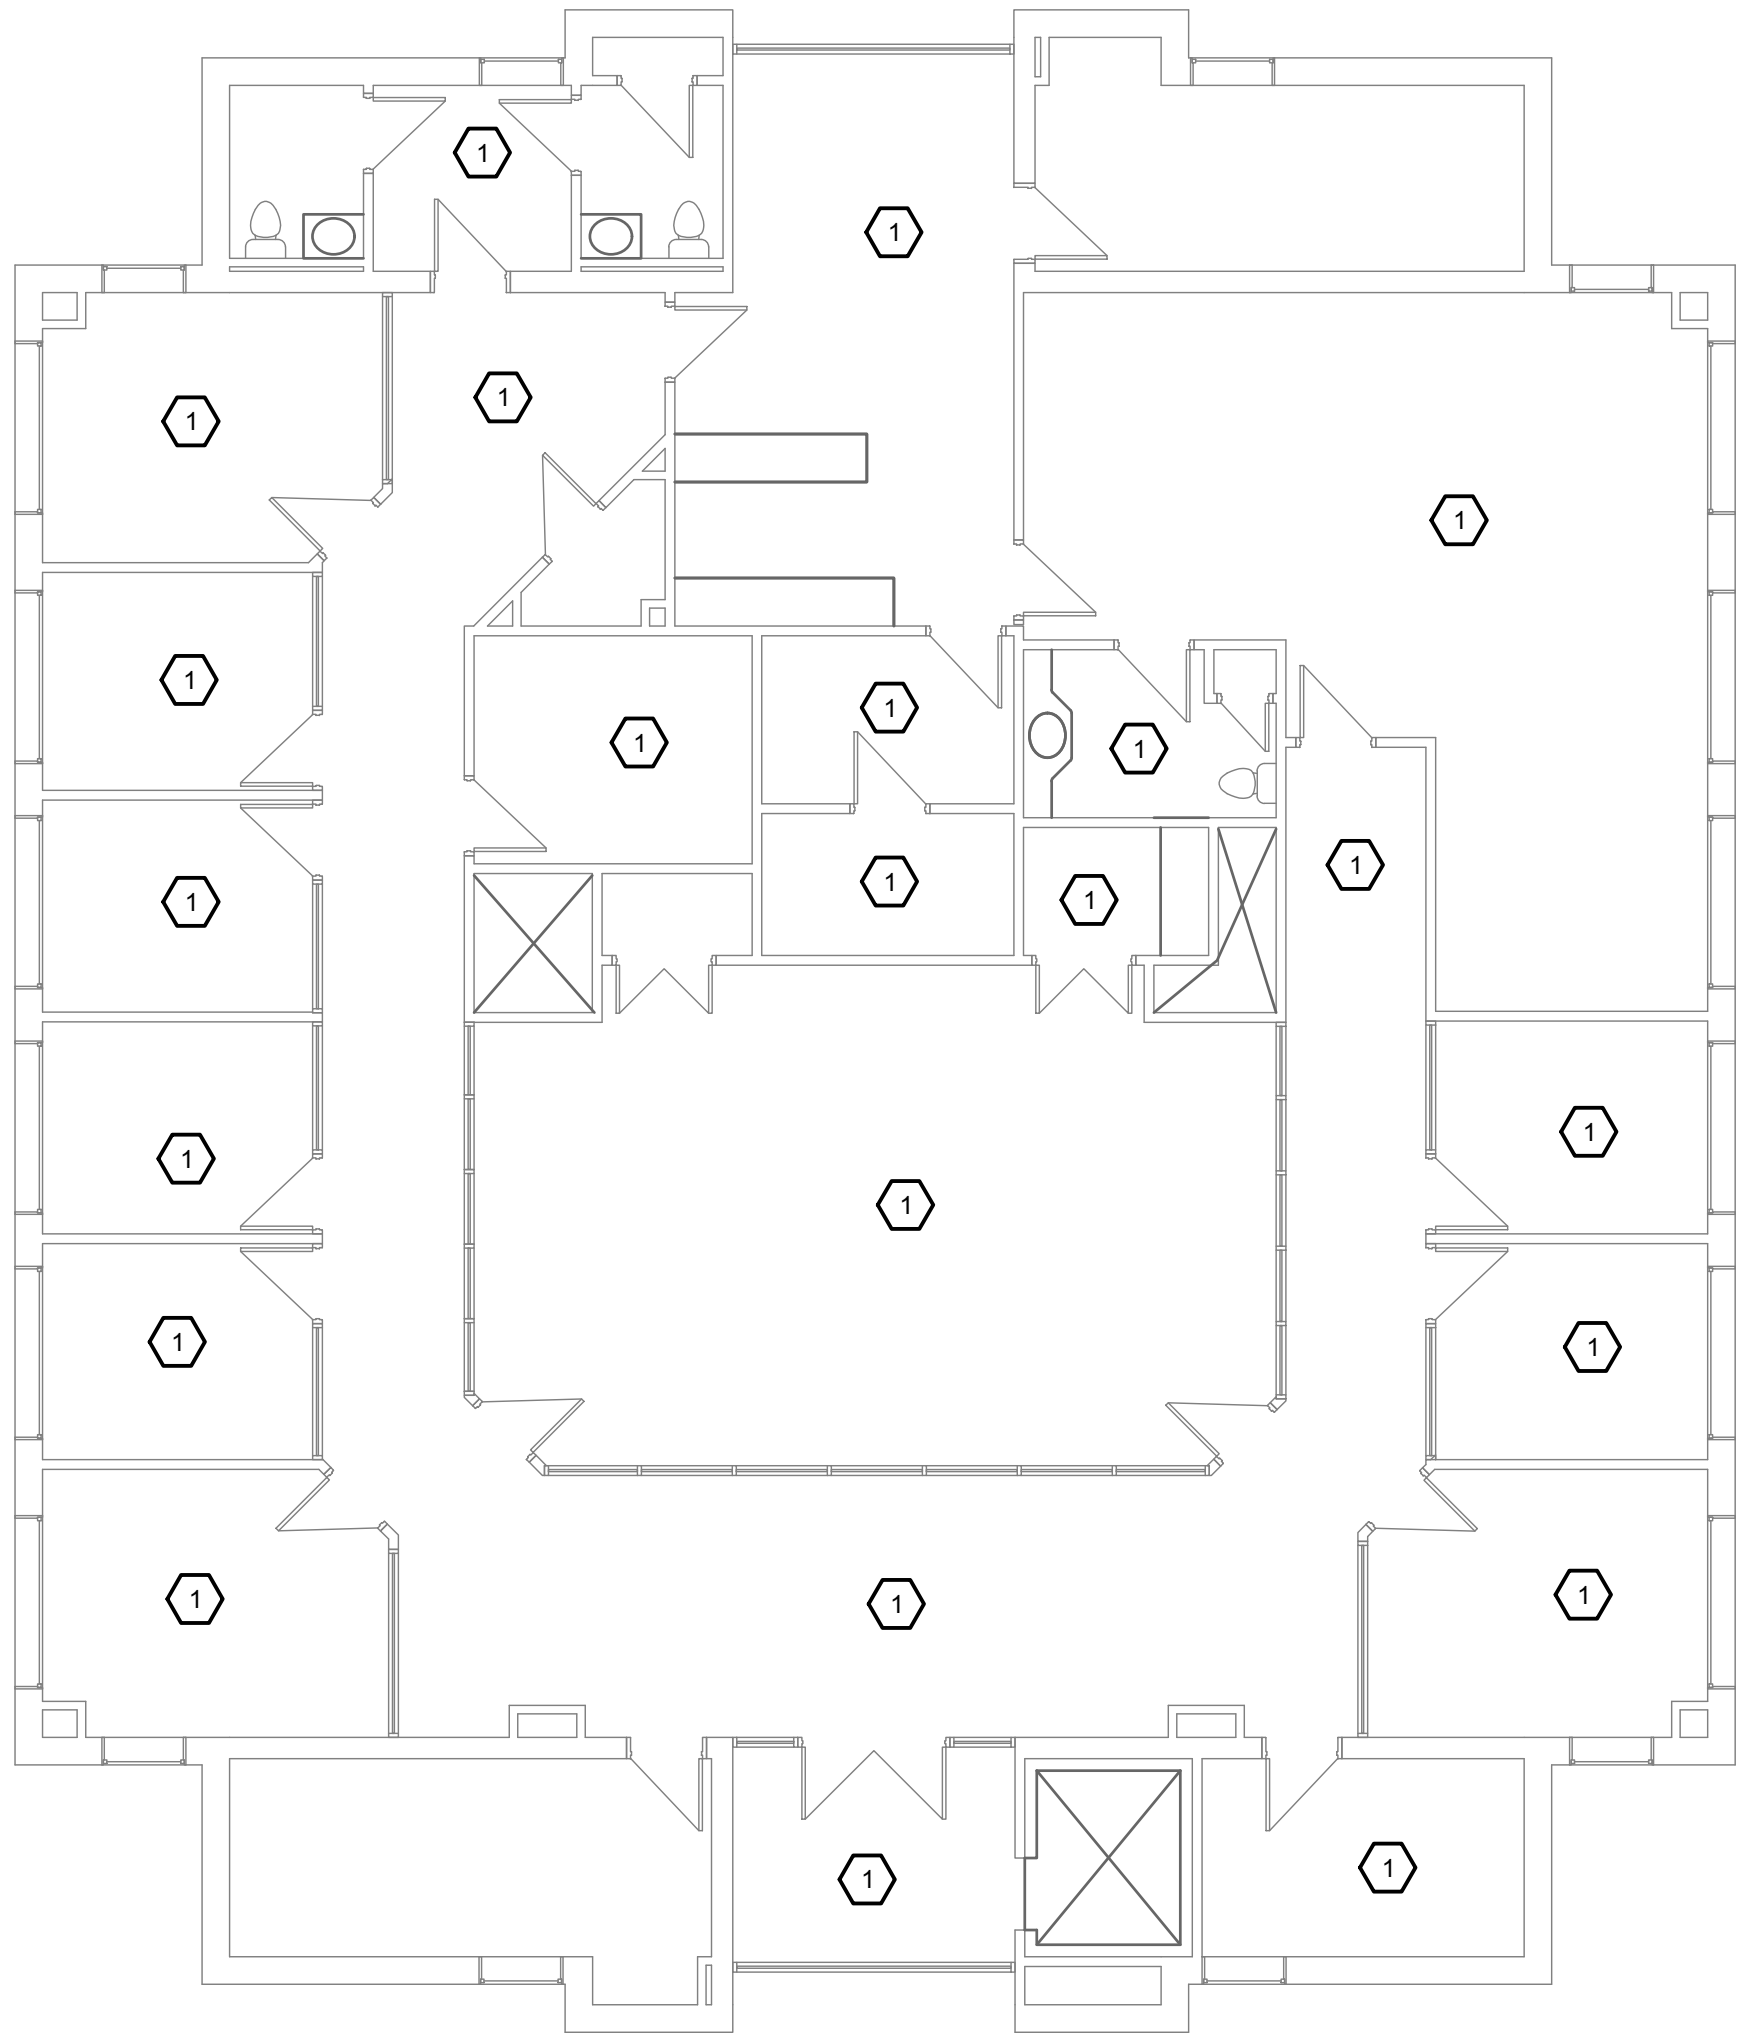

2 THIRD FLOOR FIRE PROTECTION DEMO PLAN

0 2' 4' 8' 16'



NOTES (THIS SHEET)

1. SEE SHEET FP-0.01 FOR SYMBOLS AND ABBREVIATIONS.

DEMOLITION KEYNOTES

1. REMOVE EXISTING SPRINKLER HEADS IN THIS AREA.

KEYNOTES (THIS SHEET)

1. EXISTING SPRINKLER HEADS AND PIPING IN THIS AREA TO REMAIN.

