### ADDENDUM NO. 02

Date: 09.12.2025

## Project: Sheridan HS and MS School Renovation Project

Owner: Sheridan Community Schools 24795 Hinesley Road Sheridan



### **Construction Manager:**

Hagerman, Inc 10315 Allisonville Road Fishers, IN 46038

TO: All Interested Bidders of Record

This Addendum #02, Dated 09.12.2025, forms part of the contract documents and modifies the original Bidding Documents dated 08.15.2025. Please acknowledge receipt of this Addendum in the space provided on the Bid Form. Failure to acknowledge this Addendum may subject the Bidder to disqualification.

The Hagerman, Inc portion of this Addendum consists of the following information:

- I. GENERAL INFORMATION
  - 1. CSO and Context, and R.E. Dimond Addendum #02 Dated 09.12.2025.
- II. CHANGES TO THE PROJECT CONTRACT MANUAL

- 1. All Contractors shall review the attached CSO Addendum #02 and incorporate the changes made to the drawings and specifications into the respective bid item scope of bids.
- 2. A Pre-Bid Meeting was held on 09.11.2025 at 3:30 pm. Hagerman reviewed the Bidding Procedures and the Prequalification Procedures for the project. Refer to the Bid Form and List of Bidding Requirements. The Bidding Contractors had the opportunity to walk the Project Building and Project Site and review the existing site conditions. All questions must be submitted in writing and answered in writing. See the attached pre bid meeting sign in sheets.
- 3. Replace Section 00 41 16 Bid Form with the new Bid Form issued as part of this Addenda #02.
- 4. Amend the Scope of Bids, Section 00 24 00, Subsection 1.3, Line #61 to read: There is no Geotechnical Report for this project.
- 5. Bid Item #01 General Trades Work shall furnish and install the work per the Notes on Detail 14 on S401. This includes private utility locates, sawcut, floor slab removal, excavation work, and new concrete work.
- 6. Bid Item #02 Masonry Contractor shall be responsible for CMU Wall Demo and Bid Item #01 General Trades, shall be responsible for the Concrete Floor Infill work, per the added Keyed Demolition Note 59 on Drawing AD201B. This applies to all drawings with Keyed Demolition notes per CSO Addendum #02.
- 7. All Contractors shall review and include your work per the Added Plan Note 14 and 15 on A201B.
- 8. Bid Item #06 Drywall Contractor shall furnish and install the bulkhead per Detail 3 on Drawing A210B and per RCP Note 14 on A210B. Bid Item #07 Painter shall provide the associated Painting Work.
- 9. Bid Item #10 Carpet, LVT and Base Work Contractor shall furnish and install the floor grinding and metal transition work per Finish Plan Note F16 and revised transition detail on A800 and A801A.

- 10.Bid Item #13 Mechanical Contractor shall be responsible for Plan Note 13 on Drawing PD201A.
- 11.Bid Item #12, Fire Protection Contractor shall furnish and install concealed style sprinkler heads in the new classrooms and office area. All heads except those that go in rooms with no ceilings, those can be the exposed type.
- 12.Bid Item #14 Electrical Contractor shall be responsible for salvaging the existing VFD per Plan Note 7 on Drawing MD201D.
- 13.Bid Item #14 Electrical Contractor shall be responsible for Plan Note 2 on Drawing ED201A. Note this might require some temporary electrical work to keep the building live until you install the new circuits and panels.
- 14.Bid Item #14 Electrical Contractor shall be responsible for Plan Note 4 on Drawing ED201B. Note this might require some temporary electrical work to keep the building live until you install the new circuits and panels.
- 15.Bid Item #14 Electrical Contractor shall note the changes made to Drawing E201B, E201D, E211A, E211D, E601.
- 16.Note: Bid Item #14 Electrical Contractor shall note the ceiling material changes per the Addendum #01, Drawing A210B, at the Grow Lab Room 125D, therefore Bid Item #14 Electrical Contractor will need to change the Light Fixtures from a ceiling mount type to a lay in on Drawing E201B.
- 17.Bid Item #14 Electrical Contractor shall be responsible for Plan Note 3 on Drawing TD201A.
- 18.Bid Item #01 General Trades Contractor, amend Scope of Bid, Line Item #151 to read: Bid Item #01 General Trades to furnish and install the "TB1" metal framed tackboard assemblies like shown in the Choir Room details 1 and 3 on A601 and per A800 and per specs 10 11 00.
- 19.Bid Item #05 Aluminum Window Contractor, amend Scope of Bid, Line Item #36 to read: Bid Item #05 Aluminum Window Contractor shall furnish

- and install the Mirrors per legend and as shown on the interior elevation drawings A601 and A602. For example, detail 2 on A601.
- 20.Bid Item #11 Manufactured Casework Contractor, amend Scope of Bid, Line Item #41 to read: Note: Bid Item #01 General Trades to furnish and install the "TB1" metal framed tackboard assemblies like shown in the Choir Room details 1 and 3 on A601 and per A800 and per specs 10 11 00.
- 21.Bid Item #02 Masonry Contractor shall be responsible for all of the Masonry Walls, CMU and Brick Masonry demo as is relates to Keyed Demolition Notes 1, 2, 33, 48 and 59 on Drawings AD201A, AD201B, AD201D, and AD401. Also, Bid Item #01 General Trades is responsible for the select demo work of items like hollow metal window frames and glass, doors and frames, etc., that are in the CMU walls.
- 22.All Contractors shall be responsible for General Finish Note 4 on Drawings A800, A801A, A801B, and A801D as it relates to your bid package.
- 23.Bid Item #07 Painting Contractor shall be responsible for General Finish Note 15 on Drawings A800, A801A, A801B, and A801D.
- 24.Bid Item #01 General Trades Contractor, amend Scope of Bid Line Item #182 to read: Bid Item #01 General Trades Contractor shall furnish and install the work per the Note: Existing network pathways and cabling in existing Shop room 128F to be protected during demolition and construction as needed. Refer to Plan Note 3 on Drawing TD201B for location of the existing network pathways.
- 25.Bid Item #01 General Trades shall be responsible to remove any unused MEP Concrete House Keeping Pads.
- 26. Amend the Scope of Bid, Bid Item #09 Epoxy Floor Work, Item #10 to read as follows: Bid Item #09 Epoxy Floor Contractor shall furnish and install the Concrete Surface Treatment per Section 03 35 00 at all rooms that receive Sealed Concrete, "SC" on the Room Finish Drawing A800 and A801A, A801B and A801D and Finish Plan Note F6.
- 27.Bid Item #13 Mechanical Contractor shall furnish and install the work per Section 23 81 34 Mini Split Air Conditioning.

### III. DESIGN INFORMATION

1. CSO, Context, and R.E. Dimond Addendum #02 Dated 09.12.2025.

END OF SECTION

1



# SHERIDAN HS AND MS RENOVATION PROJECT PRE BID MEETING SIGN IN SHEET 09.11.2025 @ 3:30 PM

LOCATION:	E-MAIL ADDRESS PHONE NUMBER  Samondale @ C-Cal. Com 317-385-7432	Solley Or Or M. Sciences (UC. Co. y 31). SEC. 3585	1 12	TCHNTMOLLE CONSO FLOOR FICE	aldespling of lagermanger com 517-607-0160 measillar @sceeof, com 765-461-2038.	ILKemny @ Deloss Inc. Com 317-502-1595	er Abauldine Tecta America. Corr 317-464-7765	For Sweeze le ctric com (765) 215-6721 + 02cobauch @ lomas melunt, mb 265-617 200	Chadreding Shifonventilation, com 317-308-8194
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MEETING DATE: () () () 2025	Showy Amorphale	Scott Culler Brandon Foster	Tyle Boumer	They Caltracel	Mike CASILLAS	Jeny Kemma	Ronny Cauldin	Free Persy	Chaol Peding



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# SHERIDAN HS AND MS RENOVATION PROJECT PRE BID MEETING SIGN IN SHEET 09.11.2025 @ 3:30 PM

MEETING DATE:	TIME:LOCA	LOCATION:
NAME	COMPANY NAME	E-MAIL ADDRESS PHONE NUMBER
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Tony Matheresis	Deloss Specializas	1524 @ Delossing, com 317 937-0985
Nick Tsolver	Pridemork	
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# SHERIDAN HS AND MS RENOVATION PROJECT PRE BID MEETING SIGN IN SHEET 09.11.2025 @ 3:30 PM

	PHONE NUMBER	acendicorp Chotmail.con (317)374-2695				
LOCATION:	E-MAIL ADDRESS	acendicorp Photona				
TIME: LC	COMPANY NAME	ACII CENDENDATION				
MEETING DATE: $\sqrt{/ll/2}$	NAME	LuDue				

COMPANY N	AME OF BIDDER:				
PROJECT:	Sheridan High School &	Middle School	Renovations (Bid Package #01)		
BID DATE: September 25, 2025					
BID TIME:	2:00 PM				
BIDDERS AR THEIR BID:	E TO COMPLETE AN	D SUBMIT T	HE FOLLOWING FORMS WITH		
<ul> <li>2. One (1) of the B Bond at </li> <li>3. One (1) signed 1 </li> <li>4. Bid Sub</li> </ul>	Base Bid or a certified chend/or Certified check made	the form of an Acck in the amounted to He Board of Acco	AIA A310 Bid Bond in the amount of 10% nt of 10% of the Base Bid. Note: The Bid agerman, Inc. punts Form 96 (revised 2013) including a		
Sheridan High Hagerman, Inc.	Community Schools y Road 6069				
with local cond Work, in accord dated 8/15/202	litions affecting the cost of dance with the Project Co	of this Work, he ontract/Subcont	york and having familiarized himself/herself reby proposes to perform the following listed ract Manual/Specifications and Drawings, cations Letters issued prior to the due date of		
(prices) for <u>nine</u> Hagerman, Inc. Bidder agrees t	ety (90) consecutive days to perform work for the go guarantee Alternate Bio ward or Agreement for a	from date of sustated bid sums d Sums for thos	sal, Bidder agrees to guarantee the bids abmittal and enter into an agreement with at any time during this period. Further, the e Alternate Bids not initially acceptable in a hundred twenty (120) days from the date of		
Addenda Recei	ived & Included:	No	Dated		
Addenda Recei	ived & Included:	No	Dated		

Addenda Received & Included:

No.\_\_\_\_ Dated\_\_\_\_

BASE BID: Bid Item #01 – General Trades Work (words)		•	_
Bid Item #01 – General Trades Work			_
	:		
BASE BID:			
	0%) of the Con	<b>D:</b> A Performance Bond and Payment Bond ntract Amount may be required of the succe Bid Item.	
<b>NOTE: Refer</b> to Section 00 43 21 for A Section 00 43 23 for the Alternate(s).	Allowance(s), S	Section 00 43 22 for Unit Price(s) and	
included in Specification Section 00 24	00, covered by	tify that I have reviewed the Scope of Bids y this Bid Form, and acknowledge that the rk stated in the Scope of Bids without any	
	ion 00 31 13, c	Γ: I certify that I have reviewed the project covered by this Bid Form, and acknowledge schedule without any modifications.	
Revisions/Clarifications Letter Received	d/Included:	Dated	
Revisions/Clarifications Letter Received	d/Included:	Dated	
Revisions/Clarifications Letter Received	d/Included:	Dated	
Revisions/Clarifications Letter Received	d/Included:	Dated	
Addenda Received & Included:	No	Dated	
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Addenda Received & Included:	No	Dated	
A 11 1- D 1 0 T 1- 1 - 1.			

## Bid Item #02 – Masonry Work:

(words)	
	<u>\$</u>
Performance & Payment Bond	(add) \$
(See Alternates: #03)	<del></del>
Bid Item #03 – Steel Work:	
(words)	
	<u>\$</u>
Performance & Payment Bond	(add) \$
(See Alternates: #01, #02, #03)	<u> </u>
Bid Item #04 – Roofing and Metal Canopy Work:	
(words)	
	<u>\$</u>
Performance & Payment Bond	<u>(add)</u> \$
(See Alternates: #01, #02, #03)	
Bid Item #05 – Aluminum Window and Door Work:	
(words)	
	<u>\$</u>
Performance & Payment Bond	<u>(add)</u> \$
(See Alternates: #03)	
Bid Item #06 – Metal Stud, Drywall, Insulation, Acous	stic Ceilings, and Sound Panel Work:
(words)	
	<u>\$</u>
Performance & Payment Bond	(add) \$
(See Alternates: #03, #06)	<del></del>

### **Bid Item #07 – Painting and Wallcovering Work:**

(words)	
	\$
Performance & Payment Bond (See Alternates: #03, #06)	(add) \$
Bid Item #08 – Tile Work:	
(words)	
	\$
Performance & Payment Bond (See Alternates: #03)	(add) \$
Bid Item #9 – Epoxy Resinous Flooring Work:	
(words)	
	\$
Performance & Payment Bond (See Alternates: #03, #04a)	(add) \$
Bid Item #10 – Carpet, LVT, and Base Work:	
(words)	
	\$
Performance & Payment Bond (See Alternates: #03, #04b)	(add) \$
Bid Item #11 – Manufactured Casework and Tops Work:	
(words)	
	<u>\$</u>
Performance & Payment Bond (See Alternates: #03, #05)	(add) \$

## **Bid Item #12 – Fire Protection Work:**

(words)	
	\$
Performance & Payment Bond	(add) \$
Bid Item #13 – Plumbing, Mechanical, HVAC Duc	twork, and Temperature Controls Work:
(words)	
	\$
Performance & Payment Bond (See Alternates: #01, #02, #03)	<u>(add)</u> \$
Bid Item #14 – Electrical and Fire Alarm, AV, and	Technology Work:
(words)	
	\$
Performance & Payment Bond	(add) \$
(See Alternates: #01, #02, #03)	

### **COMBINATION BIDS:**

Bidders may propose combination bids of two or mornot award subcontracts based on the Combination Bid	
Bid Item Nos. / / / / / _ (amount	in words)
	\$
Performance & Payment Bond	<u>(add)</u> \$
UNIT PRICING: NONE	
ALLOWANCES: NONE	
BID ALTERNATES: All alternates shall be reviewed for each bid item. If Hagerman assumes no added or deducted cost for the add/deduct for the performance bond and payment be Alternate No. 01: Existing Middle School Roof R	nat scope of work. Please state the amount to bond in the space provided for each bid alternate
(Refer to Drawings: AD220C, AD220D, A220C, a	and A220D)
Base Bid: Existing roof system to remain.	
Alternate: Bid Item #01 General Trades Contractor's detail 4 on drawing A411 and spec section 06 10 53 existing roofing membrane, insulation, coping, gravidrawings AD220C and AD220D and per spec section curbs, gutters, downspouts, and fascia as indicated in to detail 3 on drawings AD401. Bid Item #04 Roofing Thermoplastic Polyolefin (TPO) Roofing, fully adher A104, A220C, A220D, A301 and per spec section 0 coping, insulation, termination bars, gravel stops, see Bid Item #04 shall also provide all expansion joints Refer to details on drawings A401, A410, and A411 responsible for temporarily removing the existing road AD220C and AD220D. Bid Item #13 shall reinstall A220D.	Bid Item #04 Roofing Contractor to remove el stops, gutters, and downspouts as indicated in on 02 41 19. Salvage existing expansion joints, in the drawings and roof demolition notes. Refering Contractor shall furnish and install new ered attached system as shown on drawings of 54 23. This includes all membranes, flashings calants, substrates, walkways, etc. as indicated. per detail 4 on A411 and per spec 07 95 00.  Bid Item #13 Plumbing Contractor shall be profided by the confidence of Demolition Note 6 on
Bid Item #01: General Trades Work	<u>(add)</u> \$
Performance & Payment Bond	<u>(add)</u> \$

Bid Item #04: Roofing and Metal Panel Work	(add) \$	
Performance & Payment Bond	(add) \$	
Bid Item #13: Plumbing, Mechanical, HVAC Ductwork, and Temperature Controls Work		
	(add) \$	
Performance & Payment Bond	(add) \$	
Bid Item #14: Electrical and Fire Alarm, AV, and Technology Work		
	(add/deduct) \$	
Performance & Payment Bond	(add/deduct) \$	
Alternate No. 02: Existing High School CTE Roof Replacement (Area B) (Refer to Drawings: AD220B and A220B)		
Base Bid: Existing roof system to remain.		
Alternate: Bid Item #01 General Trades Contractor shall for detail 6 on drawing A410 and spec section 06 10 53. Bid I existing roofing membrane, insulation, coping, gravel stop drawing AD220B and per spec section 02 41 19. Salvage of downspouts, and fascia as indicated in the drawings and roofing Contractor shall furnish and install new Thermop adhered attached system as shown in drawings A104 and a includes all membranes, flashings, coping, insulation, term substrates, walkways, etc. as indicated. Refer to details on Plumbing Contractor shall be responsible for temporarily in Demolition Note 6 on AD220B. Bid Item #13 shall reinstated A220B.	tem #04 Roofing Contractor to remove os, gutters, and downspouts as indicated in existing expansion joints, curbs, gutters, of demolition notes. Bid Item #04 lastic Polyolefin (TPO) Roofing, fully A220B and per spec section 07 54 23. This mination bars, gravel stops, sealants, drawings A402 and A410. Bid Item #13 removing the existing roof drains per Roof	
Bid Item #01: General Trades Work	(add) \$	
Performance & Payment Bond	(add) \$	
Bid Item #04: Roofing and Metal Panel Work	(add) \$	
Performance & Payment Bond	(add) \$	

Bid Item #13: Plumbing, Mechanical, HVAC Ductwork, and Temperature Controls Work

	(add) \$
Performance & Payment Bond	(add) \$
Bid Item #14: Electrical and Fire Alarm, AV, and Te	chnology Work
	(add/deduct) \$
Performance & Payment Bond	(add/deduct) \$
Alternate No. 03: Alternative High School Classro	<u>ooms</u>
Base Bid: All work per the Drawings: AD201B, AD4 A801B, A901B, PD101B, PD201B, P101B, P201B, E211B, TD201B, T201B, and Details 3 and 4 on S20 details on the other drawings and all per specs. Also random "CLASSROOM 124" to be existing to remain. Room "BREAK ROOM 123B", and "RESTROOM 123C" Reduce the amount of work for the Alternative Class per the Alternate Notes on the Following Drawings: A290, A201B and Refer to A290, A210B and Refer A701, A8001, A801B, A901B, Alternate Detail on M201B, Alternate on M211B, Alternate Detail on T201B, Details 5 and 6 on S201, and the associated and all per specs. Also refer to the Bid Alternate Sections.	MD201B, M201B, M211B, ED201B, E201B, 01, 5/S701 and the associated sections and refer to the Scopes of Bid.  tween rooms "CLASSROOM 123" and as: "SMALL GROUP ROOM 123A", to be removed from the drawings entirely. room Work in Unit B. This includes the work AD201B and Refer to A290, AD401 and Refer to A290, A290, A301, A402, A501, A650, 101B, Alternate Detail on P201B, Alternate etail on E201B, Alternate on E211B, Alternate etail on the other drawings
deduct.  Did Itam #01. Canaral Trades Work	(add/dadwat) ©
Bid Item #01: General Trades Work  Performance & Payment Bond	(add/deduct) \$ (add/deduct) \$
renormance & rayment Bond	(add/deddct) s
Bid Item #02: Masonry Work	(add/deduct) \$
Performance & Payment Bond	(add/deduct) \$
Bid Item #03: Steel Work	(add/deduct) \$
Performance & Payment Bond	(add/deduct) \$

Bid Item #04: Roofing and Metal Canopy Work	(add/deduct) §				
Performance & Payment Bond	(add/deduct) \$				
Bid Item #05: Aluminum Window and Door Work	(add/deduct) \$				
Performance & Payment Bond	(add/deduct) \$				
Bid Item #06: Metal Stud, Drywall, Insulation, Acoustical Ceilings, and Sound Panel Work					
	(add/deduct) \$				
Performance & Payment Bond	(add/deduct) \$				
Bid Item #7: Painting and Wallcovering Work	(add/deduct) \$				
Performance & Payment Bond	(add/deduct) \$				
Bid Item #08: Tile Work	(add/deduct) \$				
Performance & Payment Bond	(add/deduct) \$				
Bid Item #09: Epoxy Resinous Flooring Work	(add/deduct) \$				
Performance & Payment Bond	(add/deduct) \$				
Bid Item #10: Carpet, LVT, and Base Work	(add/deduct) \$				
Performance & Payment Bond	(add/deduct) \$				
Bid Item #11: Manufactured Casework and Tops Wor	rk (add/deduct) \$				
Performance & Payment Bond	(add/deduct) \$				
Bid Item #12: Fire Protection Work	No work associated with this bid alternate)				
Bid Item #13: Plumbing, Mechanical, HVAC Ductwork, and Temperature Controls Work					
	(add/deduct) \$				
Performance & Payment Bond	(add/deduct) \$				

Bid Item #14: Electrical and Fire Alarm, AV, and Te	echnology Work
	(add/deduct) \$
Performance & Payment Bond	(add/deduct) \$
Alternate No. 04: Flooring Moisture Mitigation	
Base Bid: No moisture mitigation material under flo	oring materials.
Alternate 4a: Bid Item #9 Epoxy Flooring contractor an approved moisture mitigation material under all earchitectural drawings.	
Bid Item #09: Epoxy Resinous Flooring Work	(add) \$
Performance & Payment Bond	(add) \$
Alternate 4b: Bid Item #9 Carpet and LVT Flooring and installing an approved moisture mitigation mate 61 and architectural drawings.	
Bid Item #10: Carpet, LVT, and Base Work	(add) \$
Performance & Payment Bond	(add) \$
Alternate No. 05: Unit D Reception Desk	
Base Bid: Bid Item #11 Casework Contractor to furr on Drawing A651 in their base bid.	aish and install Unit D reception desk per details
Alternate: Bid Item #11 Casework Contractor to furn per details on Drawing A652 in lieu of the desk show	
Bid Item #11: Manufactured Casework and Tops Wo	ork <u>(add)</u> \$
Performance & Payment Bond	(add) \$

### Alternate No. 06: Unit D Reception Bulkhead and Walls

Base Bid: All ceilings, walls, bulkheads, and wall coverings in Reception 312 per Drawings A201D, A210D, A801D, to be provided in base bid.

Alternate: Bid Item #06 Drywall Contractor shall deduct the metal stud walls from Reception 312 shown on Details 11 and 12 on A420. Walls to be built per Detail 3 on A201D. Bid Item #06 shall deduct bulkhead and install acoustical ceiling per Detail 3 on A210D. Bid Item #07 Painting Contractor

shall deduct painting the bulkhead and revise the paint and wall covering layout in Reception 312 per Details 3 on A210D and A801D.

Bid Item #06: Metal Stud, Drywall, Insulation, Acoustical Ceilings, and Sound Panel Work					
	(add/deduct) \$				
Performance & Payment Bond	(add/deduct) \$				
Bid Item #7: Painting and Wallcovering Work	(add/deduct) \$				
Performance & Payment Bond	(add/deduct) \$				

### **GENERAL INFORMATION:**

LEGAL NAME OF BIDDER:	
d/b/a NAME (if different):	
ADDRESS:	
FEDERAL ID NUMBER:	
PHONE (Office):	
PHONE (Mobile):	
FAX:	
E-MAIL ADDRESS:	
BY:	
PRINTED NAME:	
TITLE:	
DATE:	
Please provide the contact information for the project estimator responsible for preparing this bid.	
NAME:	
PHONE (Mobile):	
Each Contractor is also requested to submit the names of the proposed staff that would be assigned this project as well as a resume for each person.	to
Project Manager:	
Site Foreman/Superintendent:	

END OF SECTION

### **ADDENDUM**



ADDENDUM NO: 02

PROJECT: Sheridan HS & MS Renovation Project

PROJECT NO: 2024037 DATE: September 12, 2025 BY: Jack Leibham

This Addendum is issued in accordance with the provisions of "The General Conditions of the Contract for Construction," Article 1, "Contract Documents" and becomes a part of the Contract Documents as provided therein. This Addendum includes:

Addendum Pages:

### ADD2-1 through ADD2-5

Attached Documents: 08 71 00, 23 81 34

Attached Drawing Sheets: S401, AD201B, A201B, A210B, A290, A601, A800, A801A, A801B, PD201D, P201A,

P501, FP201D, ED201B, E201B, E201D, E211A, E211D, E601, TD201A, MD201D,

M301

### **PART 0 - GENERAL INFORMATION**

0.1 NOT USED

### **PART 1 - BIDDING REQUIREMENTS**

1.1 NOT USED

### **PART 2 - SPECIFICATIONS**

- 2.1 08 71 00 DOOR HARDWARE
  - A. Revise Hardware Group No. 33 as shown.
- 2.2 22 30 00 ELECTRIC DOMESTIC WATER HEATERS
  - A. Add Bock Water Heaters as an approved manufacturer.
- 2.3 23 73 12 MODULAR INDOOR AIR HANDLING UNITS
  - A. Add Dunham Bush as approved manufacturer.
- 2.4 <u>23 81 34 MINI-SPLIT AIR-CONDITIONING</u>
  - A. Add specification in full. See attached.
- 2.5 <u>SECTION 23 82 20 BLOWER COIL UNIT</u>



A. Add Daikin as approved manufacturer.

### **PART 3 - DRAWINGS**

### **STRUCTURAL**

### 3.1 <u>S401 – TYPICAL DETAILS</u>

A. Revise note for 14/S401 as shown.

### **ARCHITECTURAL**

### 3.2 <u>AD201B – GROUND FLOOR DEMOLITION PLAN – UNIT B</u>

- A. Add Demolition Note 59.
- B. Change Demolition Notes 1 to 59 where shown.

### 3.3 <u>A201B – GROUND FLOOR PLAN – UNIT B</u>

- A. Add Plan Note 14
- B. Add Plan Note 15.
- C. Add plan notes 14 and 15 to plan as shown.
- D. General note M changed to "NOT USED".

### 3.4 <u>A210B – GROUND FLOOR REFLECTED CEILING PLAN – UNIT B</u>

- A. Revise ceilings in Innovation Lab 125C as shown.
- B. Add RCP Note.
- C. Add detail 3/A210B.

### 3.5 <u>A290 – UNIT B - ALTERNATIVE SCHOOL – ALTERNATE #03</u>

A. Add note 15 to floor plan as shown.

### 3.6 <u>A601 – INTERIOR ELEVATIONS</u>

- A. Revised Elevation numbers.
- B. Add Elevation 6/A601.

### 3.7 <u>A800 – FINISH LEGEND</u>

A. Revised LVT to Existing Terrazzo transition strip.

### 3.8 <u>A801A – GROUND FLOOR FINISH PLAN – UNIT A</u>

- A. Add F16 to finish note list.
- B. Add F16 to plan as shown.

### 3.9 A801B – GROUND FLOOR FINISH PLAN – UNIT B

- A. Add Elevation 6/A601.
- B. Revised Elevation numbers.

### **PLUMBING**

### 3.10 PD201A - GROUND FLOOR PLAN - UNIT A - PLUMBING DEMOLITION

- A. Plan Note #13: REMOVE THERMOSTATIC MIXING VALVE AND PIPING COMPLETELY.
- B. Plan Note #13 refers to mixing valve in corridor wall. See attached sheet.

### 3.11 P201A – GROUND FLOOR PLAN – UNIT A – PLUMBING

- A. Change SK-3 to SK-4
- 3.12 P501 ISOMETRICS PLUMBING
  - A. Change SK-3 to SK-4 in detail E.
  - B. Change SK-3 to SK-4 in detail F.
  - C. Change SK-2 to SK-3 in detail L.

### **FIRE PROTECTION**

### 3.13 FP201D – GROUND FLOOR PLAN – UNIT D – FIRE PROTECTION

- A. Add plan note 3 to PRATICE ROOM 318C.
- B. Change plan note 3 from pendent sprinkler head to concealed style sprinkler head.

### **MECHANICAL**

### 3.14 MD201D – GROUND FLOOR PLAN – UNIT D – MECHANICAL DEMOLITION

- A. Plan Note #7: REMOVE VFD AND RETURN TO OWNER.
- B. Plan Note #7 applies to AHU-2 VFD located in Mechanical Room. See attached sheet.

### 3.15 <u>M301 – ENLARGED PLANS – MECHANICAL</u>



A. Drawing now shows location of existing AHU-2 TCP where new controls for new AHU-MS-2025 can be installed. See attached sheet.

### **ELECTRICAL**

3.16	ED201A -	<b>GROUND</b>	FLOOR	PLAN -	UNIT A -	<b>ELECTRICAL</b>	DEMOLITION

- A. Edited Plan Notes on Drawing.
- B. This drawing is to be reissued in its entirety.

### 3.17 <u>ED201B – GROUND FLOOR PLAN - UNIT B – ELECTRICAL DEMOLITION</u>

- A. Added Plan Note 4.
- B. This drawing is to be reissued in its entirety.

### 3.18 <u>E201B – GROUND FLOOR PLAN - UNIT B – LIGHTING</u>

- A. Lighting Fixture Type changes.
- B. This drawing is to be reissued in its entirety.

### 3.19 <u>E201D – GROUND FLOOR PLAN - UNIT D – LIGHTING</u>

- A. Exit Light Fixture Type change.
- B. This drawing is to be reissued in its entirety.

### 3.20 E211A – GROUND FLOOR PLAN - UNIT A – POWER AND SIGNAL

- A. Circuit Number added for RR-161, RR-162 and water cooler.
- B. This drawing is to be reissued in its entirety.

### 3.21 <u>E211D – GROUND FLOOR PLAN - UNIT D – POWER AND SIGNAL</u>

- A. Edited circuit number on drawing.
- B. Edited Plan Note 4.
- C. This drawing is to be reissued in its entirety.

### 3.22 <u>E601 – SCHEDULES - ELECTRICAL</u>

- A. Edited INTERIOR LIGHT FIXTURE SCHEDULE.
- B. This drawing is to be reissued in its entirety.



### **TELECOM**

### 3.23 TD201A – GROUND FLOOR PLAN – UNIT A – TELECOM DEMOLITION

A. Plan Note #3: REMOVE TELECOM ENCLOSURE AND WIRING IN WALL COMPLETELY. CONTRACTOR TO VERIFY IF ANY WIRING IS ACTIVE BEFORE DEMOLITION. REROUTE ACTIVE WIRING.

### **PART 4 - OTHER ITEMS**

4.1 NOT USED

### **PART 5 - QUESTIONS AND ANSWERS**

5.1 <u>NOT USED</u>

### **END ADDENDUM #2**

### 133985 OPT0427946

### V1 6/4/2025 vs. V2 9/11/2025

Hardware Group No. 33

For use on Door #(s):

318-1

### Provide each OPENING with the following:

QTY		DESCRIPTION	CATALOG NUMBER	FINISH	MFR
3	EA	HINGE	5BB1HW SIZE, QTY, NRP AS REQ'D (SEE SPECS)	652	IVE
1	EA	PANIC HARDWARE	LD-9975-L-2-06	626	VON
1	EA	RIM CYLINDER	1E72	626	BES
1	EA	MORTISE CYLINDER	1E74	626	BES
<u>1</u>	<u>EA</u>	SURFACE CLOSER	4040XP EDA	<u>689</u>	<b>LCN</b>
1	EA	KICK PLATE	8400 10"H X WIDTH AS REQ'D B- CS	630	IVE
1	EA	WALL STOP/HOLDER	WS40/WS40X	626	IVE
1	SET	SOUND SEAL	328AA-S	AA	ZER
1	EA	AUTO DOOR BOTTOM	364AA	AA	ZER
1	EA	THRESHOLD, 1/4"	545A	Α	ZER
1	EA	SOUND SEAL MTG BRACKET	328SPB		ZER

### PART 1 – GENERAL

### 1.1 SYSTEM DESCRIPTION

- A. The variable capacity, mini (heat and cool model) split system shall be as specified.
- B. The outdoor unit shall be interconnected to indoor units and shall be of capacity as noted on Drawings. The indoor units shall be connected to the outdoor utilizing the manufacturer's specified piping joints and headers.
- C. Voltage Platform as noted on Drawings.
- D. Simple Wiring Systems shall use 16 AWG, 2 wire, multi-stranded, non-shielded and non-polarized daisy chain control wiring.
- E. Outside Air Systems shall accept outside air as shown on drawings.
- F. Controls Each device shall be provided with complete factory controls that communicate with each other.

### 1.2 SUBMITTALS

- A. Product Data: Include manufacturer's technical data for each ductless split system, including rated capacities, dimensions, required clearances, characteristics, furnished specialties, and accessories.
- B. Shop Drawings: Detail equipment assemblies and indicate dimensions, weights, loads, required clearances, method of field assembly, components, and location and size of each field connection.
  - 1. Wiring Diagrams: Power, signal, and control wiring.
- C. Operation and maintenance data.
- D. Warranty.

### 1.3 QUALITY ASSURANCE

- A. The units shall be listed by Electrical Laboratories (ETL) and bear the cETL label.
- B. All wiring shall be in accordance with the National Electric Code (NEC).

- C. The system will be produced in an ISO 9001 and ISO 14001 facility, which are standards set by the International Standard Organization (ISO). The system shall be factory tested for safety and function.
- D. The outdoor unit will be factory charged with R-410A.

### 1.4 WARRANTY

A. The units shall have a manufacturer's warranty for a period of one (1) year from date of substantial completion. The compressors shall have a complete parts and labor warranty of six (6) years from date of substantial completion. During the stated period, should any part fail due to defects in material and workmanship, it shall be repaired or replaced. All warranty service work shall be performed by a factory trained service professional.

### 1.5 OPERATING RANGE

A. The unit startup and operating range in cooling will be -10°F DB ~ 110°F DB.

### PART 2 - PRODUCTS

### 2.1 ACCEPTABLE MANUFACTURERS

- A. Trane / Mitsubishi.
- B. Fujitsu.
- C. Samsung.
- D. Hitachi
- E. Daikin

### 2.2 OUTDOOR UNIT

- A. General: The outdoor unit is designed specifically for use as a complete system with indoor components.
  - 1. The outdoor unit shall be factory assembled and pre-wired with all necessary electronic and refrigerant controls.
  - 2. The sound pressure level standard shall be that value as listed at 3 feet from the front of the unit. The outdoor unit shall be capable of operating automatically at further reduced noise during nighttime.
  - 3. The system will automatically restart operation after a power failure and will not cause any settings to be lost, thus eliminating the need for reprogramming.
  - 4. The unit shall incorporate an auto-charging feature and a refrigerant charge check function.

- 5. The outdoor unit shall be modular in design and should allow for side-by-side installation with minimum spacing.
- 6. The following safety devices shall be included on the condensing unit; high pressure switch, control circuit fuses, crankcase heaters, fusible plug, high pressure switch, overload relay, inverter overload protector, thermal protectors for compressor and fan motors, over current protection for the inverter and anti-recycling timers.
- 7. Provide all low ambient controls, baffles, and accessories as required to meet the required operational range.

### B. Unit Cabinet:

1. The outdoor unit shall be completely weatherproof and corrosion resistant. The unit shall be constructed from rust-proofed mild steel panels coated with a baked enamel finish.

### C. Compressor:

 The inverter scroll compressors shall be variable speed (PAM inverter) controlled which is capable of changing the speed to follow the variations in total cooling and heating load as determined by the suction gas pressure as measured in the condensing unit.

### D. Electrical:

- 1. The power supply to the outdoor unit shall be as noted on Drawings. Wiring, conduit, and power from the outdoor unit shall be extended to the respective indoor unit, as required on the mfg's wiring diagram.
- 2. The control voltage between the indoor and outdoor unit shall be 16VDC non-shielded, stranded 2 conductor cable.
- 3. The control wiring shall be a two-wire multiplex transmission system, making it possible to connect multiple indoor units to one outdoor unit with one 2-cable wire, thus simplifying the wiring operation.

### E. ACCU Roof Equipment Support Stand

- 1. Provide roof equipment support stand suitable for size and loading of the condensing unit.
- 2. Designed to support Mini-Split condenser units.
- 3. Designed for height, width, and span adjustability for a wide range of Mini-Split Units.
- 4. Frame material is 14 gauge Hilti Channel (7/8×1-5/8) with a zinc-magnesium finish for outdoor use.
- 5. Base material is polycarbonate with carbon black for UV resistance.
- 6. Hardware and brackets are either hot-dip galvanized or electro-galvanized
- 7. Support is designed for gravity loading. Additional wind and/or seismic tie downs and engineering provided upon request.
- 8. Optimized load of 3.0 PSI to roof is approximately 300LBS. Ultimate load capacity is not tested
- 9. Miro Industries Uniflex MiniSplit Rail Support or equal.

### 2.3 MINI-SPLIT – FAN COILS

### A. Ceiling Suspended Cassette Unit

- 1. General: Indoor unit shall be a ceiling suspended cassette style unit, operable with refrigerant R-410A, equipped with an electronic expansion valve, for installation onto a wall or ceiling within a conditioned space and have a finished white casing.
- 2. Indoor Unit:
  - a. Indoor unit shall be completely factory assembled and tested. Included in the unit is factory wiring, piping, electronic proportional expansion valve, control circuit board, fan motor thermal protector, flare connections, condensate drain pan, self-diagnostics, auto-restart function, 3-minute fused time delay, and test run switch. The unit shall have an auto-swing louver which ensures efficient air distribution, which closes automatically when the unit stops. The remote controller shall be able to set five (5) steps of discharge angle. The front grille shall be easily removed for washing. The discharge angle shall automatically set at the same angle as the previous operation upon restart. The drainpipe can be fitted to from the rear, top or left and right sides of the unit.
  - b. Indoor unit and refrigerant pipes will be charged with dehydrated air prior to shipment from the factory.
  - c. Both refrigerant lines shall be insulated from the outdoor unit.
  - d. Return air shall be through a resin net mold resistant filter.
  - e. The indoor units shall be equipped with a condensate pan.
  - f. The indoor units shall be equipped with a return air thermistor.

### 3. Unit Cabinet:

- a. The cabinet shall be affixed to a factory supplied wall/ceiling hanging brackets and located in the conditioned space.
- b. The cabinet shall be constructed with sound absorbing foamed polystyrene and polyethylene insulation.

### 4. Coil:

- a. Coils shall be of the direct expansion type constructed from copper tubes expanded into aluminum fins to form a mechanical bond.
- b. The coil shall be of a waffle louver fin and high heat exchange, rifled bore tube design to ensure highly efficient performance.
- c. The coil shall be a 2-row cross fin copper evaporator coil with 15 fpi design completely factory tested.
- d. A thermistor will be located on the liquid and gas line.
- e. A condensate pan shall be located in the unit.

### 5. Electrical:

a. Unit power to be obtained from respective outdoor unit.

### B. Wall-Mounted Indoor Unit

1. General: Indoor unit shall be a wall-mounted unit, operable with refrigerant R-410A, equipped with an electronic expansion valve, for installation onto a wall within a conditioned space and have a finished white casing.

### 2. Indoor Unit:

- a. Indoor unit shall be completely factory assembled and tested. Included in the unit is factory wiring, piping, electronic proportional expansion valve, control circuit board, fan motor thermal protector, flare connections, condensate drain pan, self-diagnostics, auto-restart function, 3-minute fused time delay, and test run switch. The unit shall have an auto-swing louver which ensures efficient air distribution, which closes automatically when the unit stops. The remote controller shall be able to set five (5) steps of discharge angle. The front grille shall be easily removed for washing. The discharge angle shall automatically set at the same angle as the previous operation upon restart. The drainpipe can be fitted to from the rear, top or left and right sides of the unit.
- b. Indoor unit and refrigerant pipes will be charged with dehydrated air prior to shipment from the factory.
- c. Both refrigerant lines shall be insulated from the outdoor unit.
- d. Return air shall be through a resin net mold resistant filter.
- e. The indoor units shall be equipped with a condensate pan.
- f. The indoor units shall be equipped with a return air thermistor.

### Unit Cabinet:

- a. The cabinet shall be affixed to a factory supplied wall hanging brackets and located in the conditioned space.
- b. The cabinet shall be constructed with sound absorbing foamed polystyrene and polyethylene insulation.

### 4. Coil:

- a. Coils shall be of the direct expansion type constructed from copper tubes expanded into aluminum fins to form a mechanical bond.
- b. The coil shall be of a waffle louver fin and high heat exchange, rifled bore tube design to ensure highly efficient performance.
- c. The coil shall be a 2-row cross fin copper evaporator coil with 15 fpi design completely factory tested.
- d. A thermistor will be located on the liquid and gas line.
- e. A condensate pan shall be located in the unit.

### 5. Electrical:

a. Unit power to be obtained from respective outdoor unit.

### PART 3 - EXECUTION


### 3.1 INSTALLATION REQUIREMENTS

A. The system must be installed by a factory trained contractor/dealer. The bidders shall be required to submit training certification proof with bid documents. The mechanical contractor's installation price shall be based on the systems installation requirements. The mechanical contractor bids with complete knowledge of the HVAC system requirements.

### 3.2 DEMONSTRATION/OWNER TRAINING

A. The mini-split system manufacturer shall provide two (2) hours of on-site training to the Owner's maintenance personnel in the proper operation and care of the entire system.

END OF SECTION 23 81 34

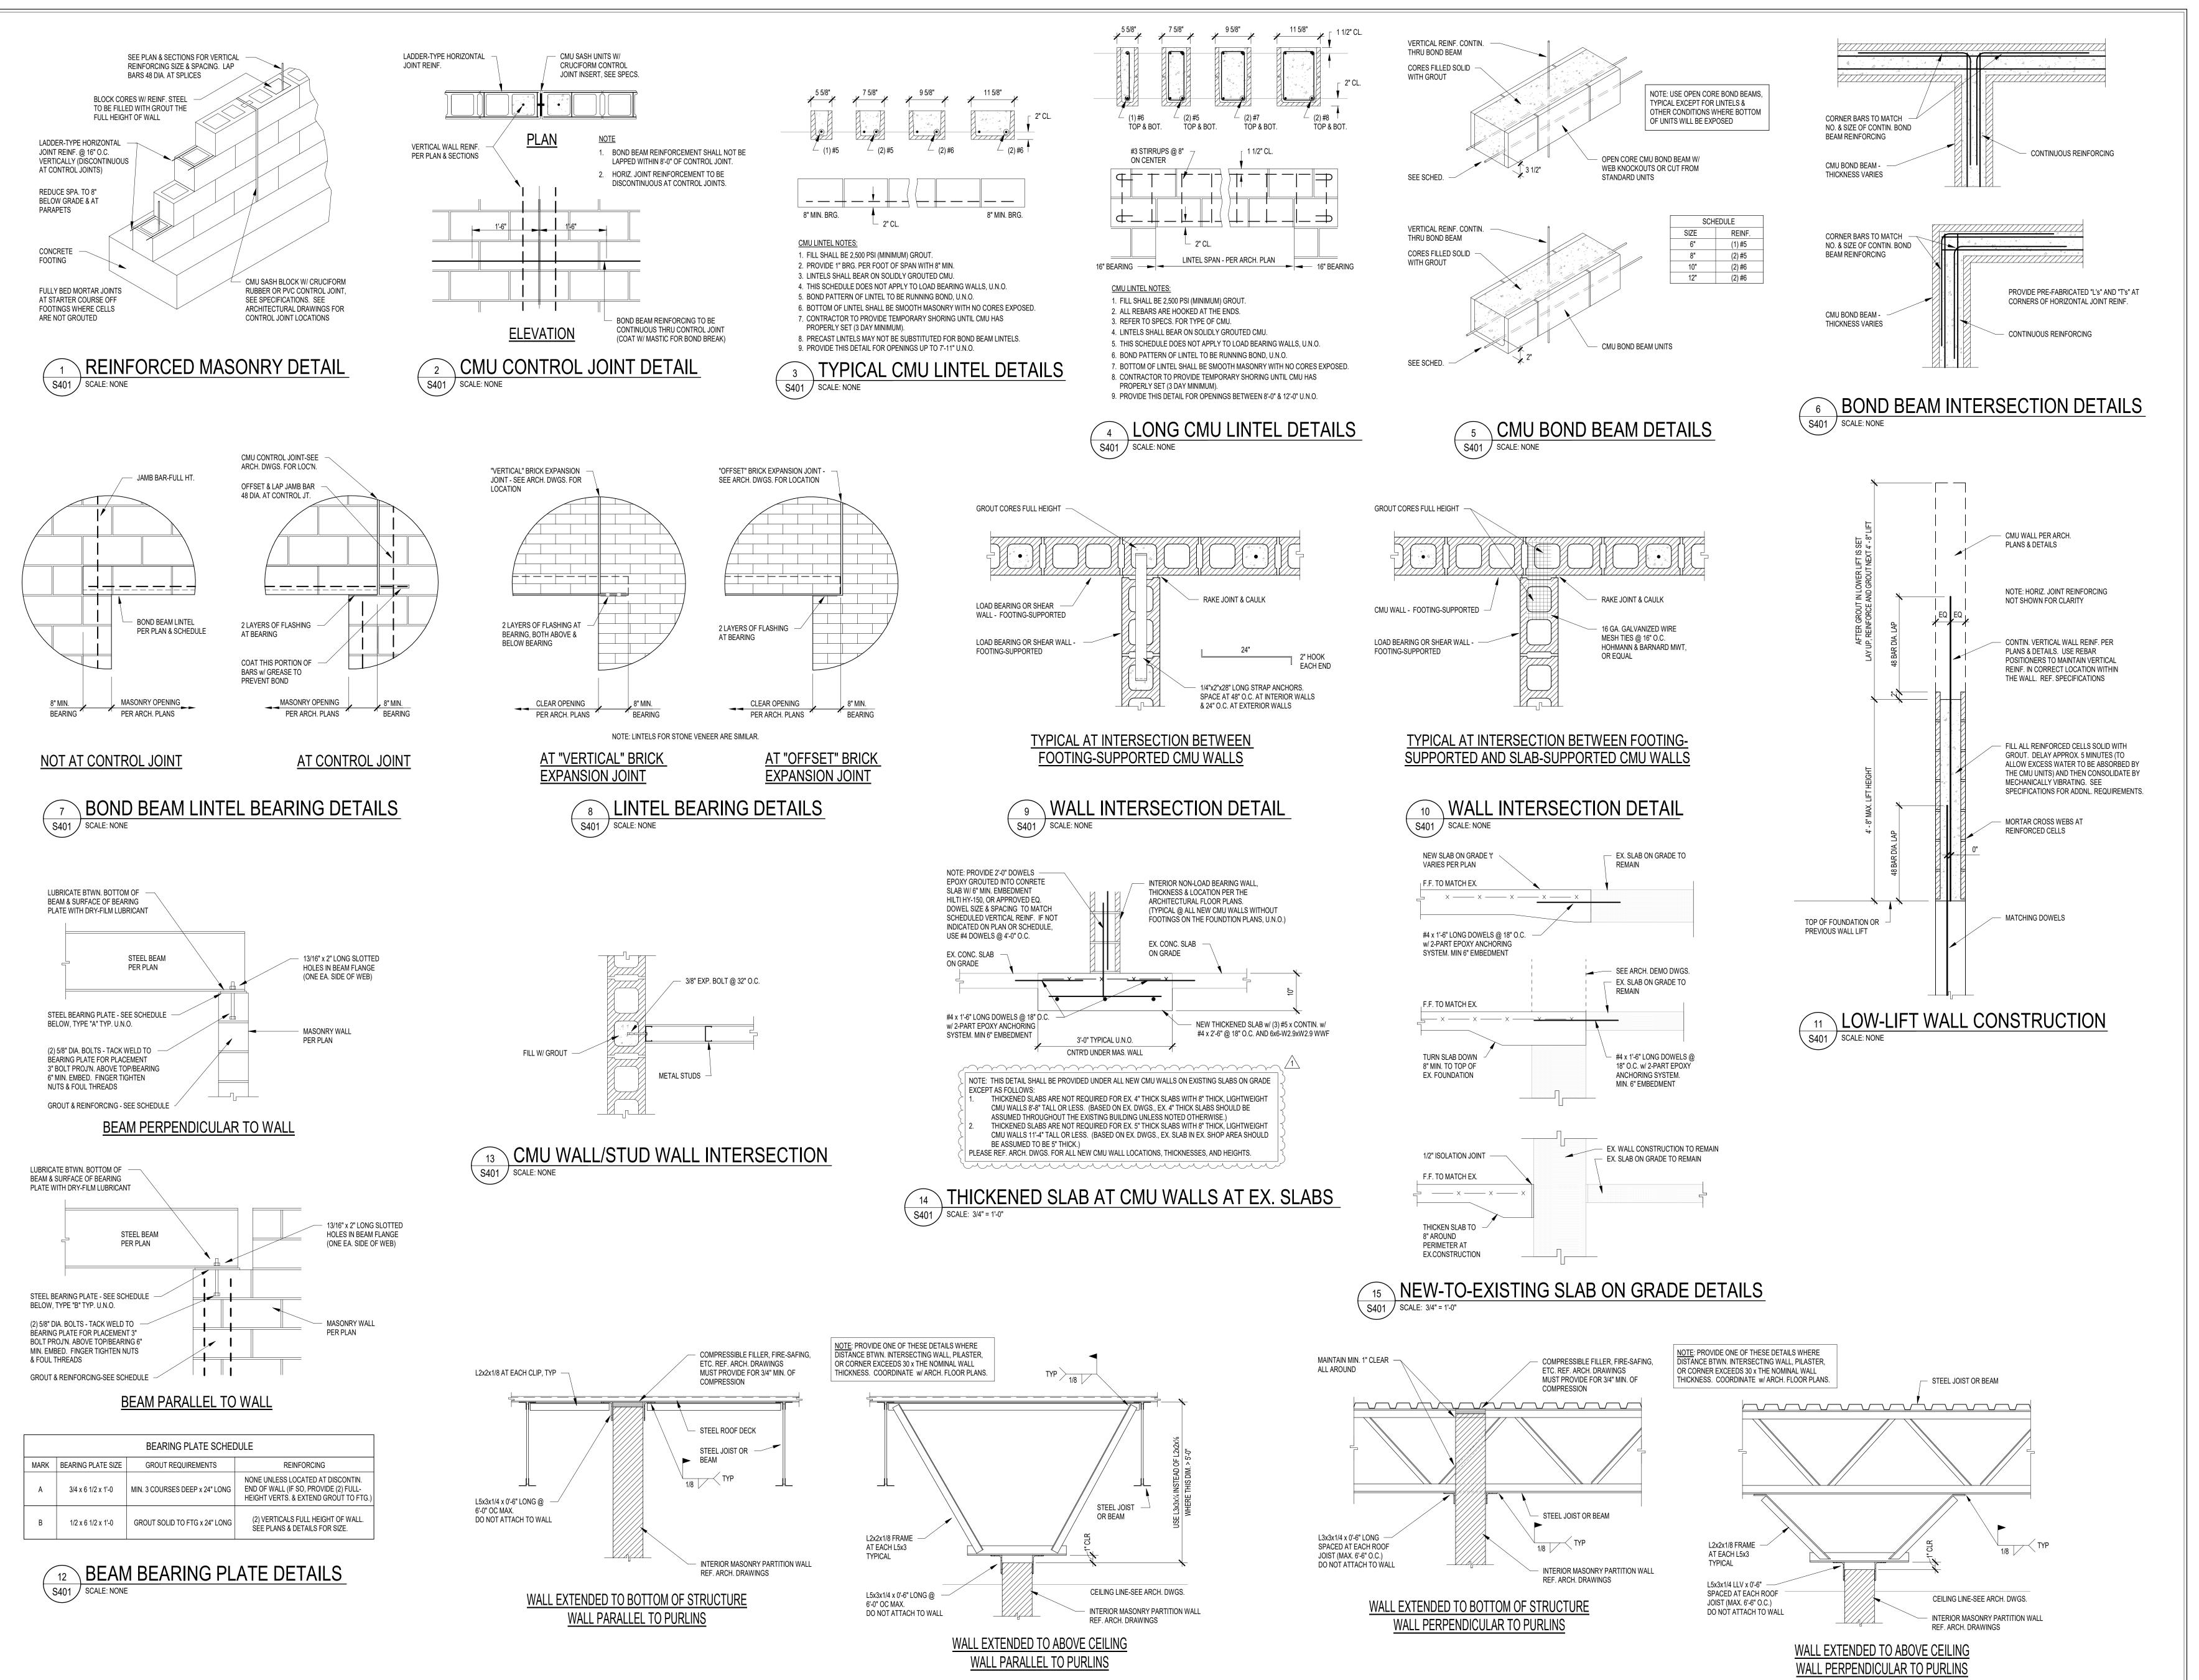

16 CMU PARTITION BRACING DETAILS - PARALLEL TO PURLINS

S401 SCALE: 3/4" = 1'-0"

COMMUNITY SCHOOL

**S831** Keystone Crossing, Indianapolis, IN 46240 317.848.7800 | csoinc.net

Lynch,
Harrison &
Harrison &
Brumleve,
Inc.
P 317.423.1550
is, IN 46203
F 317.423.1551

SHERIDAN COMMUNITY SCHOOLS
HIGH SCHOOL & MIDDLE SCHOOL
RENOVATION PROJECT
00% CONSTRUCTION DOCUMENTS

SCOPE DRAWINGS:
These drawings indicate the general scope of the project in terms of architectural design concept, the dimensions of the building, the major architectural elements and the type of structural, mechanical and electrical systems.
The drawings do not necessarily indicate or describe all work required for full performance and completion of the requirements of the Contract.
On the basis of the general scope indicated or described, the trade contractors shall furnish all items required for the proper execution and completion of the work.

REVISIONS:
Addendum #2 9/12/2025

ISSUE DATE | DRAWN BY | CHECKED BY

08/15/2025 MDL MDL

DRAWING TITLE:

TYPICAL DETAILS

CERTIFIED BY:

PE19400114

STATE OF

WOJANA

WOJANA

ONAL

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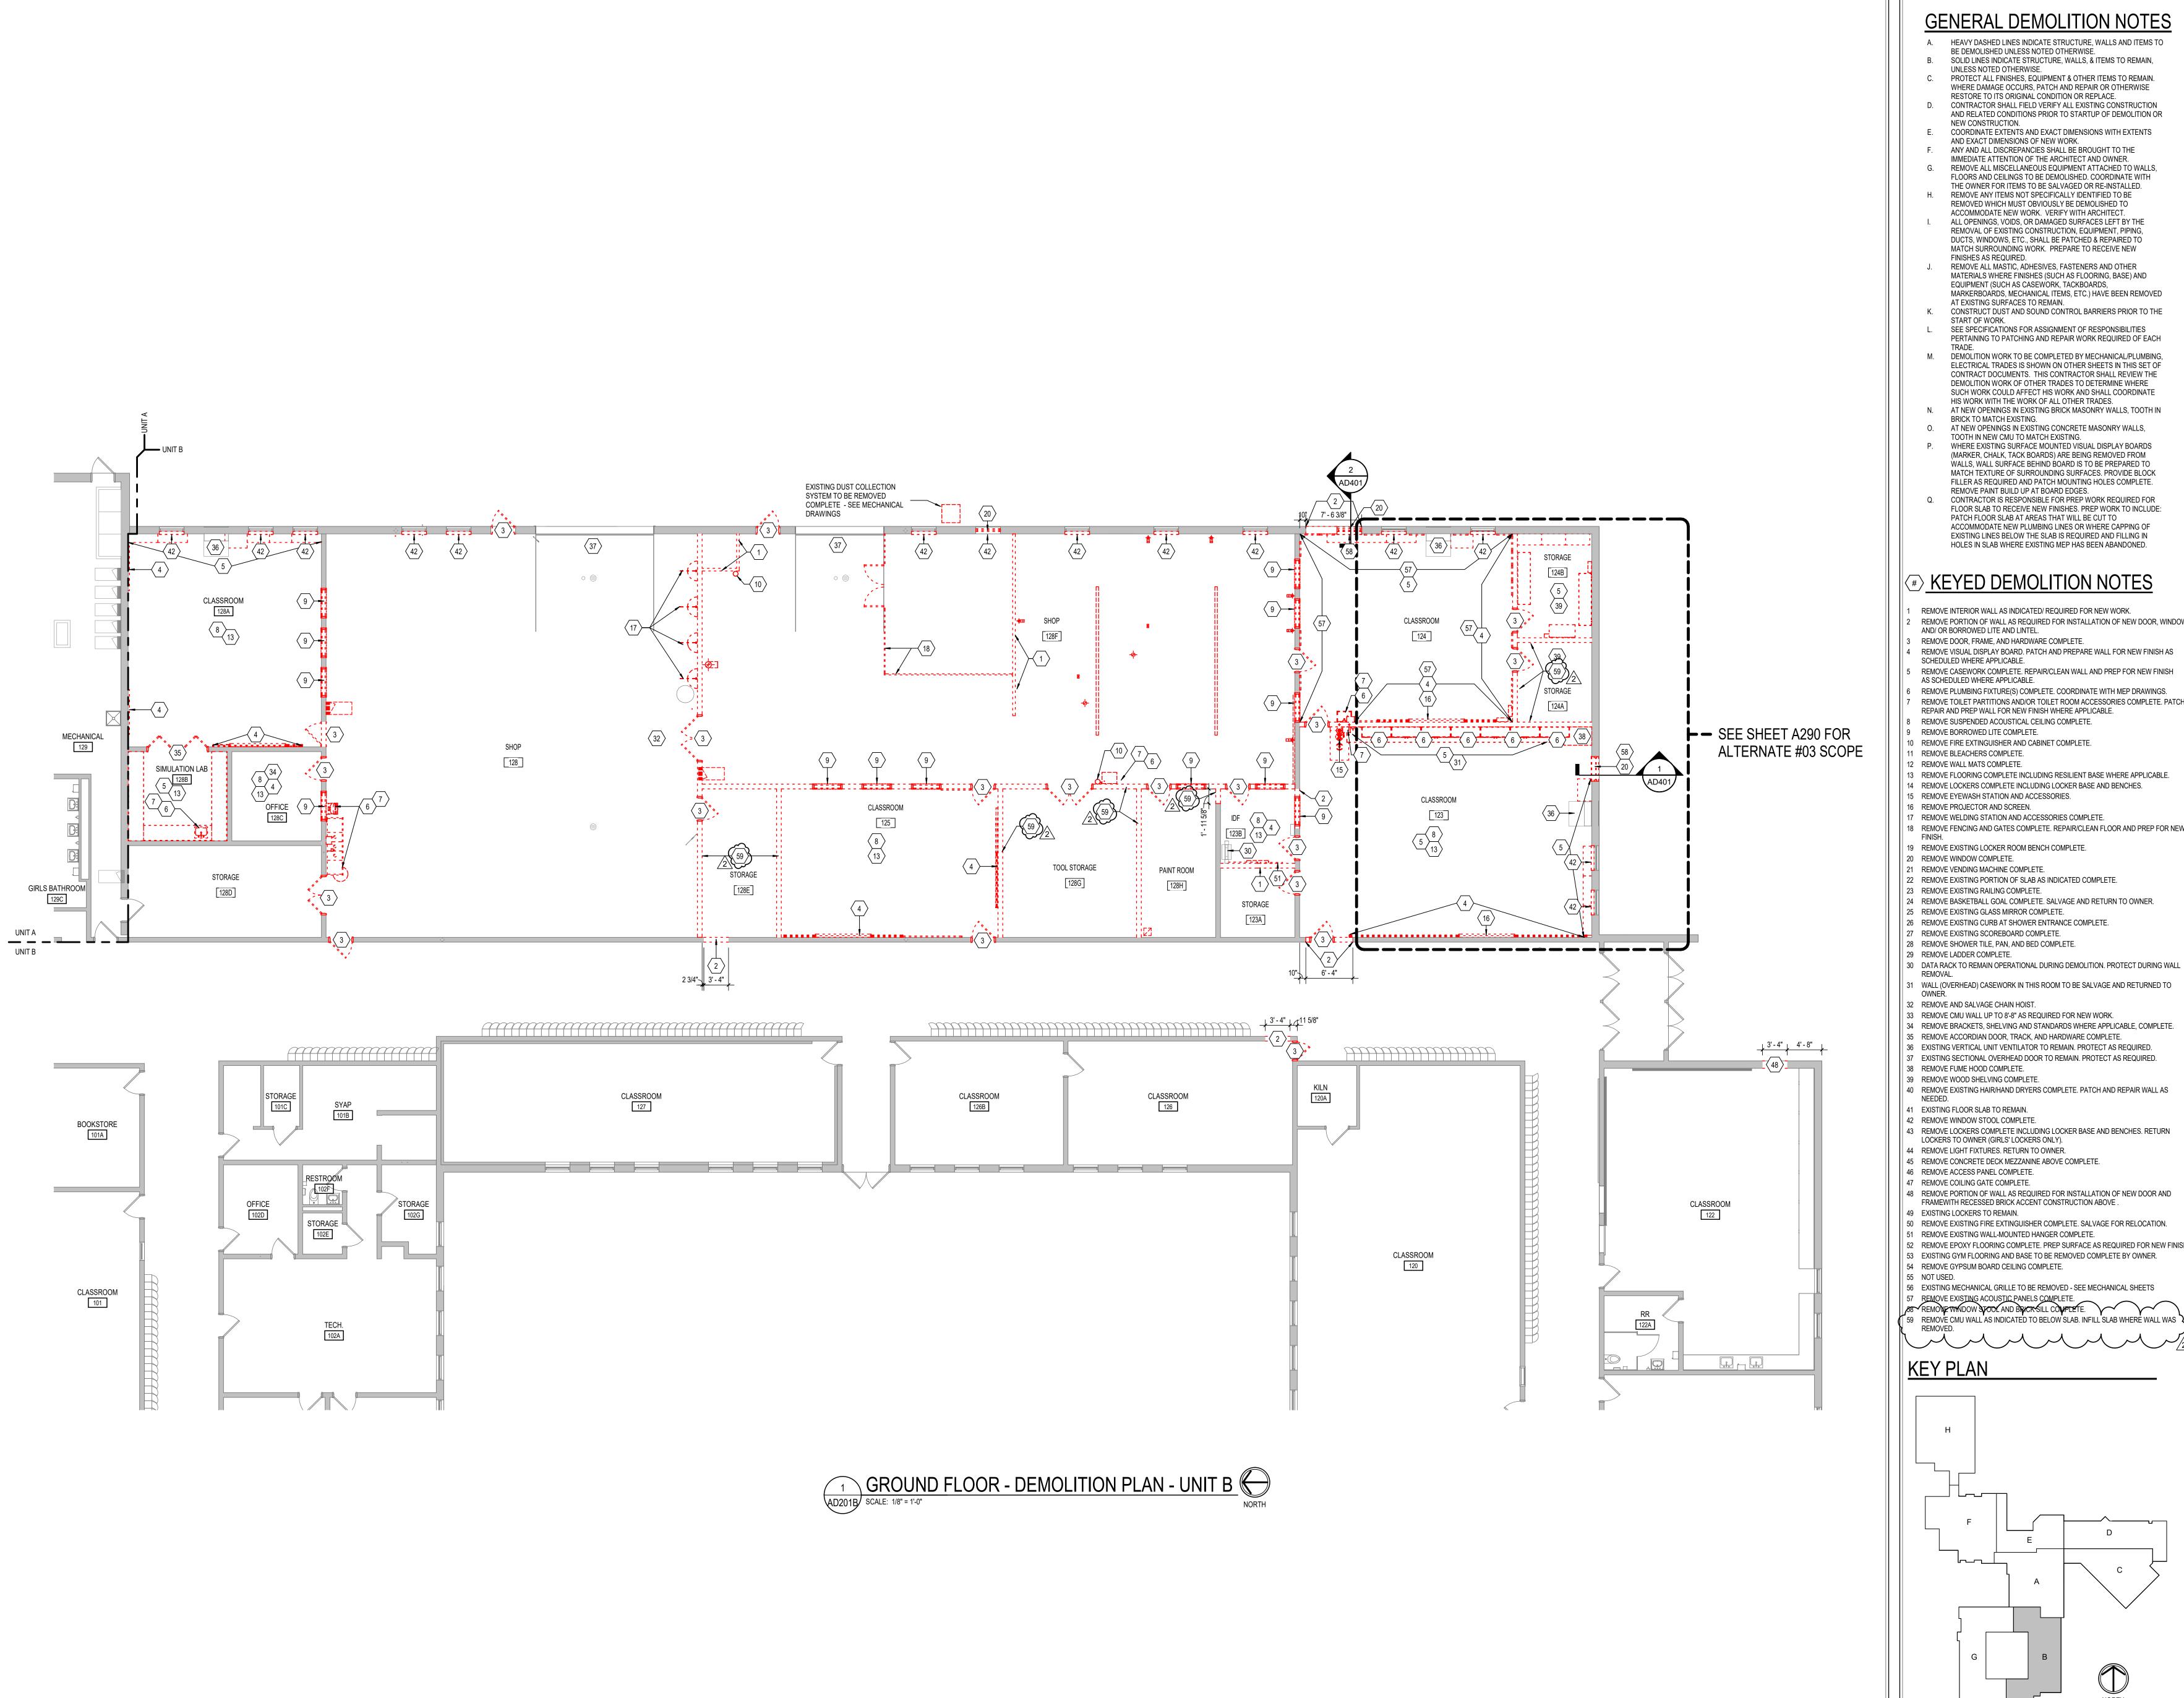
ONAL

S401

PROJECT NUMBER 2024037

CMU PARTITION BRACING DETAILS - PERPENDICULAR TO PURLINS

S401 SCALE: 3/4" = 1'-0"




## GENERAL DEMOLITION NOTES

- A. HEAVY DASHED LINES INDICATE STRUCTURE, WALLS AND ITEMS TO BE DEMOLISHED UNLESS NOTED OTHERWISE.
- B. SOLID LINES INDICATE STRUCTURE, WALLS, & ITEMS TO REMAIN,
- C. PROTECT ALL FINISHES, EQUIPMENT & OTHER ITEMS TO REMAIN. WHERE DAMAGE OCCURS, PATCH AND REPAIR OR OTHERWISE
- RESTORE TO ITS ORIGINAL CONDITION OR REPLACE. D. CONTRACTOR SHALL FIELD VERIFY ALL EXISTING CONSTRUCTION
- AND RELATED CONDITIONS PRIOR TO STARTUP OF DEMOLITION OR NEW CONSTRUCTION.
- E. COORDINATE EXTENTS AND EXACT DIMENSIONS WITH EXTENTS AND EXACT DIMENSIONS OF NEW WORK.
- F. ANY AND ALL DISCREPANCIES SHALL BE BROUGHT TO THE IMMEDIATE ATTENTION OF THE ARCHITECT AND OWNER.
- G. REMOVE ALL MISCELLANEOUS EQUIPMENT ATTACHED TO WALLS, FLOORS AND CEILINGS TO BE DEMOLISHED. COORDINATE WITH THE OWNER FOR ITEMS TO BE SALVAGED OR RE-INSTALLED.
- ACCOMMODATE NEW WORK. VERIFY WITH ARCHITECT. ALL OPENINGS, VOIDS, OR DAMAGED SURFACES LEFT BY THE REMOVAL OF EXISTING CONSTRUCTION, EQUIPMENT, PIPING, DUCTS, WINDOWS, ETC., SHALL BE PATCHED & REPAIRED TO MATCH SURROUNDING WORK. PREPARE TO RECEIVE NEW
- REMOVE ALL MASTIC, ADHESIVES, FASTENERS AND OTHER MATERIALS WHERE FINISHES (SUCH AS FLOORING, BASE) AND EQUIPMENT (SUCH AS CASEWORK, TACKBOARDS, MARKERBOARDS, MECHANICAL ITEMS, ETC.) HAVE BEEN REMOVED
- AT EXISTING SURFACES TO REMAIN. K. CONSTRUCT DUST AND SOUND CONTROL BARRIERS PRIOR TO THE START OF WORK. SEE SPECIFICATIONS FOR ASSIGNMENT OF RESPONSIBILITIES
- PERTAINING TO PATCHING AND REPAIR WORK REQUIRED OF EACH M. DEMOLITION WORK TO BE COMPLETED BY MECHANICAL/PLUMBING, ELECTRICAL TRADES IS SHOWN ON OTHER SHEETS IN THIS SET OF
- DEMOLITION WORK OF OTHER TRADES TO DETERMINE WHERE SUCH WORK COULD AFFECT HIS WORK AND SHALL COORDINATE HIS WORK WITH THE WORK OF ALL OTHER TRADES. N. AT NEW OPENINGS IN EXISTING BRICK MASONRY WALLS, TOOTH IN
- BRICK TO MATCH EXISTING. O. AT NEW OPENINGS IN EXISTING CONCRETE MASONRY WALLS,
- TOOTH IN NEW CMU TO MATCH EXISTING. WHERE EXISTING SURFACE MOUNTED VISUAL DISPLAY BOARDS (MARKER, CHALK, TACK BOARDS) ARE BEING REMOVED FROM WALLS, WALL SURFACE BEHIND BOARD IS TO BE PREPARED TO MATCH TEXTURE OF SURROUNDING SURFACES. PROVIDE BLOCK
- CONTRACTOR IS RESPONSIBLE FOR PREP WORK REQUIRED FOR FLOOR SLAB TO RECEIVE NEW FINISHES. PREP WORK TO INCLUDE: PATCH FLOOR SLAB AT AREAS THAT WILL BE CUT TO ACCOMMODATE NEW PLUMBING LINES OR WHERE CAPPING OF EXISTING LINES BELOW THE SLAB IS REQUIRED AND FILLING IN HOLES IN SLAB WHERE EXISTING MEP HAS BEEN ABANDONED.

## **#** KEYED DEMOLITION NOTES

- REMOVE INTERIOR WALL AS INDICATED/ REQUIRED FOR NEW WORK. REMOVE PORTION OF WALL AS REQUIRED FOR INSTALLATION OF NEW DOOR, WINDOW,
- REMOVE DOOR, FRAME, AND HARDWARE COMPLETE.
- REMOVE VISUAL DISPLAY BOARD. PATCH AND PREPARE WALL FOR NEW FINISH AS SCHEDULED WHERE APPLICABLE.
- REMOVE CASEWORK COMPLETE. REPAIR/CLEAN WALL AND PREP FOR NEW FINISH AS SCHEDULED WHERE APPLICABLE.
- REMOVE PLUMBING FIXTURE(S) COMPLETE. COORDINATE WITH MEP DRAWINGS. REMOVE TOILET PARTITIONS AND/OR TOILET ROOM ACCESSORIES COMPLETE. PATCH,
- REPAIR AND PREP WALL FOR NEW FINISH WHERE APPLICABLE. REMOVE SUSPENDED ACOUSTICAL CEILING COMPLETE.
- REMOVE BORROWED LITE COMPLETE.
- 10 REMOVE FIRE EXTINGUISHER AND CABINET COMPLETE.
- 3 REMOVE FLOORING COMPLETE INCLUDING RESILIENT BASE WHERE APPLICABLE.
- 14 REMOVE LOCKERS COMPLETE INCLUDING LOCKER BASE AND BENCHES. 15 REMOVE EYEWASH STATION AND ACCESSORIES.
- 16 REMOVE PROJECTOR AND SCREEN.
- 18 REMOVE FENCING AND GATES COMPLETE. REPAIR/CLEAN FLOOR AND PREP FOR NEW
- 19 REMOVE EXISTING LOCKER ROOM BENCH COMPLETE.
- 22 REMOVE EXISTING PORTION OF SLAB AS INDICATED COMPLETE.
- 24 REMOVE BASKETBALL GOAL COMPLETE. SALVAGE AND RETURN TO OWNER.
- 25 REMOVE EXISTING GLASS MIRROR COMPLETE. 26 REMOVE EXISTING CURB AT SHOWER ENTRANCE COMPLETE.
- 27 REMOVE EXISTING SCOREBOARD COMPLETE. 28 REMOVE SHOWER TILE, PAN, AND BED COMPLETE.
- 31 WALL (OVERHEAD) CASEWORK IN THIS ROOM TO BE SALVAGE AND RETURNED TO
- 33 REMOVE CMU WALL UP TO 8'-8" AS REQUIRED FOR NEW WORK.
- 34 REMOVE BRACKETS, SHELVING AND STANDARDS WHERE APPLICABLE, COMPLETE. 35 REMOVE ACCORDIAN DOOR, TRACK, AND HARDWARE COMPLETE.
- 36 EXISTING VERTICAL UNIT VENTILATOR TO REMAIN. PROTECT AS REQUIRED. 37 EXISTING SECTIONAL OVERHEAD DOOR TO REMAIN. PROTECT AS REQUIRED.
- 38 REMOVE FUME HOOD COMPLETE.
- 39 REMOVE WOOD SHELVING COMPLETE. 40 REMOVE EXISTING HAIR/HAND DRYERS COMPLETE. PATCH AND REPAIR WALL AS
- 42 REMOVE WINDOW STOOL COMPLETE.
- 43 REMOVE LOCKERS COMPLETE INCLUDING LOCKER BASE AND BENCHES. RETURN LOCKERS TO OWNER (GIRLS' LOCKERS ONLY).
- 44 REMOVE LIGHT FIXTURES. RETURN TO OWNER. 45 REMOVE CONCRETE DECK MEZZANINE ABOVE COMPLETE.
- 46 REMOVE ACCESS PANEL COMPLETE.
- FRAMEWITH RECESSED BRICK ACCENT CONSTRUCTION ABOVE .
- 50 REMOVE EXISTING FIRE EXTINGUISHER COMPLETE. SALVAGE FOR RELOCATION.
- 52 REMOVE EPOXY FLOORING COMPLETE. PREP SURFACE AS REQUIRED FOR NEW FINISH. 53 EXISTING GYM FLOORING AND BASE TO BE REMOVED COMPLETE BY OWNER.
- 54 REMOVE GYPSUM BOARD CEILING COMPLETE.
- | 56 EXISTING MECHANICAL GRILLE TO BE REMOVED SEE MECHANICAL SHEETS 57 REMOVE EXISTING ACOUSTIC PANELS COMPLETE.



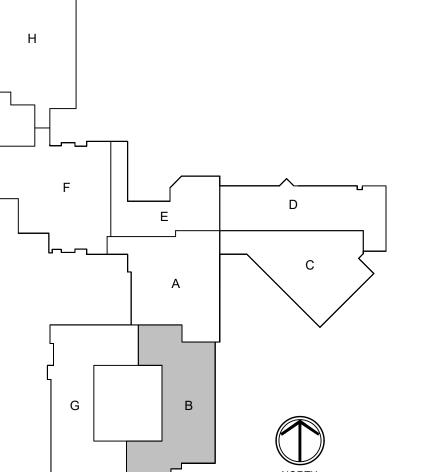



SCOPE DRAWINGS:
These drawings indicate the general scope of the project in terms of architectural design concept, the dimensions of he building, the major architectural elements and the type of structural mechanical and electrical systems. the trade contractors shall furnish all items required for the proper execution and completion of the work.

# REVISIONS:


ADDENDUM #02 09-12-2025

ISSUE DATE | DRAWN BY | CHECKED BY 08/15/2025

DRAWING TITLE: GROUND FLOOR PLAN - UNIT B

> CERTIFIED BY: No. AR10800070

AD201B PROJECT NUMBER 2024037

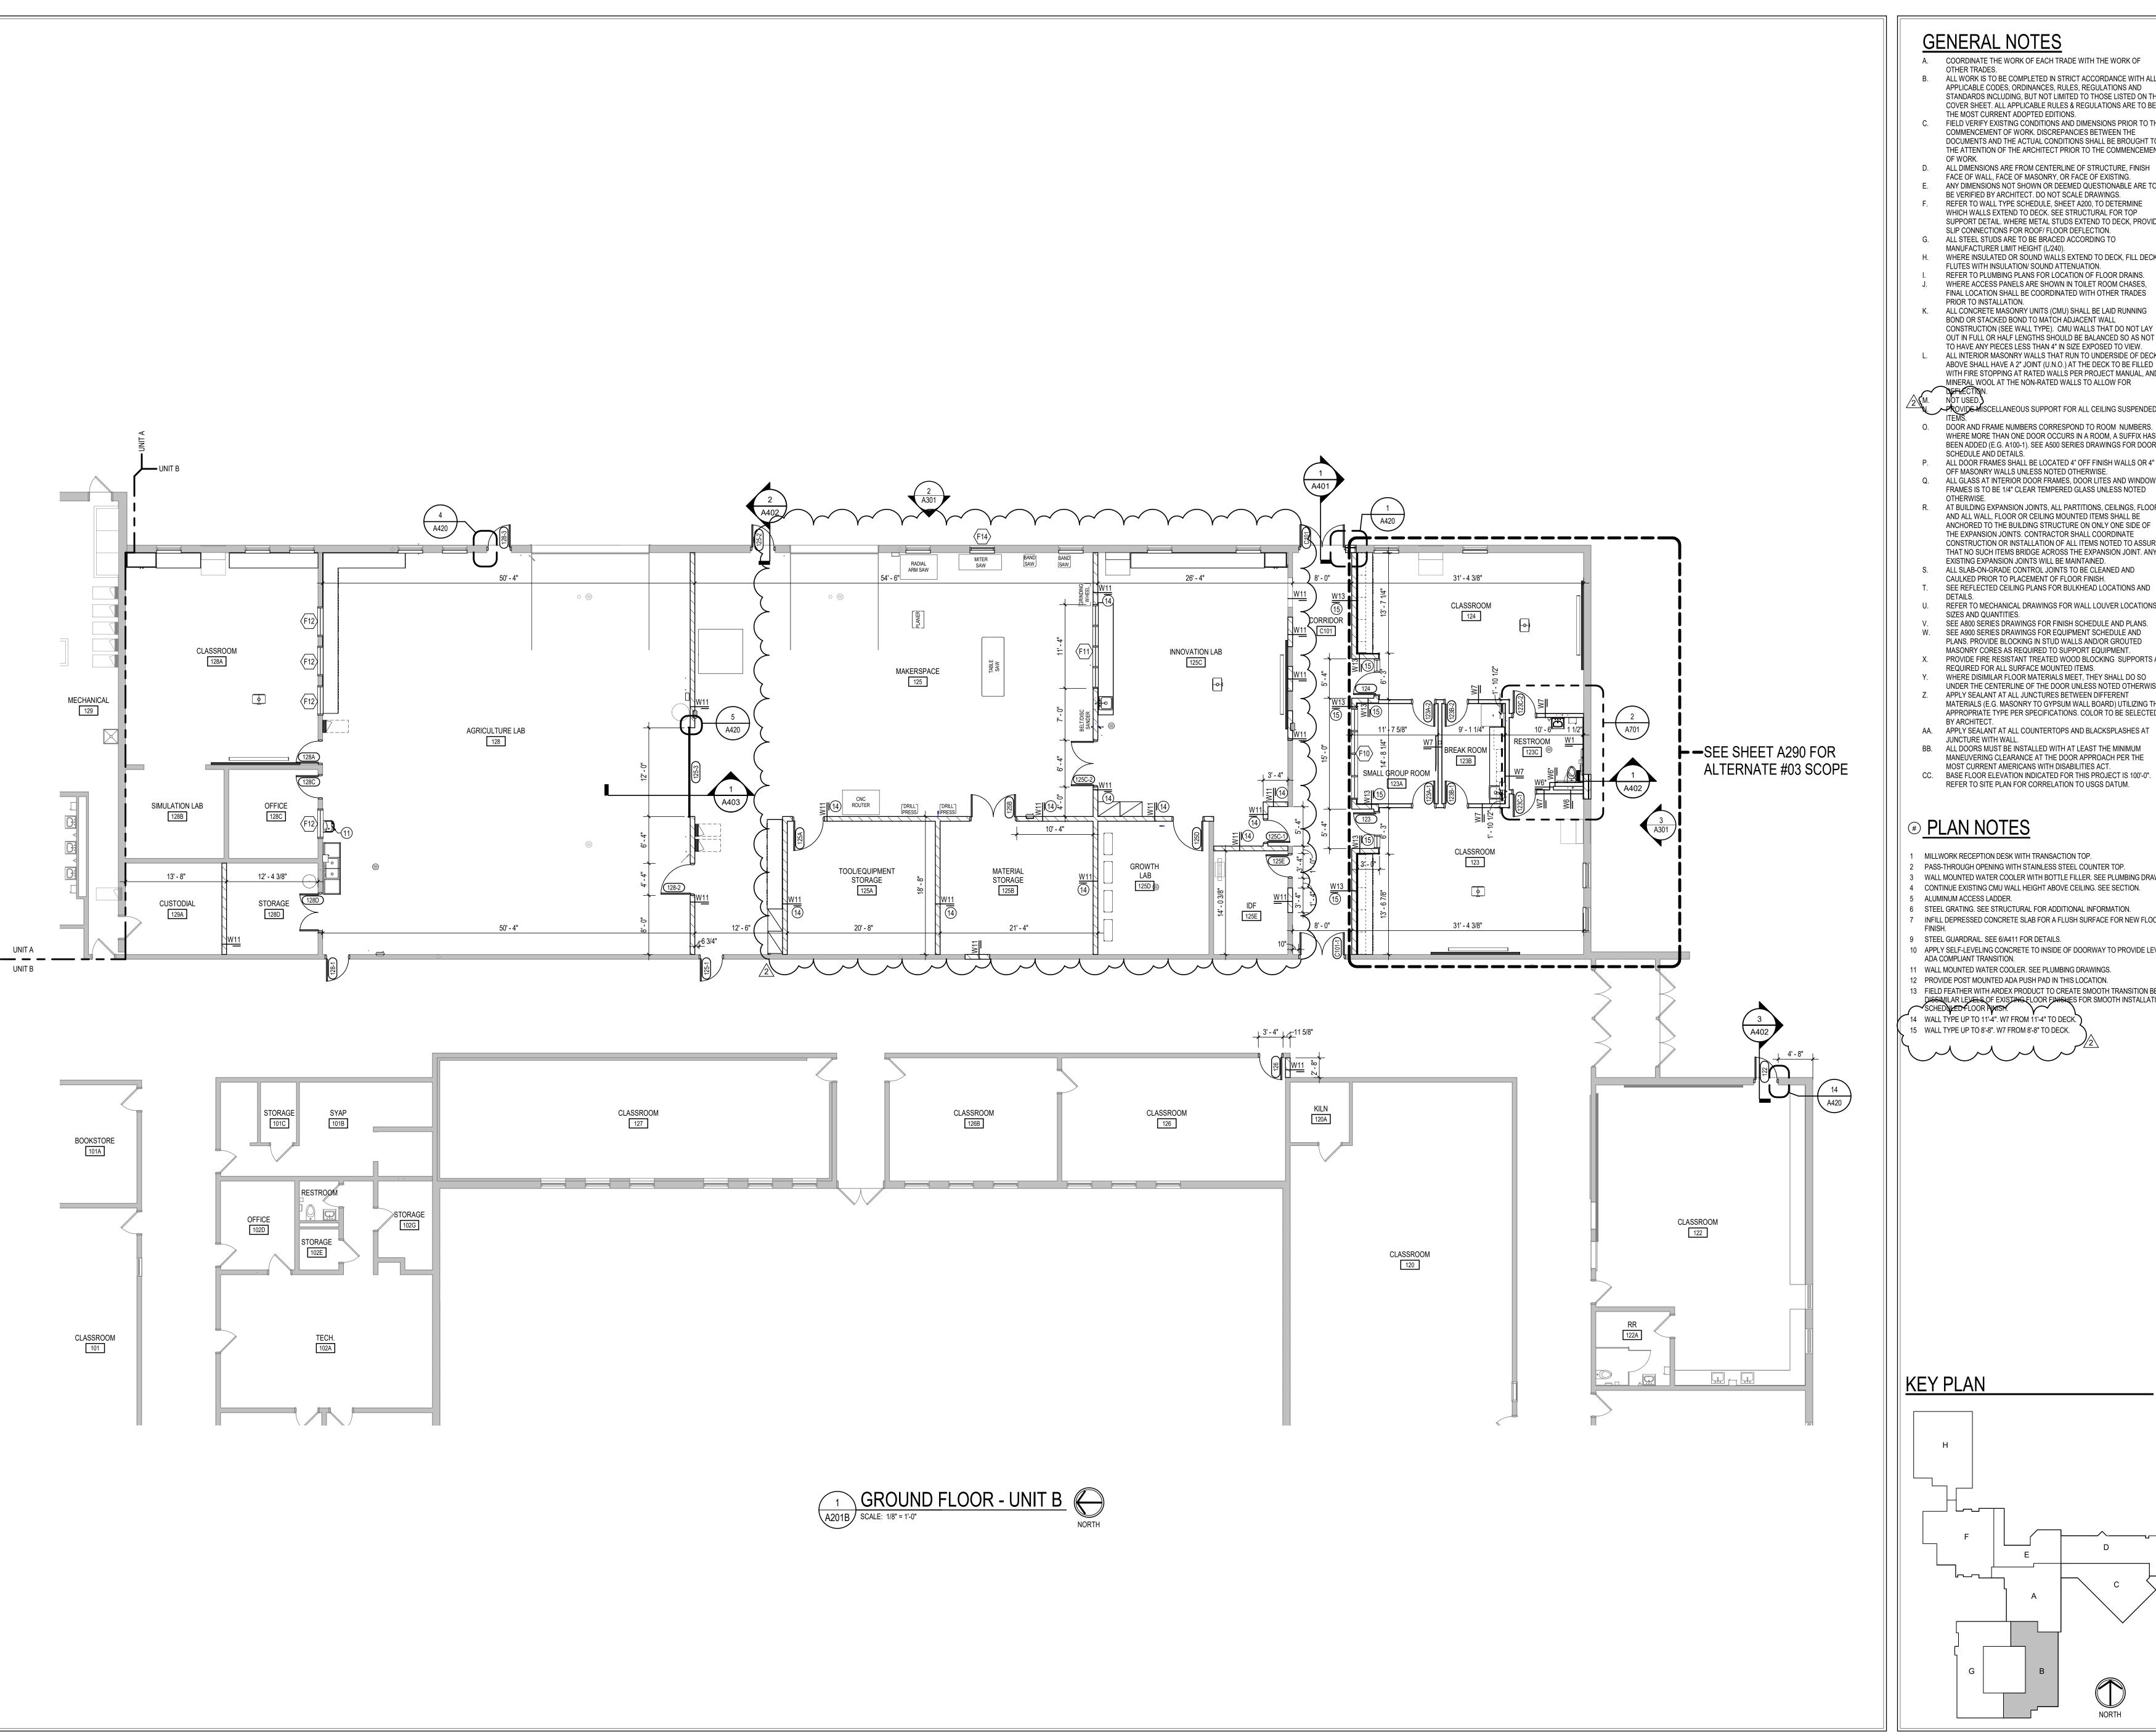

## **GENERAL NOTES**

- A. COORDINATE THE WORK OF EACH TRADE WITH THE WORK OF OTHER TRADES. B. ALL WORK IS TO BE COMPLETED IN STRICT ACCORDANCE WITH ALL APPLICABLE CODES, ORDINANCES, RULES, REGULATIONS AND
- STANDARDS INCLUDING, BUT NOT LIMITED TO THOSE LISTED ON THE COVER SHEET. ALL APPLICABLE RULES & REGULATIONS ARE TO BE THE MOST CURRENT ADOPTED EDITIONS. C. FIELD VERIFY EXISTING CONDITIONS AND DIMENSIONS PRIOR TO THE COMMENCEMENT OF WORK. DISCREPANCIES BETWEEN THE DOCUMENTS AND THE ACTUAL CONDITIONS SHALL BE BROUGHT TO THE ATTENTION OF THE ARCHITECT PRIOR TO THE COMMENCEMENT
- D. ALL DIMENSIONS ARE FROM CENTERLINE OF STRUCTURE, FINISH FACE OF WALL, FACE OF MASONRY, OR FACE OF EXISTING.
- E. ANY DIMENSIONS NOT SHOWN OR DEEMED QUESTIONABLE ARE TO BE VERIFIED BY ARCHITECT. DO NOT SCALE DRAWINGS. REFER TO WALL TYPE SCHEDULE. SHEET A200, TO DETERMINE WHICH WALLS EXTEND TO DECK. SEE STRUCTURAL FOR TOP SUPPORT DETAIL. WHERE METAL STUDS EXTEND TO DECK, PROVIDE SLIP CONNECTIONS FOR ROOF/ FLOOR DEFLECTION. G. ALL STEEL STUDS ARE TO BE BRACED ACCORDING TO
- MANUFACTURER LIMIT HEIGHT (L/240). H. WHERE INSULATED OR SOUND WALLS EXTEND TO DECK, FILL DECK FLUTES WITH INSULATION/ SOUND ATTENUATION.
- REFER TO PLUMBING PLANS FOR LOCATION OF FLOOR DRAINS. WHERE ACCESS PANELS ARE SHOWN IN TOILET ROOM CHASES, FINAL LOCATION SHALL BE COORDINATED WITH OTHER TRADES
- K. ALL CONCRETE MASONRY UNITS (CMU) SHALL BE LAID RUNNING BOND OR STACKED BOND TO MATCH ADJACENT WALL CONSTRUCTION (SEE WALL TYPE). CMU WALLS THAT DO NOT LAY OUT IN FULL OR HALF LENGTHS SHOULD BE BALANCED SO AS NOT
- TO HAVE ANY PIECES LESS THAN 4" IN SIZE EXPOSED TO VIEW. L. ALL INTERIOR MASONRY WALLS THAT RUN TO UNDERSIDE OF DECK ABOVE SHALL HAVE A 2" JOINT (U.N.O.) AT THE DECK TO BE FILLED WITH FIRE STOPPING AT RATED WALLS PER PROJECT MANUAL, AND MINERAL WOOL AT THE NON-RATED WALLS TO ALLOW FOR

## PROVIDE MISCELLANEOUS SUPPORT FOR ALL CEILING SUSPENDED

- O. DOOR AND FRAME NUMBERS CORRESPOND TO ROOM NUMBERS. WHERE MORE THAN ONE DOOR OCCURS IN A ROOM, A SUFFIX HAS BEEN ADDED (E.G. A100-1). SEE A500 SERIES DRAWINGS FOR DOOR SCHEDULE AND DETAILS. P. ALL DOOR FRAMES SHALL BE LOCATED 4" OFF FINISH WALLS OR 4"
- OFF MASONRY WALLS UNLESS NOTED OTHERWISE. Q. ALL GLASS AT INTERIOR DOOR FRAMES, DOOR LITES AND WINDOW FRAMES IS TO BE 1/4" CLEAR TEMPERED GLASS UNLESS NOTED OTHERWISE. R. AT BUILDING EXPANSION JOINTS, ALL PARTITIONS, CEILINGS, FLOORS
- AND ALL WALL, FLOOR OR CEILING MOUNTED ITEMS SHALL BE ANCHORED TO THE BUILDING STRUCTURE ON ONLY ONE SIDE OF THE EXPANSION JOINTS. CONTRACTOR SHALL COORDINATE CONSTRUCTION OR INSTALLATION OF ALL ITEMS NOTED TO ASSURE THAT NO SUCH ITEMS BRIDGE ACROSS THE EXPANSION JOINT. ANY EXISTING EXPANSION JOINTS WILL BE MAINTAINED.
- S. ALL SLAB-ON-GRADE CONTROL JOINTS TO BE CLEANED AND CAULKED PRIOR TO PLACEMENT OF FLOOR FINISH. SEE REFLECTED CEILING PLANS FOR BULKHEAD LOCATIONS AND
- U. REFER TO MECHANICAL DRAWINGS FOR WALL LOUVER LOCATIONS, SIZES AND QUANTITIES.
- V. SEE A800 SERIES DRAWINGS FOR FINISH SCHEDULE AND PLANS. W. SEE A900 SERIES DRAWINGS FOR EQUIPMENT SCHEDULE AND PLANS. PROVIDE BLOCKING IN STUD WALLS AND/OR GROUTED
- MASONRY CORES AS REQUIRED TO SUPPORT EQUIPMENT. PROVIDE FIRE RESISTANT TREATED WOOD BLOCKING SUPPORTS AS REQUIRED FOR ALL SURFACE MOUNTED ITEMS. WHERE DISIMILAR FLOOR MATERIALS MEET, THEY SHALL DO SO
- UNDER THE CENTERLINE OF THE DOOR UNLESS NOTED OTHERWISE. APPLY SEALANT AT ALL JUNCTURES BETWEEN DIFFERENT MATERIALS (E.G. MASONRY TO GYPSUM WALL BOARD) UTILIZING THE APPROPRIATE TYPE PER SPECIFICATIONS. COLOR TO BE SELECTED
- BY ARCHITECT. AA. APPLY SEALANT AT ALL COUNTERTOPS AND BLACKSPLASHES AT
- JUNCTURE WITH WALL. BB. ALL DOORS MUST BE INSTALLED WITH AT LEAST THE MINIMUM MANEUVERING CLEARANCE AT THE DOOR APPROACH PER THE
- MOST CURRENT AMERICANS WITH DISABILITIES ACT.

## **PLAN NOTES**


- MILLWORK RECEPTION DESK WITH TRANSACTION TOP.
- PASS-THROUGH OPENING WITH STAINLESS STEEL COUNTER TOP. WALL MOUNTED WATER COOLER WITH BOTTLE FILLER. SEE PLUMBING DRAWINGS. CONTINUE EXISTING CMU WALL HEIGHT ABOVE CEILING. SEE SECTION.
- STEEL GRATING. SEE STRUCTURAL FOR ADDITIONAL INFORMATION.
- INFILL DEPRESSED CONCRETE SLAB FOR A FLUSH SURFACE FOR NEW FLOOR
- STEEL GUARDRAIL. SEE 6/A411 FOR DETAILS. 10 APPLY SELF-LEVELING CONCRETE TO INSIDE OF DOORWAY TO PROVIDE LEVEL,
- 11 WALL MOUNTED WATER COOLER. SEE PLUMBING DRAWINGS.
- 12 PROVIDE POST MOUNTED ADA PUSH PAD IN THIS LOCATION. 13 FIELD FEATHER WITH ARDEX PRODUCT TO CREATE SMOOTH TRANSITION BETWEEN
- DISSIMILAR LEVELS OF EXISTING FLOOR FINISHES FOR SMOOTH INSTALLATION OF SCHEDULED FLOOR PINISH.

  14 WALL TYPE UP TO 11'-4". W7 FROM 11'-4" TO DECK.
- 15 WALL TYPE UP TO 8'-8". W7 FROM 8'-8" TO DECK.

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08/15/2025 JTL

DRAWING TITLE: GROUND FLOOR PLAN - UNIT B

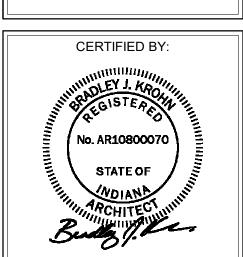


DRAWING NUMBER A201B PROJECT NUMBER 2024037

SCOPE DRAWINGS:

These drawings indicate the general scope of the project in terms of architectural design concept, the dimensions of the building, the major architectural elements and the type of structural, mechanical and electrical systems.

The drawings do not necessarily indicate or describe all work required for full performance and completion of the

# REVISIONS: ADDENDUM #01 09-05-2025 2 ADDENDUM #02 09-12-2025

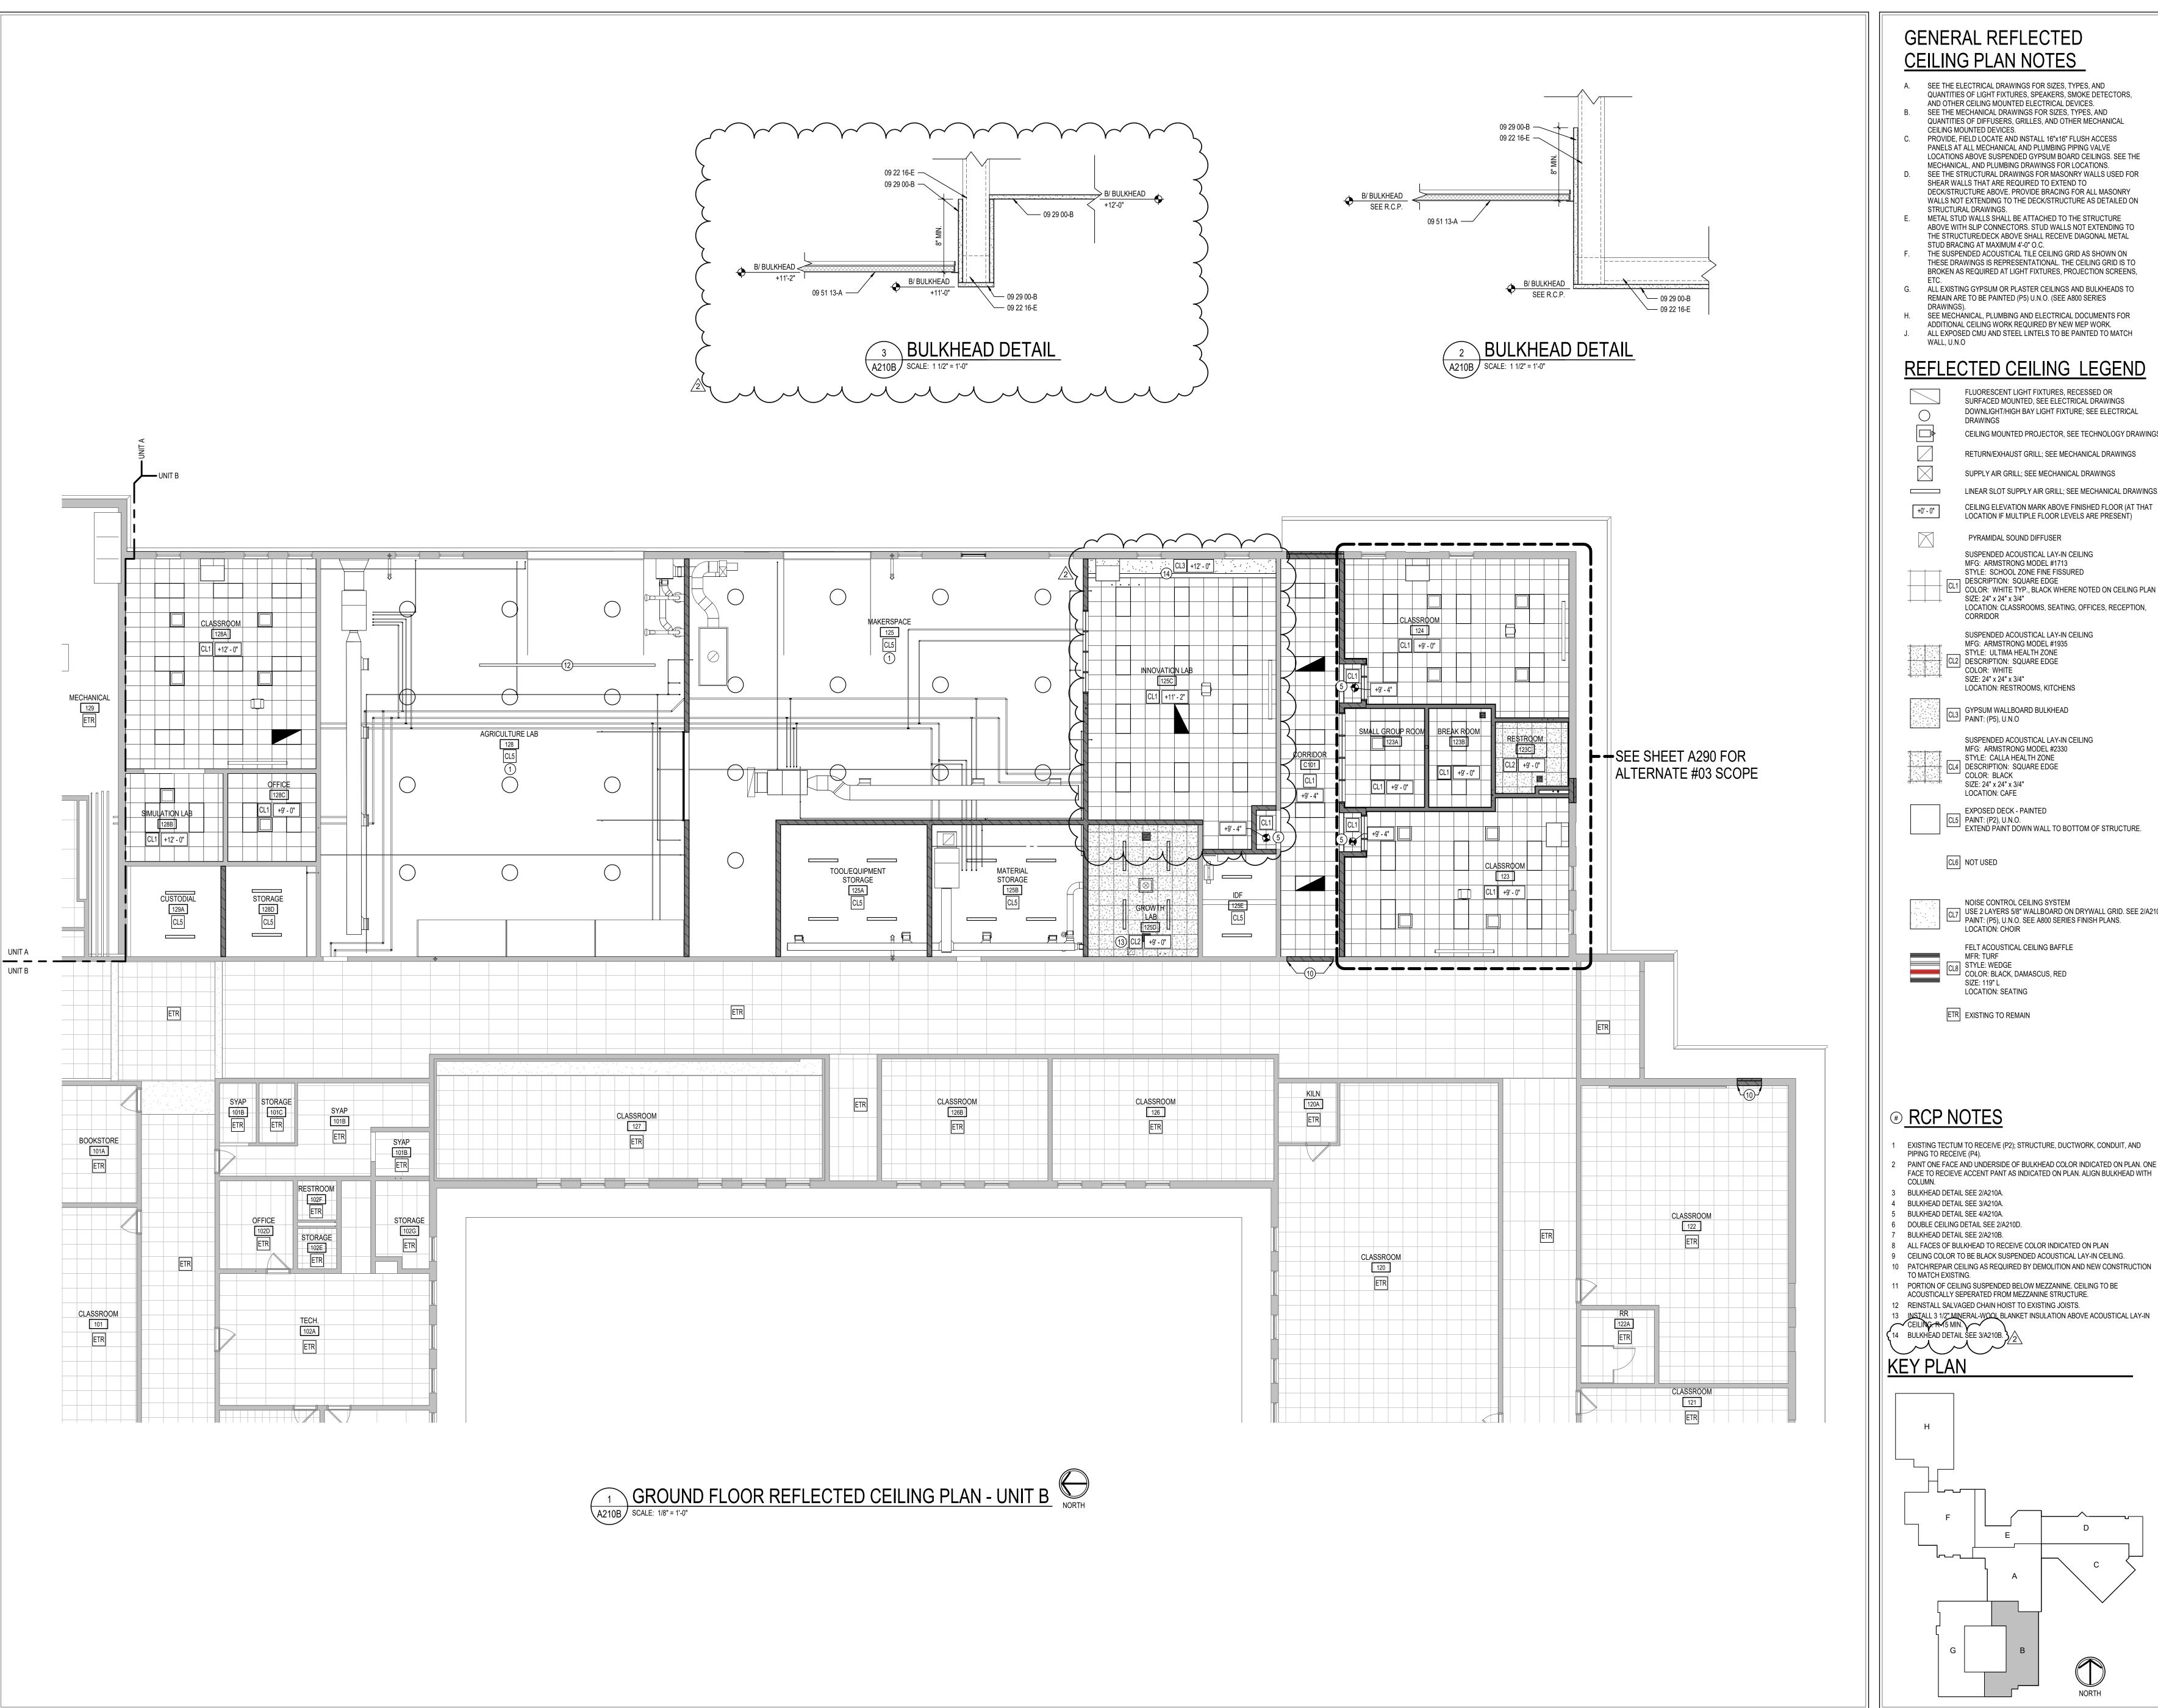

## GENERAL REFLECTED CEILING PLAN NOTES

- A. SEE THE ELECTRICAL DRAWINGS FOR SIZES, TYPES, AND QUANTITIES OF LIGHT FIXTURES, SPEAKERS, SMOKE DETECTORS,
- AND OTHER CEILING MOUNTED ELECTRICAL DEVICES. SEE THE MECHANICAL DRAWINGS FOR SIZES, TYPES, AND
- PROVIDE, FIELD LOCATE AND INSTALL 16"x16" FLUSH ACCESS PANELS AT ALL MECHANICAL AND PLUMBING PIPING VALVE LOCATIONS ABOVE SUSPENDED GYPSUM BOARD CEILINGS. SEE THE MECHANICAL, AND PLUMBING DRAWINGS FOR LOCATIONS.
- SEE THE STRUCTURAL DRAWINGS FOR MASONRY WALLS USED FOR SHEAR WALLS THAT ARE REQUIRED TO EXTEND TO DECK/STRUCTURE ABOVE. PROVIDE BRACING FOR ALL MASONRY WALLS NOT EXTENDING TO THE DECK/STRUCTURE AS DETAILED ON
- METAL STUD WALLS SHALL BE ATTACHED TO THE STRUCTURE ABOVE WITH SLIP CONNECTORS. STUD WALLS NOT EXTENDING TO THE STRUCTURE/DECK ABOVE SHALL RECEIVE DIAGONAL METAL STUD BRACING AT MAXIMUM 4'-0" O.C.
- BROKEN AS REQUIRED AT LIGHT FIXTURES, PROJECTION SCREENS, G. ALL EXISTING GYPSUM OR PLASTER CEILINGS AND BULKHEADS TO
- H. SEE MECHÁNICAL, PLUMBING AND ELECTRICAL DOCUMENTS FOR ADDITIONAL CEILING WORK REQUIRED BY NEW MEP WORK. ALL EXPOSED CMU AND STEEL LINTELS TO BE PAINTED TO MATCH

## REFLECTED CEILING LEGEND

FLUORESCENT LIGHT FIXTURES, RECESSED OR SURFACED MOUNTED, SEE ELECTRICAL DRAWINGS DOWNLIGHT/HIGH BAY LIGHT FIXTURE; SEE ELECTRICAL CEILING MOUNTED PROJECTOR, SEE TECHNOLOGY DRAWINGS

SUPPLY AIR GRILL; SEE MECHANICAL DRAWINGS LINEAR SLOT SUPPLY AIR GRILL; SEE MECHANICAL DRAWINGS

PYRAMIDAL SOUND DIFFUSER SUSPENDED ACOUSTICAL LAY-IN CEILING MFG: ARMSTRONG MODEL #1713

DESCRIPTION: SQUARE EDGE COLOR: WHITE TYP., BLACK WHERE NOTED ON CEILING PLAN LOCATION: CLASSROOMS, SEATING, OFFICES, RECEPTION,

| CL2 | DESCRIPTION: SQUARE EDGE SIZE: 24" x 24" x 3/4" LOCATION: RESTROOMS, KITCHENS

> SUSPENDED ACOUSTICAL LAY-IN CEILING MFG: ARMSTRONG MODEL #2330 STYLE: CALLA HEALTH ZONE CL4 DESCRIPTION: SQUARE EDGE SIZE: 24" x 24" x 3/4"


EXTEND PAINT DOWN WALL TO BOTTOM OF STRUCTURE.

NOISE CONTROL CEILING SYSTEM USE 2 LAYERS 5/8" WALLBOARD ON DRYWALL GRID. SEE 2/A210D. PAINT: (P5), U.N.O. SEE A800 SERIES FINISH PLANS.

FELT ACOUSTICAL CEILING BAFFLE COLOR: BLACK, DAMASCUS, RED SIZE: 119" L

- EXISTING TECTUM TO RECEIVE (P2); STRUCTURE, DUCTWORK, CONDUIT, AND
- PAINT ONE FACE AND UNDERSIDE OF BULKHEAD COLOR INDICATED ON PLAN. ONE
- ALL FACES OF BULKHEAD TO RECEIVE COLOR INDICATED ON PLAN
- CEILING COLOR TO BE BLACK SUSPENDED ACOUSTICAL LAY-IN CEILING. 10 PATCH/REPAIR CEILING AS REQUIRED BY DEMOLITION AND NEW CONSTRUCTION
- 1 PORTION OF CEILING SUSPENDED BELOW MEZZANINE. CEILING TO BE ACOUSTICALLY SEPERATED FROM MEZZANINE STRUCTURE. 2 REINSTALL SALVAGED CHAIN HOIST TO EXISTING JOISTS.
- 13 INSTALL 3 1/2" MINERAL-WOOL BLANKET INSULATION ABOVE ACOUSTICAL LAY-IN CEILING R 15 MIN.

  14 BULKHEAD DETAIL SEE 3/A210B.

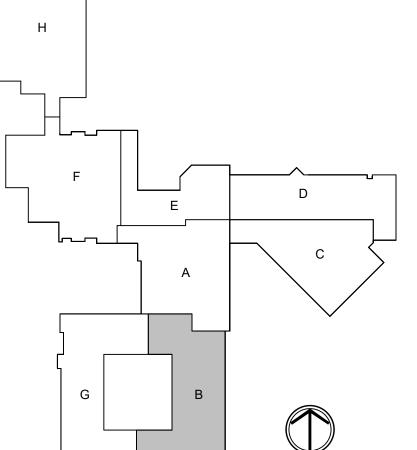




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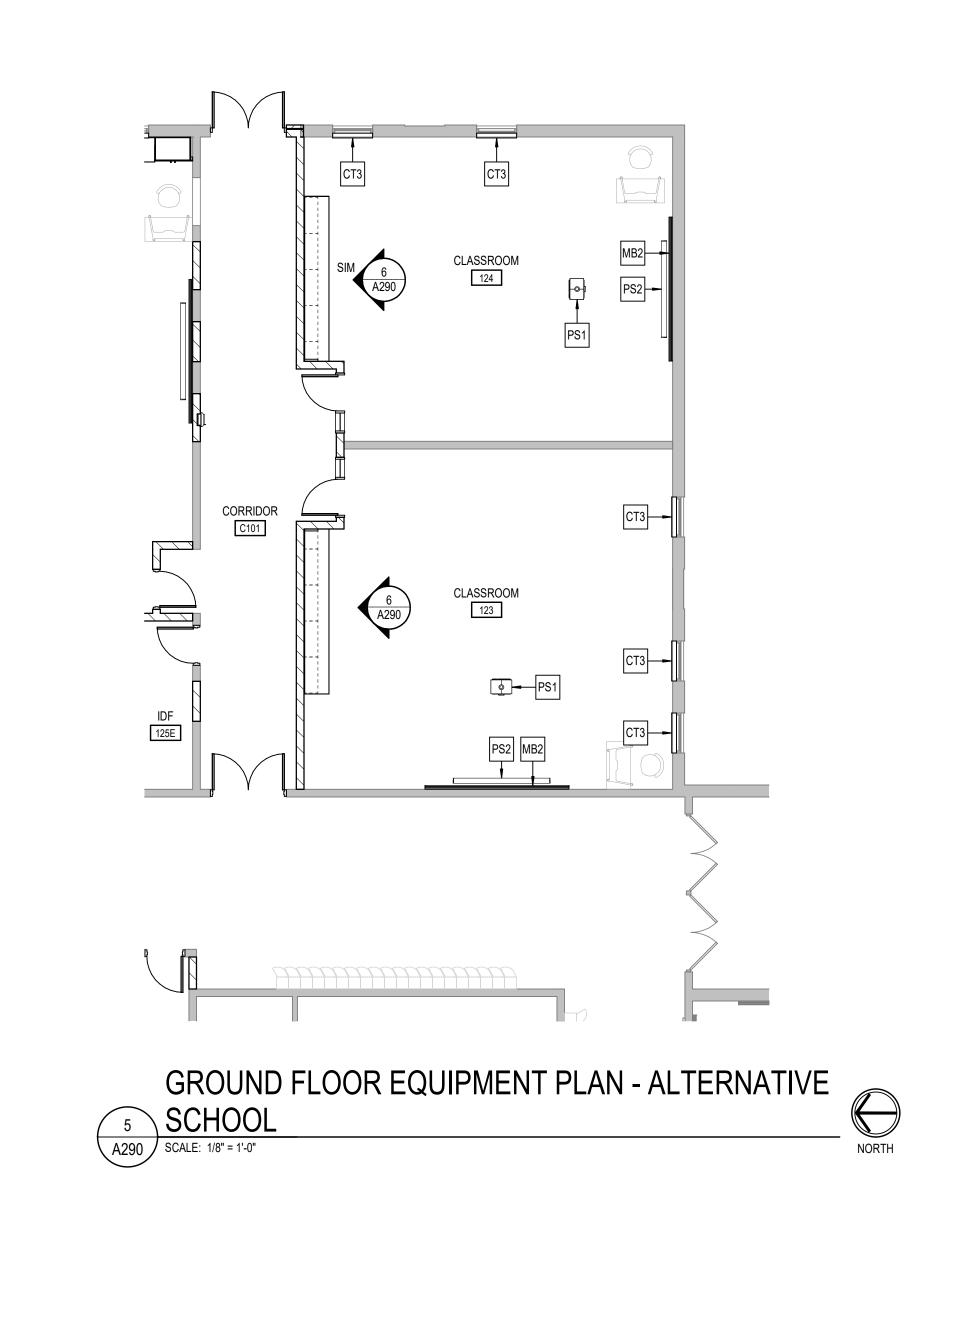
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DRAWING TITLE: GROUND FLOOR REFLECTED **CEILING PLAN -**UNIT B



DRAWING NUMBER A210B PROJECT NUMBER

2024037

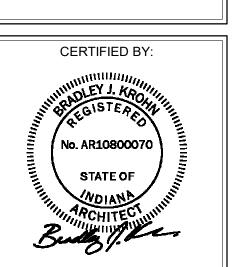

6 CLASSROOM CASEWORK ELEVATION

CL1 +9' - 0"


CL1 +9' - 0"

REFLECTED CEILING PLAN - ALTERNATIVE SCHOOL

SCALE: 1/8" = 1'-0"


NORTH


A290 | SCALE: 1/4" = 1'-0"

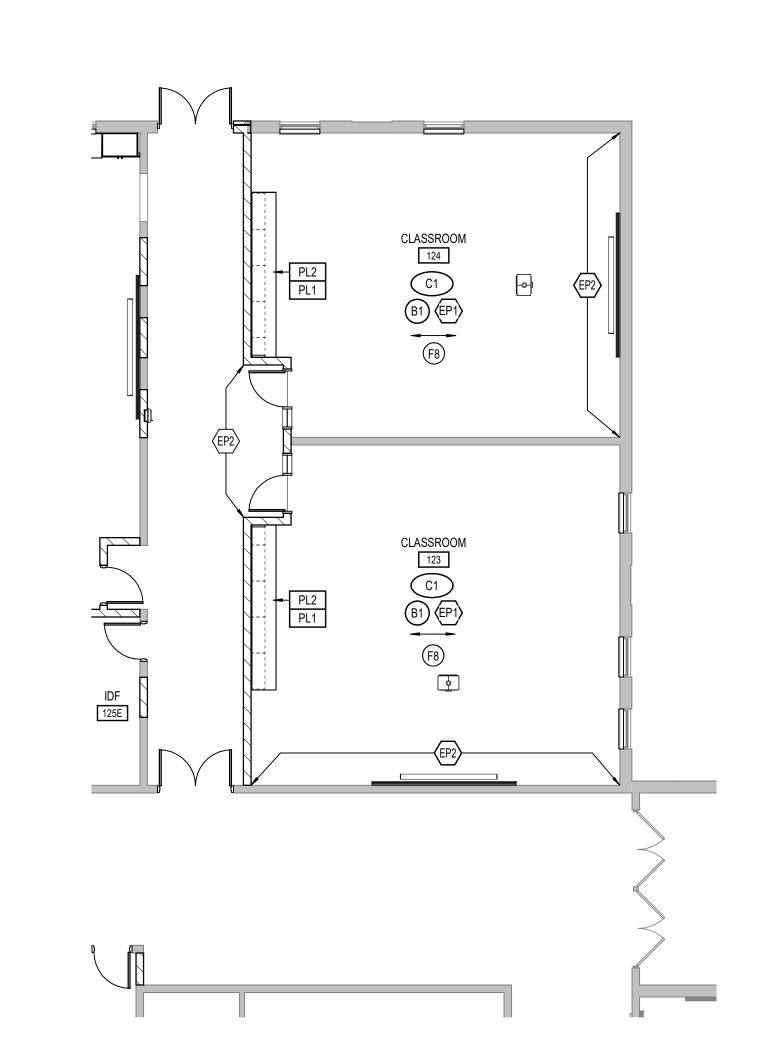



GROUND FLOOR FINISH PLAN - ALTERNATIVE SCHOOL

SCALE: 1/8" = 1'-0"

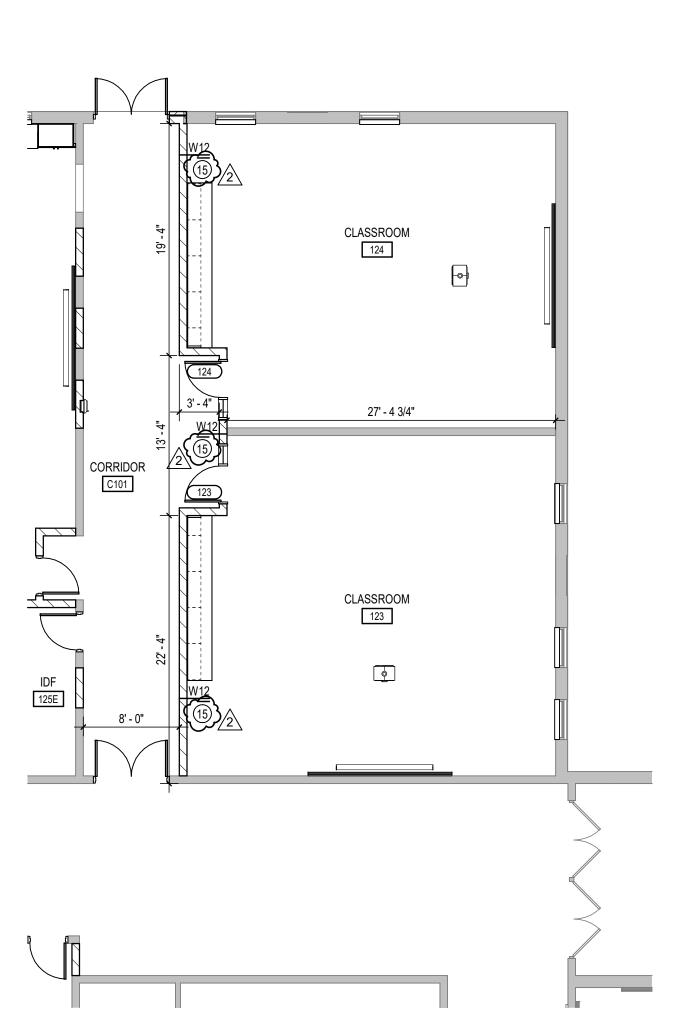

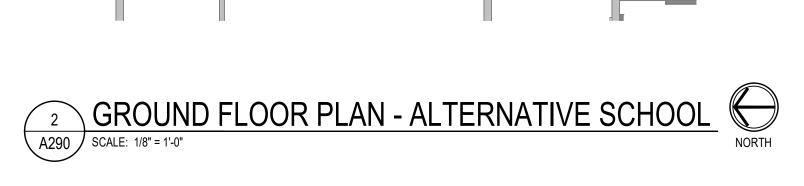

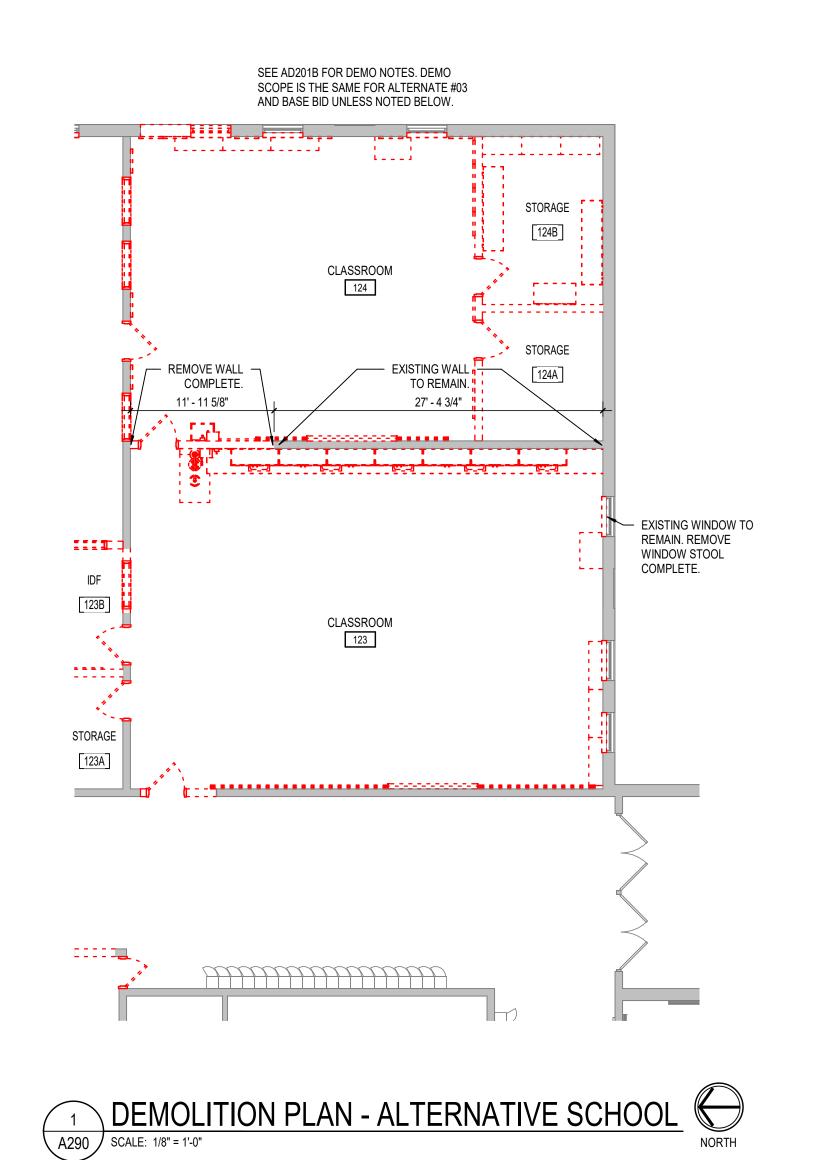

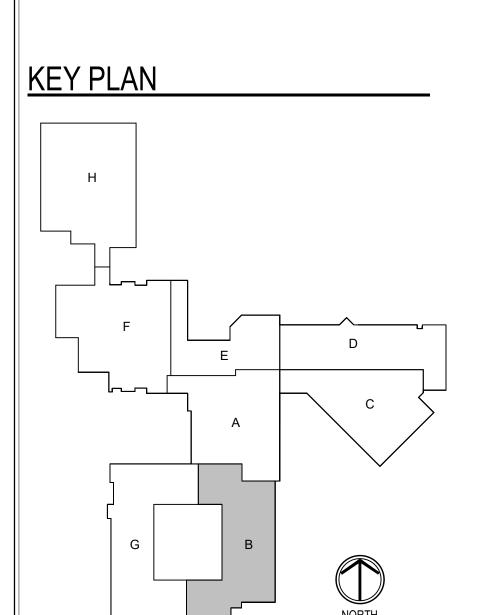

# GENERAL NOTES

- COORDINATE THE WORK OF EACH TRADE WITH THE WORK OF OTHER TRADES.

   ALL WORK IS TO BE COMPLETED IN STRICT ACCORDANCE WITH ALL APPLICABLE CODES, ORDINANCES, RULES, REGULATIONS AND STANDARDS INCLUDING, BUT NOT LIMITED TO THOSE LISTED ON THE
- COVER SHEET. ALL APPLICABLE RULES & REGULATIONS ARE TO BE THE MOST CURRENT ADOPTED EDITIONS.

  C. FIELD VERIFY EXISTING CONDITIONS AND DIMENSIONS PRIOR TO THE COMMENCEMENT OF WORK. DISCREPANCIES BETWEEN THE DOCUMENTS AND THE ACTUAL CONDITIONS SHALL BE BROUGHT TO THE ATTENTION OF THE ARCHITECT PRIOR TO THE COMMENCEMENT
- OF WORK.

  D. ALL DIMENSIONS ARE FROM CENTERLINE OF STRUCTURE, FINISH FACE OF WALL, FACE OF MASONRY, OR FACE OF EXISTING.

  E. ANY DIMENSIONS NOT SHOWN OR DEEMED QUESTIONABLE ARE TO
- BE VERIFIED BY ARCHITECT. DO NOT SCALE DRAWINGS.

  F. REFER TO WALL TYPE SCHEDULE, SHEET A200, TO DETERMINE WHICH WALLS EXTEND TO DECK. SEE STRUCTURAL FOR TOP SUPPORT DETAIL. WHERE METAL STUDS EXTEND TO DECK, PROVIDE SLIP CONNECTIONS FOR ROOF/ FLOOR DEFLECTION.

  G. ALL STEEL STUDS ARE TO BE BRACED ACCORDING TO
- MANUFACTURER LIMIT HEIGHT (L/240).

  H. WHERE INSULATED OR SOUND WALLS EXTEND TO DECK, FILL DECK FLUTES WITH INSULATION/ SOUND ATTENUATION.

  I. REFER TO PLUMBING PLANS FOR LOCATION OF FLOOR DRAINS.

  J. WHERE ACCESS PANELS ARE SHOWN IN TOILET ROOM CHASES,
- FINAL LOCATION SHALL BE COORDINATED WITH OTHER TRADES PRIOR TO INSTALLATION.

  K. ALL CONCRETE MASONRY UNITS (CMU) SHALL BE LAID RUNNING BOND OR STACKED BOND TO MATCH ADJACENT WALL CONSTRUCTION (SEE WALL TYPE). CMU WALLS THAT DO NOT LAY
- OUT IN FULL OR HALF LENGTHS SHOULD BE BALANCED SO AS NOT TO HAVE ANY PIECES LESS THAN 4" IN SIZE EXPOSED TO VIEW.

  ALL INTERIOR MASONRY WALLS THAT RUN TO UNDERSIDE OF DECK ABOVE SHALL HAVE A 2" JOINT (U.N.O.) AT THE DECK TO BE FILLED WITH FIRE STOPPING AT RATED WALLS PER PROJECT MANUAL, AND MINERAL WOOL AT THE NON-RATED WALLS TO ALLOW FOR
- M. NOT USED.

  PROVIDE MISCELLANEOUS SUPPORT FOR ALL CEILING SUSPENDED ITEMS.

  O. DOOR AND FRAME NUMBERS CORRESPOND TO ROOM NUMBERS. WHERE MORE THAN ONE DOOR OCCURS IN A ROOM, A SUFFIX HAS BEEN ADDED (E.G. A100-1). SEE A500 SERIES DRAWINGS FOR DOOR
- SCHEDULE AND DETAILS.

  P. ALL DOOR FRAMES SHALL BE LOCATED 4" OFF FINISH WALLS OR 4"
  OFF MASONRY WALLS UNLESS NOTED OTHERWISE.

  Q. ALL GLASS AT INTERIOR DOOR FRAMES, DOOR LITES AND WINDOW
  FRAMES IS TO BE 1/4" CLEAR TEMPERED GLASS UNLESS NOTED
  OTHERWISE.

R. AT BUILDING EXPANSION JOINTS, ALL PARTITIONS, CEILINGS, FLOORS

- AND ALL WALL, FLOOR OR CEILING MOUNTED ITEMS SHALL BE ANCHORED TO THE BUILDING STRUCTURE ON ONLY ONE SIDE OF THE EXPANSION JOINTS. CONTRACTOR SHALL COORDINATE CONSTRUCTION OR INSTALLATION OF ALL ITEMS NOTED TO ASSURE THAT NO SUCH ITEMS BRIDGE ACROSS THE EXPANSION JOINT. ANY EXISTING EXPANSION JOINTS WILL BE MAINTAINED.
- S. ALL SLAB-ON-GRADE CONTROL JOINTS TO BE CLEANED AND CAULKED PRIOR TO PLACEMENT OF FLOOR FINISH.
   T. SEE REFLECTED CEILING PLANS FOR BULKHEAD LOCATIONS AND DETAILS.
   U. REFER TO MECHANICAL DRAWINGS FOR WALL LOUVER LOCATIONS,

V. SEE A800 SERIES DRAWINGS FOR FINISH SCHEDULE AND PLANS.

SIZES AND QUANTITIES.

W. SEE A900 SERIES DRAWINGS FOR EQUIPMENT SCHEDULE AND PLANS. PROVIDE BLOCKING IN STUD WALLS AND/OR GROUTED MASONRY CORES AS REQUIRED TO SUPPORT EQUIPMENT.
 X. PROVIDE FIRE RESISTANT TREATED WOOD BLOCKING SUPPORTS AS REQUIRED FOR ALL SURFACE MOUNTED ITEMS.

WHERE DISIMILAR FLOOR MATERIALS MEET, THEY SHALL DO SO

- UNDER THE CENTERLINE OF THE DOOR UNLESS NOTED OTHERWISE.

  Z. APPLY SEALANT AT ALL JUNCTURES BETWEEN DIFFERENT
  MATERIALS (E.G. MASONRY TO GYPSUM WALL BOARD) UTILIZING THE
  APPROPRIATE TYPE PER SPECIFICATIONS. COLOR TO BE SELECTED
  BY ARCHITECT.

  AA. APPLY SEALANT AT ALL COUNTERTOPS AND BLACKSPLASHES AT
- JUNCTURE WITH WALL.

  BB. ALL DOORS MUST BE INSTALLED WITH AT LEAST THE MINIMUM MANEUVERING CLEARANCE AT THE DOOR APPROACH PER THE
- MOST CURRENT AMERICANS WITH DISABILITIES ACT.

  CC. BASE FLOOR ELEVATION INDICATED FOR THIS PROJECT IS 100'-0".

  REFER TO SITE PLAN FOR CORRELATION TO USGS DATUM.

SHERIDAN SOMMUNITY SCHOOL

ne Crossing, Indianapolis, IN 46240

SCHOOLS
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CUMENTS

SHERIDAN COMMUNITY S
HIGH SCHOOL & MIDDLE &
RENOVATION PRO
100% CONSTRUCTION DOC
24185 HINESLEY RD, SHERIDAN

SCOPE DRAWINGS:
ese drawings indicate the general scope of the project
s of architectural design concept, the dimensions of
Iding, the major architectural elements and the type
ctural, mechanical and electrical systems.
e drawings do not necessarily indicate or describe all
squired for full performance and completion of the
ments of the Contract.
the basis of the general scope indicated or described
de contractors shall furnish all items required for the

# REVISIONS: 2 ADDENDUM #02 09-12-2025

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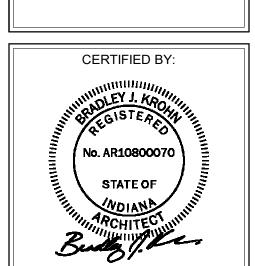
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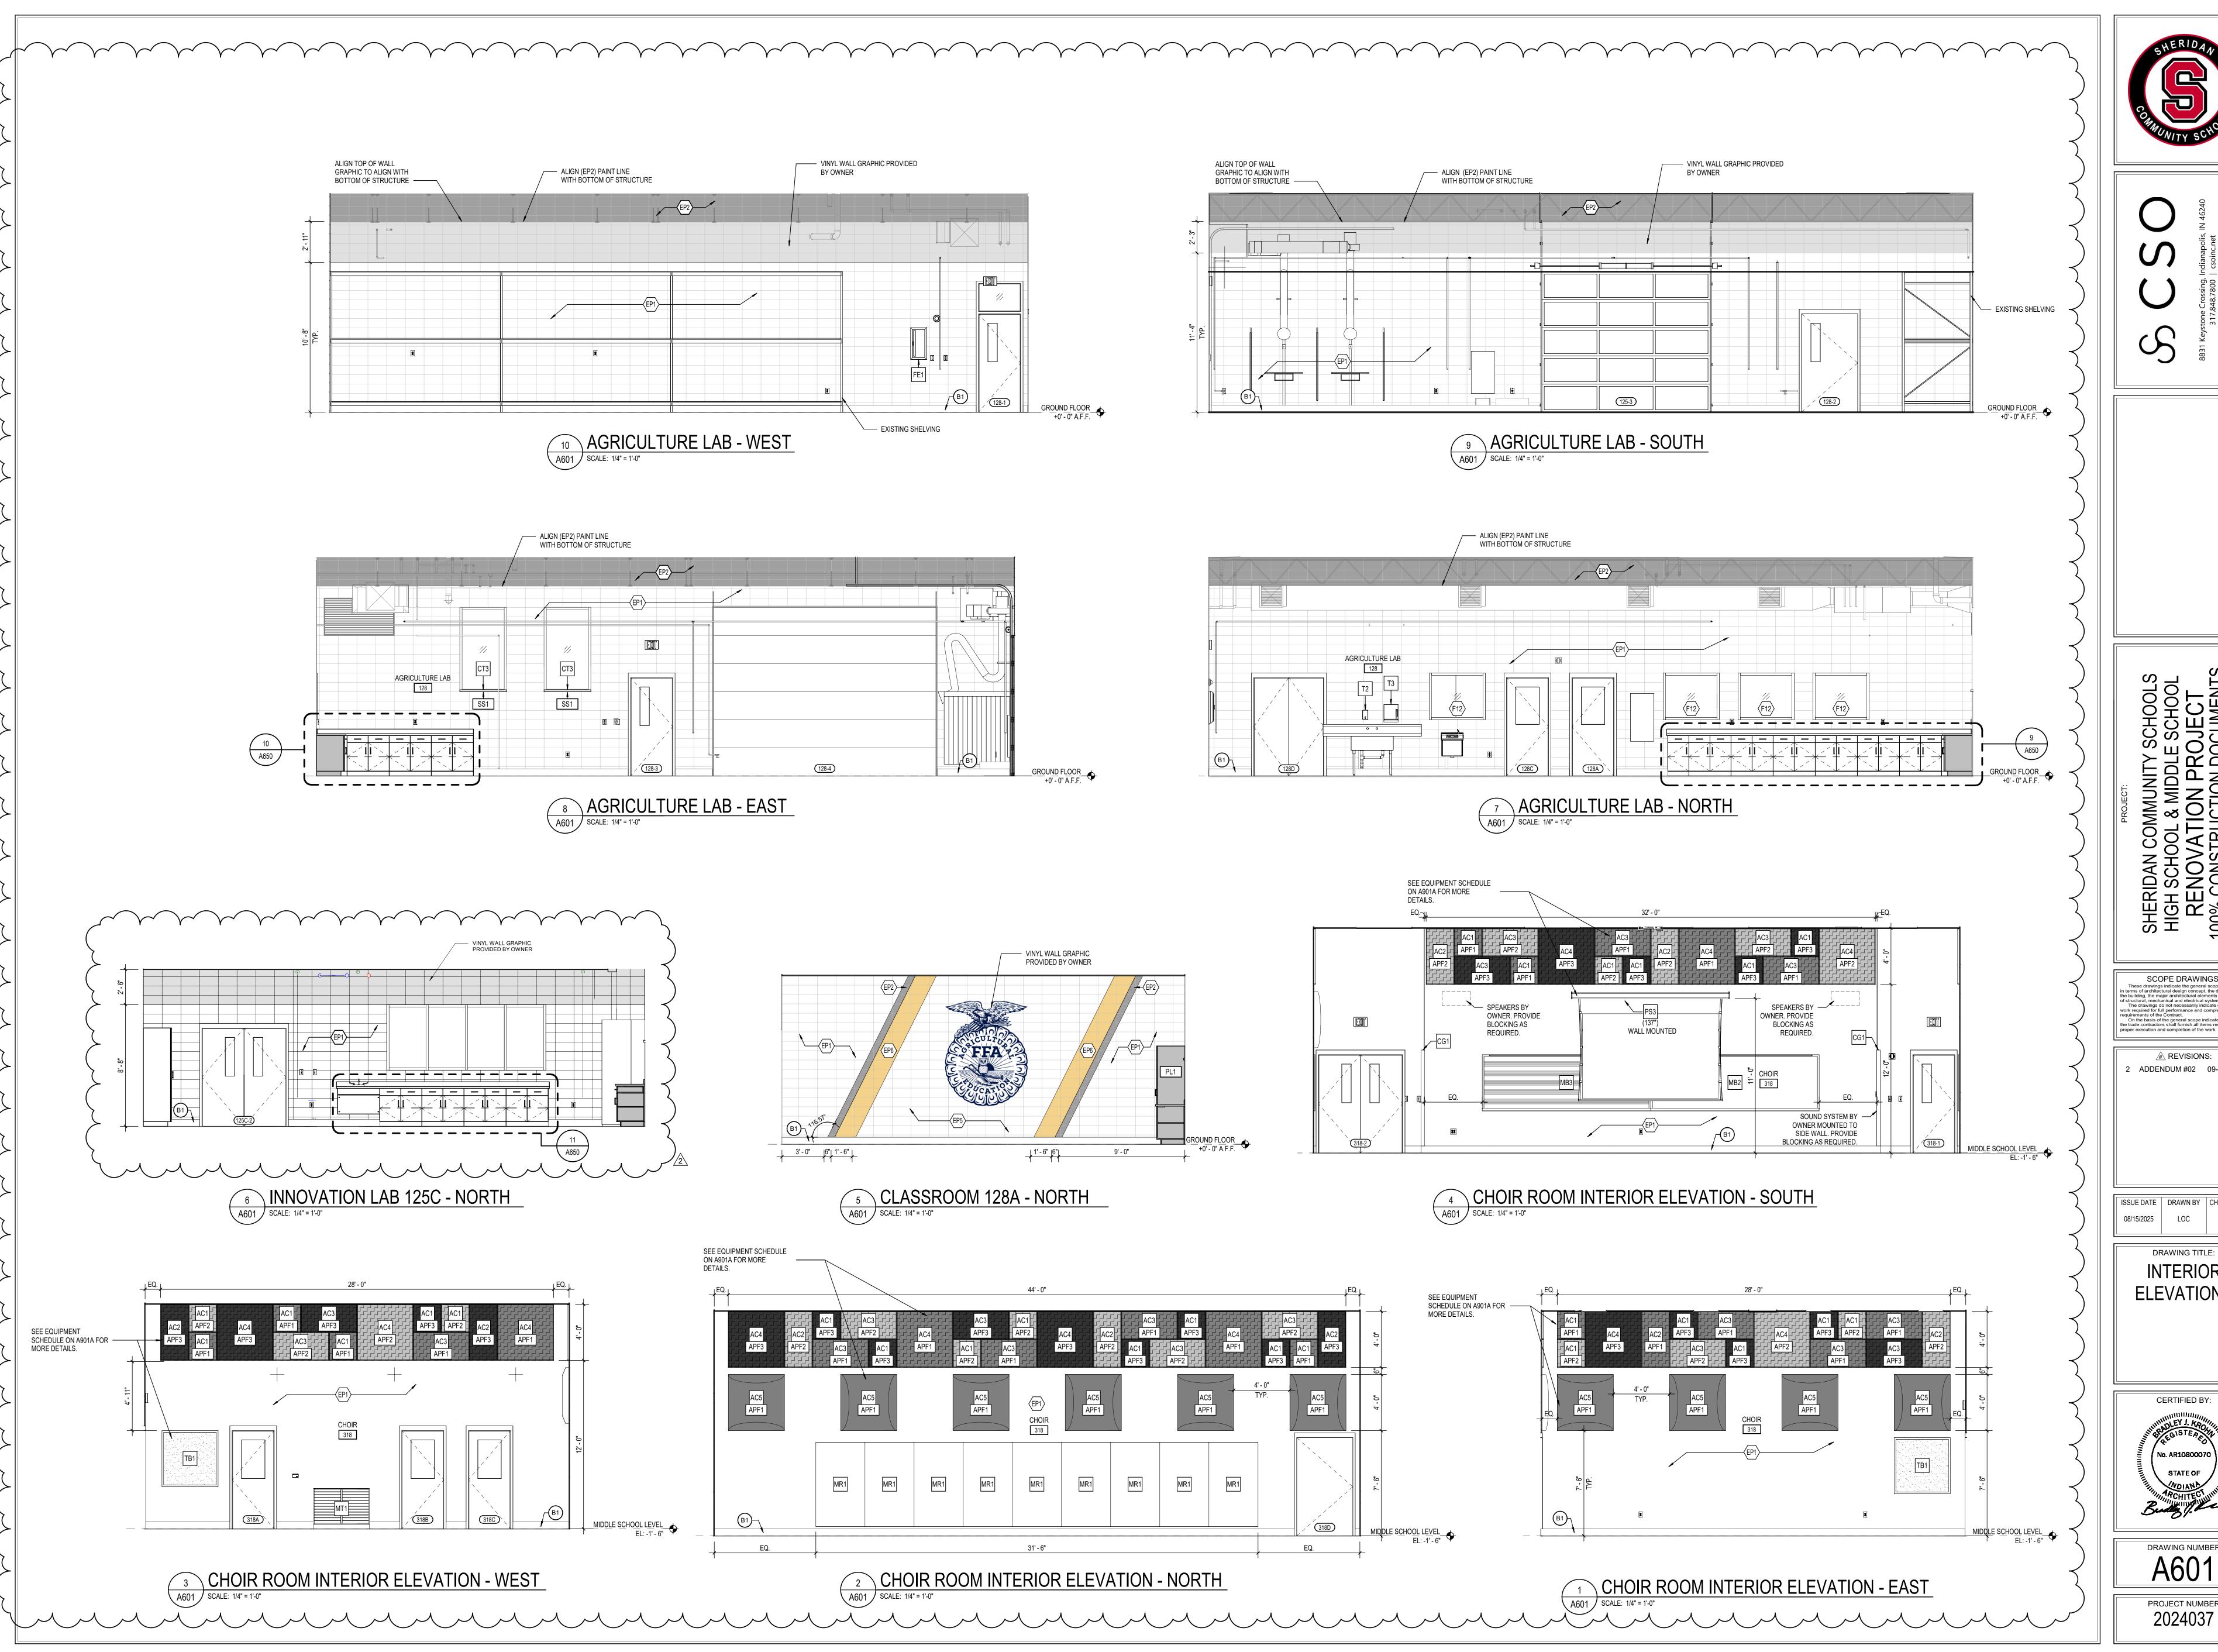
DRAWING TITLE:

UNIT B 
ALTERNATIVE

SCHOOL -

ALTERNATE #03







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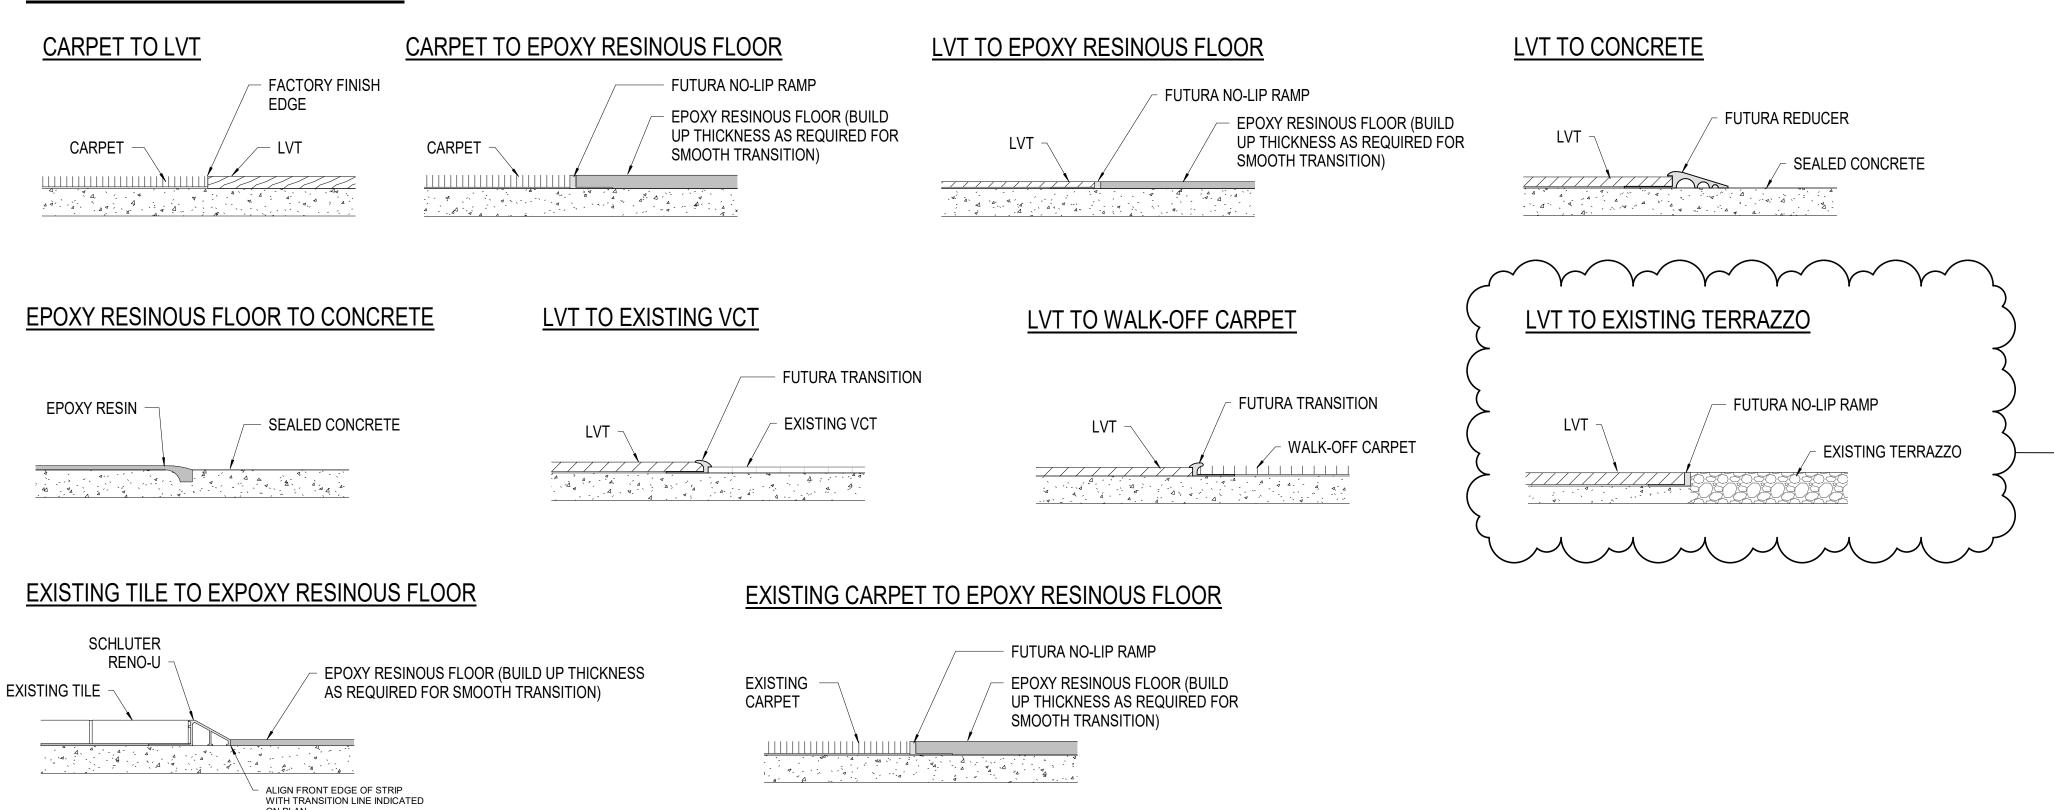
DRAWING TITLE: **INTERIOR ELEVATIONS** 

> CERTIFIED BY: No. AR10800070

STATE OF

DRAWING NUMBER A601 PROJECT NUMBER

#### FLOOR TRANSITION DETAILS



# WALL TRANSITION DETAILS



# FINISH LEGEND

# **FLOOR FINISHES**

EXISTING TO REMAIN

ETR EXISTING TO REMAIN

WALK-OFF CARPET MFR: INTERFACE STYLE: STEP REPEAT SR699 COLOR: GRANITE SIZE: 50 CM X 50 CM INSTALL: QUARTER TURN LOCATION: VESTIBULES

MFR: MOHAWK GROUP STYLE: SIDE STRIPE COLOR: HERITAGE SIZE: 24" X 24" INSTALL: QUARTER TURN (CLASSROOM, RECEPTION); BRICK ASHLAR (PRACTICE ROOMS, OFFICES)

**LUXURY VINYL TILE** LVT1 MFR: INTERFACE STYLE: STUDIO SET 4.5 MM COLOR: A00701 SILVERLIGHT SIZE: 25 CM X 1 M INSTALL: ASHLAR

LOCATION: CORRIDOR

MFR: INTERFACE STYLE: BRUSHED LINES 4.5 MM COLOR: A01605 GRAPHITE SIZE: 25 CM X 1 M INSTALL: ASHLAR LOCATION: CORRIDOR

MFR: MOHAWK GROUP STYLE: BOLDER 5.0 C2108 COLOR: 949 LAVA SIZE: 18" X 36" INSTALL: ASHLAR LOCATION: CLASSROOMS, CAFE

TYPE: SEALED CONCRETE LOCATION: CUSTODIAL, STORAGE, MAKERSPACE, AG LAB NOTE: SEE SPECS

**RESINOUS FLOORING** MFR: TORGINOL PRODUCT: TNEMEC BLEND COLOR: QUARTZ Q206 LOCATION: RESTROOMS, DRY STORAGE, PREP, INNOVATION LAB

MFR: AHF CONTRACT STYLE: ILIAD COLOR: CR017 HUNT PASSION SIZE: 12" X 12" LOCATION: CORRIDOR

MFR: AHF CONTRACT STYLE: ILIAD COLOR: CR005 FALCON GRAY SIZE: 12" X 12" LOCATION: CLASSROOM

#### **WALL BASE**

RUBBER BASE MFR: TARKETT/JOHNSONITE STYLE: RUBBER COVE COLOR: 40 BLACK SIZE: 6"H

MFR: TARKETT/JOHNSONITE STYLE: RUBBER COVE COLOR: 40 BLACK SIZE: 4"H

LOCATION: ALL CASEWORK AND MILLWORK

EPOXY BASE MFR: TORGINOL STYLE: INTREGAL COVE BASE COLOR: MATCH (EF1) SIZE: 4"H LOCATION: INSTALL ONLY W/ (EF1)

#### **WALL FINISHES**

**PAINT** 

MFR: SHERWIN WILLAMS COLOR: SW7064 PASSIVE NOTE: GENERAL PAINT

MFR: SHERWIN WILLIAMS COLOR: SW9163 TIN LIZZIE NOTE: NEUTRAL ACCENT, EXPOSED DECK

MFR: SHERWIN WILLIAMS COLOR: SW6866 HEARTTHROB NOTE: RED ACCENT

COLOR: SW6990 CAVIAR NOTE: HM DOORS/FRAMES, BLACK ACCENT, EXPOSED STRUCTURE MFR: SHERWIN WILLIAMS COLOR: SW7007 CEILING BRIGHT WHITE

MFR: SHERWIN WILLIAMS

MFR: SHERWIN WILLAMS COLOR: SW7064 PASSIVE NOTE: GENERAL PAINT MFR: SHERWIN WILLIAMS COLOR: SW9163 TIN LIZZIE

NOTE: NEUTRAL ACCENT

NOTE: GWB CEILINGS

NOT USED

MFR: SHERWIN WILLIAMS COLOR: SW6990 CAVIAR NOTE: BLACK ACCENT

MFR: SHERWIN WILLIAMS COLOR: SW7005 PURE WHITE NOTE: NEUTRAL ACCENT MFR: SHERWIN WILLIAMS

NOTE: YELLOW ACCENT MFR: SHERWIN WILLIAMS COLOR: SW6244 NAVAL NOTE: NAVY ACCENT

MFR: SHERWIN WILLIAMS COLOR: SW 6253 OLYMPUS WHITE NOTE: EXISTING CORRIDOR PAINT

COLOR: SW6684 BRITTLEBUSH

#### **WALL FINISHES**

WALLCOVERING - VINYL MFR: DESIGNTEX COLLECTION: PEBBLE 8300-201 COLOR: HEMATITE INSTALL: REVERSE HANG LOCATION: RECEPTION

WALL TILE

MFR: ATLAS CONCORDE/ LOUISVILLE TILE STYLE: COVE TERRA COLOR: BLACK FINISH: MATTE SIZE: 12" X 24" INSTALL: HORIZONTAL STACK BOND, U.N.O ON

MFR: PLATFORM SURFACES STYLE: CARAMELLA COLOR: LIQUORICE GLOSSY SIZE: 12" X 12" INSTALL: VERTICAL STACK BOND LOCATION: RESTROOMS, WATER FOUNTAINS

LOCATION: CAFE, RESTROOMS

MFR: PLATFORM SURFACES STYLE: FLOURISH COLOR: NOIR TEXTURED FINISH: MATTE SIZE: 3" X 10" INSTALL: HORIZONTAL STACK BOND LOCATION: CAFE

#### **CASEWORK AND COUNTERTOPS** PLASTIC LAMINATE

MFR: WILSONART COLOR: PINNACLE WALNUT 7992-38 FINISH: FINE VELVET FINISH LOCATION: GENERAL CASEWORK, RECEPTION

MFR: FORMICA COLOR: LAYERED WHITE SAND FINISH: SCOVATO TEXTURE LOCATION: COUNTERTOPS

MFR: FORMICA COLOR: BLACK 909-MC FINISH: MICRODOT LOCATION: AGRICULTURE LAB CASEWORK

SOLID SURFACE

MFR: CORIAN COLOR: RAIN CLOUD EDGE: EASED LOCATION: GENERAL COUNTERTOPS, WINDOW STOOLS, RECEPTION, CAFE

MFR: CORIAN COLOR: CARBON AGGREGATE EDGE: EASED LOCATION: RECEPTION

MFR: CORIAN COLOR: HOT LOCATION: TOE KICK

**EPOXY COUNTERTOPS** COLLECTION: EPOXY RESIN BLACK ONYX

LOCATION: INNOVATION LAB, AGRICULTURE LAB

WOOD WD1 SPECIES: HARD MAPLE CUT: SOLID MAPLE BUTCHERBLOCK STAIN: CLEAR LOCATION: MAKERSPACE

**DECORATIVE PANEL** MFR: STACKED WOOD

COLLECTION: NEW ERA COLLECTION TYPE: 2090 FLUTED WALNUT LOCATION: RECEPTION DESK

STAINLESS STEEL TYPE: STAINLESS STEEL NOTE: SEE A901A AND SPECIFICATIONS

#### **MISCELLANEOUS** TACK SURFACE

MFR: FORBO COLOR: 2206 OYSTER SHELL LOCATION: RECEPTION, CHOIR

ACOUSTIC PANEL FABRIC

MFR: GUILFORD OF MAINE STYLE: PALETTE 2155 COLOR: IRON 1134 LOCATION: CHOIR NOTE: DARK GRAY

MFR: GUILFORD OF MAINE STYLE: SPINEL 3582 COLOR: PETOSKEY 056 LOCATION: CHOIR

NOTE: BLACK

NOTE: LIGHT GRAY MFR: GUILFORD OF MAINE STYLE: ANCHORAGE 2335 COLOR: GRAPHITE 2079 LOCATION: CHOIR

> ACCOUSTIC BAFFLES MFR: TURF STYLE: WEDGE COLOR: BLACK

> > LOCATION: SEE A210A MFR: TURF STYLE: WEDGE COLOR: DAMASCUS

> > > LOCATION: SEE A210A

MFR: TURF STYLE: WEDGE COLOR: RED LOCATION: SEE A210A

#### GENERAL FINISH NOTES

ANY DISCREPANCIES WITHIN THE DOCUMENTS SHOULD BE BROUGHT TO THE ATTENTION OF CSO ARCHITECTS PRIOR TO INSTALLATION. THESE DOCUMENTS WILL GOVERN OVER PREVIOUS SUPPLEMENTAL DRAWINGS.

THE SCHEDULED MATERIALS SHALL NOT BE INSTALLED BEFORE THE CONTRACTOR'S PHYSICAL COLOR SAMPLE SUBMITTALS HAVE BEEN APPROVED, AS REQUIRED BY THE SPECIFICATIONS. IF ANY MATERIAL IS INSTALLED BEFORE APPROVAL, THE CONTRACTOR WILL BE RESPONSIBLE FOR THE REMOVAL, REPLACEMENT PURCHASE, AND INSTALLATION OF ALL ERRONEOUS

SPECIFICATIONS. ALL SURFACES RECEIVING FINISHES SHALL BE PROPERLY PREPARED PER

TO REMAIN SURFACES SHALL BE PROPERLY CLEANED.

MANUFACTURERS' SPECIFICATIONS PRIOR TO INSTALLATION. CONTRACTOR SHALL BE RESPONSIBLE FOR FIELD VERIFYING CONDITIONS. 4. CONTRACTOR RESPONSIBLE FOR PROTECTING INSTALLED FINISHES AND FINISHES EXISTING TO REMAIN DURING CONSTRUCTION PROCESS. ALL EXISTING

. WHERE DEMOLITION OCCURS, SURFACE TO BE PROPERLY PATCHED AND REPAIRED TO MATCH SURROUNDING SURFACES BEFORE FINISH IS APPLIED. 6. FOR CHANGE IN FLOOR FINISH MATERIALS OF DIFFERENT HEIGHTS, PROVIDE TRANSITION STRIP TO MEET CODE/ADA REQUIREMENTS. IF TRANSITIONING AT DOOR OPENING, TRANSITION TO BE ON CENTER OF DOOR LEAF/PANEL, U.N.O. SEE TRANSITION DETAILS ON A800 FOR ADDITIONAL INFORMATION. WHERE CARPET TILE AND LVT TRANSITIONS OCCUR, INSTALL FACTORY FINISHED

EDGE OF CARPET TO FACTORY FINISHED EDGE OF LVT; DO NOT USE CUT EDGES AT ANY TRANSITIONS. 8. SEE INTERIOR PAINT SPECIFICATIONS FOR SCHEDULE OF COATING TYPE PER SUBSTRATE AND SHEEN. CONTRACTOR TO PROVIDE CRISP, CLEAN LINES BETWEEN ALL PAINT TRANSITIONS.

9. ALL CMU WALLS TO RECEIVE HIGH PERFORMANCE COATINGS, SEE PAINT SPECIFICATIONS FOR ADDITIONAL INFORMATION. 10. ALL EXPOSED STRUCTURAL ELEMENTS TO BE PAINTED (P4), U.N.O. SEE

SPECIFICATIONS FOR ADDITIONAL INFORMATION. 11 RFMOVFD 12. ALL WALL-MOUNTED GRILLES, METAL PANELS, MISC, PANELS, ETC, ARE TO BE FACTORY FINISHED TO MATCH ADJACENT WALLS, U.N.O. 13. ALL GWB SOFFITS/BULKHEADS' VERTICAL FACES PAINTED TO MATCH ADJACENT

WALLS AND UNDERSIDE TO BE PAINTED (P5), U.N.O. REFER TO REFLECTED CEILING PLANS AND SPECIFICATIONS FOR ALL CEILING MATERIALS, THEIR LOCATIONS, AND ADDITIONAL INFORMATION. 14. PAINT WALLS BEFORE INSTALLING MARKER BOARDS, TACKBOARDS, ETC.

15. ALL HOLLOW METAL DOORS & FRAMES ARE TO BE PAINTED (EP4). 16. WOOD DOORS ARE TO BE WHITE BIRCH, CLEAR FINISH. REFER TO SPECIFICATIONS FOR STAIN AND ADDITIONAL INFORMATION. 17. FOR CORNER GUARDS, REFER TO SPECIFICATIONS AND A900 SERIES FOR INFORMATION AND LOCATIONS, COLORS TO BE SELECTED FROM

MANUFACTURER'S FULL RANGE, U.N.O. IN FINISH LEGEND ON A800. CORNER GUARDS TO BE APPLIED TO GWB ONLY. 18. ALL NEW WINDOW STOOLS TO BE (SS1). REFER TO A400 SERIES FOR WINDOW SECTIONS AND DETAILS.

19. WHERE WALL TILE OCCURS, ALL OUTSIDE CORNERS AND EXPOSED TILE EDGES ARE TO BE TRIMMED WITH SCHLUTER JOLLY IN BRUSHED STAINLESS STEEL FINISH. SEE WALL TRANSITION DETAILS ON A800.

WALL TILE TO BE INSTALLED WITH THE MINIMUM RECOMMENDED GROUT THICKNESS. GROUT COLOR TO BE SELECTED FROM MANUFACTURER'S FULL RANGE. REFER TO SPECIFICATIONS FOR ADDITIONAL INFORMATION.

21. ALL CMU WALLS TO RECEIVE (B1). 22. PAINT ALL SURFACE-MOUNTED CONDUIT TO MATCH ADJACENT WALL FINISH.

#### **FINISH TAG KEY**

(XXX) FLOOR FINISH

XX BASE FINISH

WALL FINISH

HORIZONTAL FINISH (COUNTERTOP) VERTICAL FINISH (CASEWORK)

COUNTERTOP, CASEWORK OR MISCELLANEOUS FINISH ONLY REFER TO FINISH LEGEND

XX ACCENT WALL FINISH

FLOORING INSTALL DIRECTION

#### FINISH PLAN NOTES

F1 NO WORK IN THIS AREA, UNLESS NOTED OTHERWISE F2 ALIGN FLOOR TRANSITION TO OUTSIDE CORNER AS INDICATED ON PLAN. F3 PATCH/REPAIR FLOOR AND WALL AS REQUIRED BY DEMOLITION AND NEW

CONSTRUCTION TO MATCH EXISITING. F4 WALL TILE (WT2) TO BE INSTALLED FULL-HEIGHT, VERTICALLY; REFER TO WALL TILE

TO FLOOR FINISH TRANSITION ON A800 FOR TRANSITION DETAIL. F5 WALL TILE (WT1) TO BE INSTALLED FULL-HEIGHT, VERTICALLY; REFER TO WALL TILE

TRANSITION ON A800 FOR TRANSITION DETAIL.

F6 EXISTING SEALED CONCRETE TO BE GRINDED AND RESEALED. F7 PROTECT EXISTING TERRAZZO; PATCH TO MATCH ADJACENT TERRAZZO IF

F8 NEW WINDOW STOOL LOCATIONS TO RECEIVE (SS1). F9 INSTALL WALL TILE (WT1) HORIZONTALLY STACKED (5) FULL COURSES HIGH. TRIM

EXPOSED TILE EDGES W/ SCHLUTER JOLLY; INSTALL SCHLUTER DILEX-AHKA AT WALL TILE TO FLOOR FINISH TRANSITION.

F16 GRIND DOWN FLOOR SLAB UP TO 12" FROM FLOORING TRANSITION TO CREATE

F10 PATCH FLOOR AS REQUIRED BY DEMOLITION W/ (VCT1). F11 PATCH FLOOR AS REQUIRED BY DEMOLITION W/ (VCT2).

F12 EXISTING GARAGE DOOR TO RECEIVE PAINT (EP1) ON INTERIOR FACE ONLY. F13 CUSTODIAL MOP SINK LOCATION TO RECEIVE FRP. LENGTH AS NECESSARY, MINIMUM OF 2'0" ON EITHER SIDE OF SINK. FRP TO START AT TOP OF BASE AND

RUN FULL PANEL WIDTH (4'-0"). COLOR TO BE SELECTED FROM MANUFACTURER'S FULL RANGE. REFER TO 06 64 00 FOR SPECIFICATION. F14 WALL TILE (WT1) TO WRAP INSIDE OF OPENING ON HEAD AND JAMBS. F15 REFER TO FOOD SERVICE DRAWINGS FOR KITCHEN EQUIPMENT.

FLUSH TRANSITION.

structural, mechanical and electrical systems.
The drawings do not necessarily indicate or describe a equirements of the Contract.
On the basis of the general scope indicated or descri proper execution and completion of the work.

> # REVISIONS: ADDENDUM #01 09-05-2025 2 ADDENDUM #02 09-12-2025

SCOPE DRAWINGS:

ISSUE DATE | DRAWN BY | CHECKED BY


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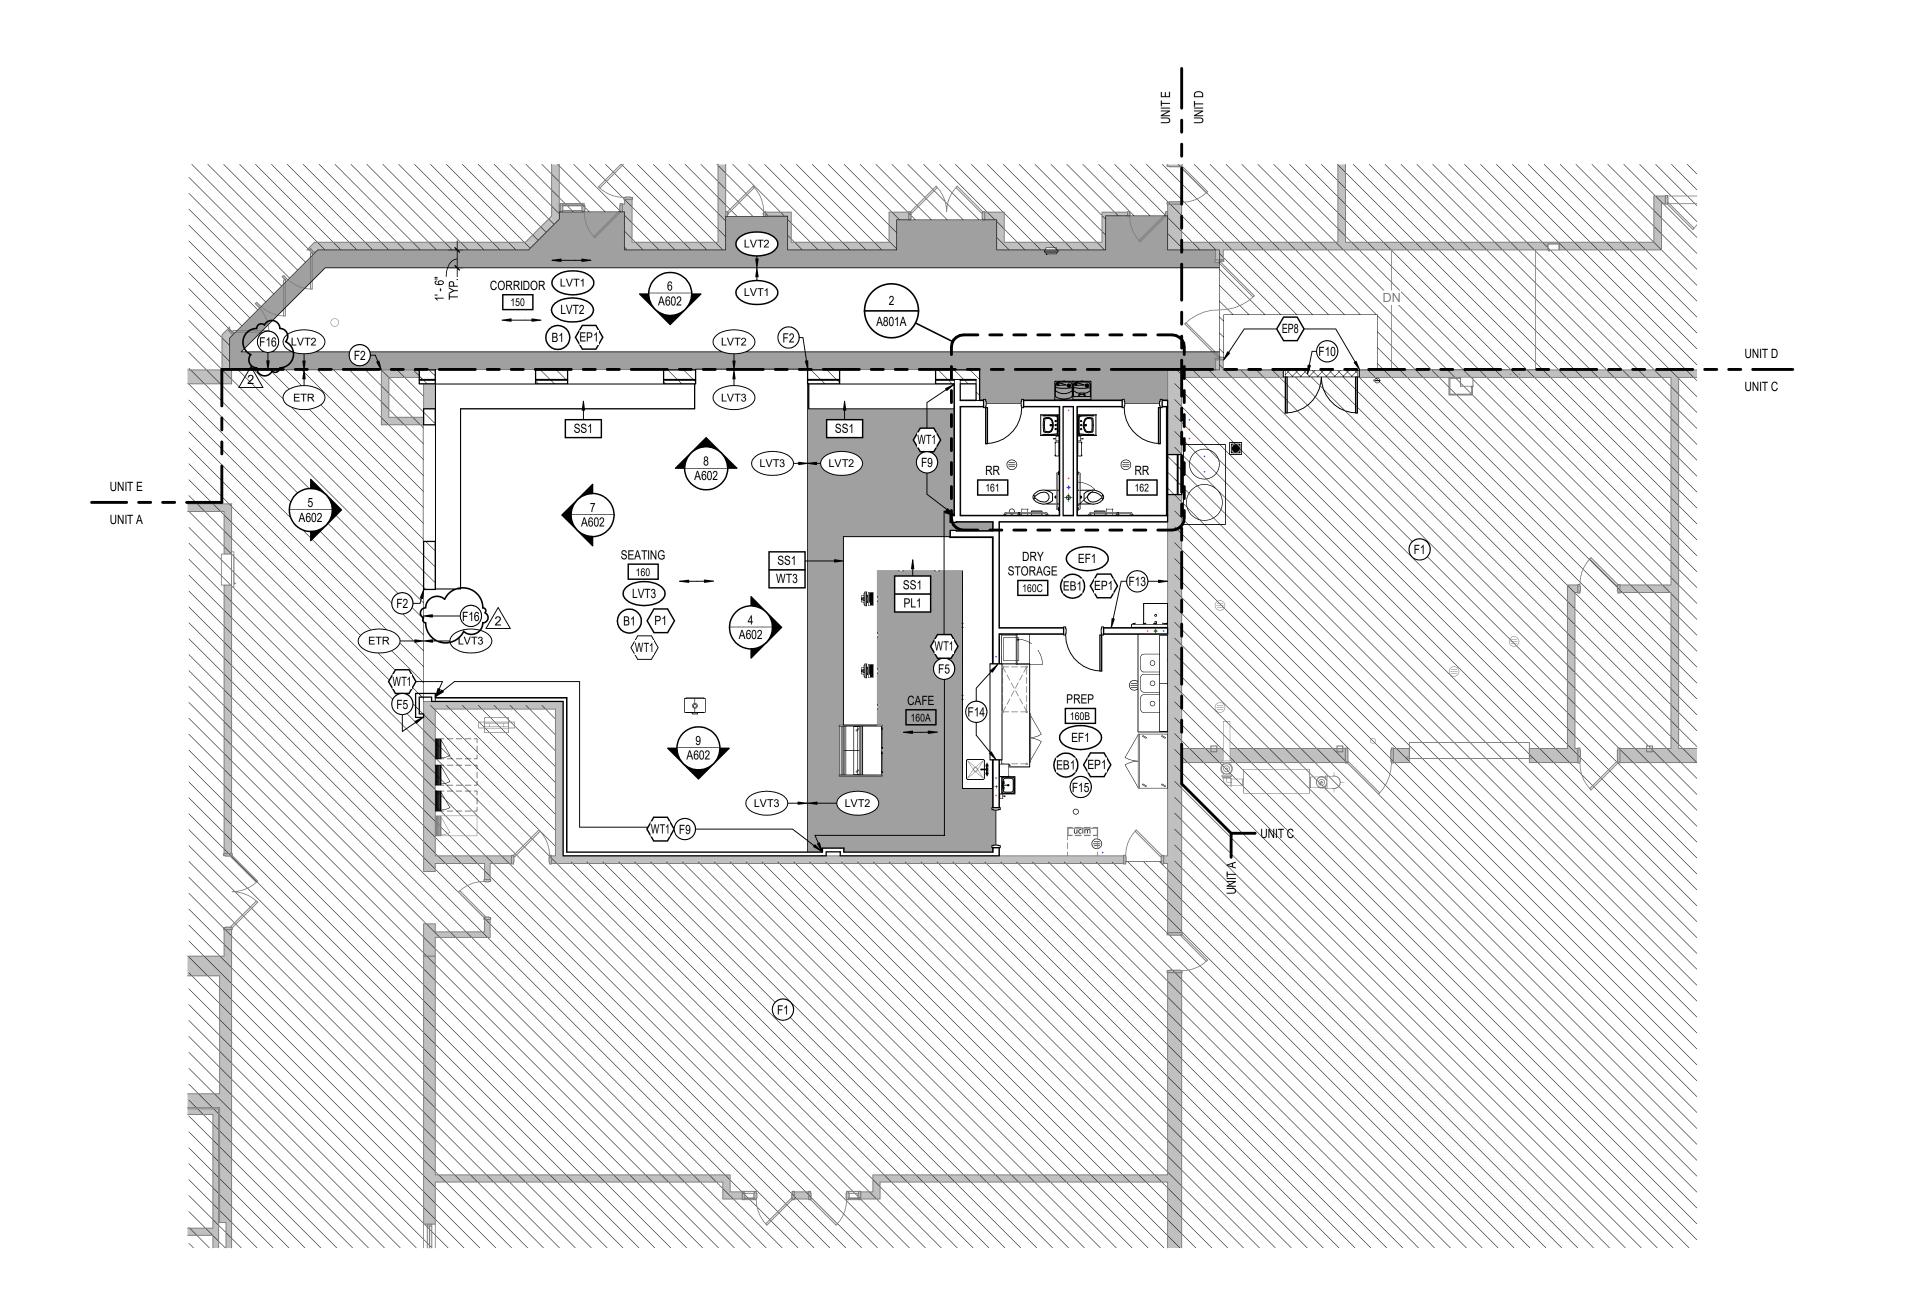
DRAWING TITLE: FINISH LEGEND

> CERTIFIED BY: No. AR10800070

DRAWING NUMBER





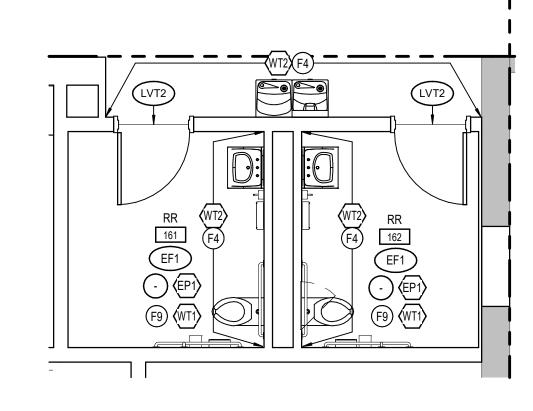

GROUND FLOOR - FINISH PLAN - UNIT A

SCALE: 1/8" = 1'-0"

### GENERAL FINISH NOTES

- ANY DISCREPANCIES WITHIN THE DOCUMENTS SHOULD BE BROUGHT TO THE ATTENTION OF CSO ARCHITECTS PRIOR TO INSTALLATION. THESE DOCUMENTS
- WILL GOVERN OVER PREVIOUS SUPPLEMENTAL DRAWINGS. 2. THE SCHEDULED MATERIALS SHALL NOT BE INSTALLED BEFORE THE CONTRACTOR'S PHYSICAL COLOR SAMPLE SUBMITTALS HAVE BEEN APPROVED. AS REQUIRED BY THE SPECIFICATIONS. IF ANY MATERIAL IS INSTALLED BEFORE APPROVAL, THE CONTRACTOR WILL BE RESPONSIBLE FOR THE REMOVAL, REPLACEMENT PURCHASE, AND INSTALLATION OF ALL ERRONEOUS
- SPECIFICATIONS. 3. ALL SURFACES RECEIVING FINISHES SHALL BE PROPERLY PREPARED PER MANUFACTURERS' SPECIFICATIONS PRIOR TO INSTALLATION. CONTRACTOR
- SHALL BE RESPONSIBLE FOR FIELD VERIFYING CONDITIONS. 4. CONTRACTOR RESPONSIBLE FOR PROTECTING INSTALLED FINISHES AND
- FINISHES EXISTING TO REMAIN DURING CONSTRUCTION PROCESS. ALL EXISTING TO REMAIN SURFACES SHALL BE PROPERLY CLEANED.
- 5. WHERE DEMOLITION OCCURS, SURFACE TO BE PROPERLY PATCHED AND REPAIRED TO MATCH SURROUNDING SURFACES BEFORE FINISH IS APPLIED.
- 6. FOR CHANGE IN FLOOR FINISH MATERIALS OF DIFFERENT HEIGHTS, PROVIDE TRANSITION STRIP TO MEET CODE/ADA REQUIREMENTS. IF TRANSITIONING AT DOOR OPENING, TRANSITION TO BE ON CENTER OF DOOR LEAF/PANEL, U.N.O. SEE TRANSITION DETAILS ON A800 FOR ADDITIONAL INFORMATION.
- 7. WHERE CARPET TILE AND LVT TRANSITIONS OCCUR, INSTALL FACTORY FINISHED EDGE OF CARPET TO FACTORY FINISHED EDGE OF LVT; DO NOT USE CUT EDGES AT ANY TRANSITIONS. 8. SEE INTERIOR PAINT SPECIFICATIONS FOR SCHEDULE OF COATING TYPE PER
- SUBSTRATE AND SHEEN. CONTRACTOR TO PROVIDE CRISP, CLEAN LINES BETWEEN ALL PAINT TRANSITIONS. 9. ALL CMU WALLS TO RECEIVE HIGH PERFORMANCE COATINGS, SEE PAINT SPECIFICATIONS FOR ADDITIONAL INFORMATION.
- 10. ALL EXPOSED STRUCTURAL ELEMENTS TO BE PAINTED (P4), U.N.O. SEE SPECIFICATIONS FOR ADDITIONAL INFORMATION. 11. REMOVED.
- 12. ALL WALL-MOUNTED GRILLES, METAL PANELS, MISC. PANELS, ETC. ARE TO BE FACTORY FINISHED TO MATCH ADJACENT WALLS, U.N.O. 13. ALL GWB SOFFITS/BULKHEADS' VERTICAL FACES PAINTED TO MATCH ADJACENT WALLS AND UNDERSIDE TO BE PAINTED (P5), U.N.O. REFER TO REFLECTED

CEILING PLANS AND SPECIFICATIONS FOR ALL CEILING MATERIALS, THEIR

- LOCATIONS, AND ADDITIONAL INFORMATION. 14. PAINT WALLS BEFORE INSTALLING MARKER BOARDS, TACKBOARDS, ETC. 15. ALL HOLLOW METAL DOORS & FRAMES ARE TO BE PAINTED (EP4). 16. WOOD DOORS ARE TO BE WHITE BIRCH, CLEAR FINISH. REFER TO
- SPECIFICATIONS FOR STAIN AND ADDITIONAL INFORMATION. 17. FOR CORNER GUARDS, REFER TO SPECIFICATIONS AND A900 SERIES FOR INFORMATION AND LOCATIONS. COLORS TO BE SELECTED FROM
- MANUFACTURER'S FULL RANGE, U.N.O. IN FINISH LEGEND ON A800. CORNER GUARDS TO BE APPLIED TO GWB ONLY. 18. ALL NEW WINDOW STOOLS TO BE (SS1). REFER TO A400 SERIES FOR WINDOW
- SECTIONS AND DETAILS. 19. WHERE WALL TILE OCCURS, ALL OUTSIDE CORNERS AND EXPOSED TILE EDGES
- ARE TO BE TRIMMED WITH SCHLUTER JOLLY IN BRUSHED STAINLESS STEEL FINISH. SEE WALL TRANSITION DETAILS ON A800. 20. WALL TILE TO BE INSTALLED WITH THE MINIMUM RECOMMENDED GROUT
- THICKNESS. GROUT COLOR TO BE SELECTED FROM MANUFACTURER'S FULL RANGE. REFER TO SPECIFICATIONS FOR ADDITIONAL INFORMATION. 21. ALL CMU WALLS TO RECEIVE (B1). 22. PAINT ALL SURFACE-MOUNTED CONDUIT TO MATCH ADJACENT WALL FINISH.

# **FINISH TAG KEY**

XXX FLOOR FINISH

BASE FINISH

XX WALL FINISH

XXX HORIZONTAL FINISH (COUNTERTOP)

COUNTERTOP, CASEWORK OR MISCELLANEOUS FINISH ONLY REFER TO FINISH LEGEND

ACCENT WALL FINISH

FLOORING INSTALL DIRECTION


#### FINISH PLAN NOTES

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- WALL TILE TO FLOOR FINISH TRANSITION. F10 PATCH FLOOR AS REQUIRED BY DEMOLITION W/ (VCT1).
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- F12 EXISTING GARAGE DOOR TO RECEIVE PAINT (EP1) ON INTERIOR FACE ONLY. F13 CUSTODIAL MOP SINK LOCATION TO RECEIVE FRP. LENGTH AS NECESSARY. MINIMUM OF 2'0" ON EITHER SIDE OF SINK. FRP TO START AT TOP OF BASE AND

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KEY PLAN



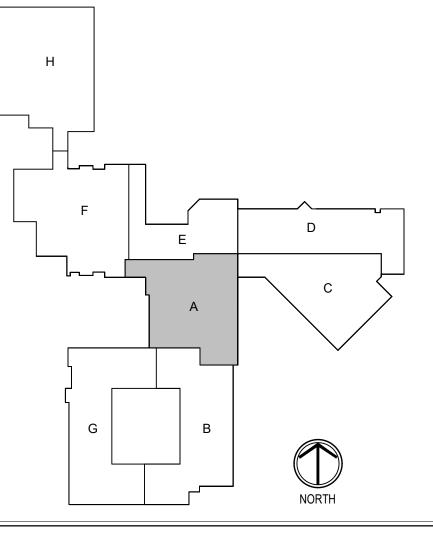

SCOPE DRAWINGS:

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> # REVISIONS: ADDENDUM #01 09-05-2025 ADDENDUM #02 09-12-2025

ISSUE DATE DRAWN BY CHECKED BY

LOC


08/15/2025

DRAWING TITLE: GROUND FLOOR FINISH PLAN -UNIT A

CERTIFIED BY:

DRAWING NUMBER PROJECT NUMBER

2024037

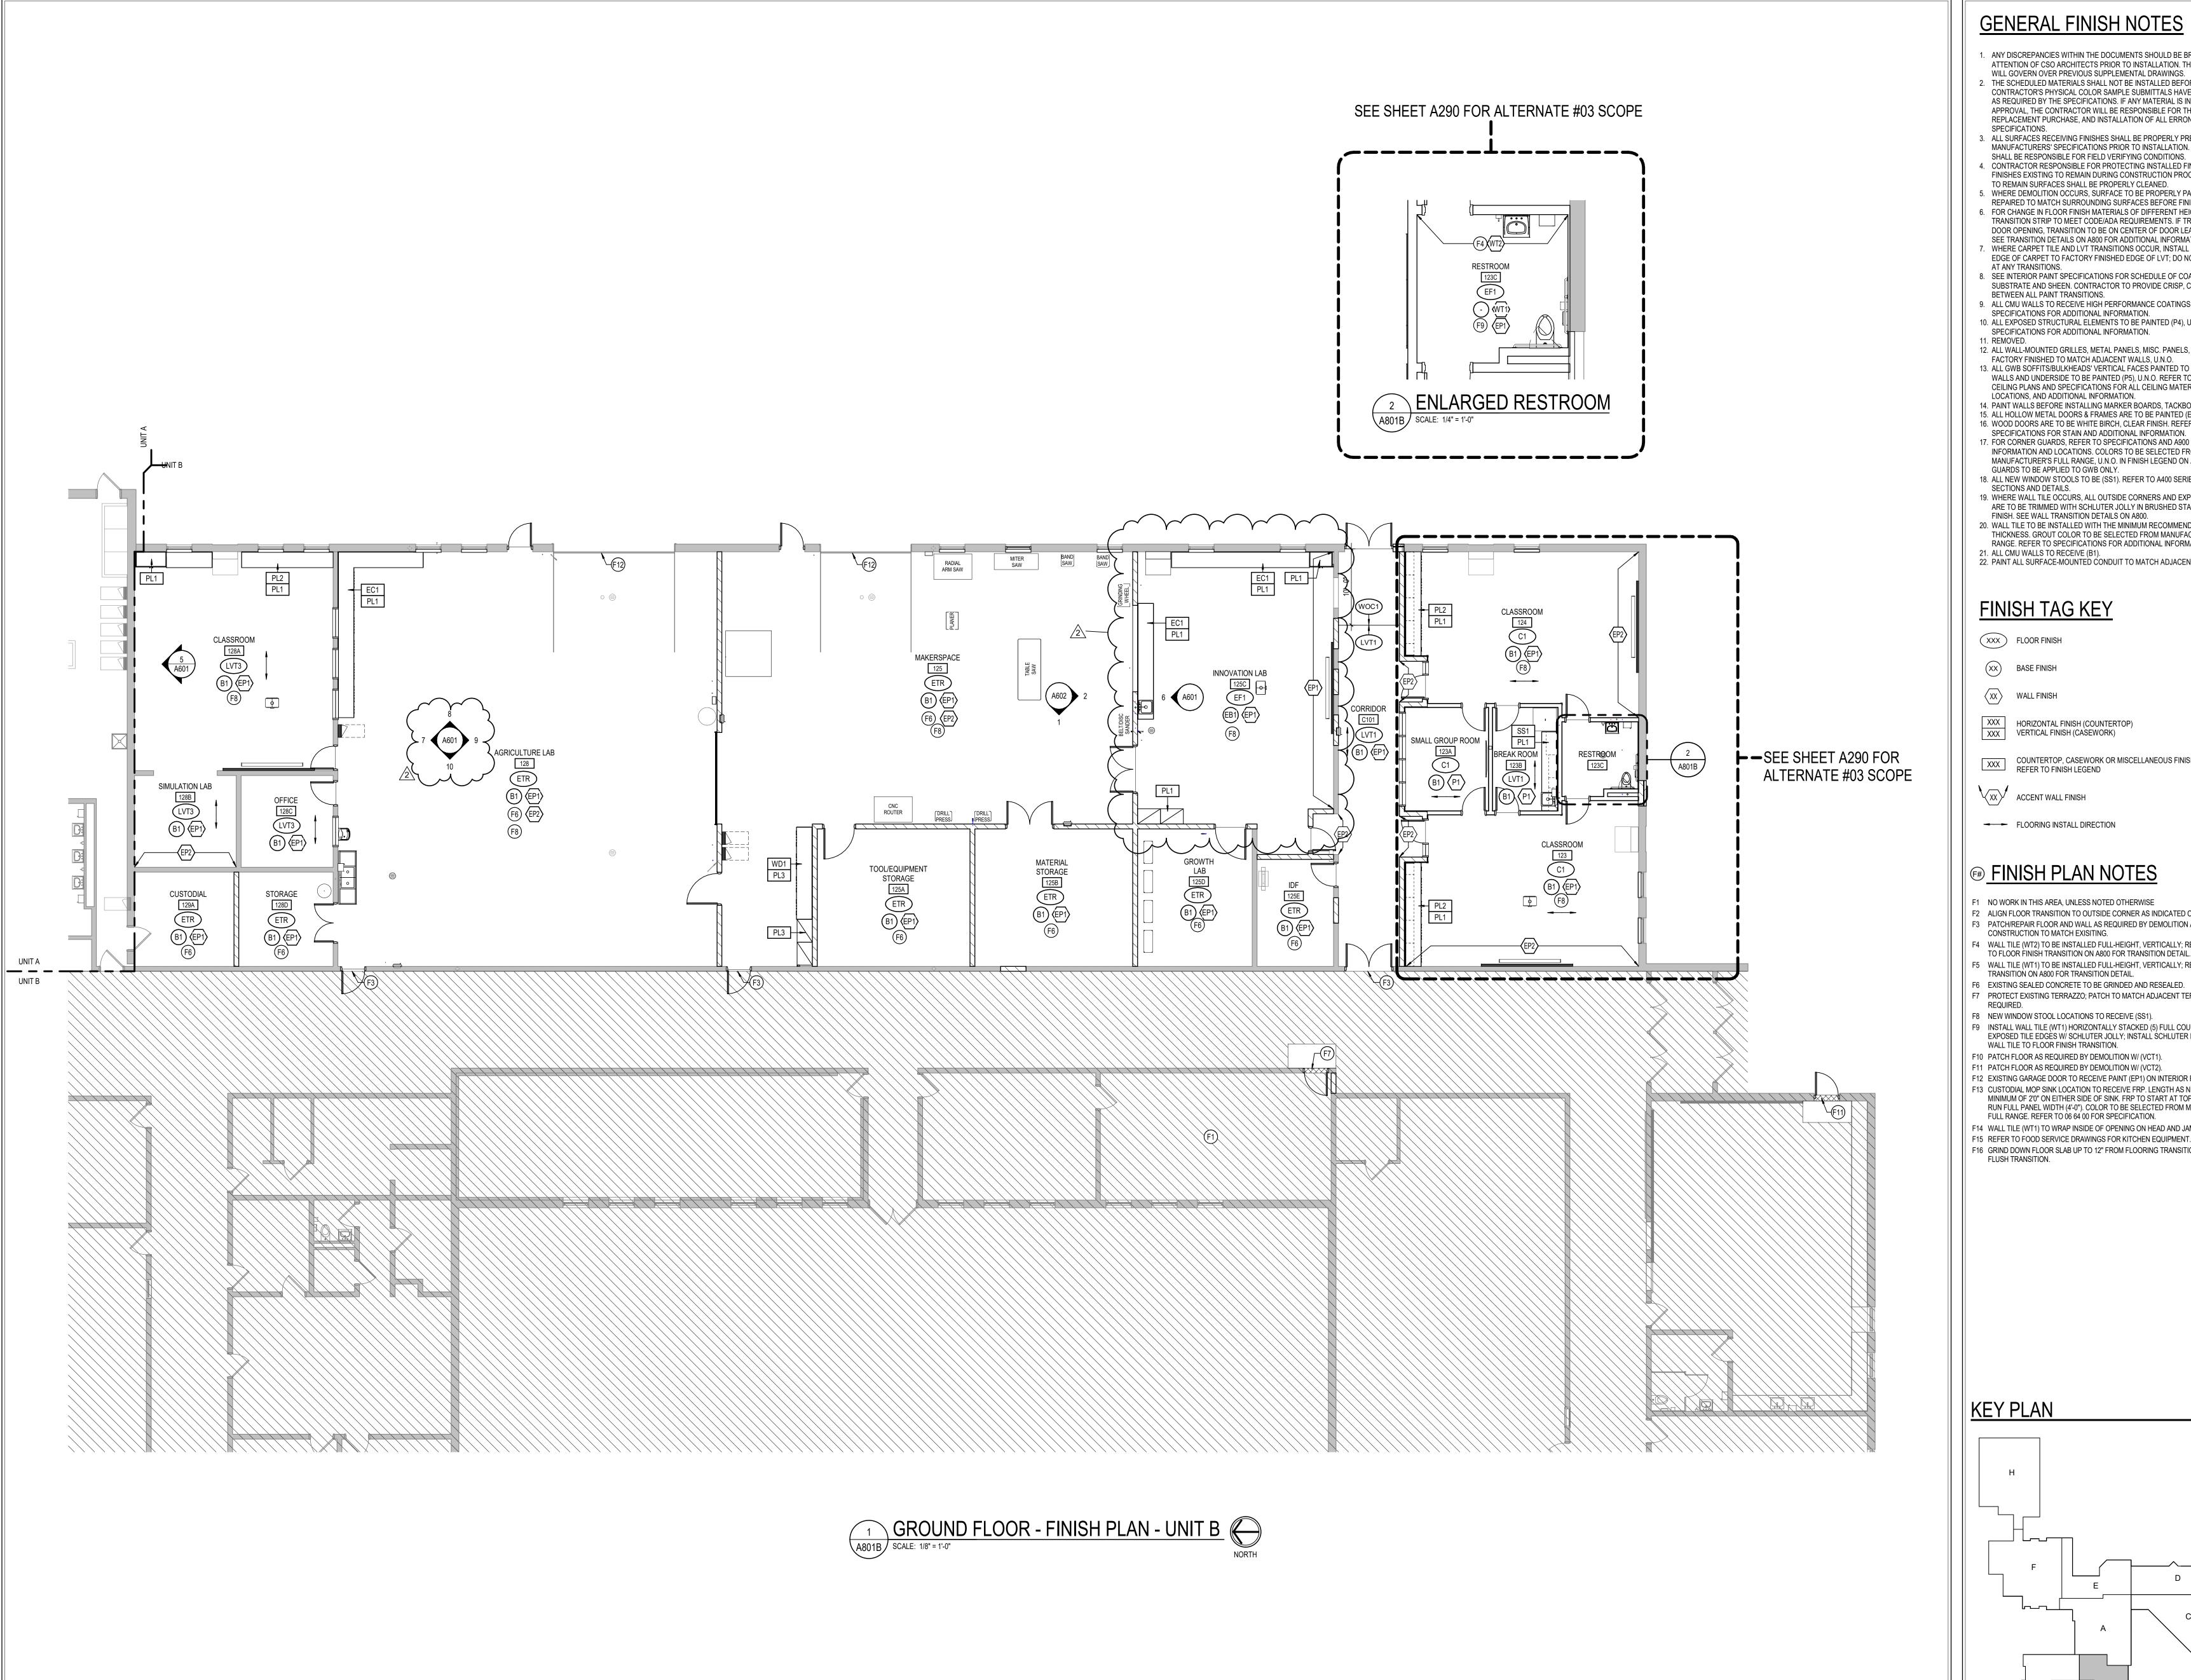

### **GENERAL FINISH NOTES**

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- BETWEEN ALL PAINT TRANSITIONS. 9. ALL CMU WALLS TO RECEIVE HIGH PERFORMANCE COATINGS, SEE PAINT SPECIFICATIONS FOR ADDITIONAL INFORMATION.
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- 12. ALL WALL-MOUNTED GRILLES, METAL PANELS, MISC. PANELS, ETC. ARE TO BE FACTORY FINISHED TO MATCH ADJACENT WALLS, U.N.O. 13. ALL GWB SOFFITS/BULKHEADS' VERTICAL FACES PAINTED TO MATCH ADJACENT
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- 19. WHERE WALL TILE OCCURS, ALL OUTSIDE CORNERS AND EXPOSED TILE EDGES ARE TO BE TRIMMED WITH SCHLUTER JOLLY IN BRUSHED STAINLESS STEEL FINISH. SEE WALL TRANSITION DETAILS ON A800.
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# **FINISH TAG KEY**

XXX FLOOR FINISH

XX BASE FINISH

XX WALL FINISH

XXX HORIZONTAL FINISH (COUNTERTOP) XXX VERTICAL FINISH (CASEWORK)

COUNTERTOP, CASEWORK OR MISCELLANEOUS FINISH ONLY REFER TO FINISH LEGEND


XX ACCENT WALL FINISH

FLOORING INSTALL DIRECTION

#### FINISH PLAN NOTES

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- F8 NEW WINDOW STOOL LOCATIONS TO RECEIVE (SS1). F9 INSTALL WALL TILE (WT1) HORIZONTALLY STACKED (5) FULL COURSES HIGH. TRIM EXPOSED TILE EDGES W/ SCHLUTER JOLLY; INSTALL SCHLUTER DILEX-AHKA AT WALL TILE TO FLOOR FINISH TRANSITION.
- F10 PATCH FLOOR AS REQUIRED BY DEMOLITION W/ (VCT1).
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- F14 WALL TILE (WT1) TO WRAP INSIDE OF OPENING ON HEAD AND JAMBS. F15 REFER TO FOOD SERVICE DRAWINGS FOR KITCHEN EQUIPMENT.
- F16 GRIND DOWN FLOOR SLAB UP TO 12" FROM FLOORING TRANSITION TO CREATE FLUSH TRANSITION.

# KEY PLAN

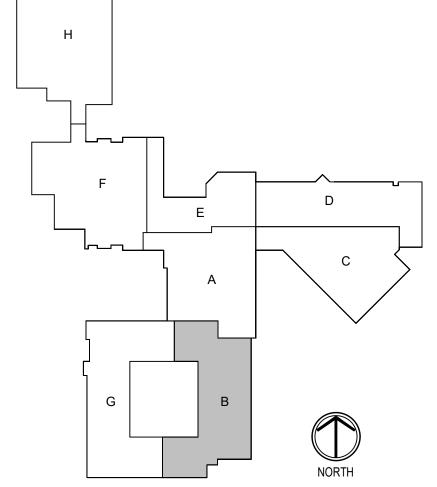



SCOPE DRAWINGS:
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ADDENDUM #01 09-05-2025 2 ADDENDUM #02 09-12-2025


# REVISIONS:

ISSUE DATE | DRAWN BY | CHECKED BY 08/15/2025 LOC

DRAWING TITLE: GROUND FLOOR FINISH PLAN -**UNIT B** 

> CERTIFIED BY: No. AR10800070 STATE OF

DRAWING NUMBER A801B PROJECT NUMBER 2024037

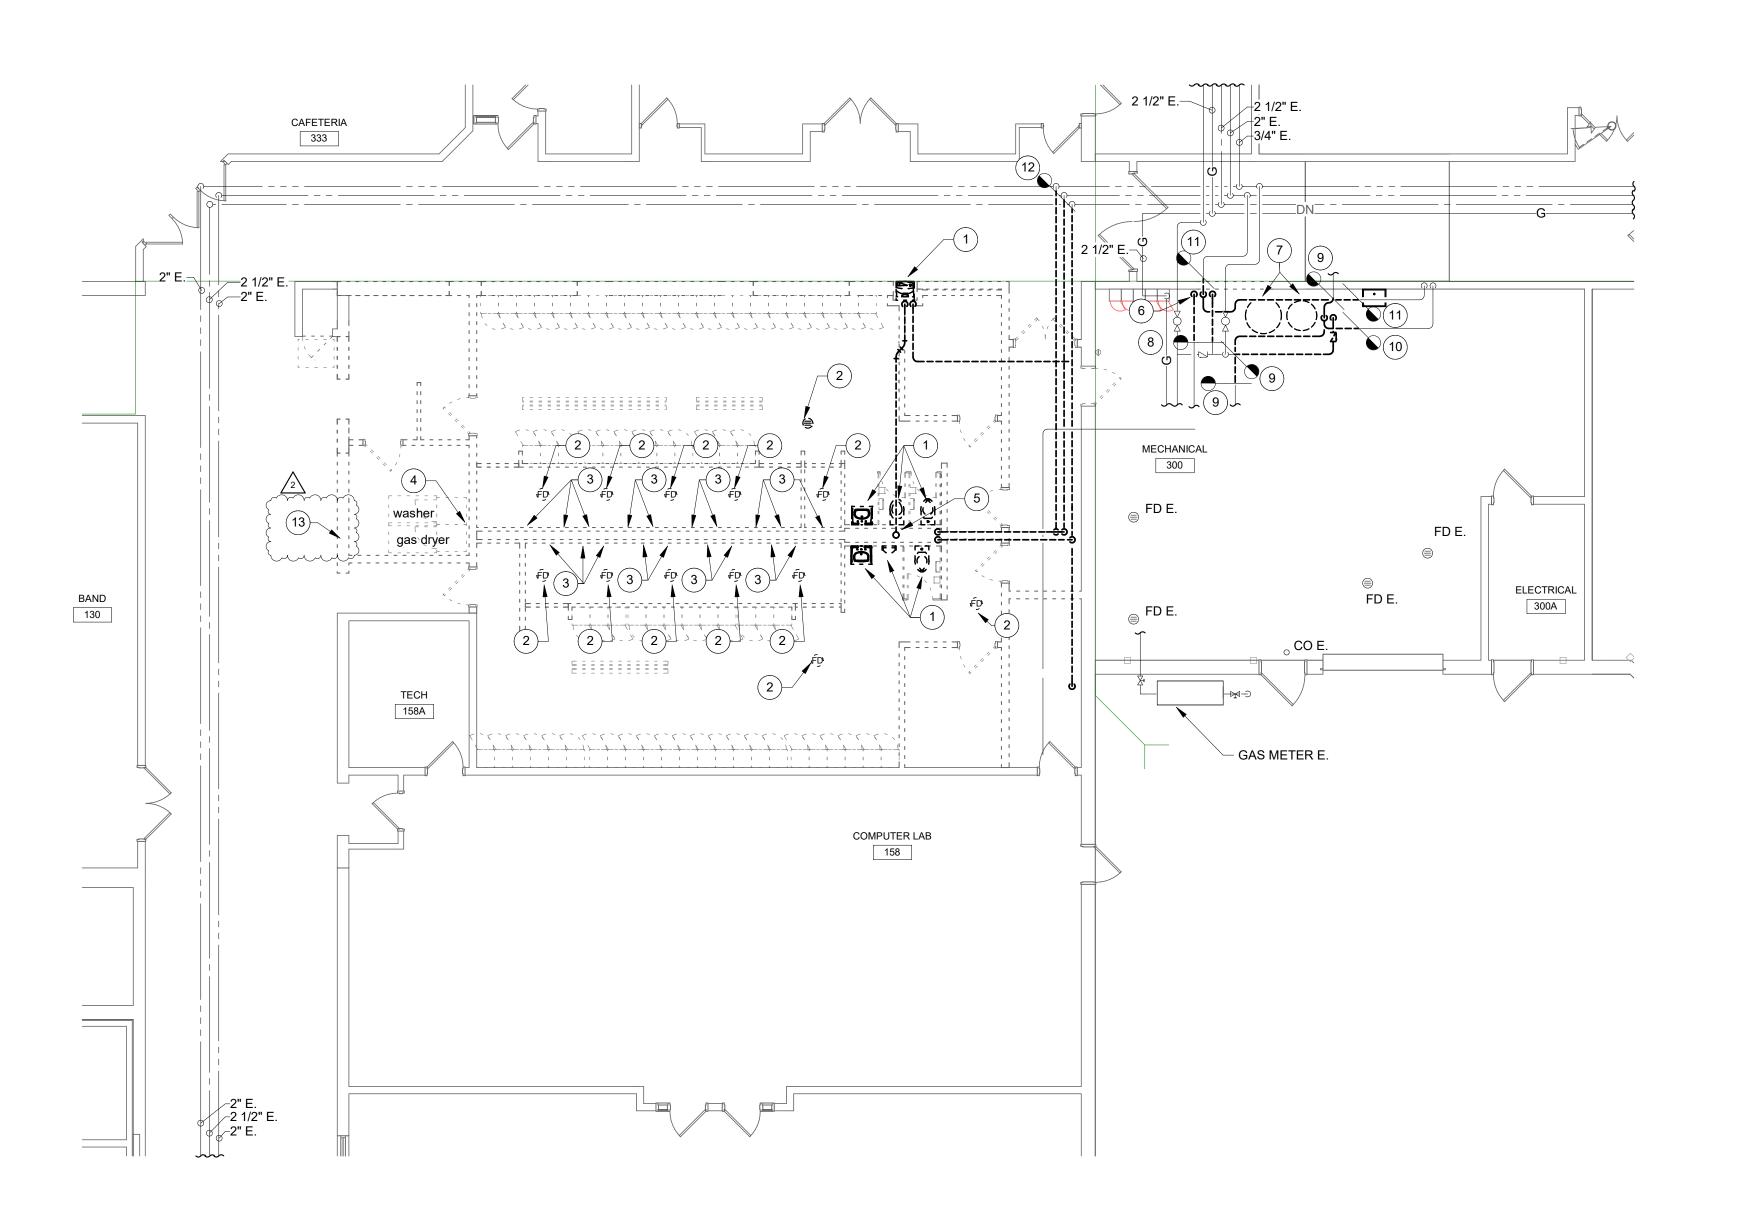





WORK TO BE REMOVED

WORK TO REMAIN

#### **GENERAL NOTES:**

1. REFER TO SHEET PM001 FOR ADDITIONAL GENERAL NOTES.

#### **# PLAN NOTES:**

 REMOVE PLUMBING FIXTURE, WATER AND WASTE PIPING COMPLETE. REMOVE WATER AND VENT PIPING IN CHASE. REMOVE WASTE PIPING TO A POINT BELOW THE FLOOR AND CAP. SAW CUT AND PATCH EXISTING FLOOR.

- REMOVE FLOOR DRAIN. REMOVE WASTE PIPING TO A POINT BELOW THE FLOOR AND CAP. SAW AND CAP EXISTING FLOOR.
- 3. REMOVE SHOWER COMPLETE. REMOVE WATER PIPING IN CHASE.
- 4. REMOVE WATER AND WASTE PIPING FOR CLOTHES WASHER. REMOVE WATER PIPING IN CHASE. REMOVE WASTE PIPING TO A POINT BELOW THE FLOOR AND CAP. SAW CUT AND CAP EXISTING
- 5. REMOVE 4" VENT UP. 4" VENT THRU ROOF TO REMAIN. MAKE 4" VENT THRU ROOF READY FOR NEW CONNECTION.
- 6. DISCONNECT WATER PIPING TO THERMOSTATIC MIXING VALVE. REMOVE AND RELOCATE THERMOSTATIC MIXING VALVE.
- DISCONNECT DOMESTIC WATER PIPING TO WATER SOFTENER AND BRINK TANK SYSTEM. REMOVE AND RELOCATE WATER SOFTENER AND BRINK TANK SYSTEM.
- REMOVE 140°F HOT WATER PIPING TO THIS POINT. MAKE 140°F HOT WATER PIPING READY FOR NEW CONNECTION. FIELD VERY EXACT PIPE SIZE.
- 9. REMOVE COLD WATER PIPING TO THIS POINT. MAKE COLD WATER PIPING READY FOR NEW CONNECTION. FIELD VERY EXACT PIPE SIZE.
- REMOVE 3/4" HOT WATER PIPING TO THIS POINT. MAKE 3/4" HOT WATER PIPING READY FOR NEW CONNECTION.
- 11. REMOVE 3/4" COLD WATER PIPING TO THIS POINT. MAKE 3/4" COLD
- WATER PIPING READY FOR NEW CONNECTION.

  12. REMOVE HOT WATER, COLD WATER, AND HOT WATER RETURN PIPING TO THIS POINT. MAKE HOT WATER, COLD WATER, AND HOT
- WATER RETURN PIPING READY FOR NEW CONNECTION.

  13. REMOVE THERMOSTATIC MIXING VALVE AND PIPING COMPLETELY

13. REMOVE THERMOSTATIC MIXING VALVE AND PIPING COMPLETELY.

SHERIDAN SONON

Sing, Indianapolis, IN 46240 '800 | csoinc.net

8831 Keystone Crossing, India 317.848.7800 | csc

D&A #2503

iates, Inc.
ngineers
Avenue

Consulting Enginee 732 North Capitol Avenue Indianapolis, IN 46204 Phone: (317) 634-4672 Fax: (317) 638-8725

HIGH SCHOOL & MIDDLE SCHO
RENOVATION PROJECTION CONSTRUCTION DOCUME
24185 HINESLEY RD, SHERIDAN, IN 460

SCOPE DRAWINGS:

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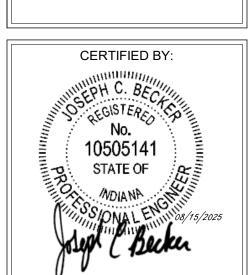
# REVISIONS:
2 ADDENDUM #2 9/12/25

ISSUE DATE | DRAWN BY | CHECKED BY

08/15/2025


GROUND FLOOR
PLAN - UNIT A PLUMBING
DEMOLITION


TJG



PROJECT NUMBER
2024037



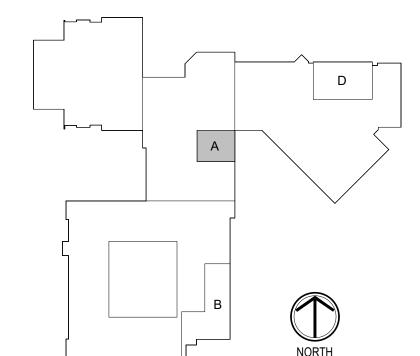

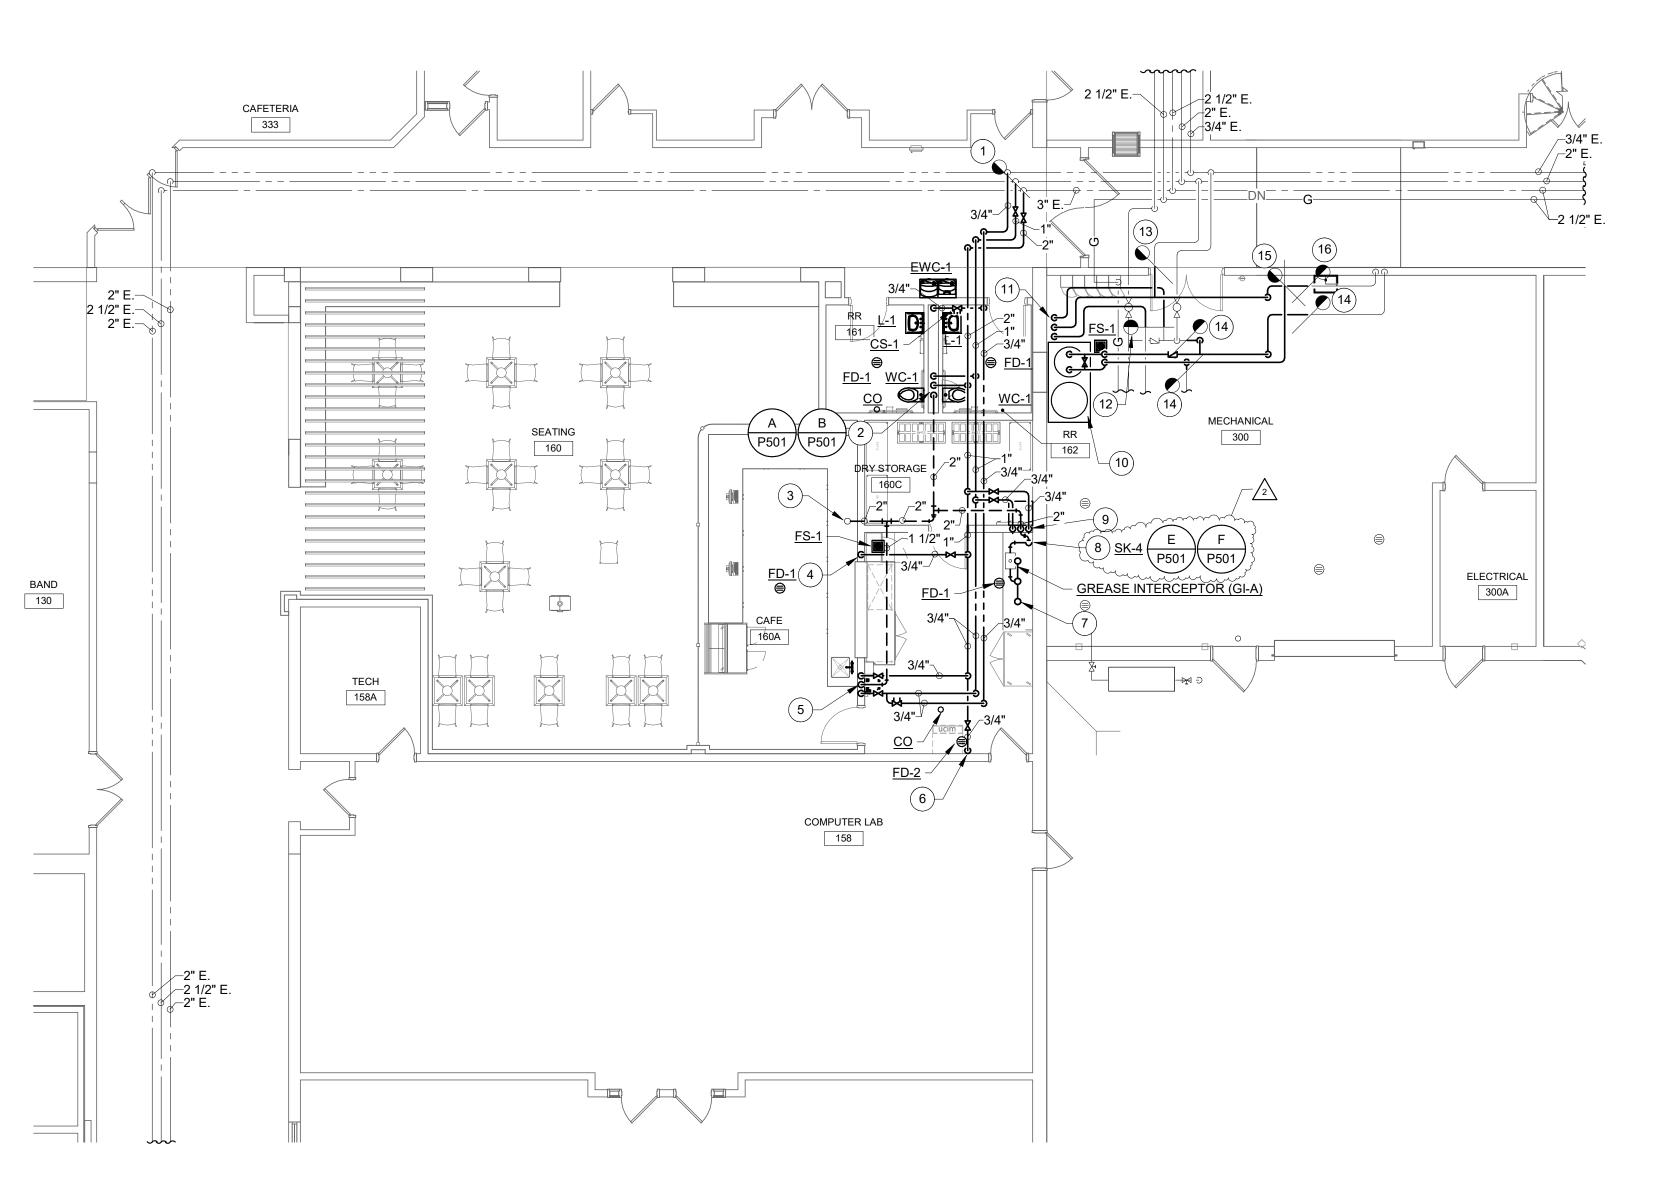



# **RENOVATION LEGEND:**

WORK TO BE INSTALLED WORK TO REMAIN

**GENERAL NOTES:** 

1. REFER TO SHEET PM001 FOR ADDITIONAL GENERAL NOTES.

#### **# PLAN NOTES:**

- CONNECT 1" HOT WATER, 2" COLD WATER, AND 3/4" HOT WATER RETURN PIPING TO EXISTING HOT WATER, COLD WATER, AND HOT WATER RETURN MAINS.
- 3/4" HOT WATER AND 2" COLD WATER DOWN. 4" WASTE DOWN. 2" VENT UP.
- 3. CONNECT 2" VENT PIPING TO EXISTING 4" VENT PIPING THRU ROOF.
- 3/4" COLD WATER DOWN. CONNECT TO DISHWASHER. CONNECT DRAIN PIPING FROM DISHWASHER AND TERMINATE OVER FLOOR SINK.
- 5. 3/4" HOT WATER AND 3/4" COLD WATER DOWN. 1 1/2" WASTE DOWN. 1 1/2" VENT UP. EXTEND 3/4" HOT WATER, 3/4" COLD WATER, AND 1 1/2" WASTE PIPING TO COUNTER SINK.
- 6. 3/4" COLD WATER DOWN. CONNECT TO ICE MACHINE. CONNECT DRAIN PIPING TO ICE MACHINE AND TERMINATE OVER FLOOR DRAIN.
- 7. CONNECT 1 1/2" WASTE PIPING TO SINK DRAIN. (TYPICAL OF 3)
- 8. 2" WASTE DOWN. 2" VENT UP. ROUTE VENT PIPING UNDER COUNTER AND CONNECT TO VENT PIPING IN WALL.
- 3/4" HOT WATER AND 3/4" COLD WATER OWN. 2" VENT FROM BELOW. EXTEND 3/4" HOT WATER AND 3/4" COLD WATER TO 3 COMPARTMENT SINK. ROUTE ON WALL UNDER PIPING UNDER SINK.
- 10. RELOCATED WATER SOFTENER AND BRINE TANK SYSTEM.
- 11. RELOCATED THERMOSTATIC MIXING VALVE.
- 12. CONNECT 140° F HOT WATER TO EXISTING 140°F HOT WATER. FIELD VERIFY EXACT PIPE SIZE.
- 13. CONNECT HOT WATER TO EXISTING HOT WATER. FIELD VERIFY EXACT
- CONNECT COLD WATER TO EXISTING COLD WATER. FIELD VERIFY EXACT PIPE SIZE.
- 15. CONNECT 3/4" COLD WATER TO EXISTING 3/4" COLD WATER.
- 16. CONNECT 3/4" HOT WATER TO EXISTING 3/4" HOT WATER.







SCOPE DRAWINGS:

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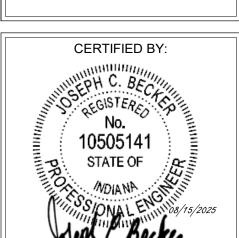
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REVISIONS: 2 ADDENDUM #2 9/12/25


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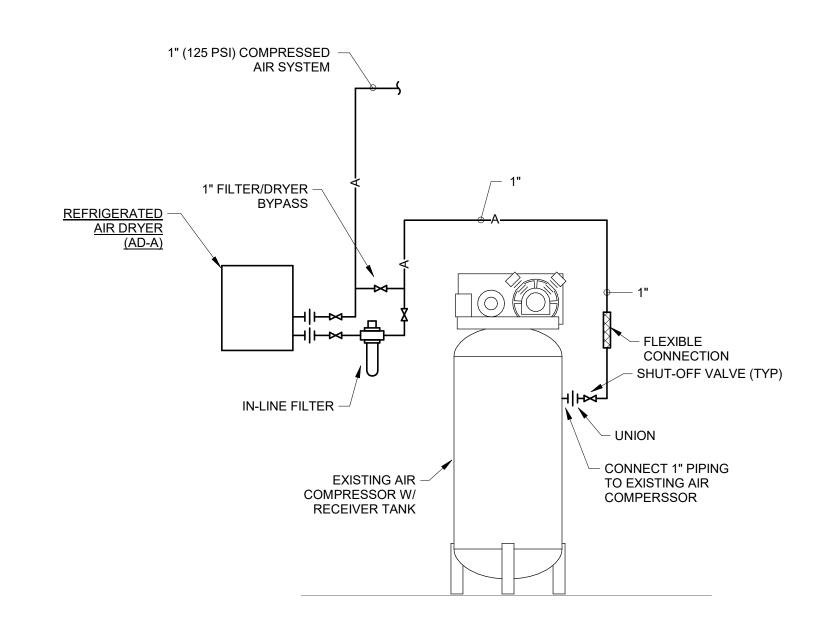
DRAWING TITLE: GROUND FLOOR PLAN - UNIT A -PLUMBING




DRAWING NUMBER P201A

PROJECT NUMBER 2024037




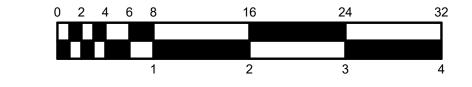


# J AIR COMPRESSOR SCALE: NONE

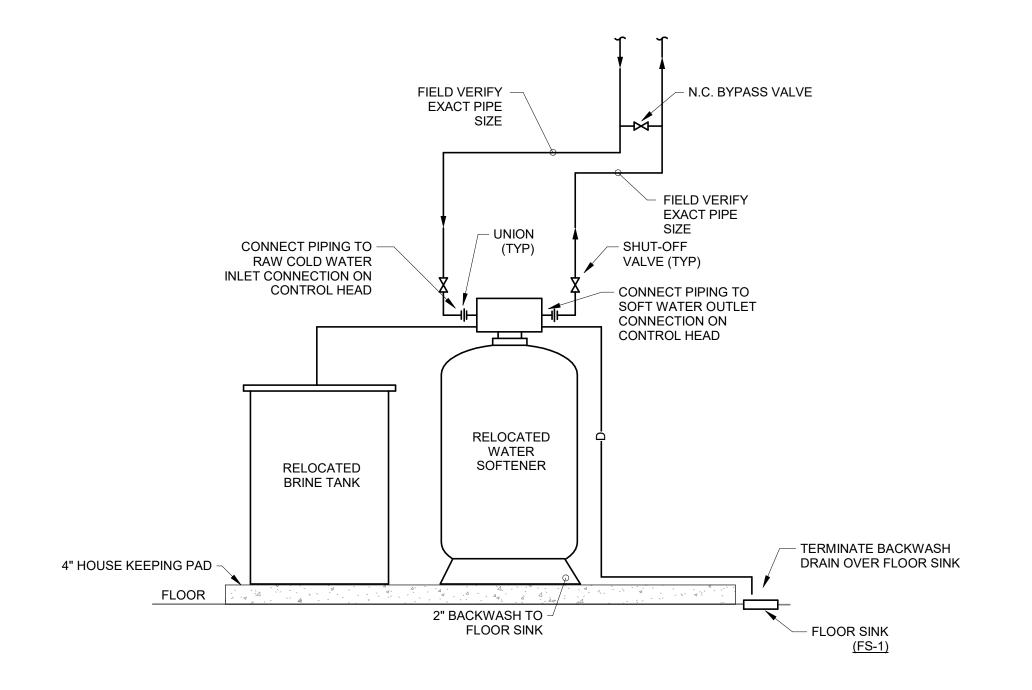


# K WATER SOFTENER SCALE: NONE

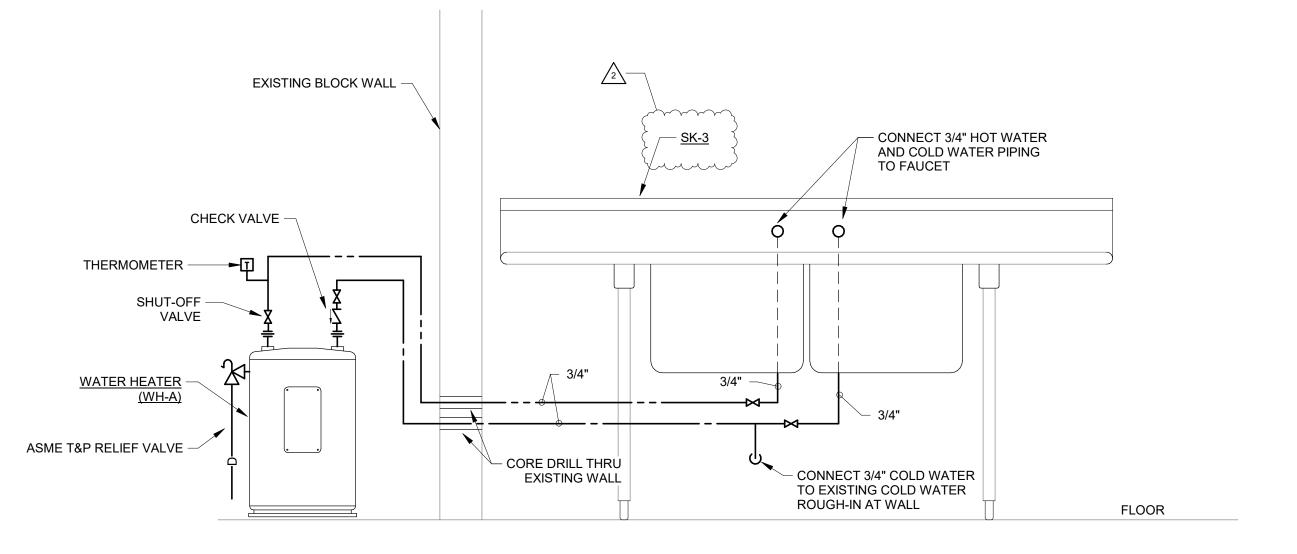


L WATER HEATER SCALE: NONE

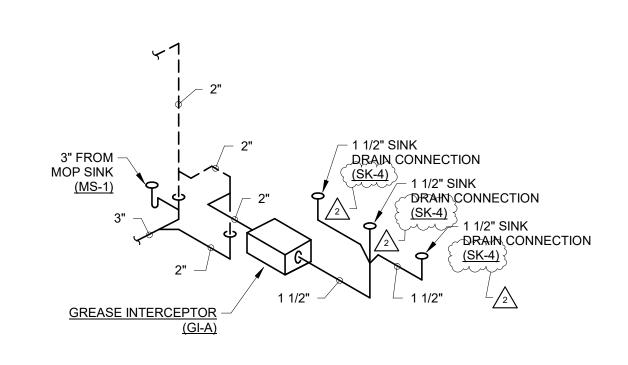


#### E WASTE AND VENT DIAGRAM SCALE: NONE

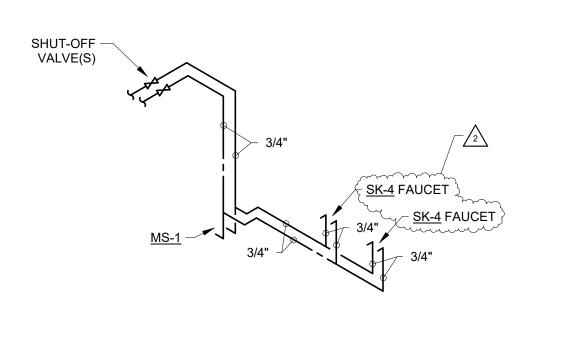


# F HOT AND COLD WATER DIAGRAM

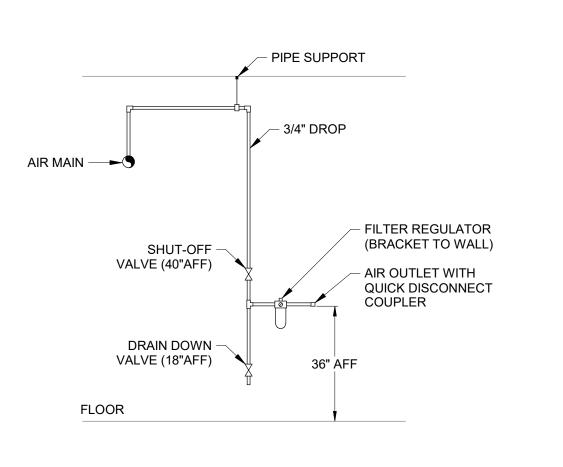


# G AIR REGULATOR STATION

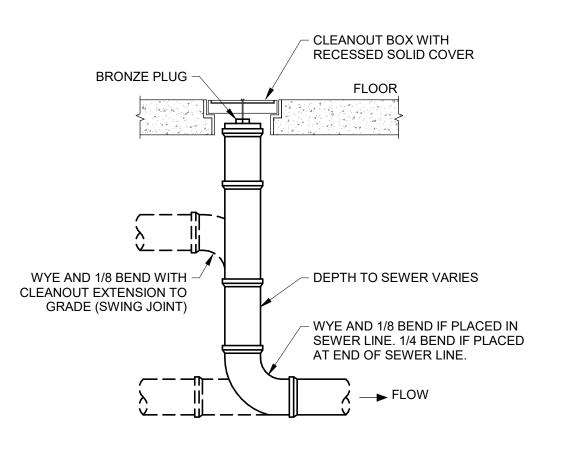


H INTERIOR CLEANOUT

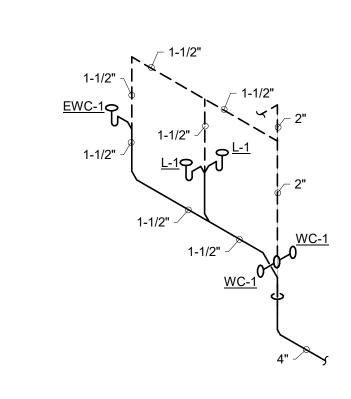


# A WASTE AND VENT DIAGRAM SCALE: NONE

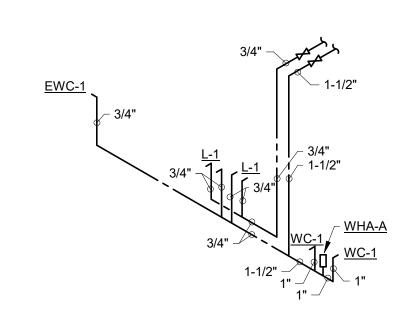

# B HOT AND COLD WATER DIAGRAM

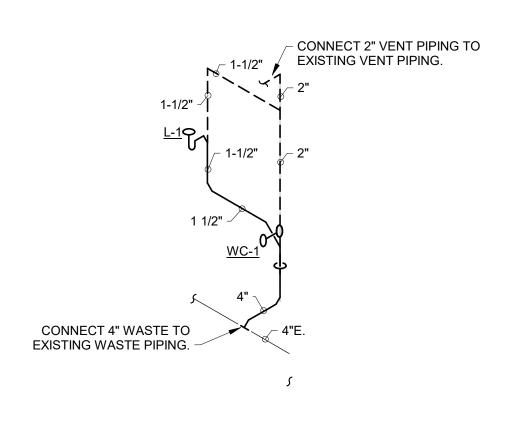



# C WASTE AND VENT DIAGRAM SCALE: NONE

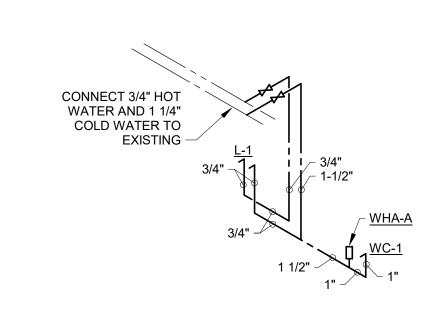

D HOT AND COLD WATER DIAGRAM SCALE: NONE



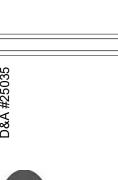

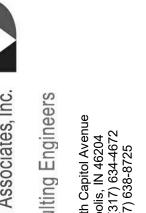

SCOPE DRAWINGS:

These drawings indicate the general scope of the project in terms of architectural design concept, the dimensions of the building, the major architectural elements and the type of structural, mechanical and electrical systems.


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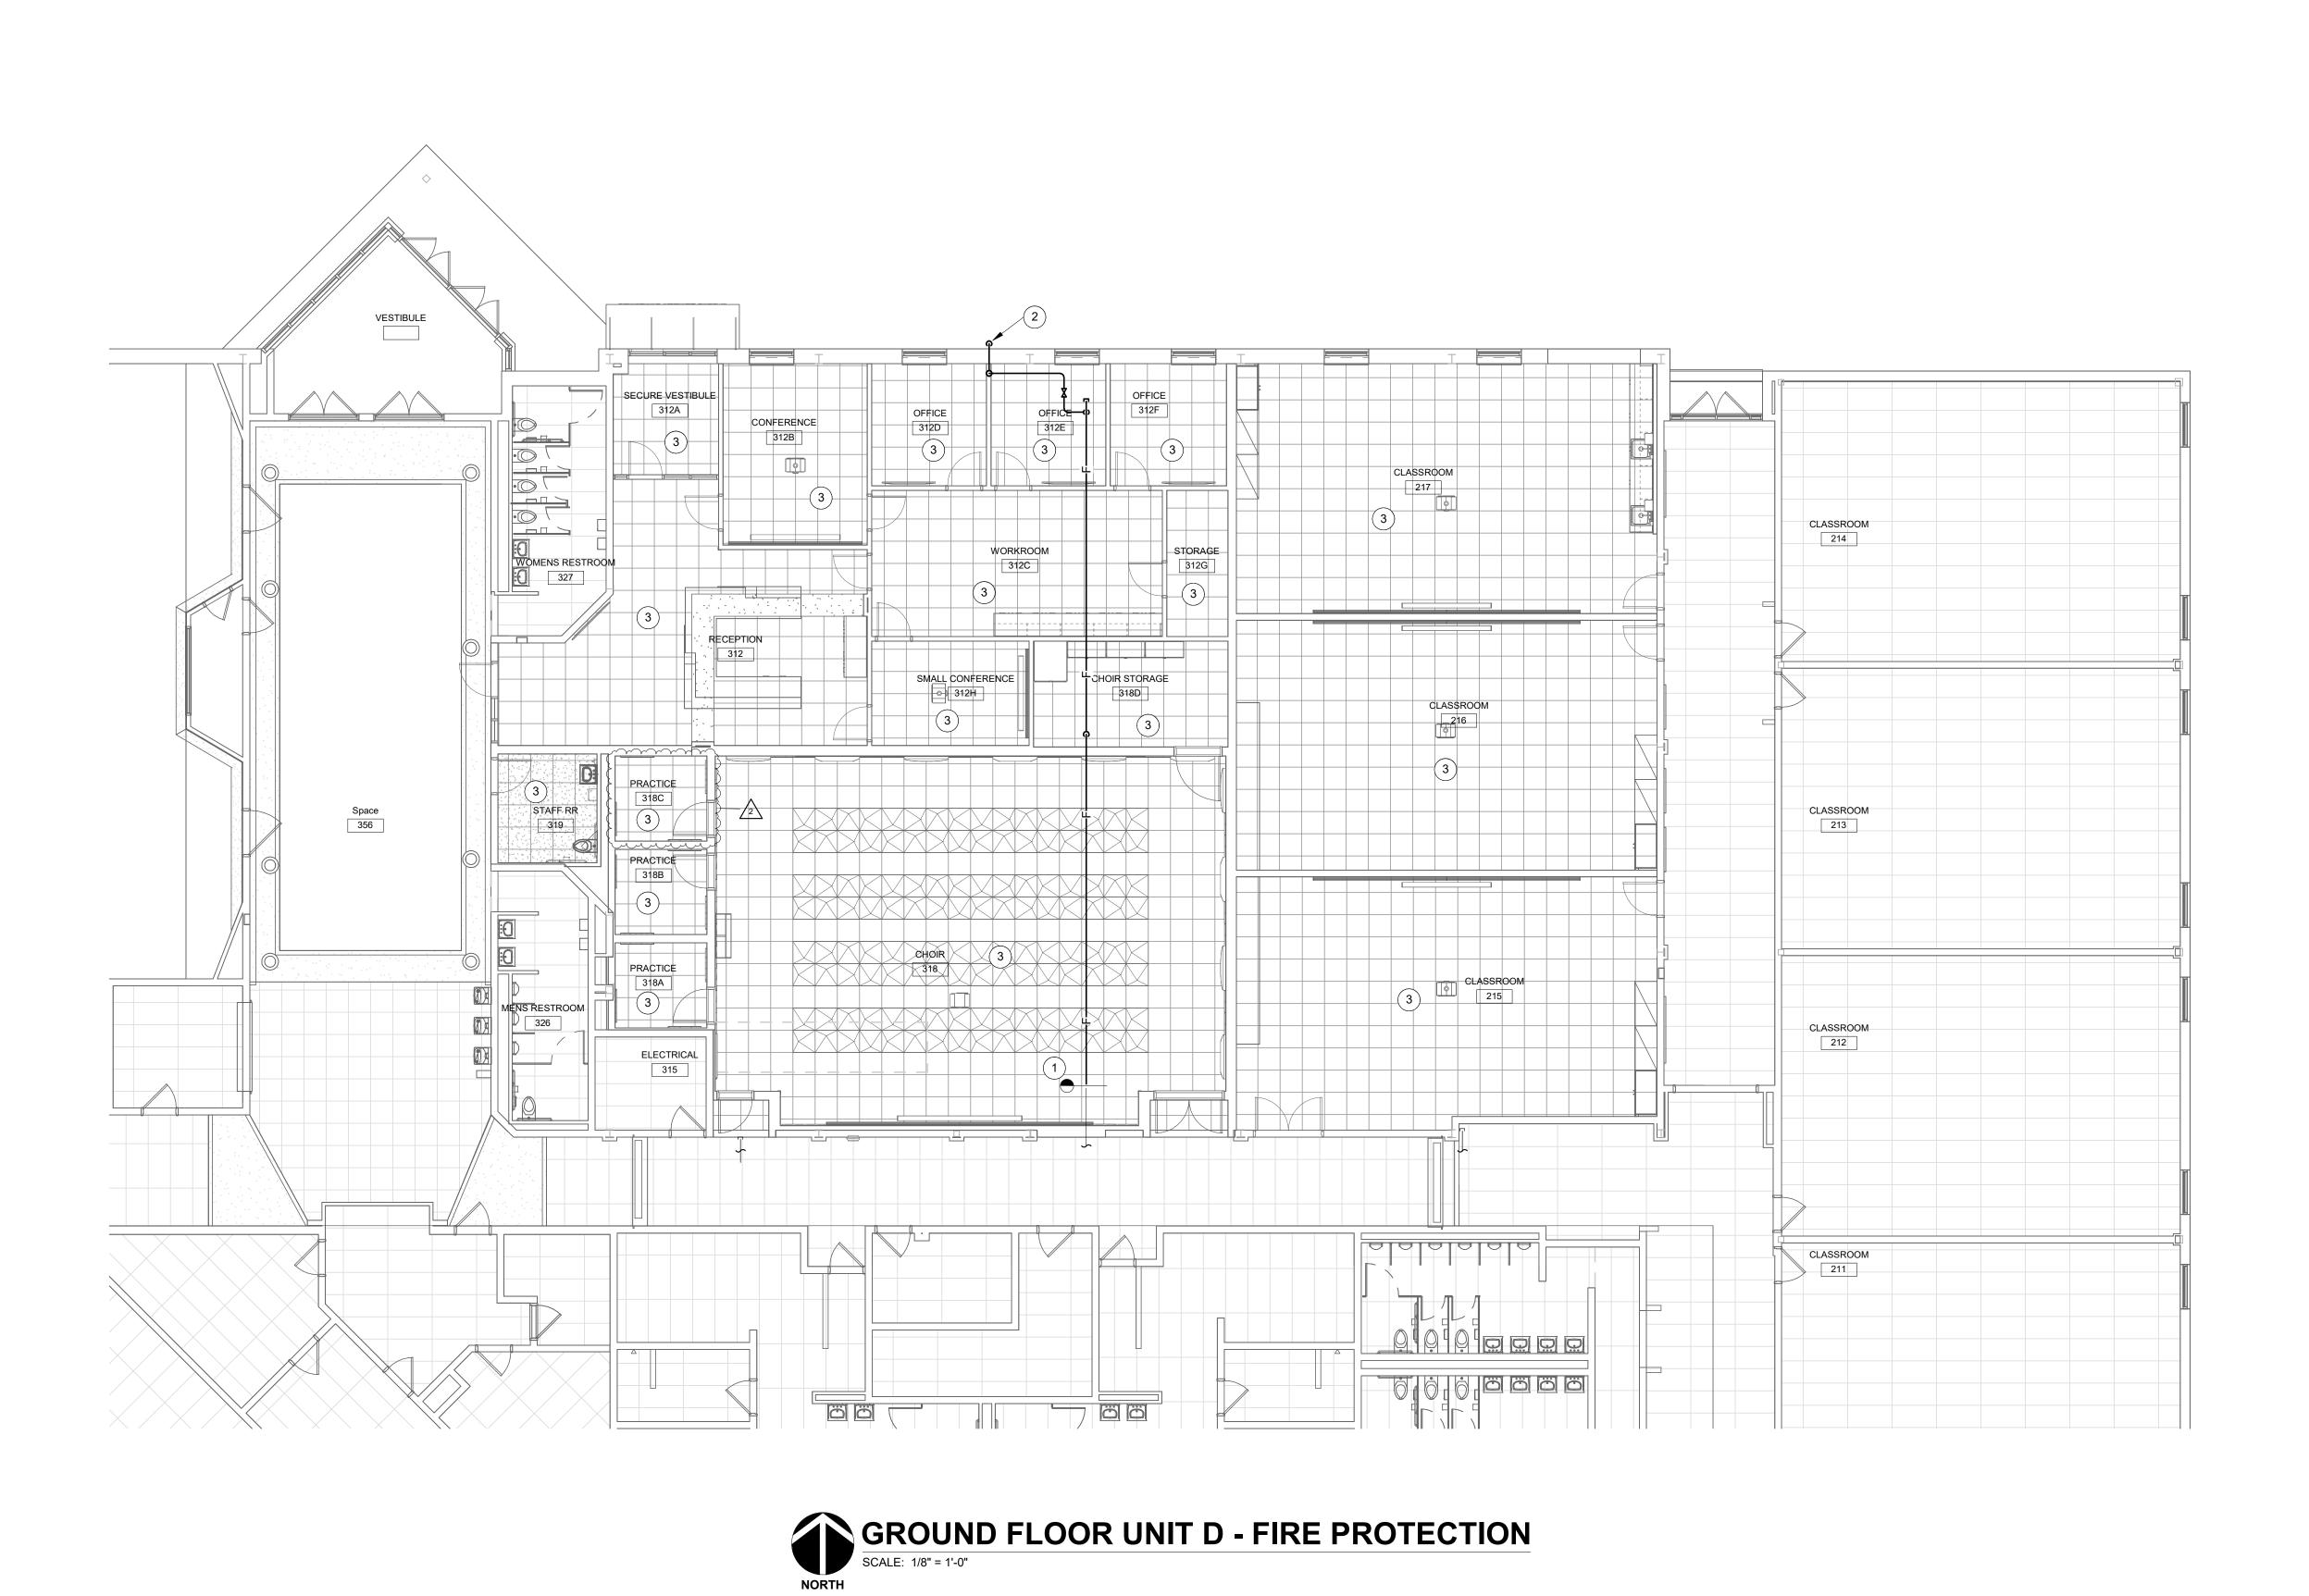
# REVISIONS: 2 ADDENDUM #2 9/12/25

ISSUE DATE | DRAWN BY | CHECKED BY TJG 08/15/2025

DRAWING TITLE: ISOMETRICS -PLUMBING



DRAWING NUMBER

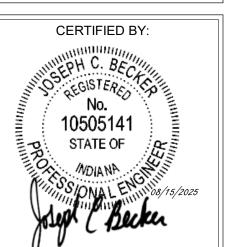



WORK TO BE INSTALLED

WORK TO REMAIN

#### **GENERAL NOTES:**

1. SEE DRAWING FP201A FOR GENERAL NOTES.

### **# PLAN NOTES:**

1. CONNECT SPRINKLER MAIN TO EXISTING SPRINKLER MAIN.

2. 1" AUXILLARY DRAIN. TERMINATE OVER SIDE. CORE DRILL AND SEAL PIPE PENETRATION THRU WALL WEATHER TIGHT.

3. CONCEALED STYLE SPRINKLER HEAD. COORDINATE LOCATION OF

SPRINKLER HEAD WITH ALL OTHER CEILING MOUNTED DEVICES. manne a serie de la constantina della constantin

KEY PLAN

SCOPE DRAWINGS:

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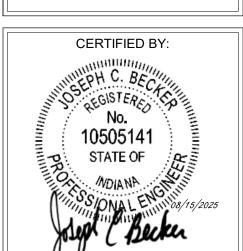
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REVISIONS: 2 ADDENDUM #2 9/12/25

ISSUE DATE | DRAWN BY | CHECKED BY


TJG 08/15/2025 DRAWING TITLE:

GROUND FLOOR PLAN - UNIT D -FIRE PROTECTION



DRAWING NUMBER FP201D PROJECT NUMBER 2024037



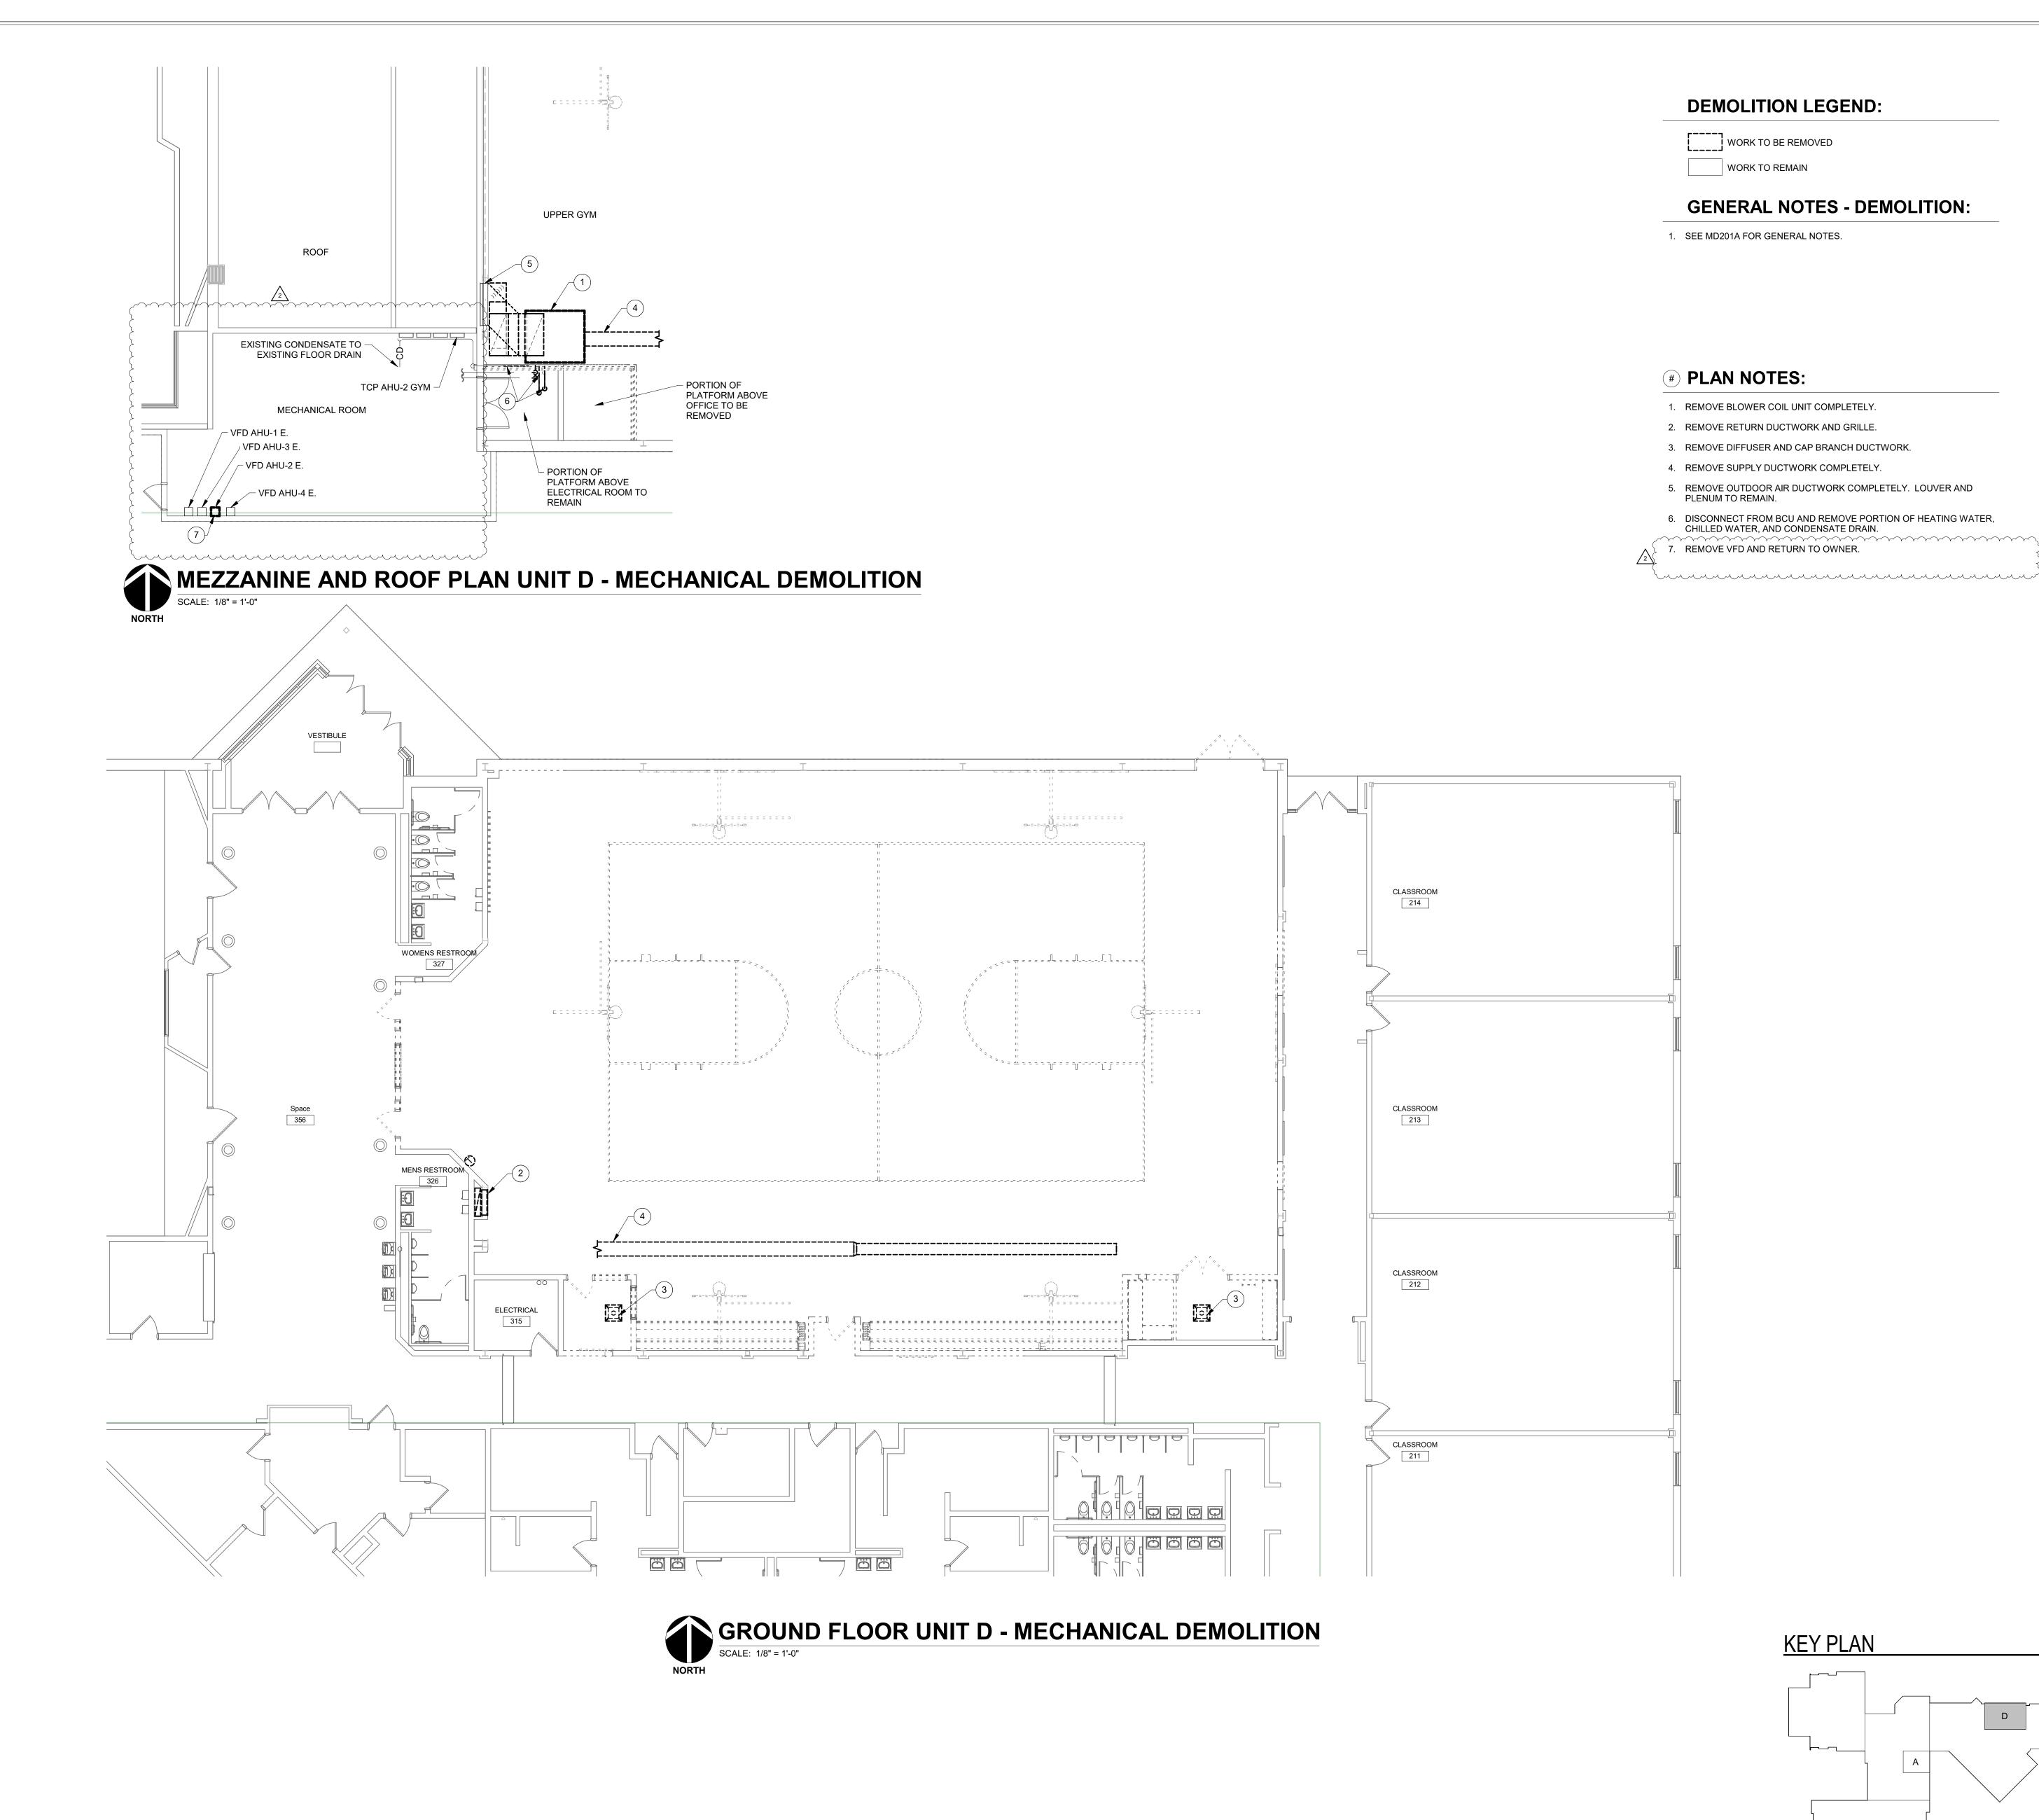



S831 Keystone Crossing, Indianapolis, IN 46240 317.848.7800 | csoinc.net

D&A #25035

i, Inc.

Consulting Engineers
732 North Capitol Avenue
Indianapolis, IN 46204
Phone: (317) 634-4672
Fax: (317) 638-8725

HIGH SCHOOL & MIDDLE SCHO
RENOVATION PROJECTION CONSTRUCTION DOCUME
24185 HINESLEY RD, SHERIDAN, IN 460

SCOPE DRAWINGS:

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# REVISIONS:
2 ADDENDUM #2 9/12/25

ISSUE DATE DRAWN BY CHECKED BY

08/15/2025 JCB JCB

GROUND FLOOR
PLAN - UNIT D MECHANICAL
DEMOLITION

CERTIFIED BY:

NO.

10505141


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DRAWING NUMBER NUMBER PROJECT NUMBER 2024037






7 6 5 4 3

FILTER / MIXING BOX
 ACCESS SECTION
 FAN SECTION
 ACCESS SECTION
 PREHEAT COIL
 COOLING COIL
 DISCHARGE PLENUM

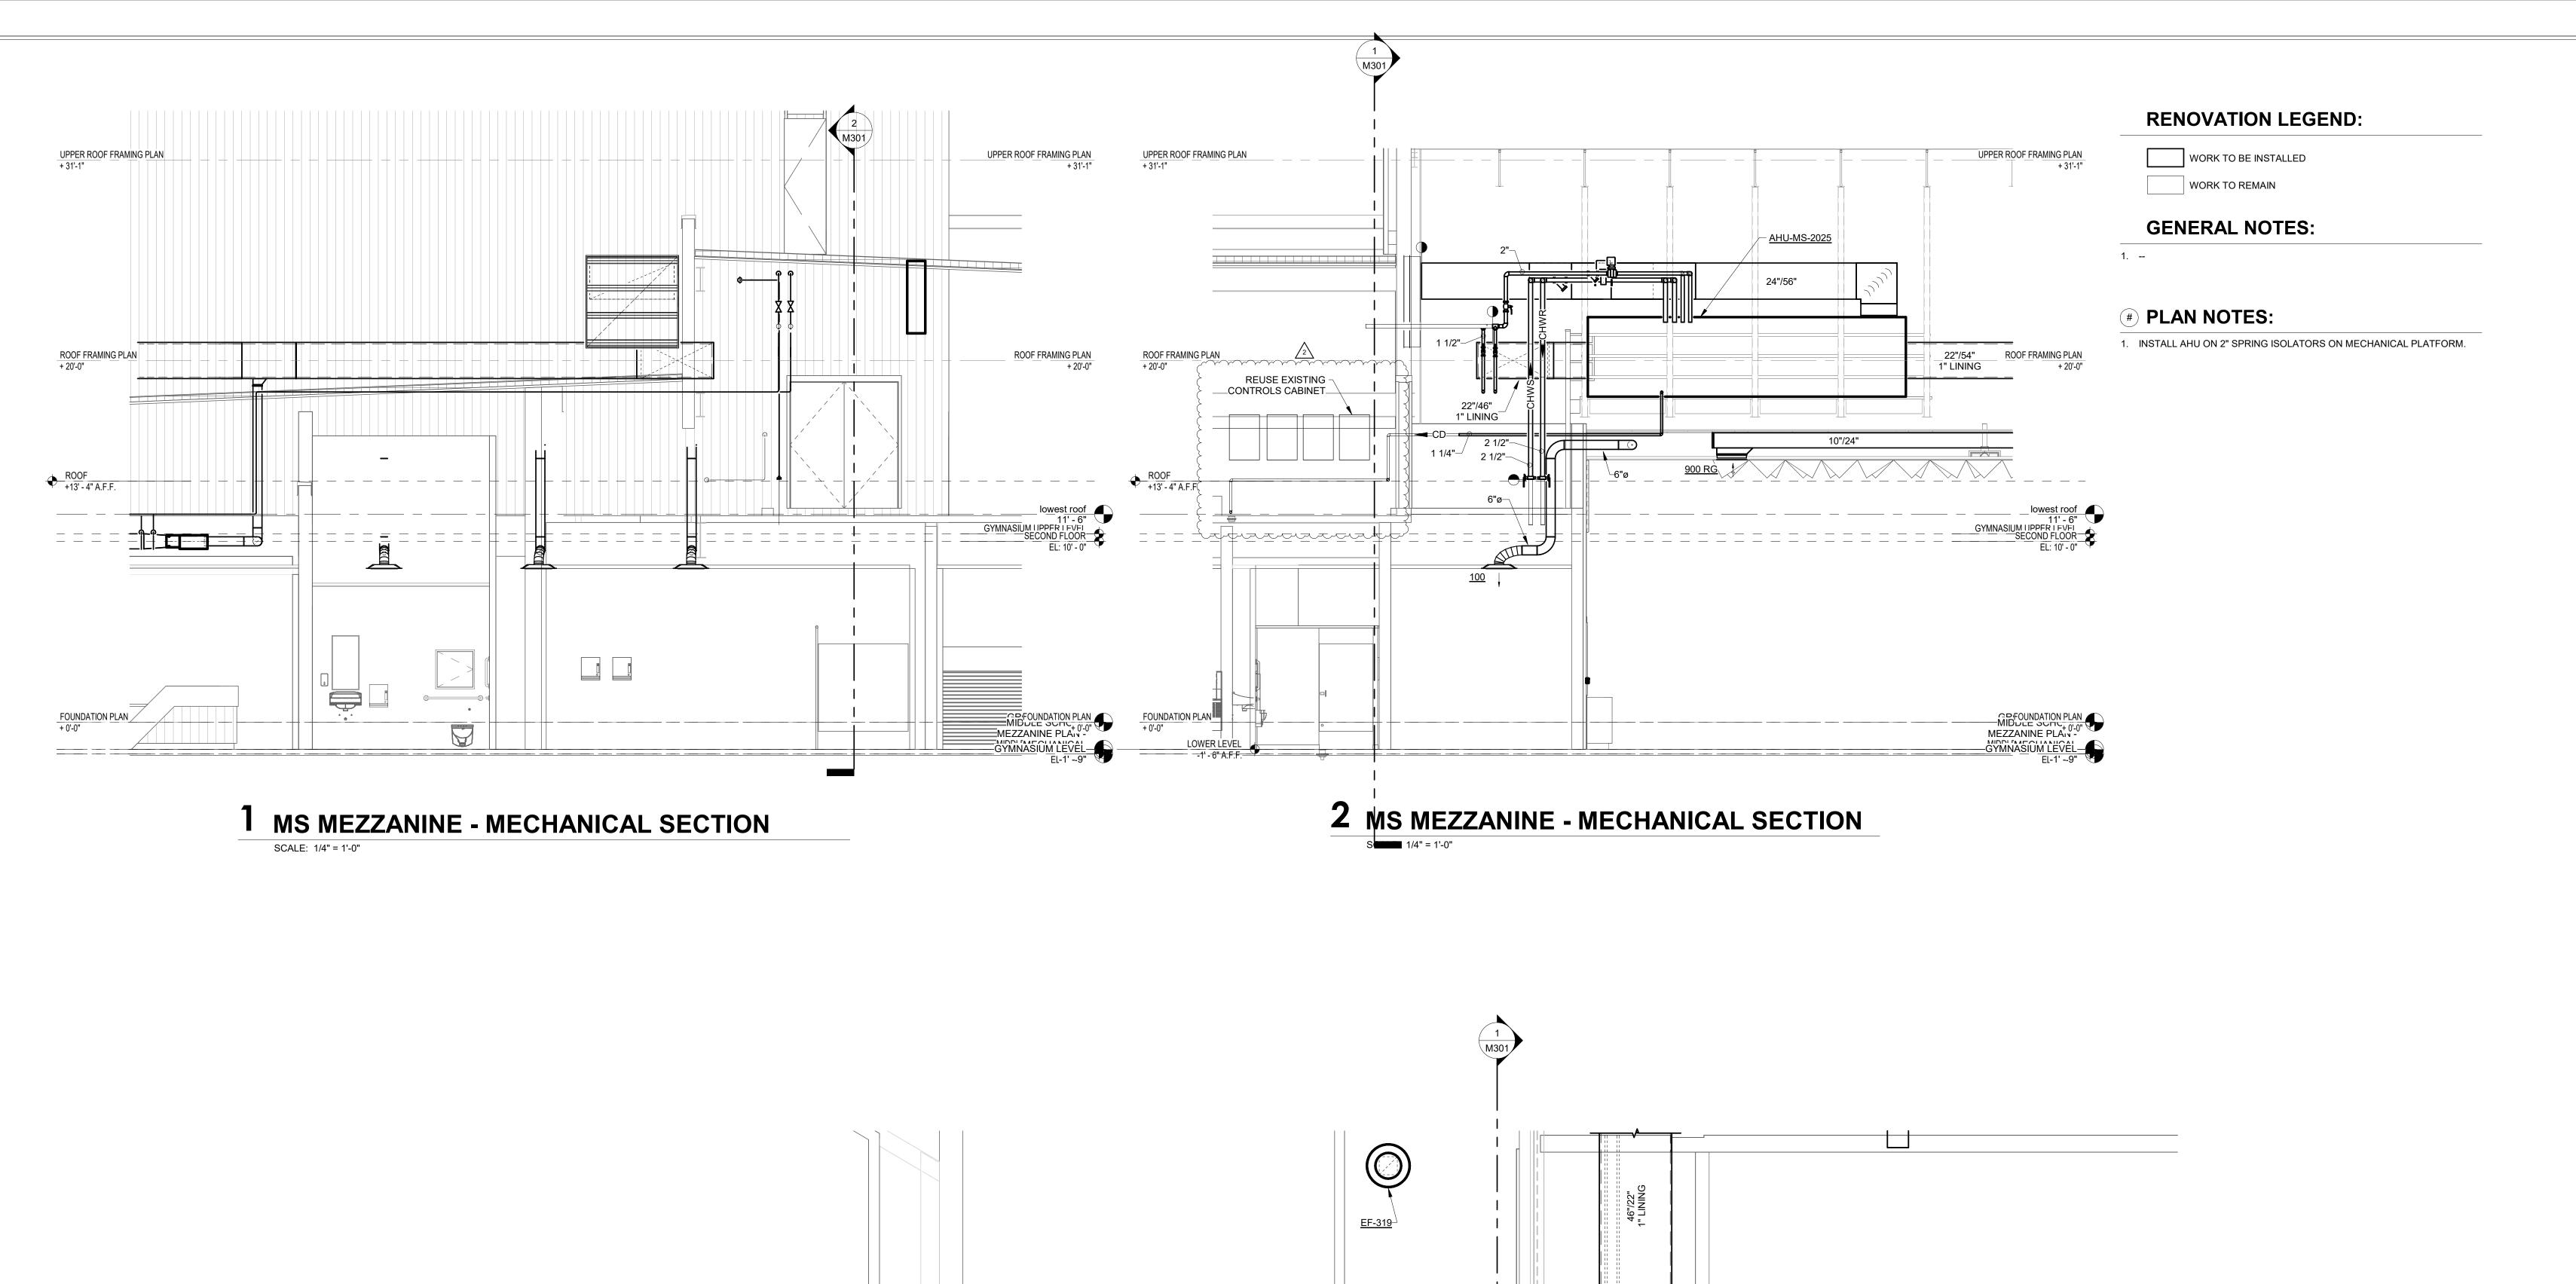2 1

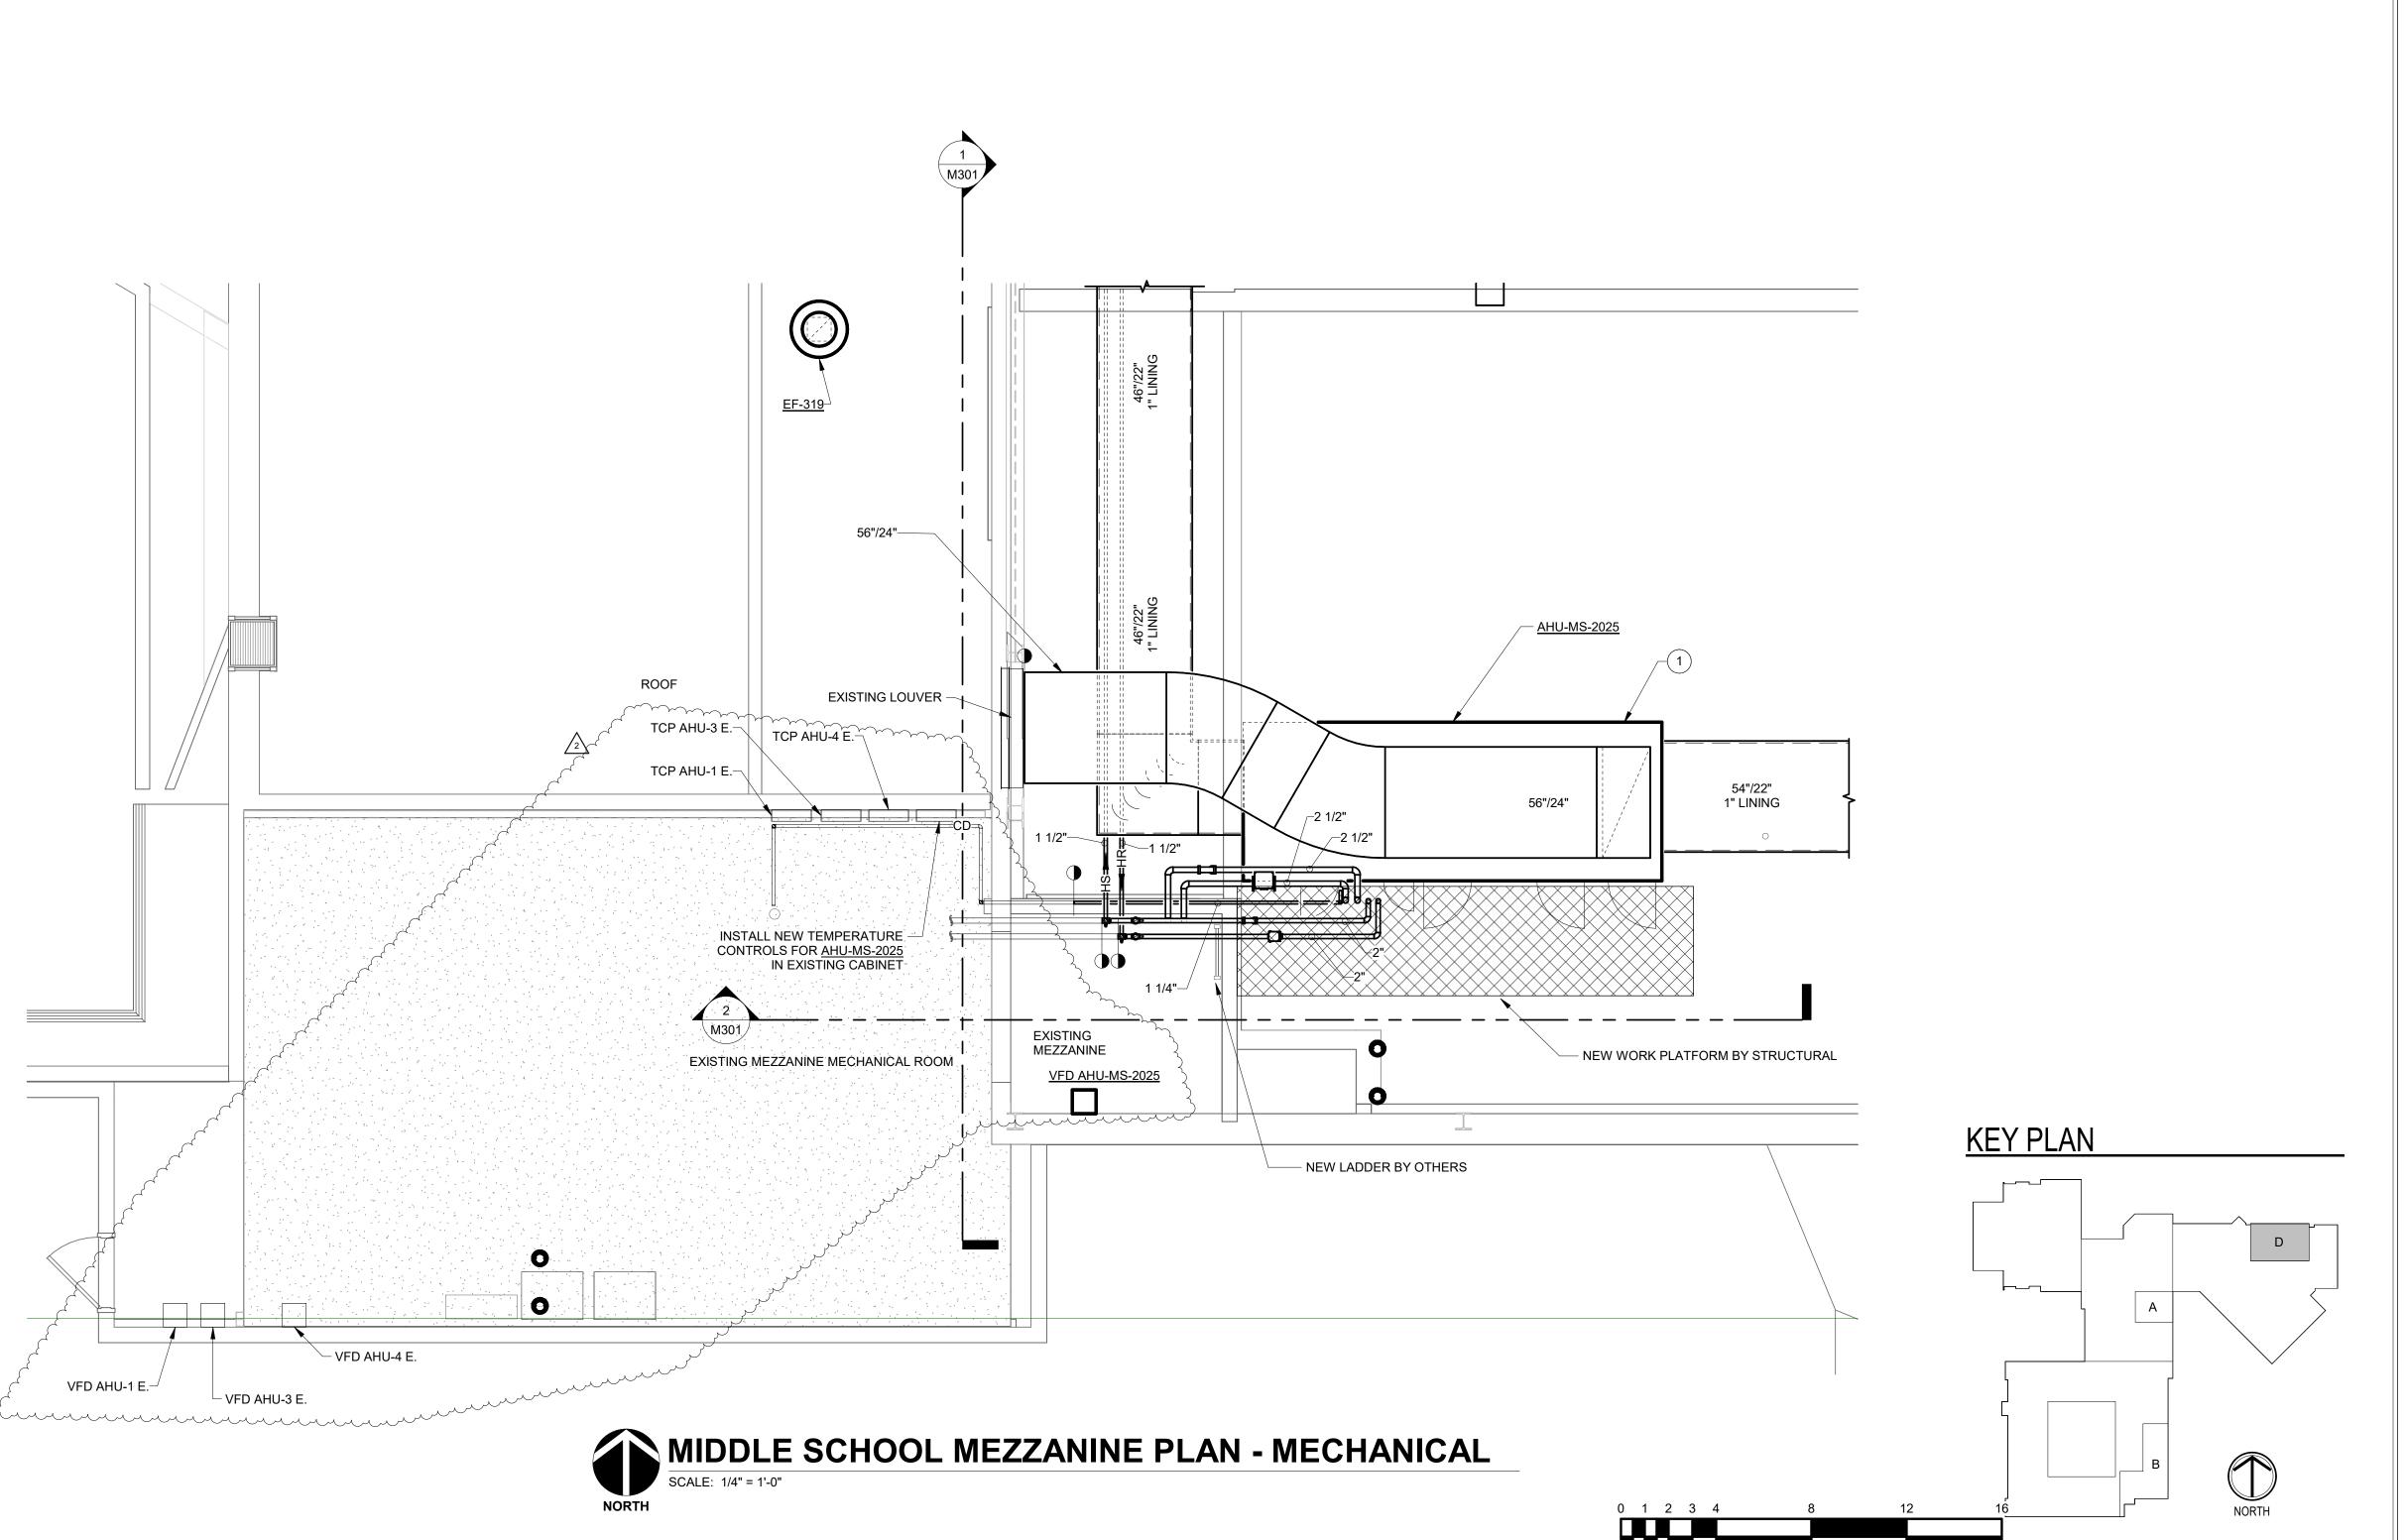



S831 Keystone Crossing, Indianapolis, IN 46240

D&A

and Associates, Inc.
Consulting Engineers
732 North Capitol Avenue
Indianapolis, IN 46204
Phone: (317) 634-4672

SHERIDAN COMMUNITY SCHOOLS
HIGH SCHOOL & MIDDLE SCHOOL
RENOVATION PROJECT
100% CONSTRUCTION DOCUMENTS
24185 HINESLEY RD. SHERIDAN, IN 46069

SCOPE DRAWINGS:

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# REVISIONS:
2 ADDENDUM #2 9/12/25

ISSUE DATE DRAWN BY CHECKED BY 08/15/2025 JCB JCB

ENLARGED
PLANS MECHANICAL

CERTIFIED BY:

OF REGISTERS

No.

10505141

STATE OF

NOIANA

STATE OF

NOIANA

STATE OF

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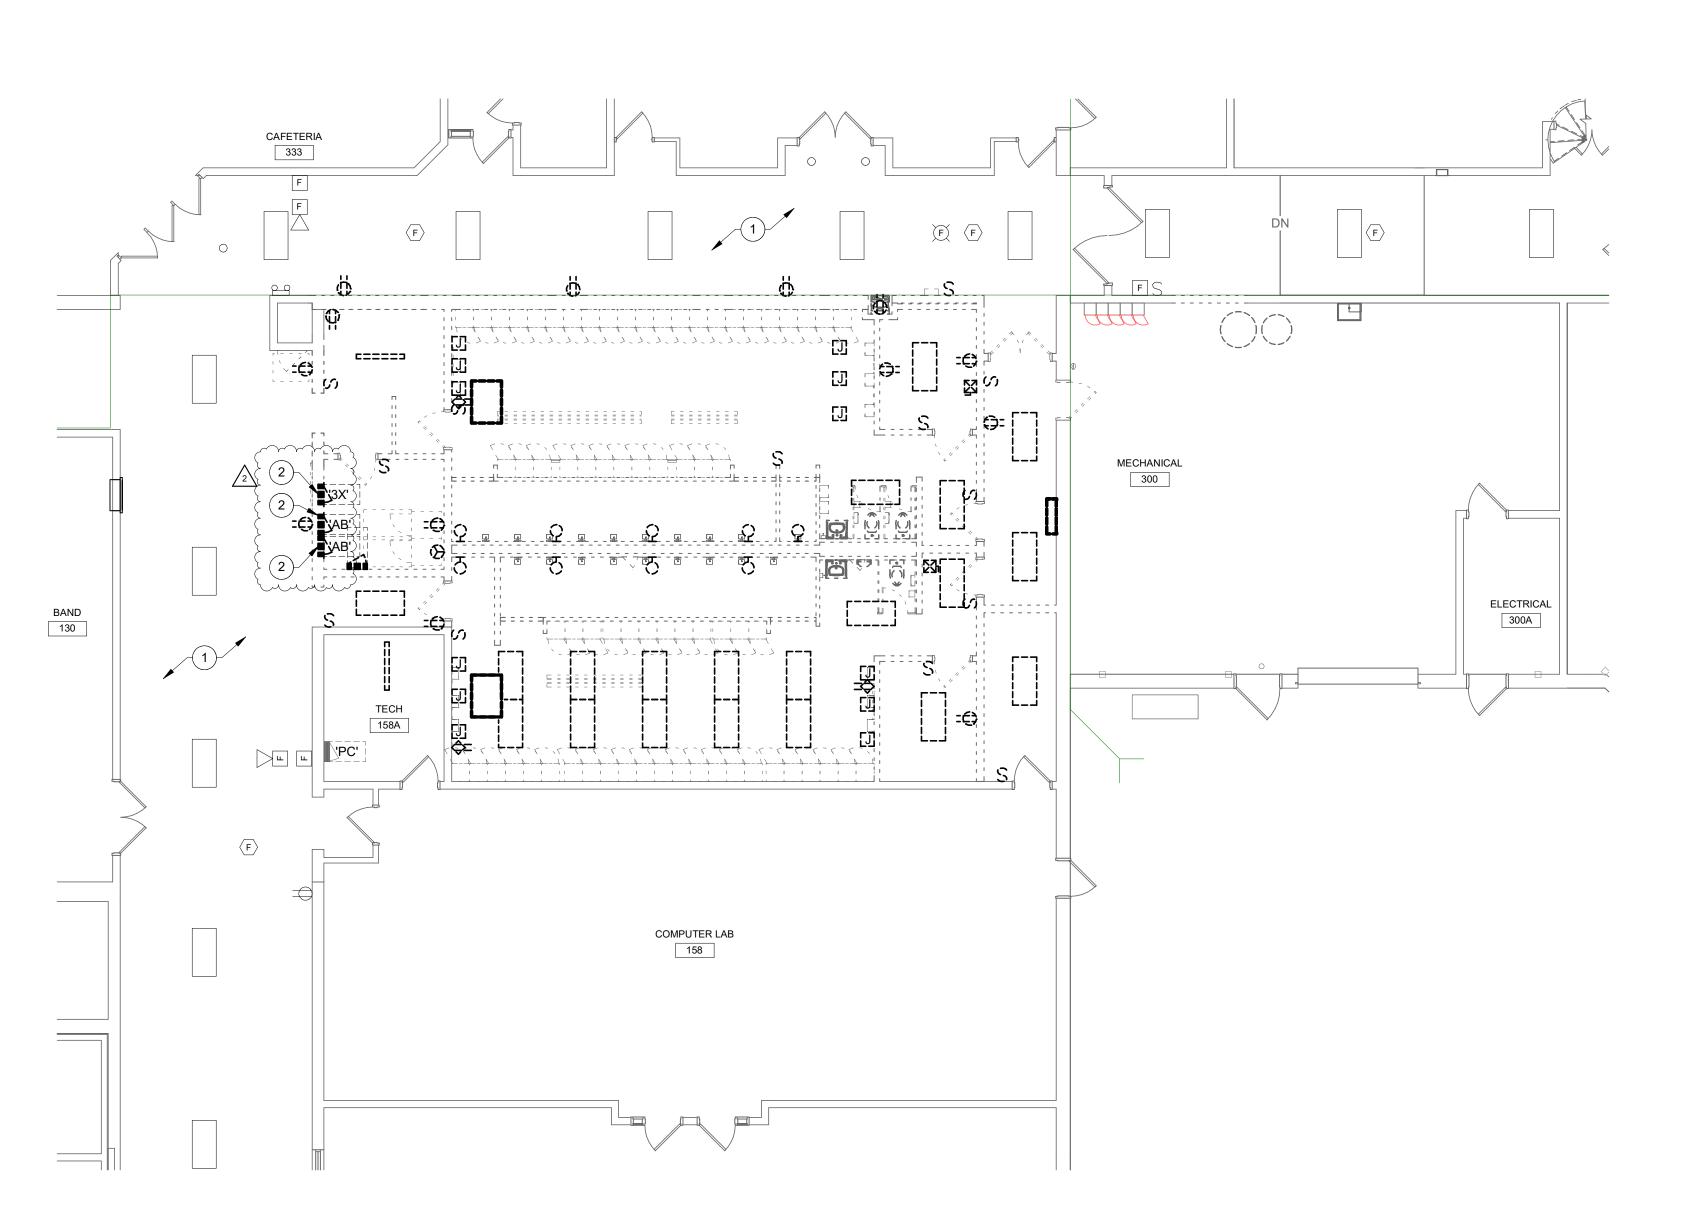
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DRAWING NUMBER


M301

PROJECT NUMBER

2024037





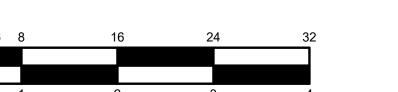

KEY PLAN



WORK TO BE REMOVED

WORK TO REMAIN


# **GENERAL NOTES:**

1. SEE E001 FOR GENERAL NOTES.

#### **# PLAN NOTES:**

- SUPPORT EXISTING DEVICES IN CEILING IN THIS AREA, INCLUDING LIGHTING, FIRE ALARM DEVICES, SPEAKERS, CAMERAS, ETC. DURING CONSTRUCTION.
- REMOVE EXISTING PANELBOARDS. REFEED EXISTING CIRCUITS TO NEW PANELBOARD LOCATION. EXISTING FEEDER TO EXTEND TO NEW PANELBOARD LOCATION. SEE DRAWING E211A FOR ADDITIONAL INFORMATION.



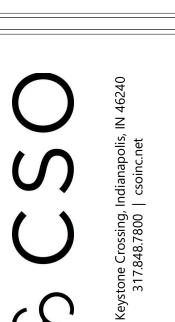



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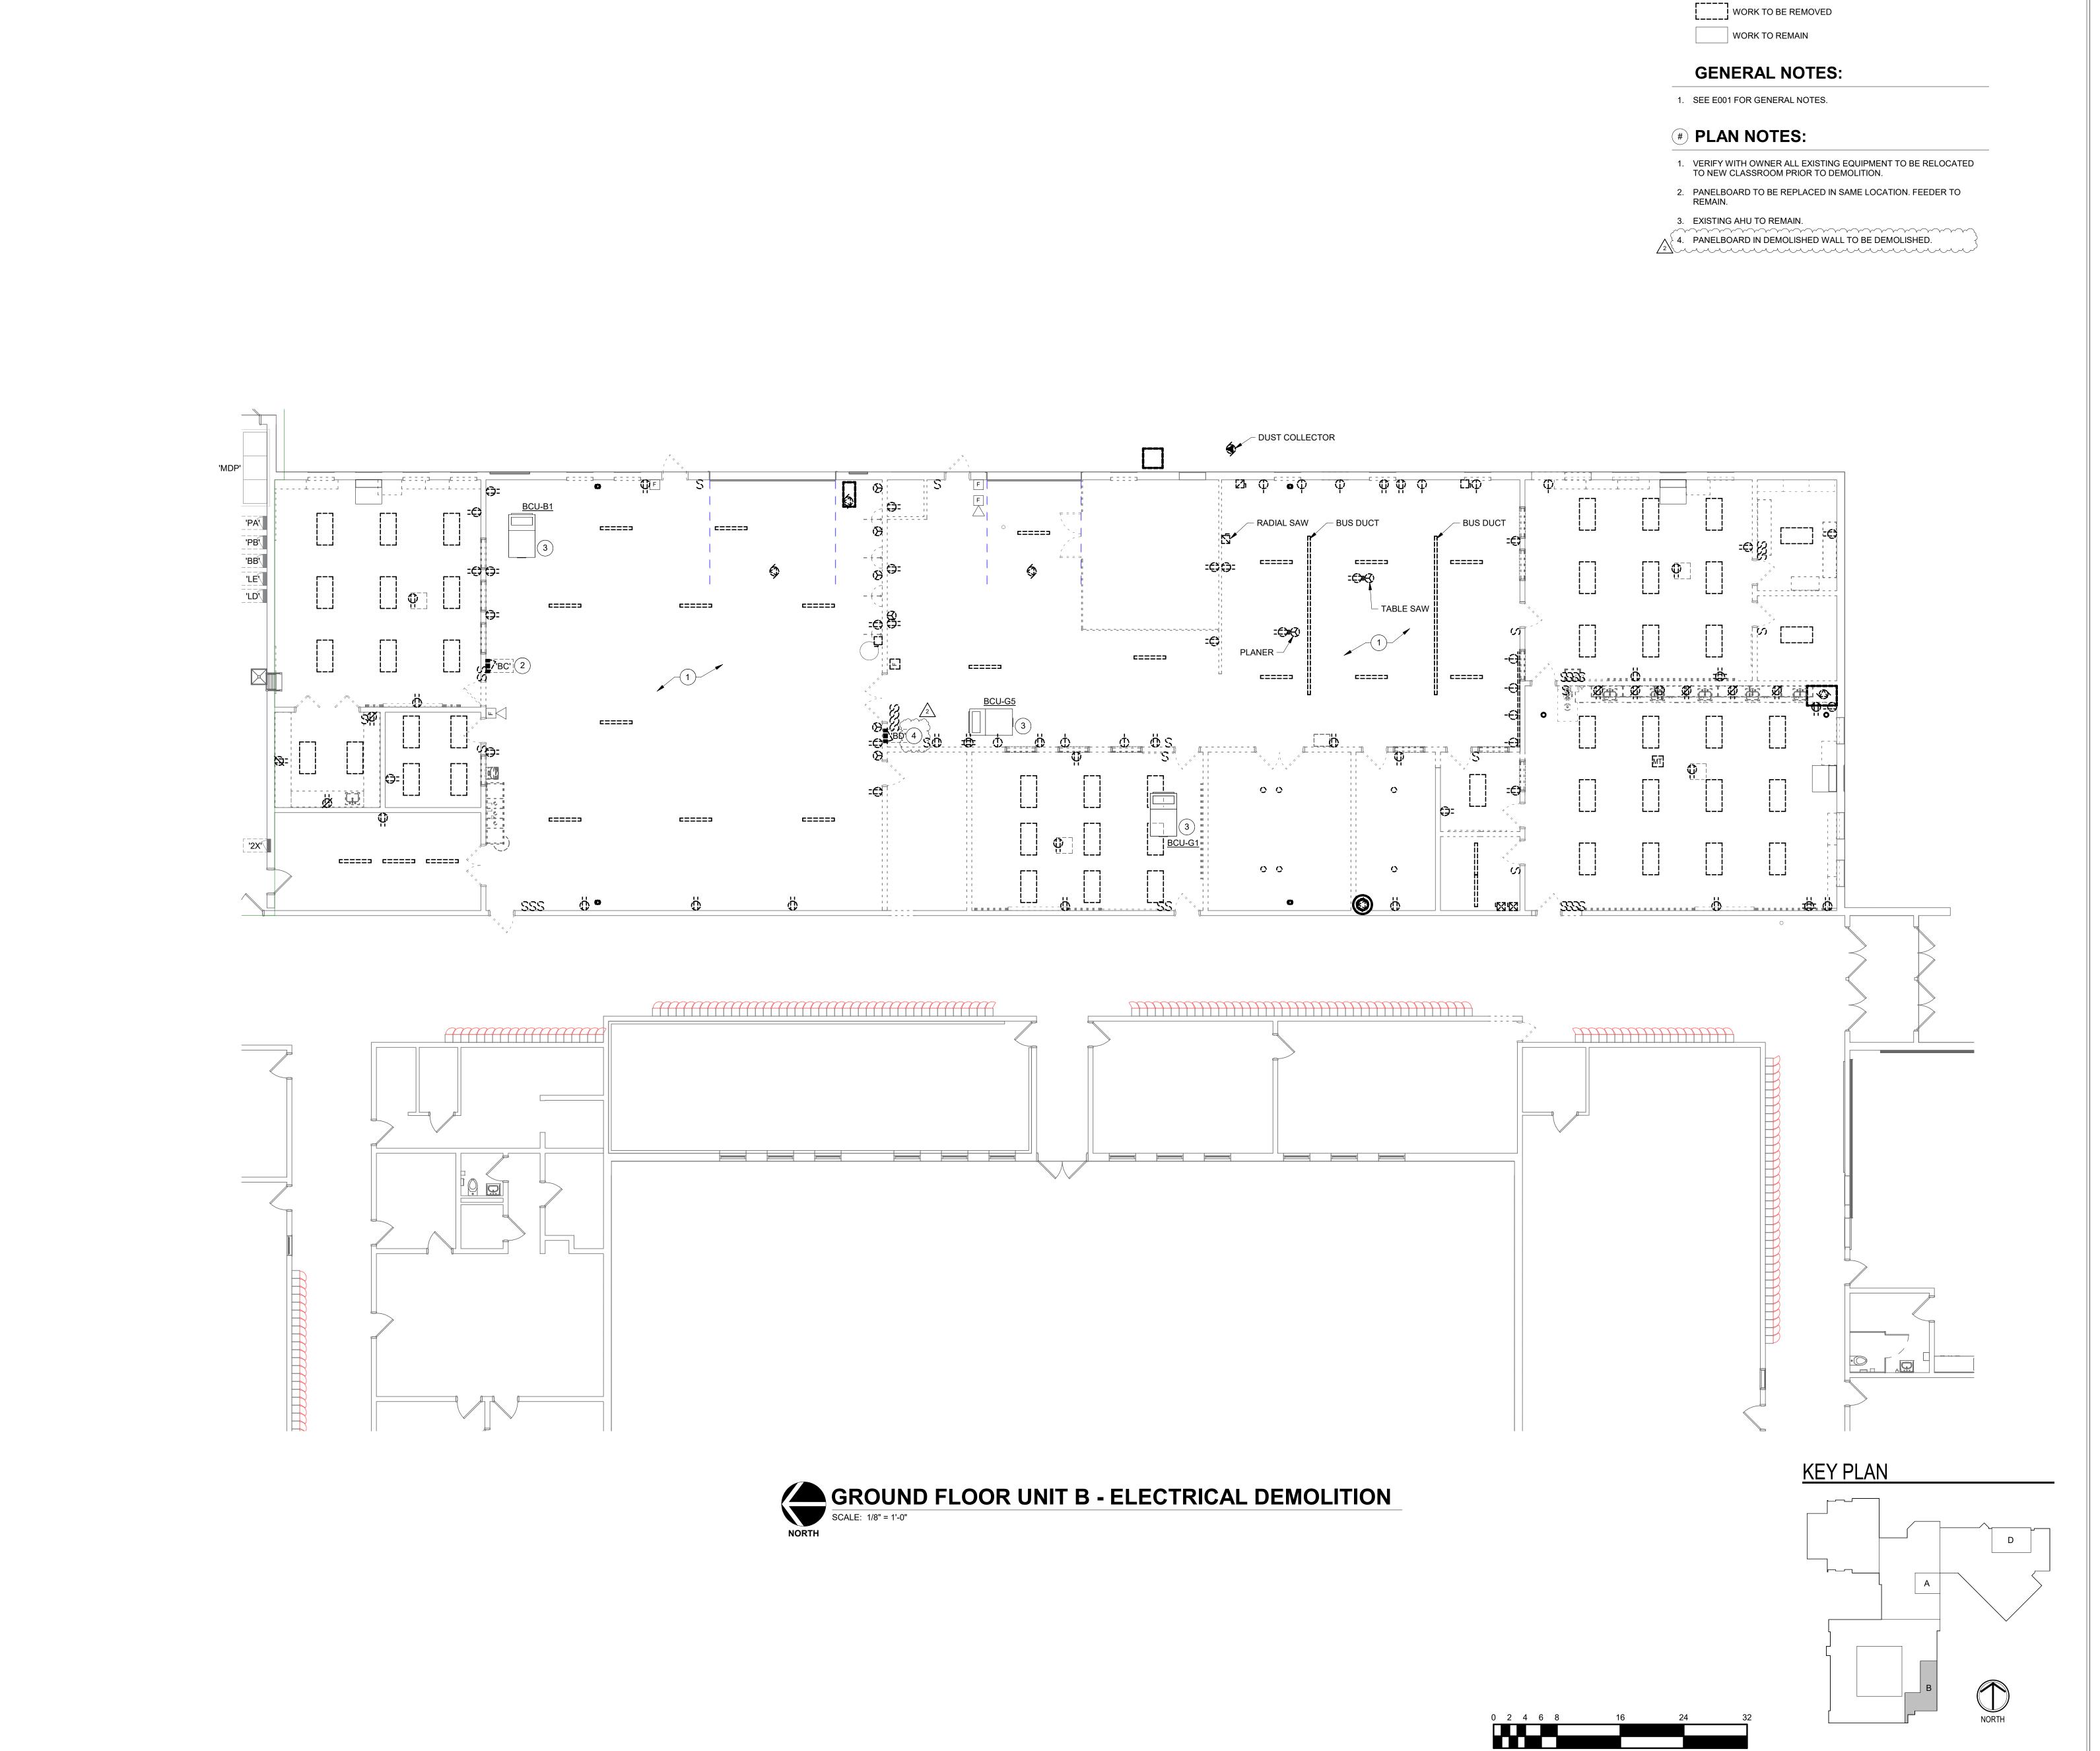
REVISIONS: 2 ADDENDUM #2 9/12/25

ISSUE DATE | DRAWN BY | CHECKED BY 08/15/2025 AJS

DRAWING TITLE: GROUND FLOOR PLAN - UNIT A -ELECTRICAL **DEMOLITION** 



DRAWING NUMBER ED201A PROJECT NUMBER 2024037





**DEMOLITION LEGEND:** 

**S831** Keystone Crossing, Indianapolis, IN 46240 317.848.7800 | csoinc.net

Si Si

Consulting Engineers 732 North Capitol Avenue Indianapolis, IN 46204 Phone: (317) 634-4672 Fax: (317) 638-8725

SHERIDAN COMMUNITY SCHOOLS
HIGH SCHOOL & MIDDLE SCHOOL
RENOVATION PROJECT
100% CONSTRUCTION DOCUMENT
24185 HINFSLEY RD. SHFRIDAN, IN 46069

SCOPE DRAWINGS:

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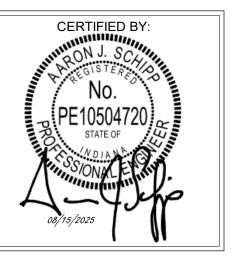
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REVISIONS:
2 ADDENDUM #2 9/12/25

ISSUE DATE DRAWN BY CHECKED BY 08/15/2025 AJS AJS


GROUND FLOOR
PLAN - UNIT B FI FCTRICAL

PLAN - UNIT B -ELECTRICAL DEMOLITION



DRAWING NUMBER
ED201B

PROJECT NUMBER
2024037

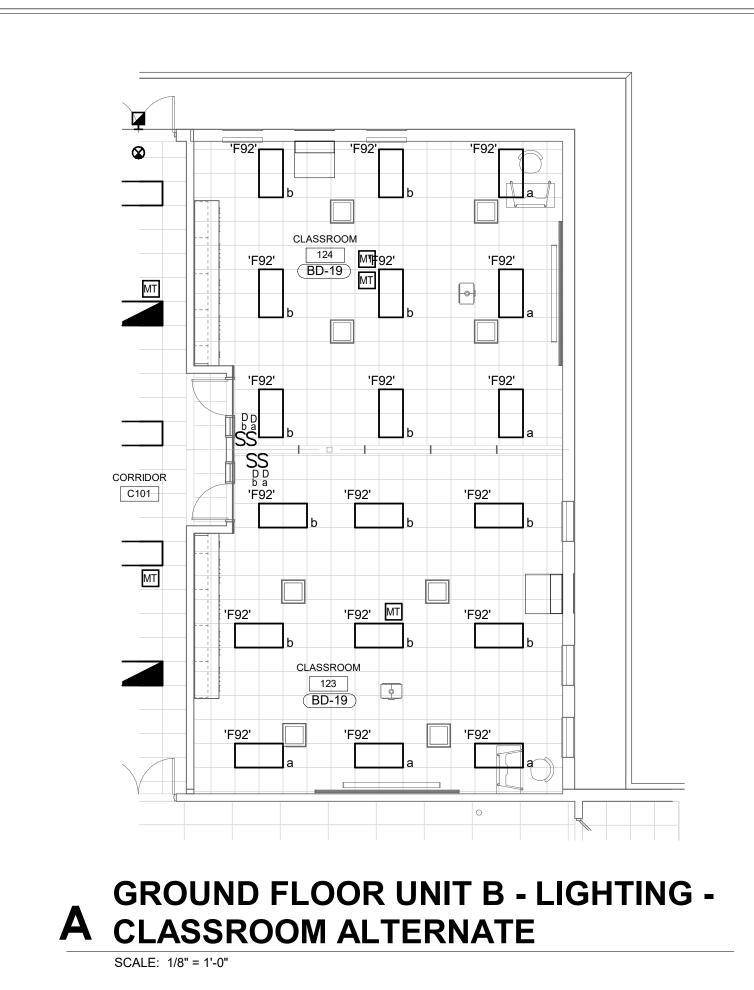



WORK TO BE INSTA

# **GENERAL NOTES:**

SEE E001 FOR GENERAL NOTES.

### **# PLAN NOTES:**

CONNECT FIXTURE TO EXISTING UNSWITCHED LIGHTING CIRCUIT IN THIS SPACE.

COMMUNITY SCHOOL

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es, Inc. ineers

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732 North Capitol Avenue
Indianapolis, IN 46204
Phone: (317) 634-4672
Fax: (317) 638-8725

SHERIDAN COMMUNITY SCHOOL HIGH SCHOOL & MIDDLE SCHOOL RENOVATION PROJECT 100% CONSTRUCTION DOCUMEN 24185 HINESLEY RD. SHERIDAN, IN 46065

SCOPE DRAWINGS:

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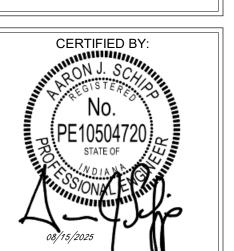
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REVISIONS:
2 ADDENDUM #2 9/12/25

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GROUND FLOOR
PLAN - UNIT B LIGHTING

AJS




E201B

PROJECT NUMBER
2024037



GROUND FLOOR UNIT B - LIGHTING

SCALE: 1/8" = 1'-0"

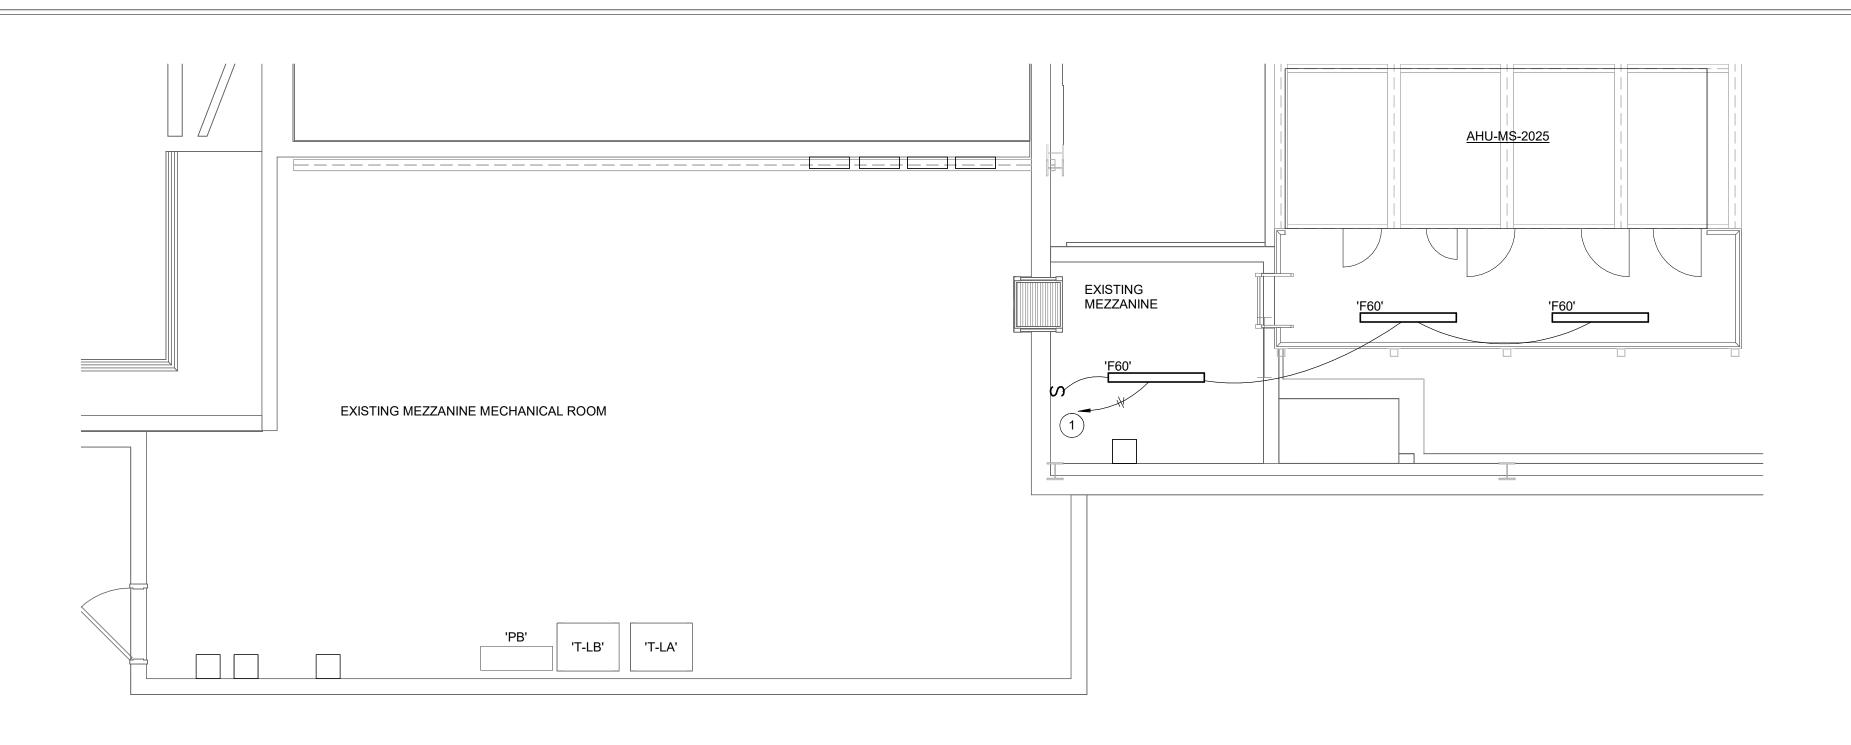

# A MIDDLE SCHOOL MEZZANINE PLAN - LIGHTING







KEY PLAN



WORK TO BE INSTALLED

WORK TO REMAIN

#### **GENERAL NOTES:**

1. SEE E001 FOR GENERAL NOTES.

#### **# PLAN NOTES:**

- EXTEND EXISTING MECHANICAL MEZZANINE LIGHTING CIRCUIT TO NEW FIXTURES ON PLATFORM.
- OCCUPANCY SENSOR TO CONTROL BOTH LIGHTING (277V) AND EXHAUST FAN (120V). PROVIDE POWER PACK RELAYS AS REQUIRED TO CONTROL BOTH.
- 3. PROVIDE JUNCTION BOX FOR SIGN. CONTROL CIRCUIT FROM SWITCH INDICATED. COORDINATE MOUNTING HEIGHT OF JUNCTION BOX WITH SIGN MANUFACTURER PRIOR TO ROUGH-IN.
- 4. GRID MOUNTED EMERGENCY MICRO-INVERTER WITH REMOTE TEST SWITCH. (MYERS LVM-125-G-RT SERIES). COORDINATE LOCATION OF REMOTE TEST SWITCH WITH OWNER PRIOR TO ROUGH-IN. (2#12, 1#12GND, 3/4"C.).
- ROUTE CIRCUIT FOR CANOPY LIGHTING THROUGH INVERTER AND PHOTOCELL FOR CONTROL.
- 6. PHOTOCELL MOUNTED ON TOP OF CANOPY. COORDINATE EXACT LOCATION IN FIELD PRIOR TO ROUGH-IN.





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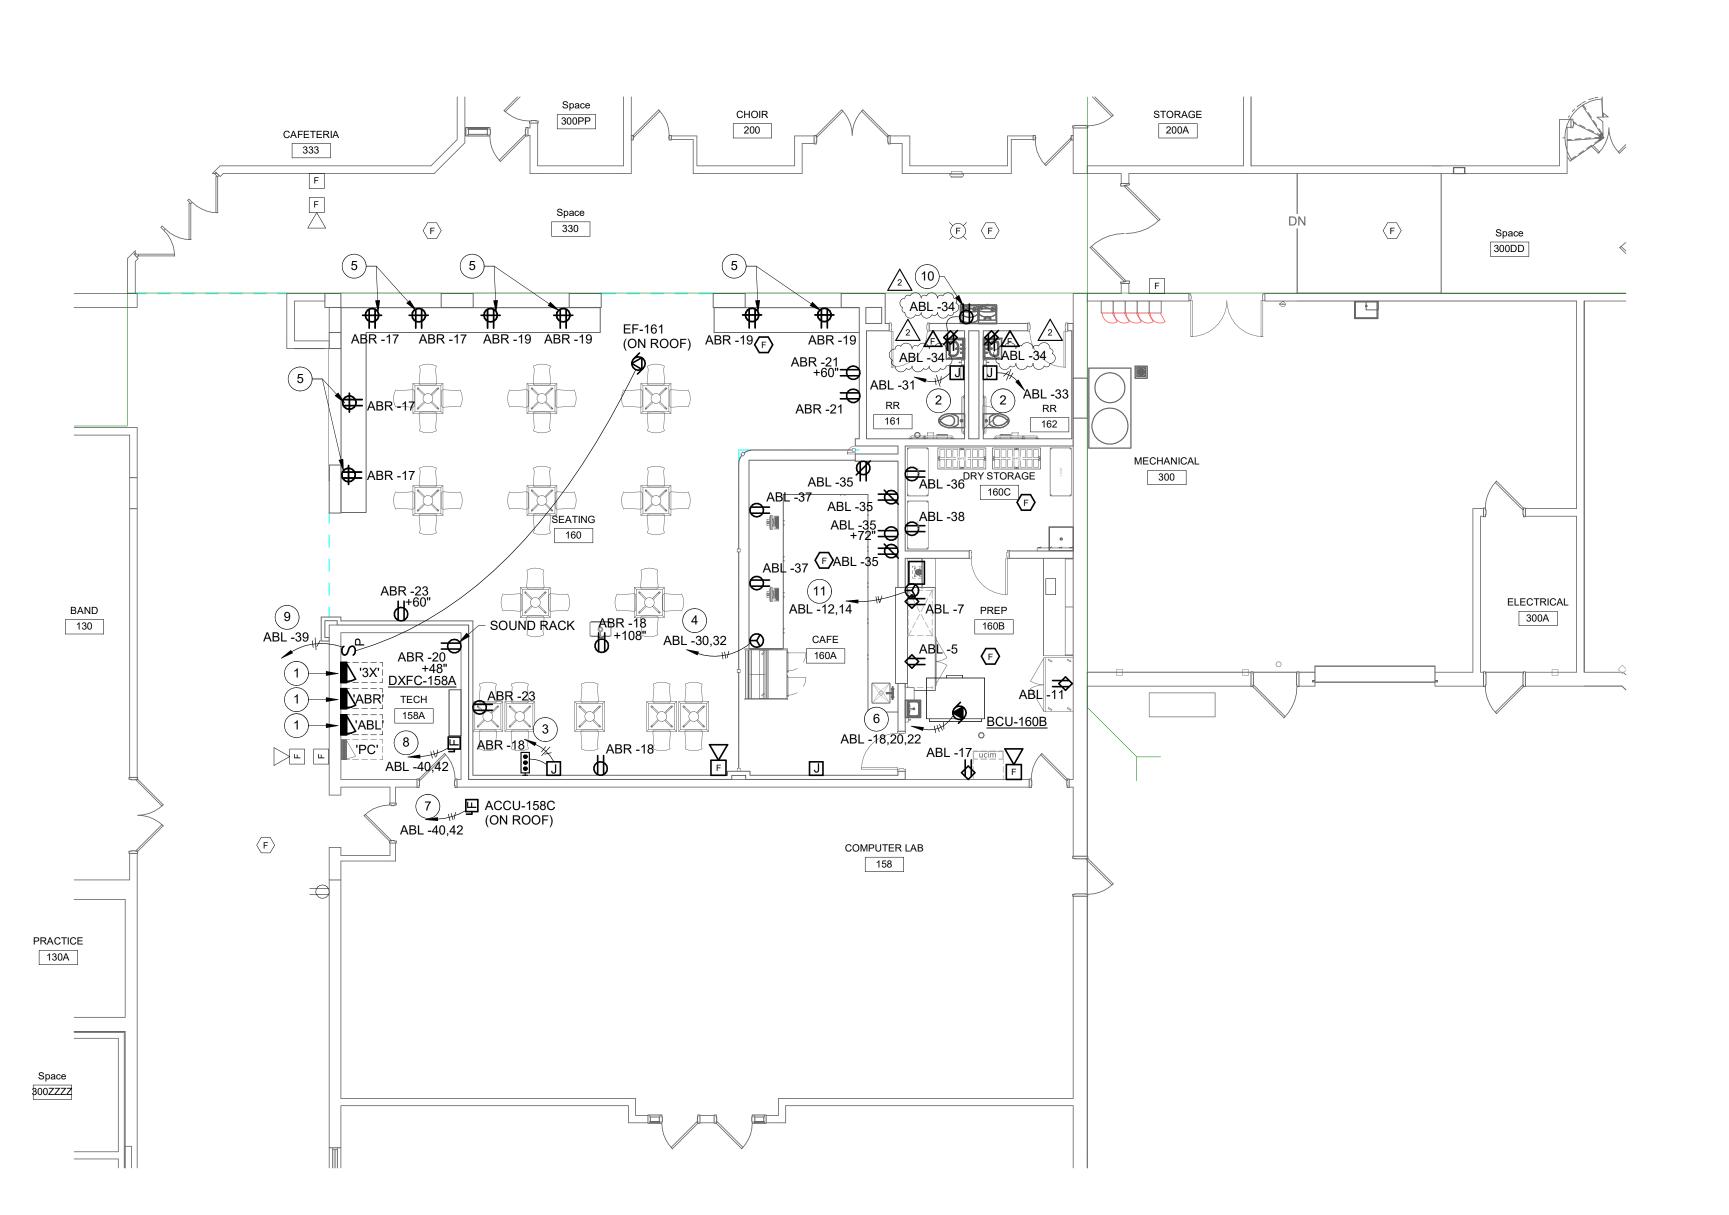
# REVISIONS: 1 ADDENDUM #1 09/05/25 2 ADDENDUM #2 9/12/25

ISSUE DATE | DRAWN BY | CHECKED BY

DRAWING TITLE: GROUND FLOOR PLAN - UNIT D -LIGHTING



DRAWING NUMBER E201D







WORK TO BE INSTALLED

WORK TO REMAIN

#### **GENERAL NOTES:**

1. SEE E001 FOR GENERAL NOTES.

#### **# PLAN NOTES:**

- 1. NEW PANELBOARD WITH RELOCATED CIRCUITS. PROVIDE JUNCTION BOX ABOVE EXISTING PANELBOARD LOCATION AND EXTEND EXISTING CIRCUITS AS REQUIRED. FIELD VERIFY ANY EXISTING CIRCUITS ROUTED IN SLAB. ANY CIRCUITS ROUTED IN SLAB WILL BE REFED OVERHEAD TO EXISTING DEVICES AND UTILIZE SURFACE RACEWAY TO EXTEND CIRCUIT FROM ABOVE CEILING TO EXISTING DEVICES. RELOCATE EXISTING PANELBOARD FEEDERS AS REQUIRED TO NEW LOCATION.
- 2. PROVIDE RECESSED BACK BOX FOR HAND DRYER. COORDINATE MOUNTING HEIGHT WITH HAND DRYER INSTRUCTIONS PRIOR TO ROUGH-IN. (2#10, 1#10GND, 3/4"C.).
- 3. PROVIDE CIRCUIT TO MOTORIZED PROJECTION SCREEN. PROVIDE 3/4" CONDUIT FROM SCREEN TO CONTROL LOCATION. (2#12, 1#12GND, 3/4"C.).
- 4. PROVIDE A NEMA 6-20R. (2#12, 1#12GND, 3/4"C.).
- 5. MOUNT RECEPTACLES HORIZONTAL IN COUNTER BACKSPLASH.
- 6. PROVIDE CONNECTION TO UNIT MOUNTED DISCONNECT.
- PROVIDE A 208V, 1PH. 30A DISCONNECT IN A NEMA 3R ENCLOSURE, FUSE AT 30AMPS FOR MINISPLIT CONDENSING UNIT. (2#10, 1#10GND, 3/4"C.). COORDINATE CONNECTION TO INDOOR UNIT WITH MANUFACTURER.
- 8. PROVIDE A 208V, 1PH. 30A DISCONNECT IN A NEMA 1 ENCLOSURE, FUSE AT 15 AMPS. (2#10, 1#10GND, 3/4"C.).
- PROVIDE A TOGGLE SWITCH WITH PILOT LIGHT. EXTEND MANUFACTURERS UNIT MOUNTED DISCONNECT FOR EXHAUST FAN ON ROOF. (2#12, 1#12GND, 3/4"C.).
- CONNECT WATERCOOLER TO DOWNSTREAM SIDE OF GFCI RECEPTACLE.
- 11. PROVIDE A NEMA 6-20R AT 18" A.F.F. FOR MICROWAVE. (2#12, 1#12GND, 3/4"C.).



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IGH SCHOOL & MIDDLE SCHOOR RENOVATION PROJECT 3% CONSTRUCTION DOCUMEN 24185 HINESLEY RD, SHERIDAN, IN 4606

SCOPE DRAWINGS:

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# REVISIONS:


1 ADDENDUM #1 09/05/25
2 ADDENDUM #2 9/12/25


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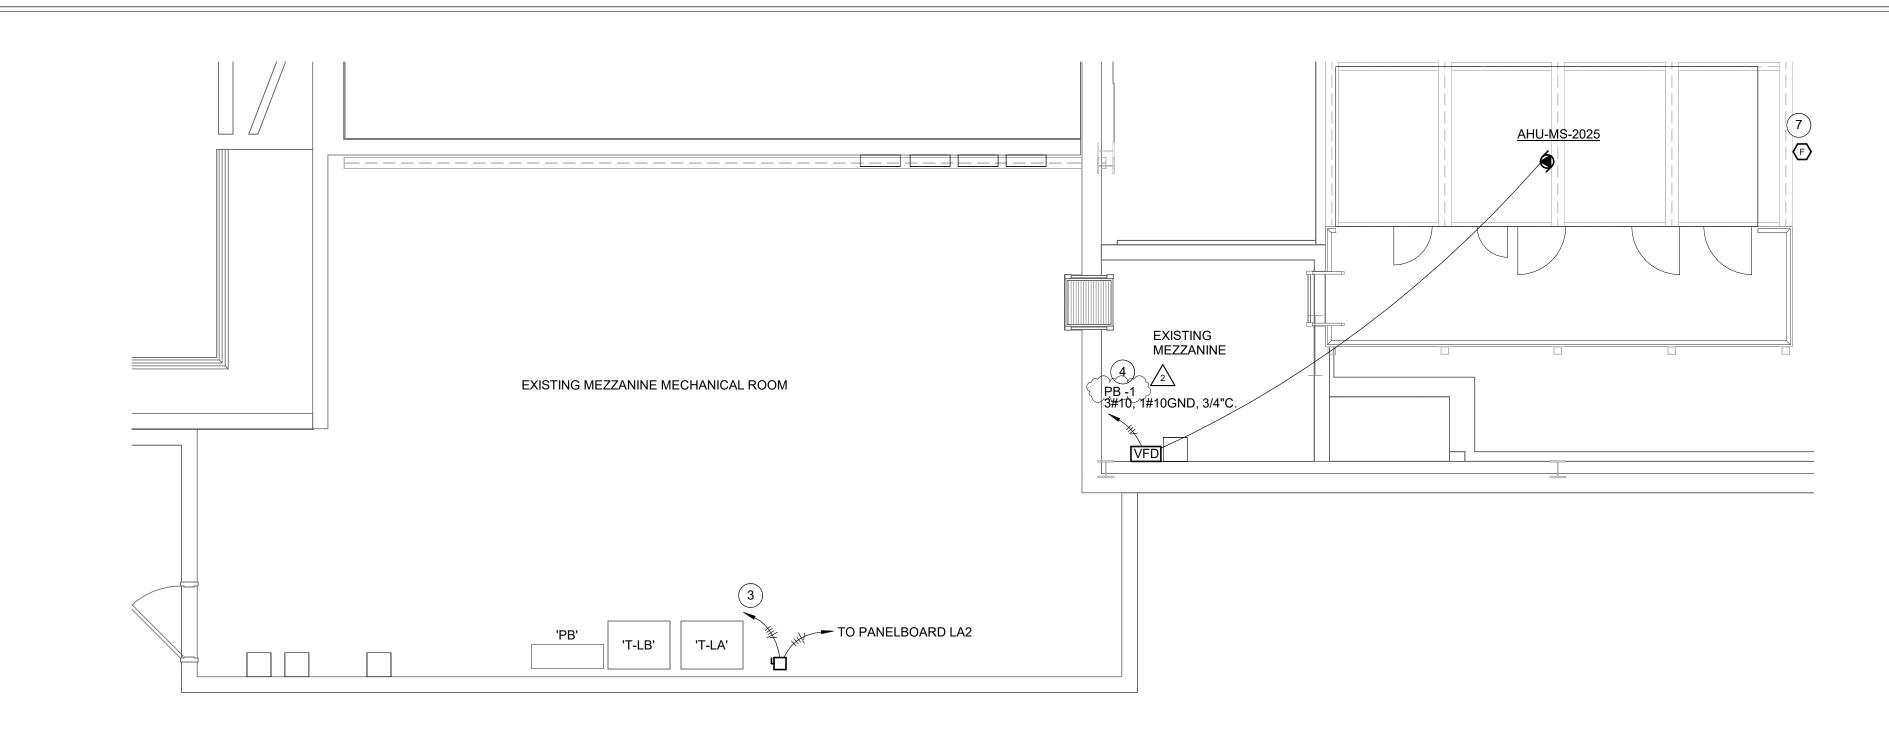
GROUND FLOOR
PLAN - UNIT A POWER AND
SIGNAL




PROJECT NUMBER
2024037



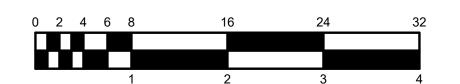

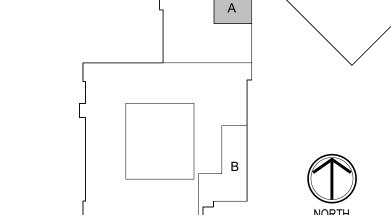

#### A MIDDLE SCHOOL MEZZANINE PLAN - ELECTRICAL SCALE: 1/4" = 1'-0"

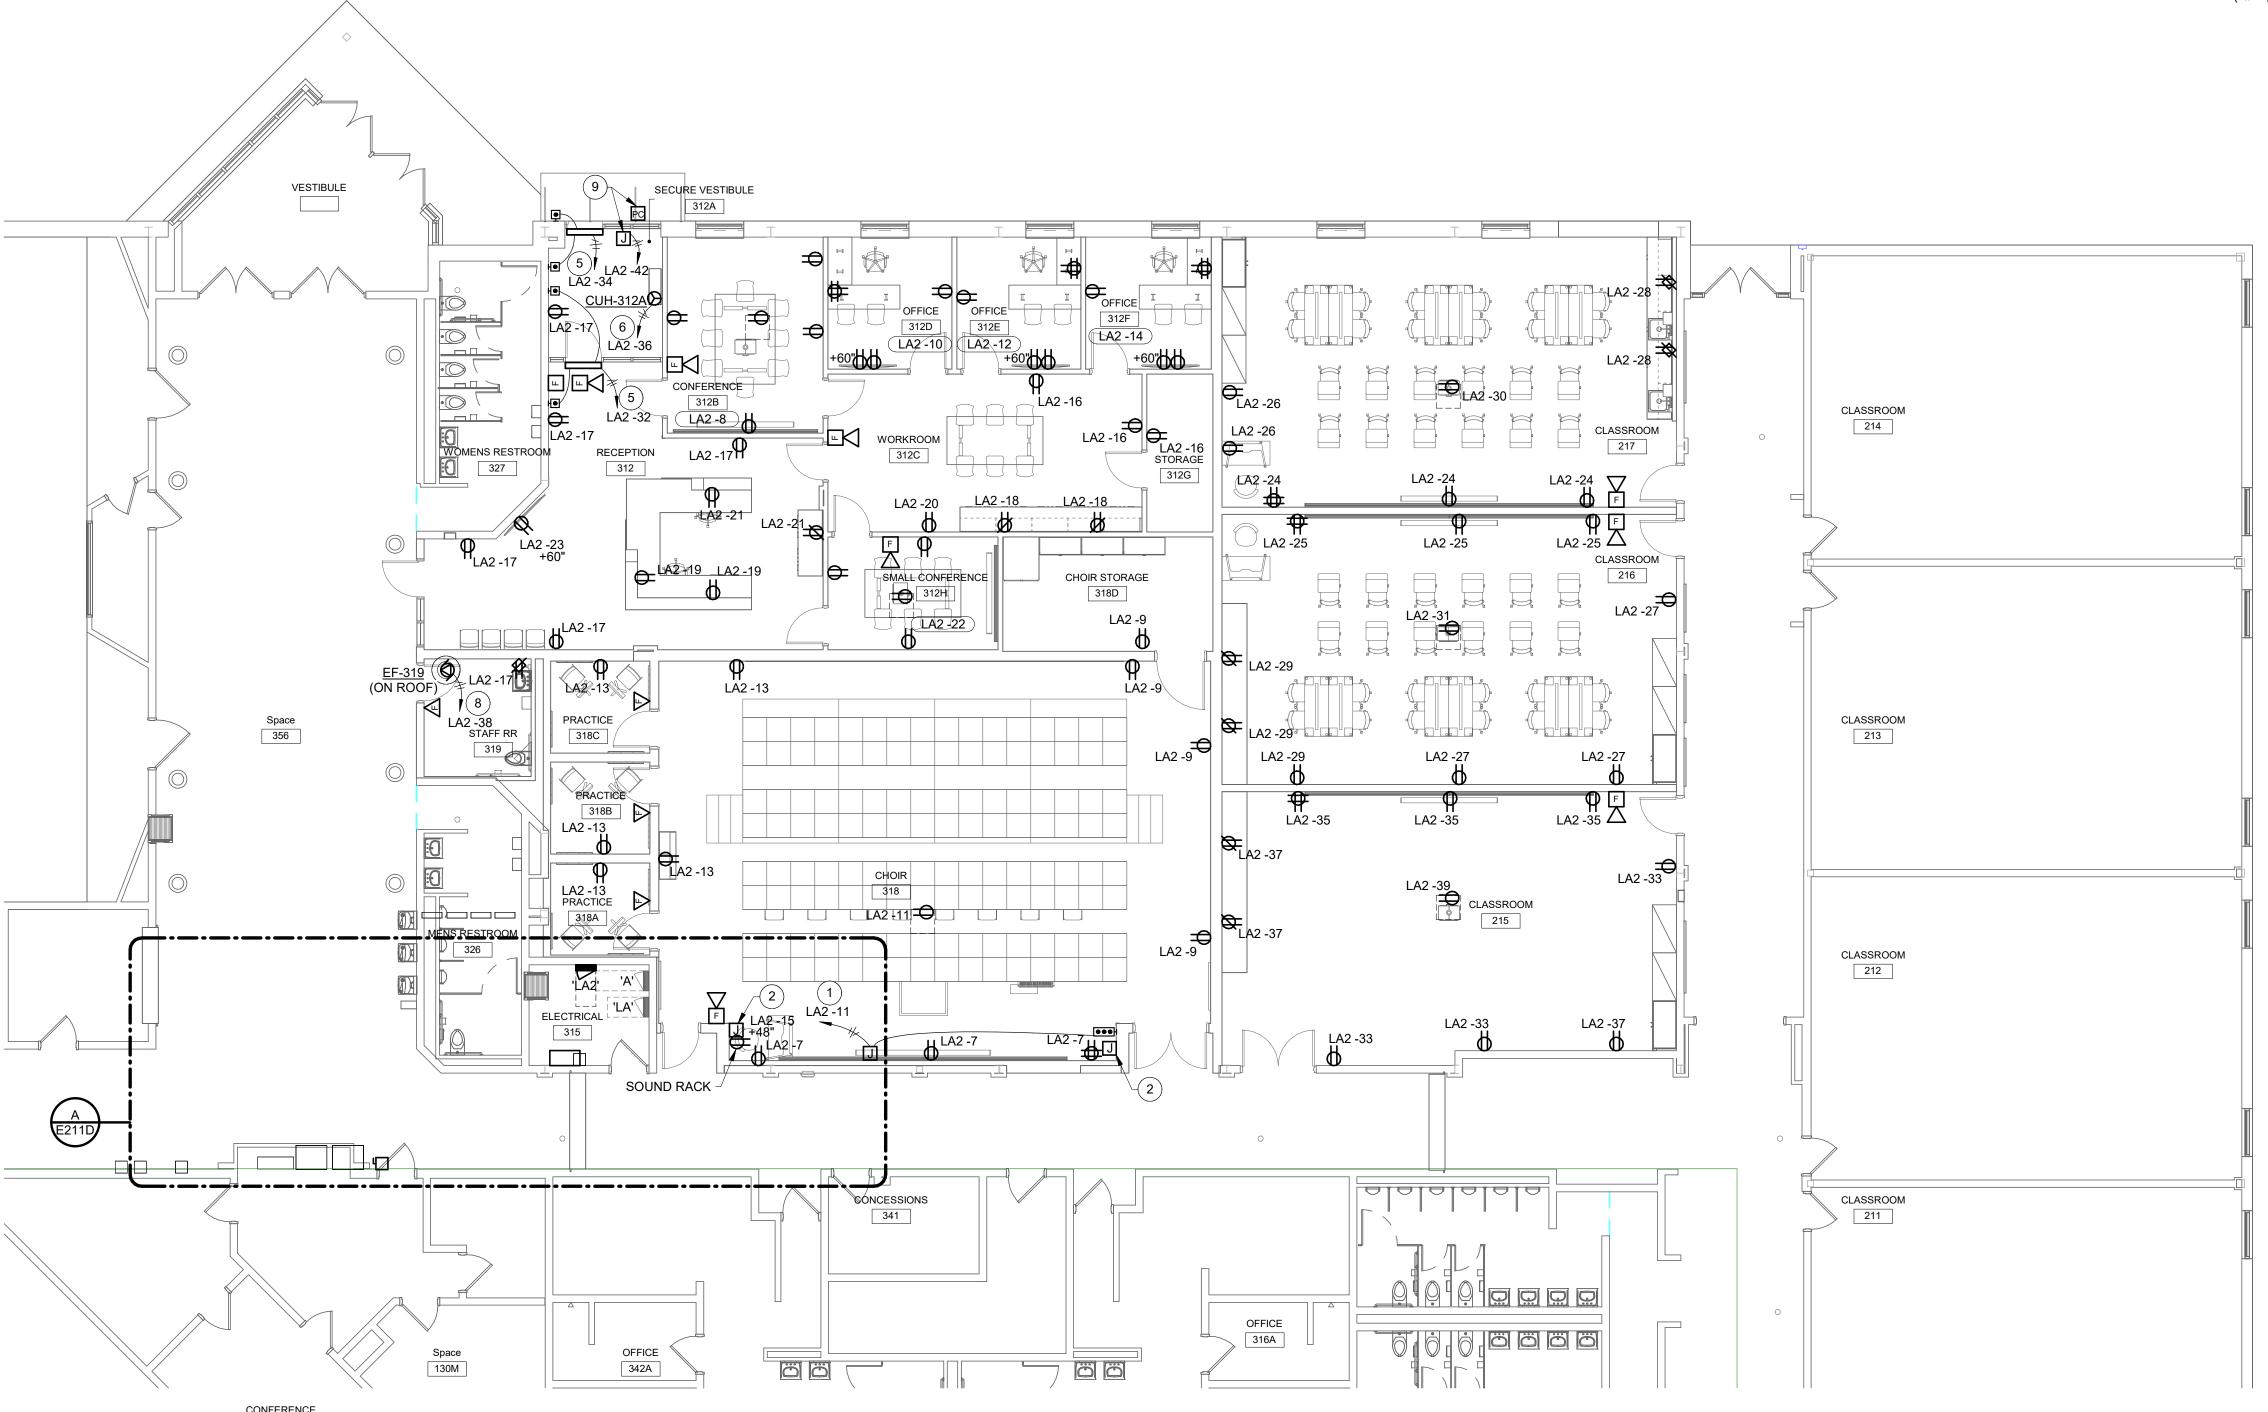

GROUND FLOOR UNIT D - POWER AND SIGNAL

SCALE: 1/8" = 1'-0"



WORK TO BE INSTALLED

WORK TO REMAIN


#### **GENERAL NOTES:**


1. SEE E001 FOR GENERAL NOTES.

#### **# PLAN NOTES:**

- PROVIDE CIRCUIT TO MOTORIZED PROJECTION SCREEN. PROVIDE 3/4" CONDUIT FROM SCREEN TO CONTROL LOCATION. (2#12, 1#12GND, 3/4"C.).
- 2. PROVIDE A RECESSED BACKBOX AND 3/4" CONDUIT TO ABOVE ACCESSIBLE CEILING.
- 3. PROVIDE A 480V, 3PH, 100A FUSED DISCONNECT FOR NEW PANELBOARD LA2, NEMA 1 ENCLOSURE, FUSE AT 100A. CONNECT TO SECONDARY OF EXISTING TRANSFORMER T-LA. (4#1, 1#6GND,
- 4. E.C. TO INSTALL VFD PROVIDED BY OTHERS. PROVIDE CONNECTION FROM VFD TO MECHANICAL UNIT. CIRCUIT TO EXISTING AHU-2 FUSED SWITCH IN DISTRIBUTION PANELBOARD PB. PROVIDE 25A
- 5. PROVIDE CONNECTION TO ADA DOOR OPERATOR. PROVIDE CONDUIT AND BACKBOX FOR ADA PUSH BUTTONS. COORDINATE WITH ADA DOOR MANUFACTURER'S INSTRUCTIONS. (2#12, 1#12GND,
- 6. CONNECT TO UNIT MOUNTED DISCONNECT SWITCH.
- 7. INSTALL DUCT DETECTOR IN RETURN DUCT. CONNECT TO EXISTING FIRE ALARM SYSTEM.
- 8. CONNECT TO UNIT MOUNTED DISCONNECT SWITCH. PROVIDE RELAY TO CONTROL FAN BY LIGHTING OCCUPANCY SENSOR. SEE DRAWING E201D.
- 9. PROVIDE CIRCUIT FOR OUTDOOR SIGN POWER SUPPLY. PROVIDE PHOTOCELL CONTROL ABOVE CANOPY FOR CONTROL. COORDINATE WITH SIGN PROVIDER PRIOR TO ROUGH-IN. (2#12, 1#12GND, 3/4"C.).



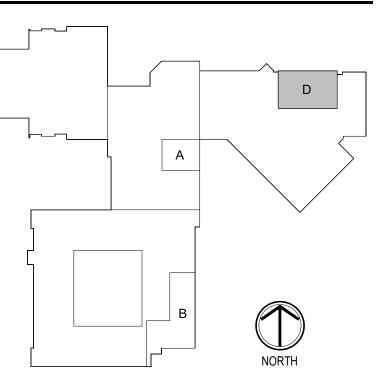

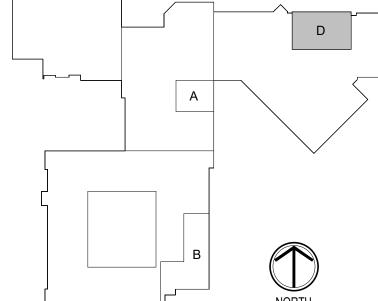



# REVISIONS: 2 ADDENDUM #2 9/12/25

DRAWING TITLE: GROUND FLOOR PLAN - UNIT D -POWER AND SIGNAL



E211D

MARK	DESCRIPTION	MOUNTING	WATTS	CRI	COLOR	LUMENS	VOLTS	MANUFACTURER(S)	MA
F1-4	LINEAR 1-INCH WIDE, 4' LENGTH T-BAR MOUNTED LED, FROSTED LENS, 120 DEGREE DISTRIBUTION, WHITE HOUSING, 0-10V DIMMING, VERIFY EXACT CEILING SPECIFICATIONS WITH ARCHITECT PRIOR TO ORDERING FIXTURE.	SURFACE	26 W	80	3500K	730/FT	120-277V	VODE ZIPTWO 3515 SO ARON EZT SERIES XICO NSQ95 SERIES QTL VERS-FLUSH (02) SW SERIES SCOUT SS-O SERIES	F
F1-4E	SAME AS 'F1-4' EXCEPT WITH EMERGENCY LED POWER UNIT.	SURFACE	40 W	80	3500K	730/FT	120-277V		F1
F1-8 F1-14	SAME AS 'F1-4' EXCEPT LENGTH.  LINEAR 1-INCH WIDE, 4' LENGTH T-BAR MOUNTED LED, FROSTED LENS, 120 DEGREE DISTRIBUTION, WHITE HOUSING, 0-10V DIMMING, VERIFY EXACT CEILING SPECIFICATIONS WITH ARCHITECT PRIOR TO ORDERING FIXTURE.	SURFACE SURFACE	53 W 92 W	80	3500K 3500K	730/FT 730/FT	120-277V 120-277V	VODE ZIPTWO 3515 SO ARON EZT SERIES XICO NSQ95 SERIES QTL VERS-FLUSH (02) SW SERIES SCOUT SS-O SERIES	F1
F2-6	LINEAR 1-INCH WIDE BY LENGTH INDICATED, WHITE DIFFUSER, AIRCRAFT CABLE, 0-10V DIMMING TO 10-PERCENT, NON-IC RATED.	PENDENT	40 W	80	3500K	730/FT	120-277V	VODE ZIPTWO 3515 SO ARON EZT SERIES XICO NSQ95 SERIES QTL VERS-FLUSH (02) SW SERIES SCOUT SS-O SERIES	F
F2-6E	LINEAR 1-INCH WIDE BY LENGTH INDICATED, WHITE DIFFUSER, AIRCRAFT CABLE, 0-10V DIMMING TO 10-PERCENT, NON-IC RATED, EMERGENCY BATTERY UNIT.	PENDENT	40 W	80	3500K	730/FT	120-277V	VODE ZIPTWO 3515 SO ARON EZT SERIES XICO NSQ95 SERIES QTL VERS-FLUSH (02) SW SERIES SCOUT SS-O SERIES	F2
F8	18-INCH DIAMETER PENDANT FIXTURE, AIRCRAFT CABLE, FINISH TO BE SELECTED BY ARCHITECT FROM MANUFACTURER'S CATALOG OF STANDARD FINISHES, SATIN NICKEL HARDWARE.	PENDENT	90 W	LED	3500K	10000	120-277V	MCGRAW EDISON TT SERIES BEACON SRT2 SERIES SOLERA RLM-18 LITHONIA VCPG-LED-BDS SERIES CGT DESIGN SLED-L SERIES GARCO SVPG SERIES	F
F50	6-INCH CYLINDER FOOD WARMING DOWNLIGHT, ALUMINUM HOUSING, FINISH TO BE SELECTED BY ARCHITECT FROM MANUFACTURER'S CATALOG OF STANDARD FINISHES, 250W INFRARED R40 LAMP	SURFACE	250 W	80	3500K	2058	120-277V	BASELITE - FWPEO HI-LITE H-600 SERIES SPJ LIGHTING HOOP SERIES	F
F60	4-FOOT LENSED INDUSTRIAL, FORMED STEEL HOUSING, WHITE FINISH, SEMI-FROST ACRYLIC DIFFUSER.	SURFACE/ CHAIN HUNG	48 W	80	3500K	5000	120-277V	COLUMBIA MPS SERIES CREE LS4 SERIES LITHONIA ZL1D SERIES METALUX SNLED SERIES WILLIAMS FS SERIES DAYBRITE FSS SERIES	F
F91	2 BY 2-FOOT FLAT PANEL, ACRYLIC LENS, BACK-LIT, 0-10V DIMMING TO 10-PERCENT	RECESSED	32 W	80	3500K	3200	120-277V	COLUMBIA SRP22 SERIES CREE C-TR-C-FP22 LITHONIA EPANL22 SERIES METALUX 22FPX SERIES WILLIAMS BP SERIES DAYBRITE 2FPZ SERIES	F
F91E	2 BY 2-FOOT FLAT PANEL, ACRYLIC LENS, BACK-LIT, 0-10V DIMMING TO 10-PERCENT, EMERGENCY BATTERY UNIT.	RECESSED	32 W	80	3500K	3200	120-277V	COLUMBIA SRP22 SERIES CREE C-TR-C-FP22 LITHONIA EPANL22 SERIES METALUX 22FPX SERIES WILLIAMS BP SERIES DAYBRITE 2FPZ SERIES	F!
F92	2 BY 4-FOOT FLAT PANEL, ACRYLIC LENS, BACK-LIT, 0-10V DIMMING TO 10-PERCENT	RECESSED	40 W	80	3500K	4000	120-277V	COLUMBIA SRP24 SERIES CREE C-TR-C-FP24 SERIES LITHONIA EPANL24 SERIES METALUX 24FPX SERIES WILLIAMS BP SERIES DAYBRITE 2FPZ SERIES	F
F92E	2 BY 4-FOOT FLAT PANEL, ACRYLIC LENS, BACK-LIT, 0-10V DIMMING TO 10-PERCENT, EMERGENCY BATTERY UNIT.	RECESSED	40 W	80	3500K	4000	120-277V	COLUMBIA SRP24 SERIES CREE C-TR-C-FP24 SERIES LITHONIA EPANL24 SERIES METALUX 24FPX SERIES WILLIAMS BP SERIES DAYBRITE 2FPZ SERIES	F
X1	CAST ALUMINUM EXIT SIGN, BRUSHED FACE, BLACK HOUSING, SELF POWERED, SELF DIAGNOSTIC.	UNIVERSAL	5 W	80	RED	N/A	120-277V	DUAL-LITE SE SERIES SURE-LITES CX SERIES LITHONIA LE SERIES LSL LSXDC SERIES CHLORIDE ER55L3R	,
X3W	THERMOPLASTIC COMBINATION EXIT SIGN / EMERGENCY LIGHT, WHITE HOUSING, SELF POWERED, SELF DIAGNOSTIC, WIREGUARD.	SURFACE WALL	5 W	80	RED	N/A	120-277V	DUAL-LITE HCX SERIES SURE-LITES APC SERIES LITHONIA LQHM SERIES LSL LSINDCWLEZU SERIES CHLORIDE VLTC SERIES	X

- CONTRACTOR SHALL SET OUTPUT AND COLOR TEMPERATURE OF ADJUSTABLE FIXTURES AS DIRECTED IN THE FIELD BY THE ENGINEER.
- VERIFY EXIT SIGN LETTERING COLOR WITH EXISTING FIXTURES IN BUILDING PRIOR TO ORDERING.

EXTERIOR LIGHT FIXTURE SCHEDULE											
MARK	DESCRIPTION	MOUNTING	WATTS	CRI	COLOR	LUMENS	VOLTS	MANUFACTURER(S)	MARK		
F81	4-INCH SURFACE MOUNT LED DOWNLIGHT, WET LOCATION LISTED, DIE-CAST ALUMINUM TRIM RING, DIE FORMED ALUMINUM FRAME, MATTE WHITE FINISH, ARCHITECT TO CONFIRM FINISH.	SURFACE	9 W	80	4000K	600		PRESCOLITE LBSD-RD SERIES JUNO JSF-5IN SERIES LUMINOSO DL-4-RD SERIES LUMINATION LDED R4 SERIES LOTUS DL205T SERIES ROYAL PACIFIC 8739	F81		
FN	ARCHITECTURAL WALL PACK, WET LOCATION LISTED, FINISH TO BE SELECTED BY ARCHITECT FROM MANUFACTURER'S CATALOG OF STANDARD COLORS, INTETRAL PHOTOCELL, EMERGENCY BATTERY UNIT.	SURFACE WALL	40 W	70	3500K	4000	-	HUBBELL SG SERIES LITHONIA WPX SERIES LUMARK XTOR SERIES TRACE-LITE WLZ4 SERIES LUMECON BLS-FCW SERIES	FN		



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SHERIDAN COMMUNITY SCHOOL HIGH SCHOOL & MIDDLE SCHOOL RENOVATION PROJECT 100% CONSTRUCTION DOCUMEN 24185 HINFSLEY RD. SHERIDAN IN 4606

SCOPE DRAWINGS:

These drawings indicate the general scope of the project in terms of architectural design concept, the dimensions of the building, the major architectural elements and the type of structural, mechanical and electrical systems.

The drawings do not necessarily indicate or describe all work required for full performance and completion of the requirements of the Contract.


On the basis of the general scope indicated or described, the trade contractors shall furnish all items required for the proper execution and completion of the work.

# REVISIONS:


1 ADDENDUM #1 09/05/25
2 ADDENDUM #2 9/12/25

ISSUE DATE DRAWN BY CHECKED BY 08/15/2025 AJS AJS

DRAWING TITLE:
SCHEDULES ELECTRICAL

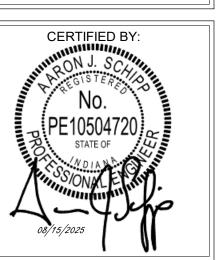

E601

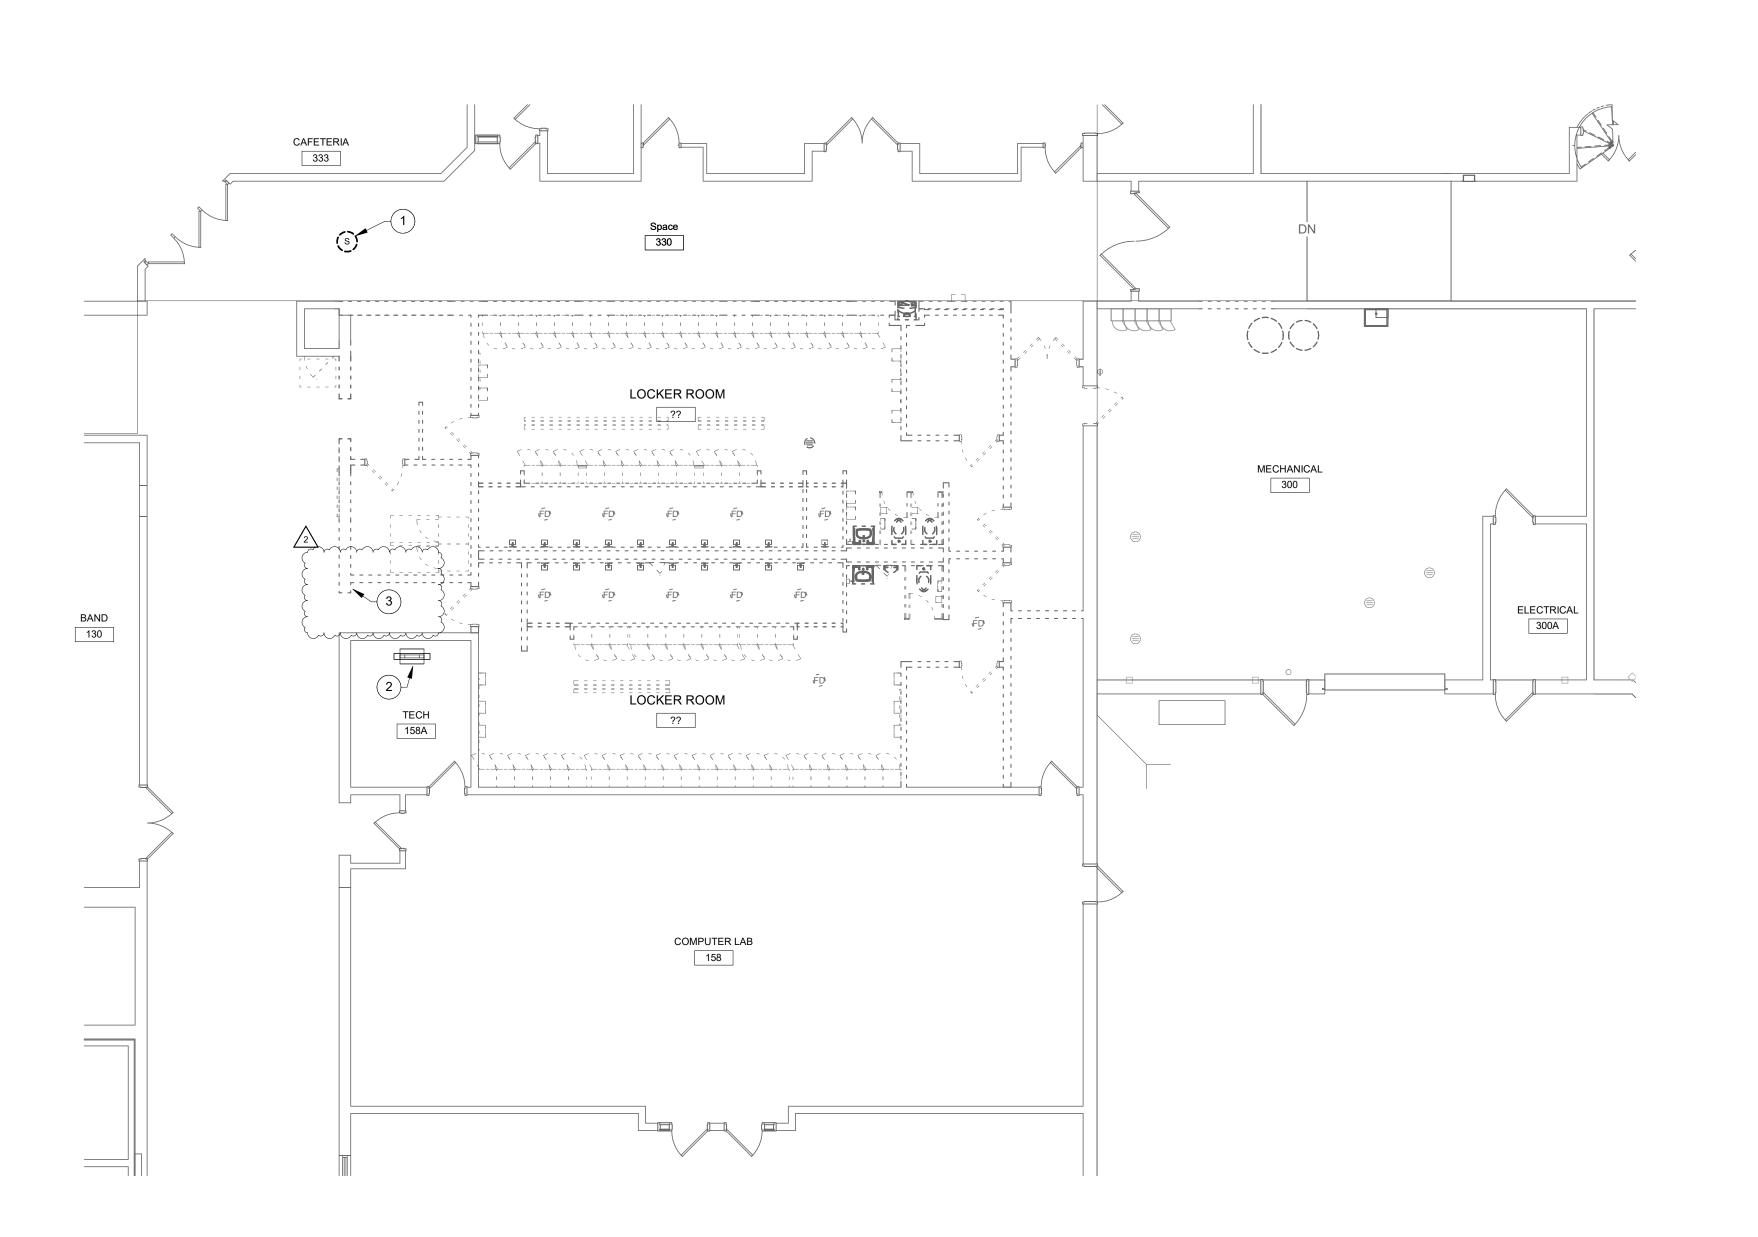

GROUND FLOOR UNIT A - TELECOMMUNICATIONS DEMOLITION

SCALE: 1/8" = 1'-0"



WORK TO BE REMOVED

WORK TO REMAIN

#### **GENERAL NOTES:**

1. REFER TO DRAWING T001 FOR ADDITIONAL GENERAL NOTES.

2. ALL WORK SHALL REMAIN UNLESS SPECIFICALLY NOTED OTHERWISE.

- 3. FIELD VERIFY ALL EXISTING CONDITIONS AS TO EXACT SERVICE, LOCATION, TYPE OF MATERIAL, ETC. BEFORE BIDDING AND BEFORE
- BEGINNING RENOVATION WORK. 4. COORDINATE ALL SHUT-DOWNS, DELIVERY AND STORAGE OF

MATERIAL, ETC. WITH OWNER'S REPRESENTATIVE.

5. CONTRACTORS SHALL PROTECT ALL EXISTING OWNER FACILITIES DURING CONSTRUCTION. ANY AND ALL OWNER FACILITIES DAMAGED OR DISCONNECTED BY CONTRACTOR OPERATIONS SHALL BE FULLY RESTORED TO PREVIOUS OPERATING AND APPEARANCE CONDITION BY CONTRACTOR.

#### **# PLAN NOTES:**

- 1. TEMPORARILY SUPPORT AND PROTECT DURING CONSTRUCTION.
- 2. EXISTING TELECOM EQUIPMENT RACK TO REMAIN. 3. REMOVE TELECOM ENCLOSURE AND WIRING IN WALL
  COMPLETELY. CONTRACTOR TO VERIENCE COMPLETELY. CONTRACTOR TO VERIFY IF ANY WIRING IS ACTIVE



BEFORE DEMOLITION. REROUTE ACTIVE WIRING.

Luciani de la constanta de la

SCOPE DRAWINGS:

These drawings indicate the general scope of the project in terms of architectural design concept, the dimensions of the building, the major architectural elements and the type of structural, mechanical and electrical systems.

The drawings do not necessarily indicate or describe all work required for full performance and completion of the requirements of the Contract.

On the basis of the general scope indicated or described, the trade contractors shall furnish all items required for the proper execution and completion of the work.

REVISIONS: 2 ADDENDUM #2 9/12/25

ISSUE DATE | DRAWN BY | CHECKED BY 08/15/2025

DRAWING TITLE: GROUND FLOOR PLAN - UNIT A -TELECOM. **DEMOLITION** 



DRAWING NUMBER PROJECT NUMBER

2024037

